MASTER PLAN REVIEW

KNIGHTDALE DAYCARE (ZCP-3-25)

0 JASMINE VIEW WAY
KNIGHTDALE, NORTH CAROLINA 27545
WAKE COUNTY

OWNER/DEVELOPER:

HAYWOOD GLEN INVESTMENTS LLC
MICHELLE SIMMS-REITER AND PABLO REITER
7208 FALLS OF NEUSE ROAD
SUITE 201
RALEIGH, NC 27615
MICHELLE@PRMSINV.COM

919-796-6783

CIVIL ENGINEER/ LANDSCAPE ARCHITECT:

TIMMONS GROUP
MIKE DAVIDSON
5410 TRINITY ROAD
SUITE 102
RALEIGH, NC 27607
MIKE.DAVIDSON@TIMMONS.COM
PH: (984) 222-1610

ARCHITECT:

COLLIERS ENGINEERING & DESIGN
JONATHAN CREEL
5901 VEGA AVE, SUITE 100
AUSTIN, TX 78735
JONATHAN.CREEL@COLLIERSENG.COM
PH: 432.770.3630


SURVEYOR:

MCKIM & CREED
KEVIN D. MEDEIROS
4300 EDWARDS MILL ROAD
RALEIGH, NC 27612
CSEAMSTER@MCKIMCREED.COM
PH: (919) 233-8091

	SITE PLAN SUMMARY						
PROJECT:	KNIGHTDALE DAYCARE						
OWNER:	HAYWOOD GLEN INVESTMENTS LLC						
PROJECT ADDRESSES:	0 JASMINE VIEW WAY, KNIGHTDALE, NORTH CAROLINA 27545						
PIN(S):	1755-84-4894						
JURISDICTION:	TOWN OF KNIGHTDALE						
ZONING:	RMX-PUD						
EXISTING USE:	VACANT						
PROPOSED USE:	DAYCARE						
FLOOD ZONE:	NOT LOCATED IN FLOOD HAZARDS AREA PER FEMA MAP #3720175500K (EFFECTIVE 07/19/2022)						
TOTAL LOT AREA:	1.50 AC.±						
EXISTING IMPERVIOUS SURFACE AREA:	1,555 SF						
PROPOSED IMPERVIOUS SURFACE AREA:	34,691 SF						
PROPOSED DAYCARE BUILDING SQUARE FOOTAGE:	10,235 SF						
REQUIRED BUILDING	FRONT SETBACK (MIN.) - 10'						
SETBACKS	FRONT SETBACK (MAX.) - 30'						
	SIDE SETBACK - 6' MAXIMUM SPACES = 0.35 VEHICULAR SPACES PER PERSON LICENSED CAP.						
VEHICULAR PARKING	MINIMUM SPACES = $\frac{1}{2}$ MAXIMUM # OF LICENSED CHILDREN = 146, # OF LICENSED STAFF = 22, TOTAL = 168						
FOR CHILD DAYCARE	# OF LICENSED CHILDREN = 146, # OF LICENSED STAFF = 22, TOTAL = 168 168 X 0.35 = 59 MAXIMUM SPACES						
CENTER WITH MORE	59/2 = 30 MINIMUM SPACES						
THAN SIX (6) PERSONS	1 EV CHARGING STATION PER 40 TOTAL SPACES OR 2 MINIMUM CHARGING						
	STATIONS						
VEHICLE PARKING	39 VEHICULAR PARKING SPACES						
SUMMARY: PROVIDED	(INCLUDES 2 ADA SPACES THAT ARE VAN ACCESSIBLE)						
	2 EV CHARGING STATIONS PROVIDED						

TOWN OF KNIGHTDALE ADDITIONAL USE STANDARDS (CHILD / ADULT DAY CARE CENTER)

- 1. IN ADDITION TO MEETING THE REQUIREMENTS OF SECTION 7.6, FENCING ENCLOSING ANY REQUIRED RECREATION SPACE SHALL BE A MINIMUM OF FOUR (4) FEET IN HEIGHT AND CONSTRUCTED WITH GATES IN SUCH A MANNER THAT MAXIMUM SAFETY TO THE PERSON IS ENSURED.
- 2. DAY CARE CENTERS SHALL BE LOCATED ON LOTS THAT PROVIDE AMPLE OUTDOOR PLAY AREA. A FENCED RECREATION AREA OF A MINIMUM OF TWO-THOUSAND TWO-HUNDRED FIFTY (2,250) SQUARE FEET SHALL BE PROVIDED IN THE REAR OR SIDE YARD. REQUIRED BUFFER YARDS MAY NOT BE COUNTED TOWARDS THIS REQUIREMENT.
- 3. HOURS OF OPERATION SHALL BE PERMITTED ONLY FROM 6:00 AM UNTIL 9:00 PM.

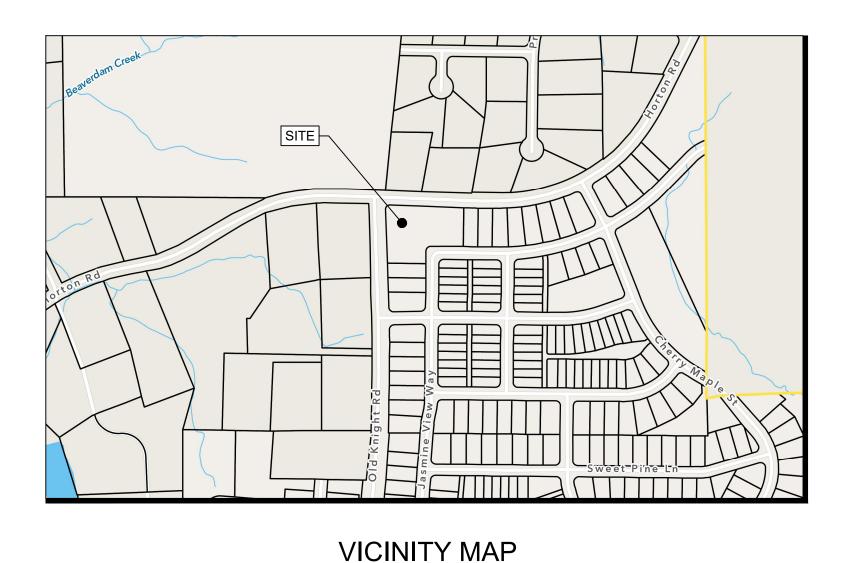

SCALE: 1" = 500'



Sheet List Table						
Sheet Number	Sheet Title					
C0.0	COVER SHEET					
C0.1	SURVEY					
C2.0	SITE LAYOUT PLAN					
C2.1	SIGNS AND MARKINGS PLAN					
C3.0	GRADING AND DRAINAGE PLAN					
C3.1	SPOT GRADING PLAN AND STORM TABLES					
C5.0	UTILITY PLAN					
C6.0	LANDSCAPE PLAN					
C6.1	LANDSCAPE NOTES AND DETAILS					
C7.0	NOTES AND DETAILS					
C7.1	NOTES AND DETAILS					
C7.2	NOTES AND DETAILS					
C7.3	NOTES AND DETAILS					
C7.4	NOTES AND DETAILS					
25-0280A	SITE LIGHTING ARRANGEMENT					
A104	FINISHED FLOOR PLAN					
A201	BUILDING ELEVATIONS & NOTES					
A301	BUILDING SECTIONS					
AS102	DUMPSTER ENCLOSURE DETAILS					
G002	GENERAL CONDITIONS					
G102	LICENSING PLAN					

Knightdalo Dayeara Water Allegation Weekshoot	
Knightdale Daycare - Water Allocation Worksheet	
BASE_	<u>POINTS</u>
Other Uses Not Catagorized (Daycare Facility)	30
<u>BONUS</u>	
Section 1B - Roadway Improvements Not Warranted By TIA (Proposed Concrete Median in the Old Knight Road ROW to Prevent Left Turn Movement Exiting the Daycare)	8
Section 2C - Exclusive Use of Native Trees and Shrub Species	5
Section 4C - Deck/Patio - More Than 3,000 SF (Outdoor Playground)	3
Section 4F - Additional Outdoor Recreation - IPEMA Certified Playground Equipment	4
Total	50

PRELIMINARY - NOT RELEASED FOR CONSTRUCTION


ALL CONSTRUCTION TO BE IN ACCORDANCE WITH ALL TOWN OF KNIGHTDALE, WAKE COUNTY, AND NCDOT STANDARDS, SPECIFICATIONS, AND DETAILS


332\70434-Knightdale Daycare\DWG\Sheet\CD\70434-COVR.dwg | Plotted on 10/28/2025 3:49 PM | by Brandon Wright

07/07/2025 DRAWN BY CHECKED BY 1. DAVIDSON AS SHOWN

70434

SHEET NO. **CO.O**

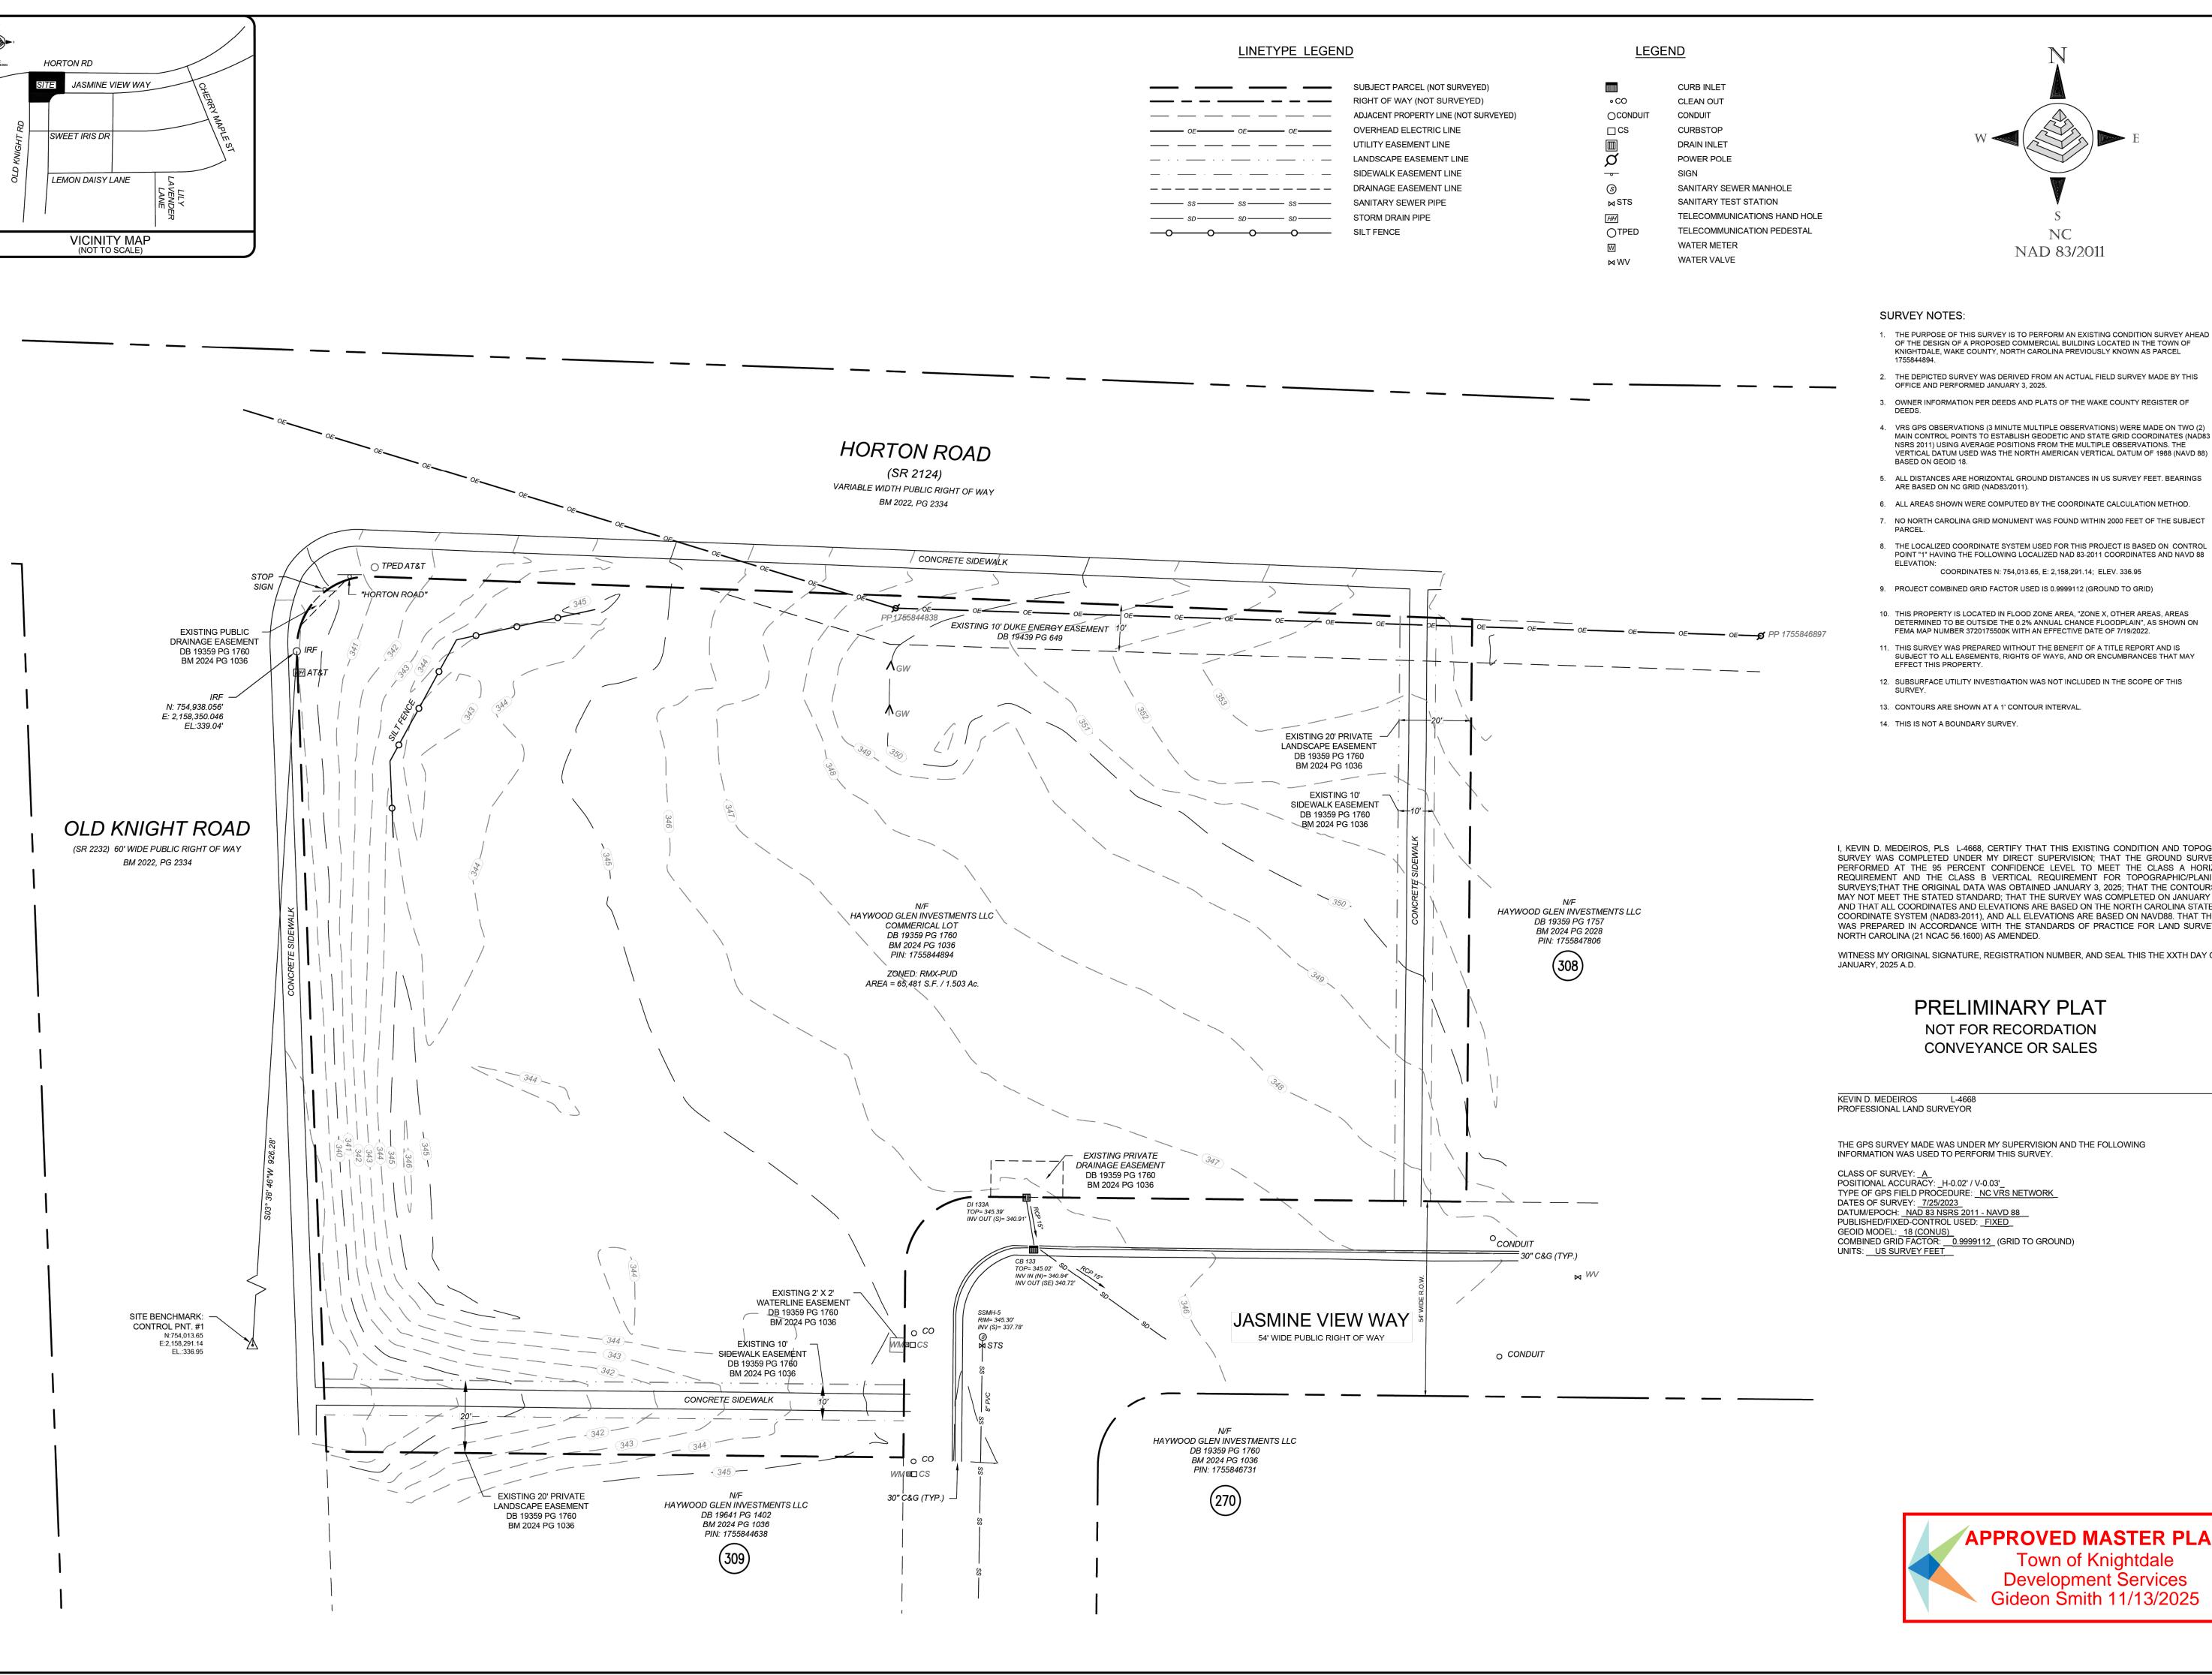

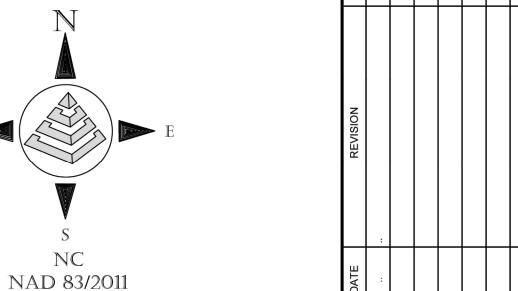

1. THE PURPOSE OF THIS SURVEY IS TO PERFORM AN EXISTING CONDITION SURVEY AHEAD OF THE DESIGN OF A PROPOSED COMMERCIAL BUILDING LOCATED IN THE TOWN OF KNIGHTDALE, WAKE COUNTY, NORTH CAROLINA PREVIOUSLY KNOWN AS PARCEL

2. THE DEPICTED SURVEY WAS DERIVED FROM AN ACTUAL FIELD SURVEY MADE BY THIS OFFICE AND PERFORMED JANUARY 3, 2025.

3. OWNER INFORMATION PER DEEDS AND PLATS OF THE WAKE COUNTY REGISTER OF

4. VRS GPS OBSERVATIONS (3 MINUTE MULTIPLE OBSERVATIONS) WERE MADE ON TWO (2) MAIN CONTROL POINTS TO ESTABLISH GEODETIC AND STATE GRID COORDINATES (NAD83 NSRS 2011) USING AVERAGE POSITIONS FROM THE MULTIPLE OBSERVATIONS. THE VERTICAL DATUM USED WAS THE NORTH AMERICAN VERTICAL DATUM OF 1988 (NAVD 88)

5. ALL DISTANCES ARE HORIZONTAL GROUND DISTANCES IN US SURVEY FEET. BEARINGS ARE BASED ON NC GRID (NAD83/2011).

6. ALL AREAS SHOWN WERE COMPUTED BY THE COORDINATE CALCULATION METHOD.

THE LOCALIZED COORDINATE SYSTEM USED FOR THIS PROJECT IS BASED ON CONTROL POINT "1" HAVING THE FOLLOWING LOCALIZED NAD 83-2011 COORDINATES AND NAVD 88

9. PROJECT COMBINED GRID FACTOR USED IS 0.9999112 (GROUND TO GRID)

10. THIS PROPERTY IS LOCATED IN FLOOD ZONE AREA, "ZONE X, OTHER AREAS, AREAS DETERMINED TO BE OUTSIDE THE 0.2% ANNUAL CHANCE FLOODPLAIN", AS SHOWN ON

11. THIS SURVEY WAS PREPARED WITHOUT THE BENEFIT OF A TITLE REPORT AND IS SUBJECT TO ALL EASEMENTS, RIGHTS OF WAYS, AND OR ENCUMBRANCES THAT MAY

12. SUBSURFACE UTILITY INVESTIGATION WAS NOT INCLUDED IN THE SCOPE OF THIS

13. CONTOURS ARE SHOWN AT A 1' CONTOUR INTERVAL.

14. THIS IS NOT A BOUNDARY SURVEY.

I, KEVIN D. MEDEIROS, PLS L-4668, CERTIFY THAT THIS EXISTING CONDITION AND TOPOGRAPHIC SURVEY WAS COMPLETED UNDER MY DIRECT SUPERVISION; THAT THE GROUND SURVEY WAS PERFORMED AT THE 95 PERCENT CONFIDENCE LEVEL TO MEET THE CLASS A HORIZONTAL REQUIREMENT AND THE CLASS B VERTICAL REQUIREMENT FOR TOPOGRAPHIC/PLANIMETRIC SURVEYS;THAT THE ORIGINAL DATA WAS OBTAINED JANUARY 3, 2025; THAT THE CONTOURS LINES MAY NOT MEET THE STATED STANDARD; THAT THE SURVEY WAS COMPLETED ON JANUARY 3, 2025; AND THAT ALL COORDINATES AND ELEVATIONS ARE BASED ON THE NORTH CAROLINA STATE PLANE COORDINATE SYSTEM (NAD83-2011), AND ALL ELEVATIONS ARE BASED ON NAVD88. THAT THIS PLAT WAS PREPARED IN ACCORDANCE WITH THE STANDARDS OF PRACTICE FOR LAND SURVEYING IN NORTH CAROLINA (21 NCAC 56.1600) AS AMENDED.

WITNESS MY ORIGINAL SIGNATURE, REGISTRATION NUMBER, AND SEAL THIS THE XXTH DAY OF

PRELIMINARY PLAT NOT FOR RECORDATION CONVEYANCE OR SALES


THE GPS SURVEY MADE WAS UNDER MY SUPERVISION AND THE FOLLOWING INFORMATION WAS USED TO PERFORM THIS SURVEY.

TYPE OF GPS FIELD PROCEDURE: NC VRS NETWORK DATUM/EPOCH: NAD 83 NSRS 2011 - NAVD 88
PUBLISHED/FIXED-CONTROL USED: FIXED GEOID MODEL: 18 (CONUS)

COMBINED GRID FACTOR: 0.9999112 (GRID TO GROUND)

UNITS: US SURVEY FEET

> APPROVED MASTER PLAN Town of Knightdale Development Services Gideon Smith 11/13/2025

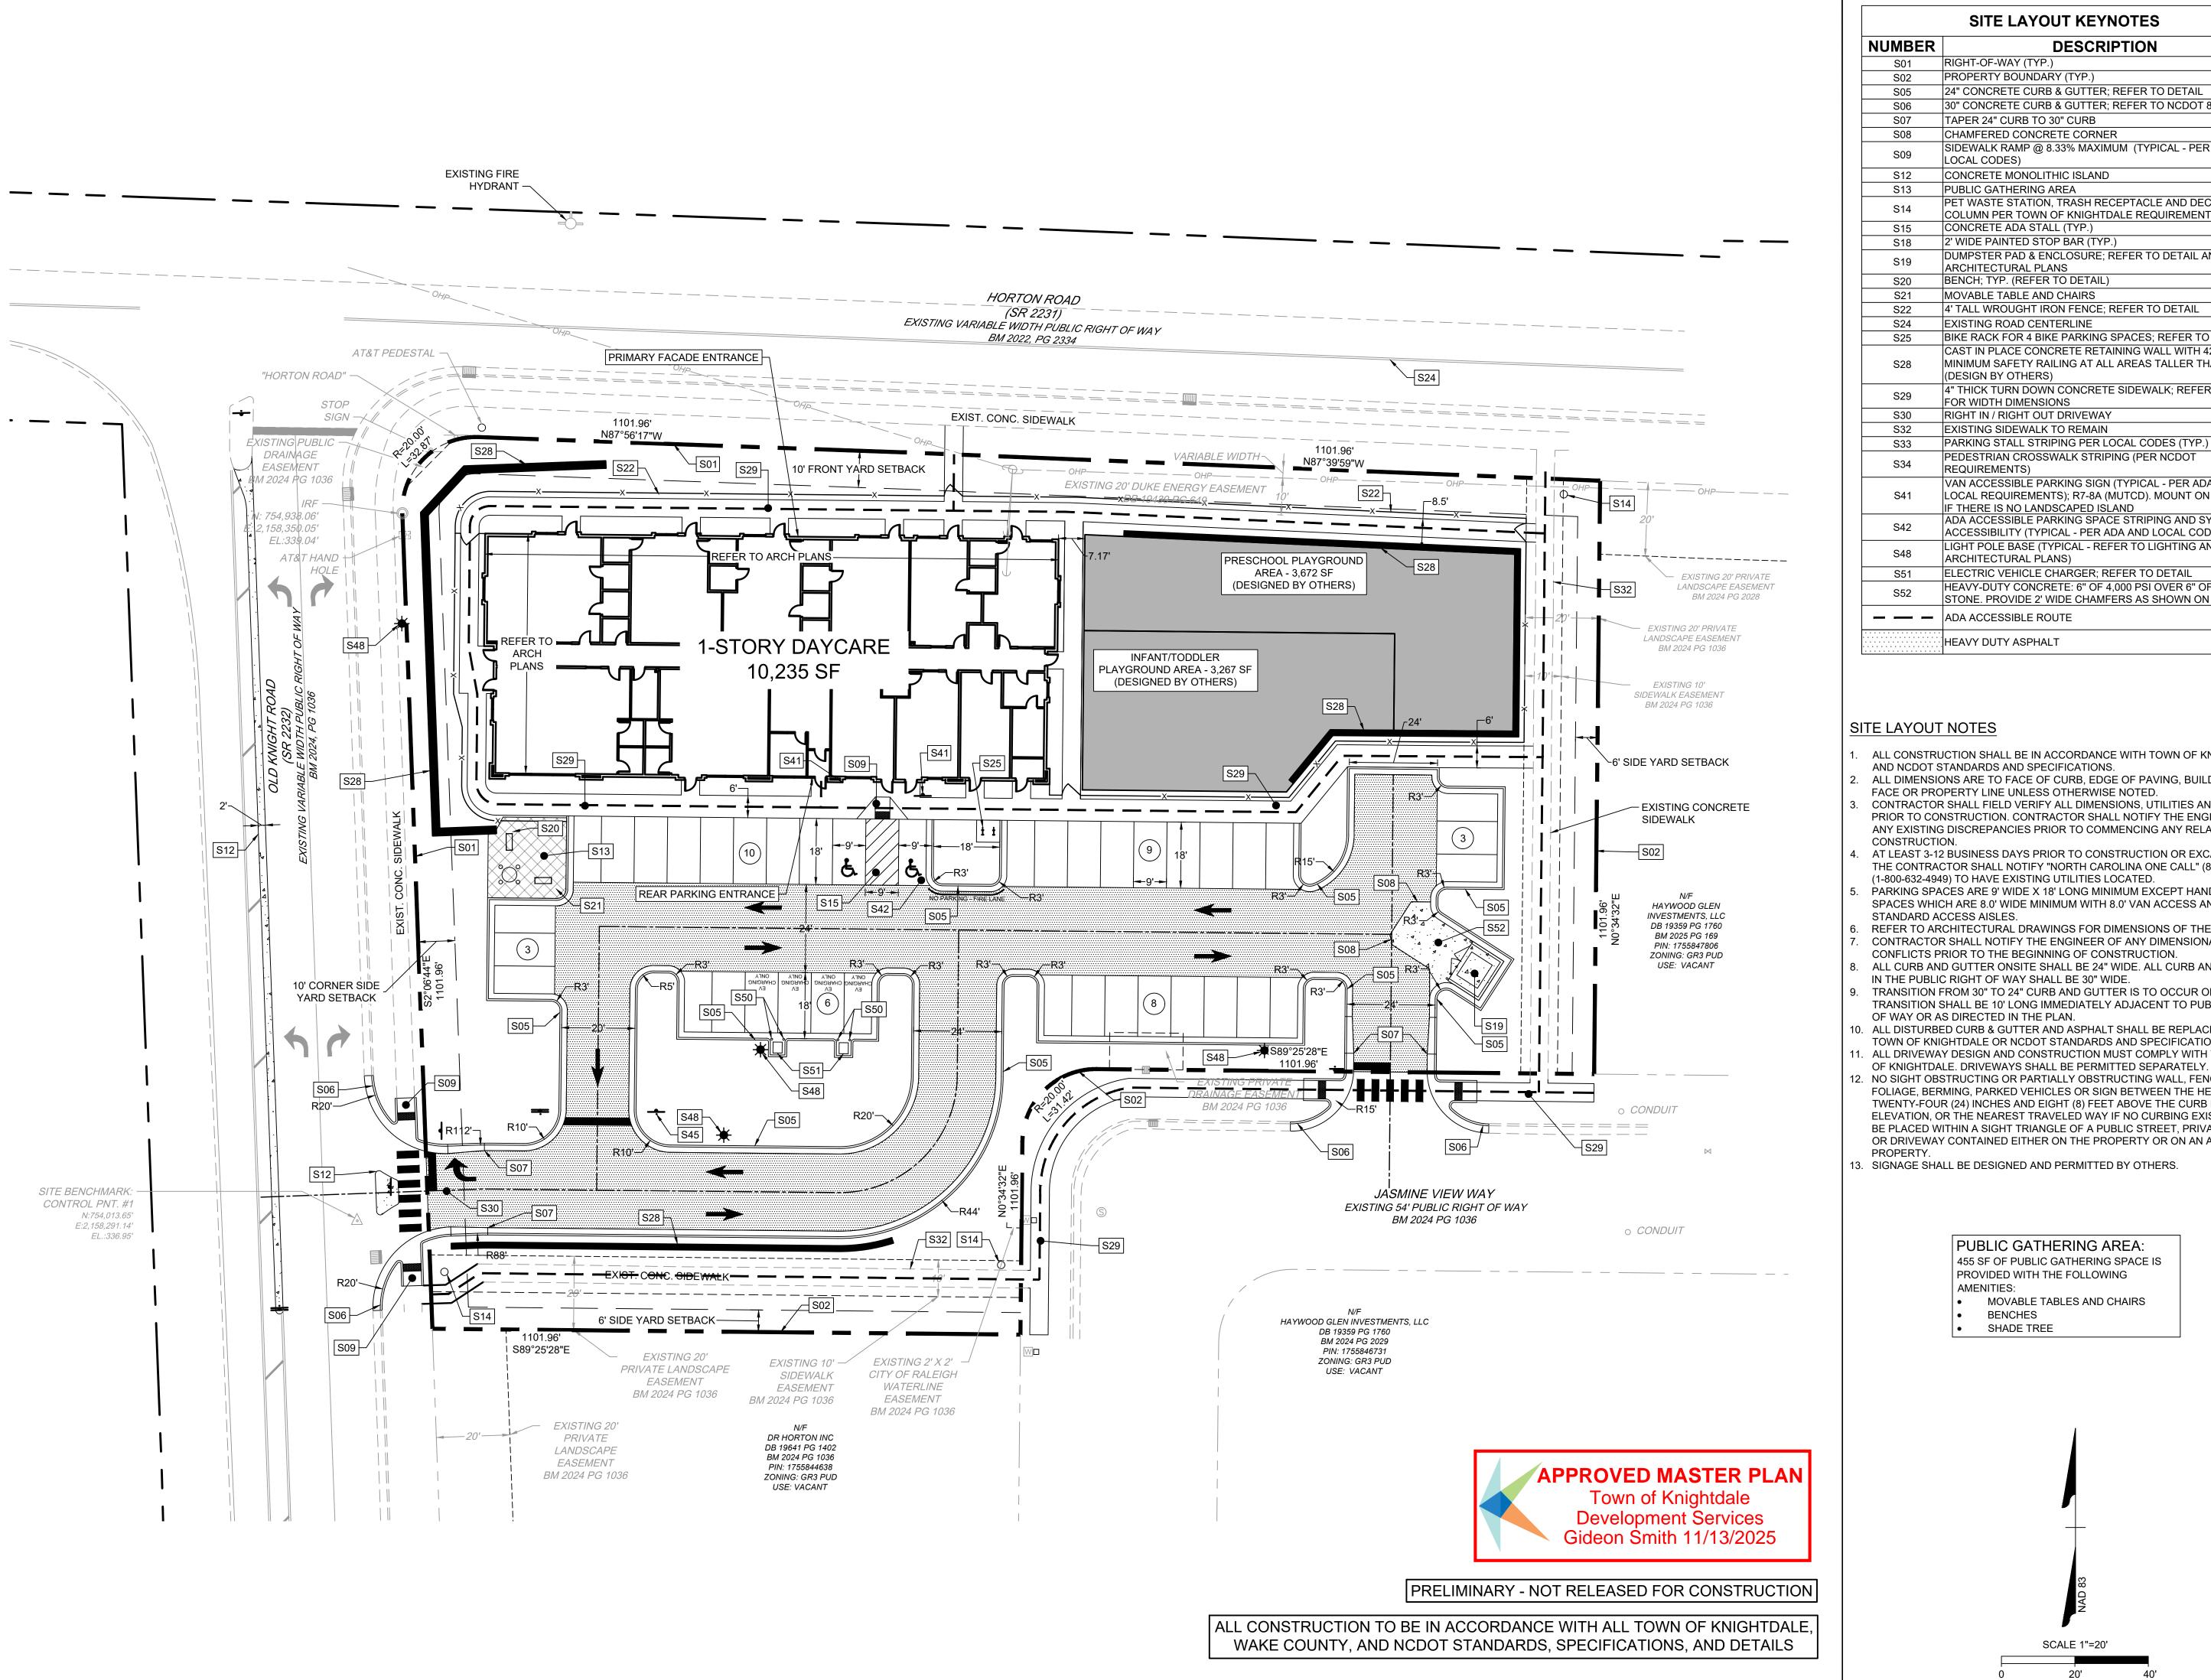


NUMBER	DESCRIPTION
S01	RIGHT-OF-WAY (TYP.)
S02	PROPERTY BOUNDARY (TYP.)
S05	24" CONCRETE CURB & GUTTER; REFER TO DETAIL
S06	30" CONCRETE CURB & GUTTER; REFER TO NCDOT 846.01
S07	TAPER 24" CURB TO 30" CURB
S08	CHAMFERED CONCRETE CORNER
S09	SIDEWALK RAMP @ 8.33% MAXIMUM (TYPICAL - PER ADA AI LOCAL CODES)
S12	CONCRETE MONOLITHIC ISLAND
S13	PUBLIC GATHERING AREA
S14	PET WASTE STATION, TRASH RECEPTACLE AND DECORATIVE COLUMN PER TOWN OF KNIGHTDALE REQUIREMENTS
S15	CONCRETE ADA STALL (TYP.)
S18	2' WIDE PAINTED STOP BAR (TYP.)
S19	DUMPSTER PAD & ENCLOSURE; REFER TO DETAIL AND ARCHITECTURAL PLANS
S20	BENCH; TYP. (REFER TO DETAIL)
S21	MOVABLE TABLE AND CHAIRS
S22	4' TALL WROUGHT IRON FENCE; REFER TO DETAIL
S24	EXISTING ROAD CENTERLINE
S25	BIKE RACK FOR 4 BIKE PARKING SPACES; REFER TO DETAIL
S28	CAST IN PLACE CONCRETE RETAINING WALL WITH 42" MINIMUM SAFETY RAILING AT ALL AREAS TALLER THAN 30" (DESIGN BY OTHERS)
S29	4" THICK TURN DOWN CONCRETE SIDEWALK; REFER TO PLA FOR WIDTH DIMENSIONS
S30	RIGHT IN / RIGHT OUT DRIVEWAY
S32	EXISTING SIDEWALK TO REMAIN
S33	PARKING STALL STRIPING PER LOCAL CODES (TYP.)
S34	PEDESTRIAN CROSSWALK STRIPING (PER NCDOT REQUIREMENTS)
S41	VAN ACCESSIBLE PARKING SIGN (TYPICAL - PER ADA AND LOCAL REQUIREMENTS); R7-8A (MUTCD). MOUNT ON BUILDI IF THERE IS NO LANDSCAPED ISLAND
S42	ADA ACCESSIBLE PARKING SPACE STRIPING AND SYMBOL (ACCESSIBILITY (TYPICAL - PER ADA AND LOCAL CODES)
S48	LIGHT POLE BASE (TYPICAL - REFER TO LIGHTING AND ARCHITECTURAL PLANS)
S51	ELECTRIC VEHICLE CHARGER; REFER TO DETAIL
S52	HEAVY-DUTY CONCRETE: 6" OF 4,000 PSI OVER 6" OF ABC STONE. PROVIDE 2' WIDE CHAMFERS AS SHOWN ON PLAN.
	ADA ACCESSIBLE ROUTE
	HEAVY DUTY ASPHALT

- ALL CONSTRUCTION SHALL BE IN ACCORDANCE WITH TOWN OF KNIGHTDALE
- ALL DIMENSIONS ARE TO FACE OF CURB, EDGE OF PAVING, BUILDING WALL FACE OR PROPERTY LINE UNLESS OTHERWISE NOTED.
- CONTRACTOR SHALL FIELD VERIFY ALL DIMENSIONS, UTILITIES AND GRADES PRIOR TO CONSTRUCTION. CONTRACTOR SHALL NOTIFY THE ENGINEER OF ANY EXISTING DISCREPANCIES PRIOR TO COMMENCING ANY RELATED
- AT LEAST 3-12 BUSINESS DAYS PRIOR TO CONSTRUCTION OR EXCAVATION THE CONTRACTOR SHALL NOTIFY "NORTH CAROLINA ONE CALL" (811) OR (1-800-632-4949) TO HAVE EXISTING UTILITIES LOCATED.
- PARKING SPACES ARE 9' WIDE X 18' LONG MINIMUM EXCEPT HANDICAP SPACES WHICH ARE 8.0' WIDE MINIMUM WITH 8.0' VAN ACCESS AND 5.0' STANDARD ACCESS AISLES.
- REFER TO ARCHITECTURAL DRAWINGS FOR DIMENSIONS OF THE BUILDING. CONTRACTOR SHALL NOTIFY THE ENGINEER OF ANY DIMENSIONAL CONFLICTS PRIOR TO THE BEGINNING OF CONSTRUCTION.
- ALL CURB AND GUTTER ONSITE SHALL BE 24" WIDE. ALL CURB AND GUTTER IN THE PUBLIC RIGHT OF WAY SHALL BE 30" WIDE.
- TRANSITION FROM 30" TO 24" CURB AND GUTTER IS TO OCCUR ON-SITE. THIS TRANSITION SHALL BE 10' LONG IMMEDIATELY ADJACENT TO PUBLIC RIGHT OF WAY OR AS DIRECTED IN THE PLAN.
- 10. ALL DISTURBED CURB & GUTTER AND ASPHALT SHALL BE REPLACED PER TOWN OF KNIGHTDALE OR NCDOT STANDARDS AND SPECIFICATIONS. . ALL DRIVEWAY DESIGN AND CONSTRUCTION MUST COMPLY WITH THE TOWN
- NO SIGHT OBSTRUCTING OR PARTIALLY OBSTRUCTING WALL, FENCE, FOLIAGE, BERMING, PARKED VEHICLES OR SIGN BETWEEN THE HEIGHTS OF TWENTY-FOUR (24) INCHES AND EIGHT (8) FEET ABOVE THE CURB LINE ELEVATION, OR THE NEAREST TRAVELED WAY IF NO CURBING EXISTS, SHALL BE PLACED WITHIN A SIGHT TRIANGLE OF A PUBLIC STREET, PRIVATE STREET OR DRIVEWAY CONTAINED EITHER ON THE PROPERTY OR ON AN ADJOINING
- 13. SIGNAGE SHALL BE DESIGNED AND PERMITTED BY OTHERS.

PUBLIC GATHERING AREA: 455 SF OF PUBLIC GATHERING SPACE IS PROVIDED WITH THE FOLLOWING AMENITIES: MOVABLE TABLES AND CHAIRS

BENCHES SHADE TREE

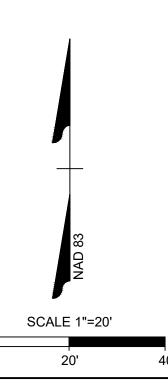


07/07/2025

DESIGNED BY CHECKED BY

M. DAVIDSON


AS SHOWN

JOB NO. 70434 SHEET NO. C2.0

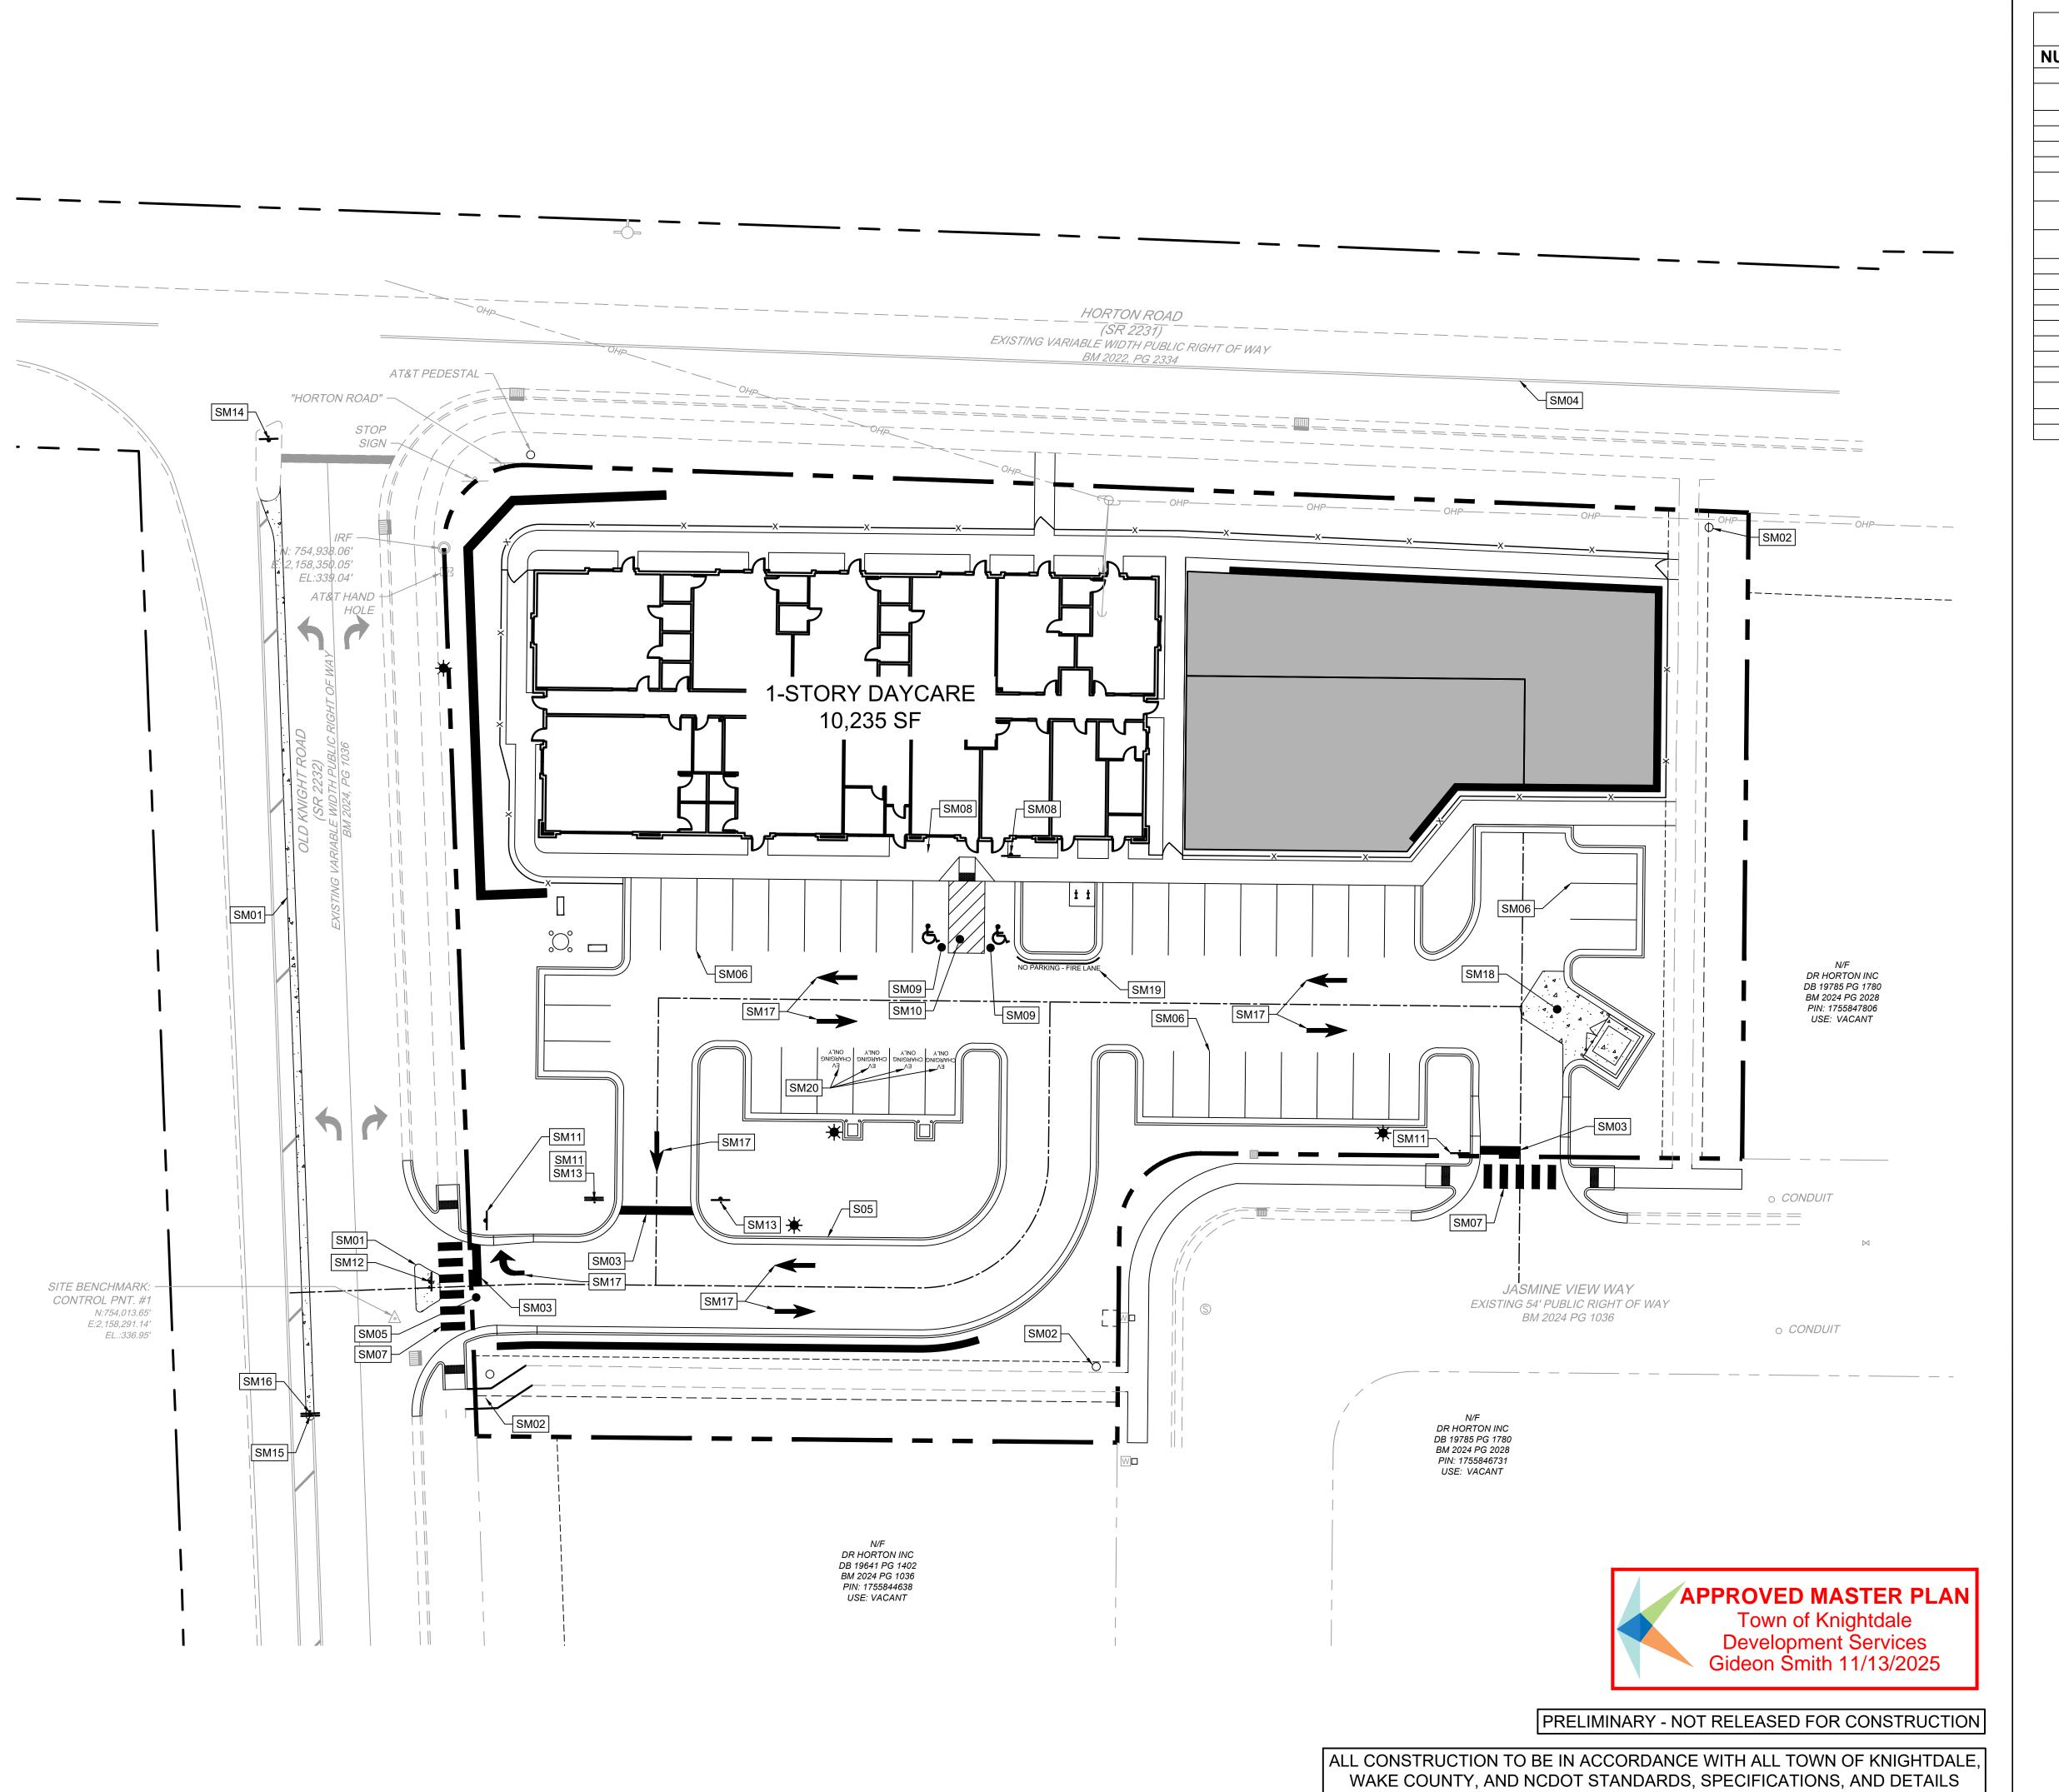

NUMBER	DESCRIPTION
SM01	CONCRETE MONOLITHIC ISLAND
SM02	PET WASTE STATION, TRASH RECEPTACLE AND DECORATIVE COLUMN PER TOWN OF KNIGHTDALE REQUIREMENTS
SM03	2' WIDE PAINTED STOP BAR (TYP.)
SM04	EXISTING ROAD CENTERLINE
SM05	RIGHT IN / RIGHT OUT DRIVEWAY
SM06	PARKING STALL STRIPING PER LOCAL CODES (TYP.)
SM07	HIGH VISIBILITY PEDESTRIAN CROSSWALK STRIPING (PER NCDOT & TOWN OF KNIGHTDALE REQUIREMENTS)
SM08	VAN ACCESSIBLE PARKING SIGN (TYPICAL - PER ADA AND LOCAL REQUIREMENTS); R7-8A (MUTCD)
SM09	ADA ACCESSIBLE PARKING SPACE STRIPING AND SYMBOL OF ACCESSIBILITY (TYPICAL - PER ADA AND LOCAL CODES)
SM10	CONCRETE ADA STALL (TYP.)
SM11	"STOP" SIGN; R1-1 (MUTCD)
SM12	"RIGHT TURN ONLY" SIGN; R3-5 (MUTCD)
SM13	"DO NOT ENTER" SIGN; R5-1 (MUTCD)
SM14	"KEEP RIGHT" SIGN; R4-7 (MUTCD)
SM15	"KEEP RIGHT" SIGN; R4-7C (MUTCD)
SM16	"NO U-TURN" SIGN; R3-4 (MUTCD)
SM17	DIRECTIONAL TRAFFIC ARROW (PER LOCAL CODES)
SM18	HEAVY-DUTY CONCRETE: 6" OF 4,000 PSI OVER 6" OF ABC STONE. PROVIDE 2' WIDE CHAMFERS AS SHOWN ON PLAN.
SM19	"NO PARKING - FIRE LANE" PAVEMENT MARKING
SM20	"EV CHARGING ONLY" PAVEMENT MARKING

07/07/2025 DESIGNED BY CHECKED BY M. DAVIDSON

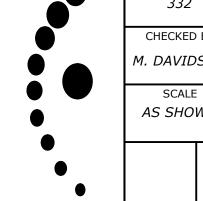


AS SHOWN

JOB NO.

70434 SHEET NO. *C2.1*

SCALE 1"=20'

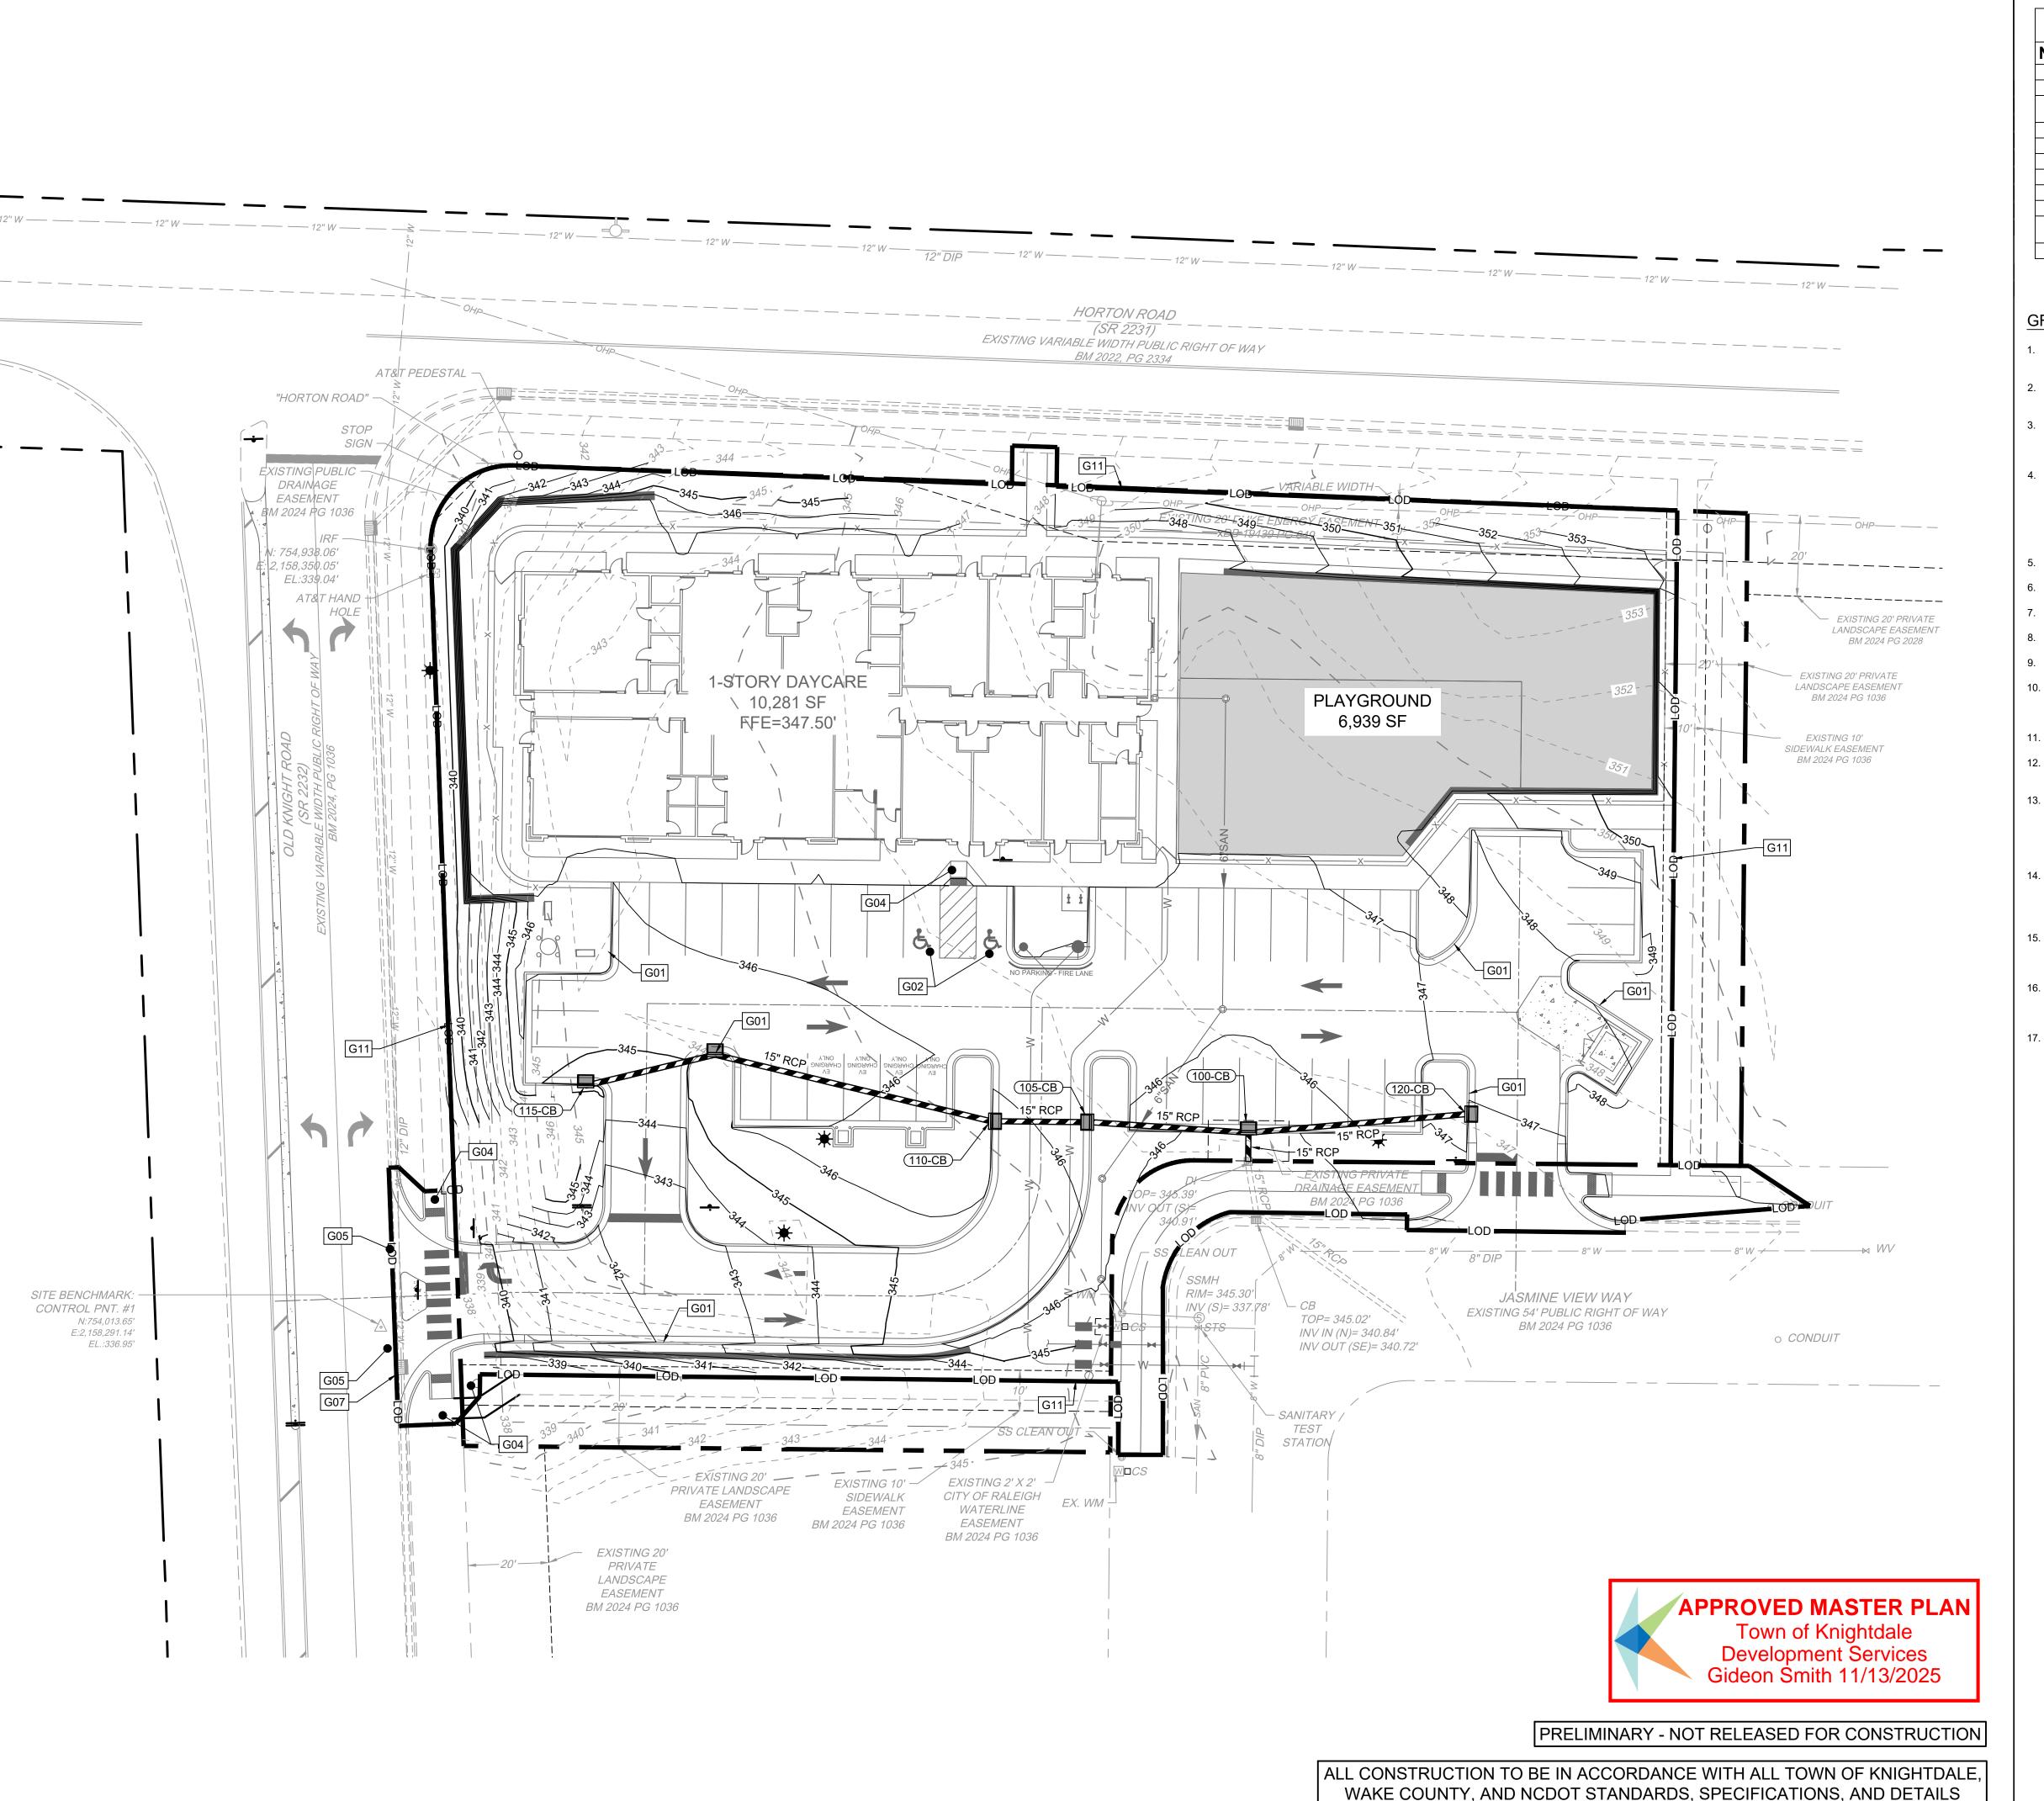

GRADING & STORMWATER KEYNOTES DESCRIPTION NUMBER G01 24" CURB & GUTTER (TYP.) ADA STALLS (MAX SLOPE 1:50) ADA ACCESS ROUTE MAX CROSS SLOPE 1:50; MAX LONG. ADA RAMP (TYP.) MATCH EXISTING PAVEMENT ELEVATION LIMITS OF SAWCUT AND PAVEMENT REMOVAL CONVERT EXISTING STRUCTURE TO DROP INLET G08 EXISTING PERMANENT DRAINAGE EASEMENT EXISTING PERMANENT UTILITY EASEMENT ROOF DRAIN (TYP.); MIN. COVER OF 2' AND MIN. SLOPE OF LIMITS OF DISTURBANCE (TYP.) G11

GRADING AND STORM DRAINAGE NOTES

- CONTRACTOR SHALL CALL "NORTH CAROLINA ONE CALL" (811) AT LEAST 3 DAYS PRIOR TO DIGGING TO HAVE EXISTING UTILITIES LOCATED. REPORT ANY DISCREPANCIES TO THE ENGINEER.
- CONTRACTOR TO COORDINATE ACTIVITIES WITH UTILITY COMPANIES INVOLVED IN ANY RELATED RELOCATION (I.E. POWER POLES, TELEPHONE PEDESTALS, WATER METERS, ETC.).
- EXISTING UTILITIES SHOWN ARE BASED ON FIELD SURVEYS AND THE BEST AVAILABLE RECORD DRAWINGS. THE CONTRACTOR SHALL VERIFY CONDITIONS PRIOR TO BEGINNING CONSTRUCTION. ANY DISCREPANCIES BETWEEN ACTUAL FIELD CONDITIONS AND THE PLANS SHALL BE REPORTED TO THE ENGINEER IMMEDIATELY. THE CATCH BASINS AND YARD INLETS SHALL BE CONSTRUCTED IN THE LOCATIONS SHOWN UNLESS OTHERWISE DIRECTED BY THE ENGINEER. THE CONTRACTOR IS RESPONSIBLE FOR REPORTING ANY DISCREPANCIES IN THE CATCH BASIN ELEVATIONS OR THE PROPOSED PIPE SLOPES TO THE ENGINEER. THE CONTRACTOR IS ALSO RESPONSIBLE TO REPORT ANY CONFLICTS BETWEEN ANY UTILITY, STORM DRAIN LINE, WATER LINE, SEWER LINE OR ANY OTHER PROPOSED OR EXISTING STRUCTURE TO THE ENGINEER.
- A LAND DISTURBING PERMIT WILL BE REQUIRED PRIOR TO THE COMMENCEMENT OF ANY LAND-DISTURBING ACTIVITIES.
- ALL EXISTING VAULTS, MANHOLES, STORM DRAIN STRUCTURES, VALVE BOXES, CLEANOUTS, ETC. SHALL BE ADJUSTED AS NEEDED TO MATCH FINISHED GRADE. ALL BACKFILL, COMPACTION, SOILS TESTING, ETC. SHALL BE PERFORMED BY THE
- OWNER'S INDEPENDENT TESTING LABORATORY. ALL SPOT ELEVATIONS INDICATED ARE AT TOP OF CURB UNLESS NOTED OTHERWISE
- ALL ELEVATIONS ARE BASED ON VERTICAL DATUM NAVD88. A PRE-CONSTRUCTION MEETING MUST BE SCHEDULED PRIOR TO ANY WORK,
- GRADING OR INSTALLATION OF EROSION CONTROL MEASURES. ALL HANDICAP PARKING SPACES AND STRIPED ACCESSIBILITY AISLES ARE TO HAVE NO MORE THAN A 1:50 (2.0%) SLOPE IN ALL DIRECTIONS. ALL SIDEWALKS ARE TO HAVE NO MORE THAN A 1:20 (5.0%) SLOPE FOR THE LENGTH OF THE SIDEWALK AND
- NO MORE THAN A 1:50 (2.0%) SLOPE FOR THE WIDTH OF THE SIDEWALK. CONTRACTOR TO IDENTIFY ALL NECESSARY SPILL CURB SECTION LOCATIONS AND INSTALL TO ENSURE POSITIVE DRAINAGE TO STORM STRUCTURES.
- IF CONTRACTOR NOTICES ANY DISCREPANCIES IN ANY OF THESE SLOPE REQUIREMENTS, IT IS THE CONTRACTOR'S RESPONSIBILITY TO CONTACT THE OWNER PRIOR TO POURING ANY CONCRETE SO THAT A SOLUTION CAN BE FOUND. SPOT ELEVATIONS ARE GIVEN AT THE MAJORITY OF THE MAJOR BREAK POINTS BUT
- IT SHOULD NOT BE ASSUMED THAT ALL NECESSARY SPOT ELEVATIONS ARE SHOWN. DUE TO SPACE LIMITATIONS, THERE MAY BE OTHER CRITICAL SPOTS NOT LABELED THAT SHOULD BE TAKEN INTO CONSIDERATION. THE CONTRACTOR SHALL REVIEW THE GRADING PLAN IN DETAIL AND SHALL ENSURE THAT ALL CRITICAL GRADE POINTS ARE STAKED AND FOLLOWED TO PROVIDE POSITIVE DRAINAGE.
- EXISTING VEGETATION WITHIN TREE PROTECTIVE AREAS SHALL REMAIN UNDISTURBED UNLESS NOTED OTHERWISE. ANY AND ALL LANDSCAPING AND EXISTING TREES AND SHRUBS TO REMAIN WHICH ARE DAMAGED DURING DEMOLITION OR CONSTRUCTION SHALL BE REPLACED BY THE CONTRACTOR USING A LICENSED LANDSCAPE CONTRACTOR AT NO ADDITIONAL COST TO THE OWNER.
- THE GRADING CONTRACTOR SHALL COMPLY WITH ALL STATE CODES IN OBSERVING EROSION CONTROL MEASURES BOTH ON AND OFF-SITE. THE GRADING CONTRACTOR SHALL MAINTAIN ALL EROSION CONTROL DEVICES AFTER EACH RAINFALL EVENT OR AS DIRECTED BY THE EROSION CONTROL INSPECTOR OR THE ENGINEER.
- THE GRADING CONTRACTOR SHALL BE RESPONSIBLE FOR OFF-SITE DISPOSAL OF ALL CLEARING AND GRADING WASTE MATERIALS GENERATED DURING CONSTRUCTION AND FOR OBTAINING ALL APPLICABLE PERMITS FOR OFF-SITE STOCKPILES AND/OR WASTE AREAS.
- ALL CATCH BASINS MUST BE MARKED "DUMP NO WASTE DRAINS TO STREAM" OR EQUIVALENT.

IMPERVIOUS SURFACE AREA SUMMARY:

NET SITE AREA: 65,480 SF±

ONSITE IMPERVIOUS SURFACES:

PROPOSED BUILDING: 10,281 SF± PROPOSED SIDEWALK / RETAINING WALL: 4,895 SF± PROPOSED VUA: 20,175 SF± EXISTING IMPERVIOUS (SIDEWALK): 1,579 SF±


TOTAL ON-SITE IMPERVIOUS TOTAL: 36,930 SF±

ONSITE PERVIOUS SURFACES:

LANDSCAPE AREAS: 21,611 SF± PLAYGROUND AREA: 6,939 SF±

ON-SITE PERVIOUS TOTAL: 28,550 SF±

*IMPERVIOUS SURFACE AREA PREVIOUSLY ALLOCATED TO THIS PARCEL: 42,000 SF

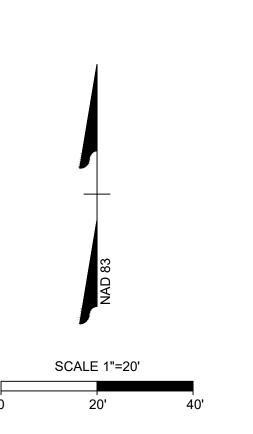

DATE

07/07/2025 *332* **DESIGNED BY**


332 CHECKED BY

M. DAVIDSON

AS SHOWN

JOB NO.

70434 SHEET NO. C3.0

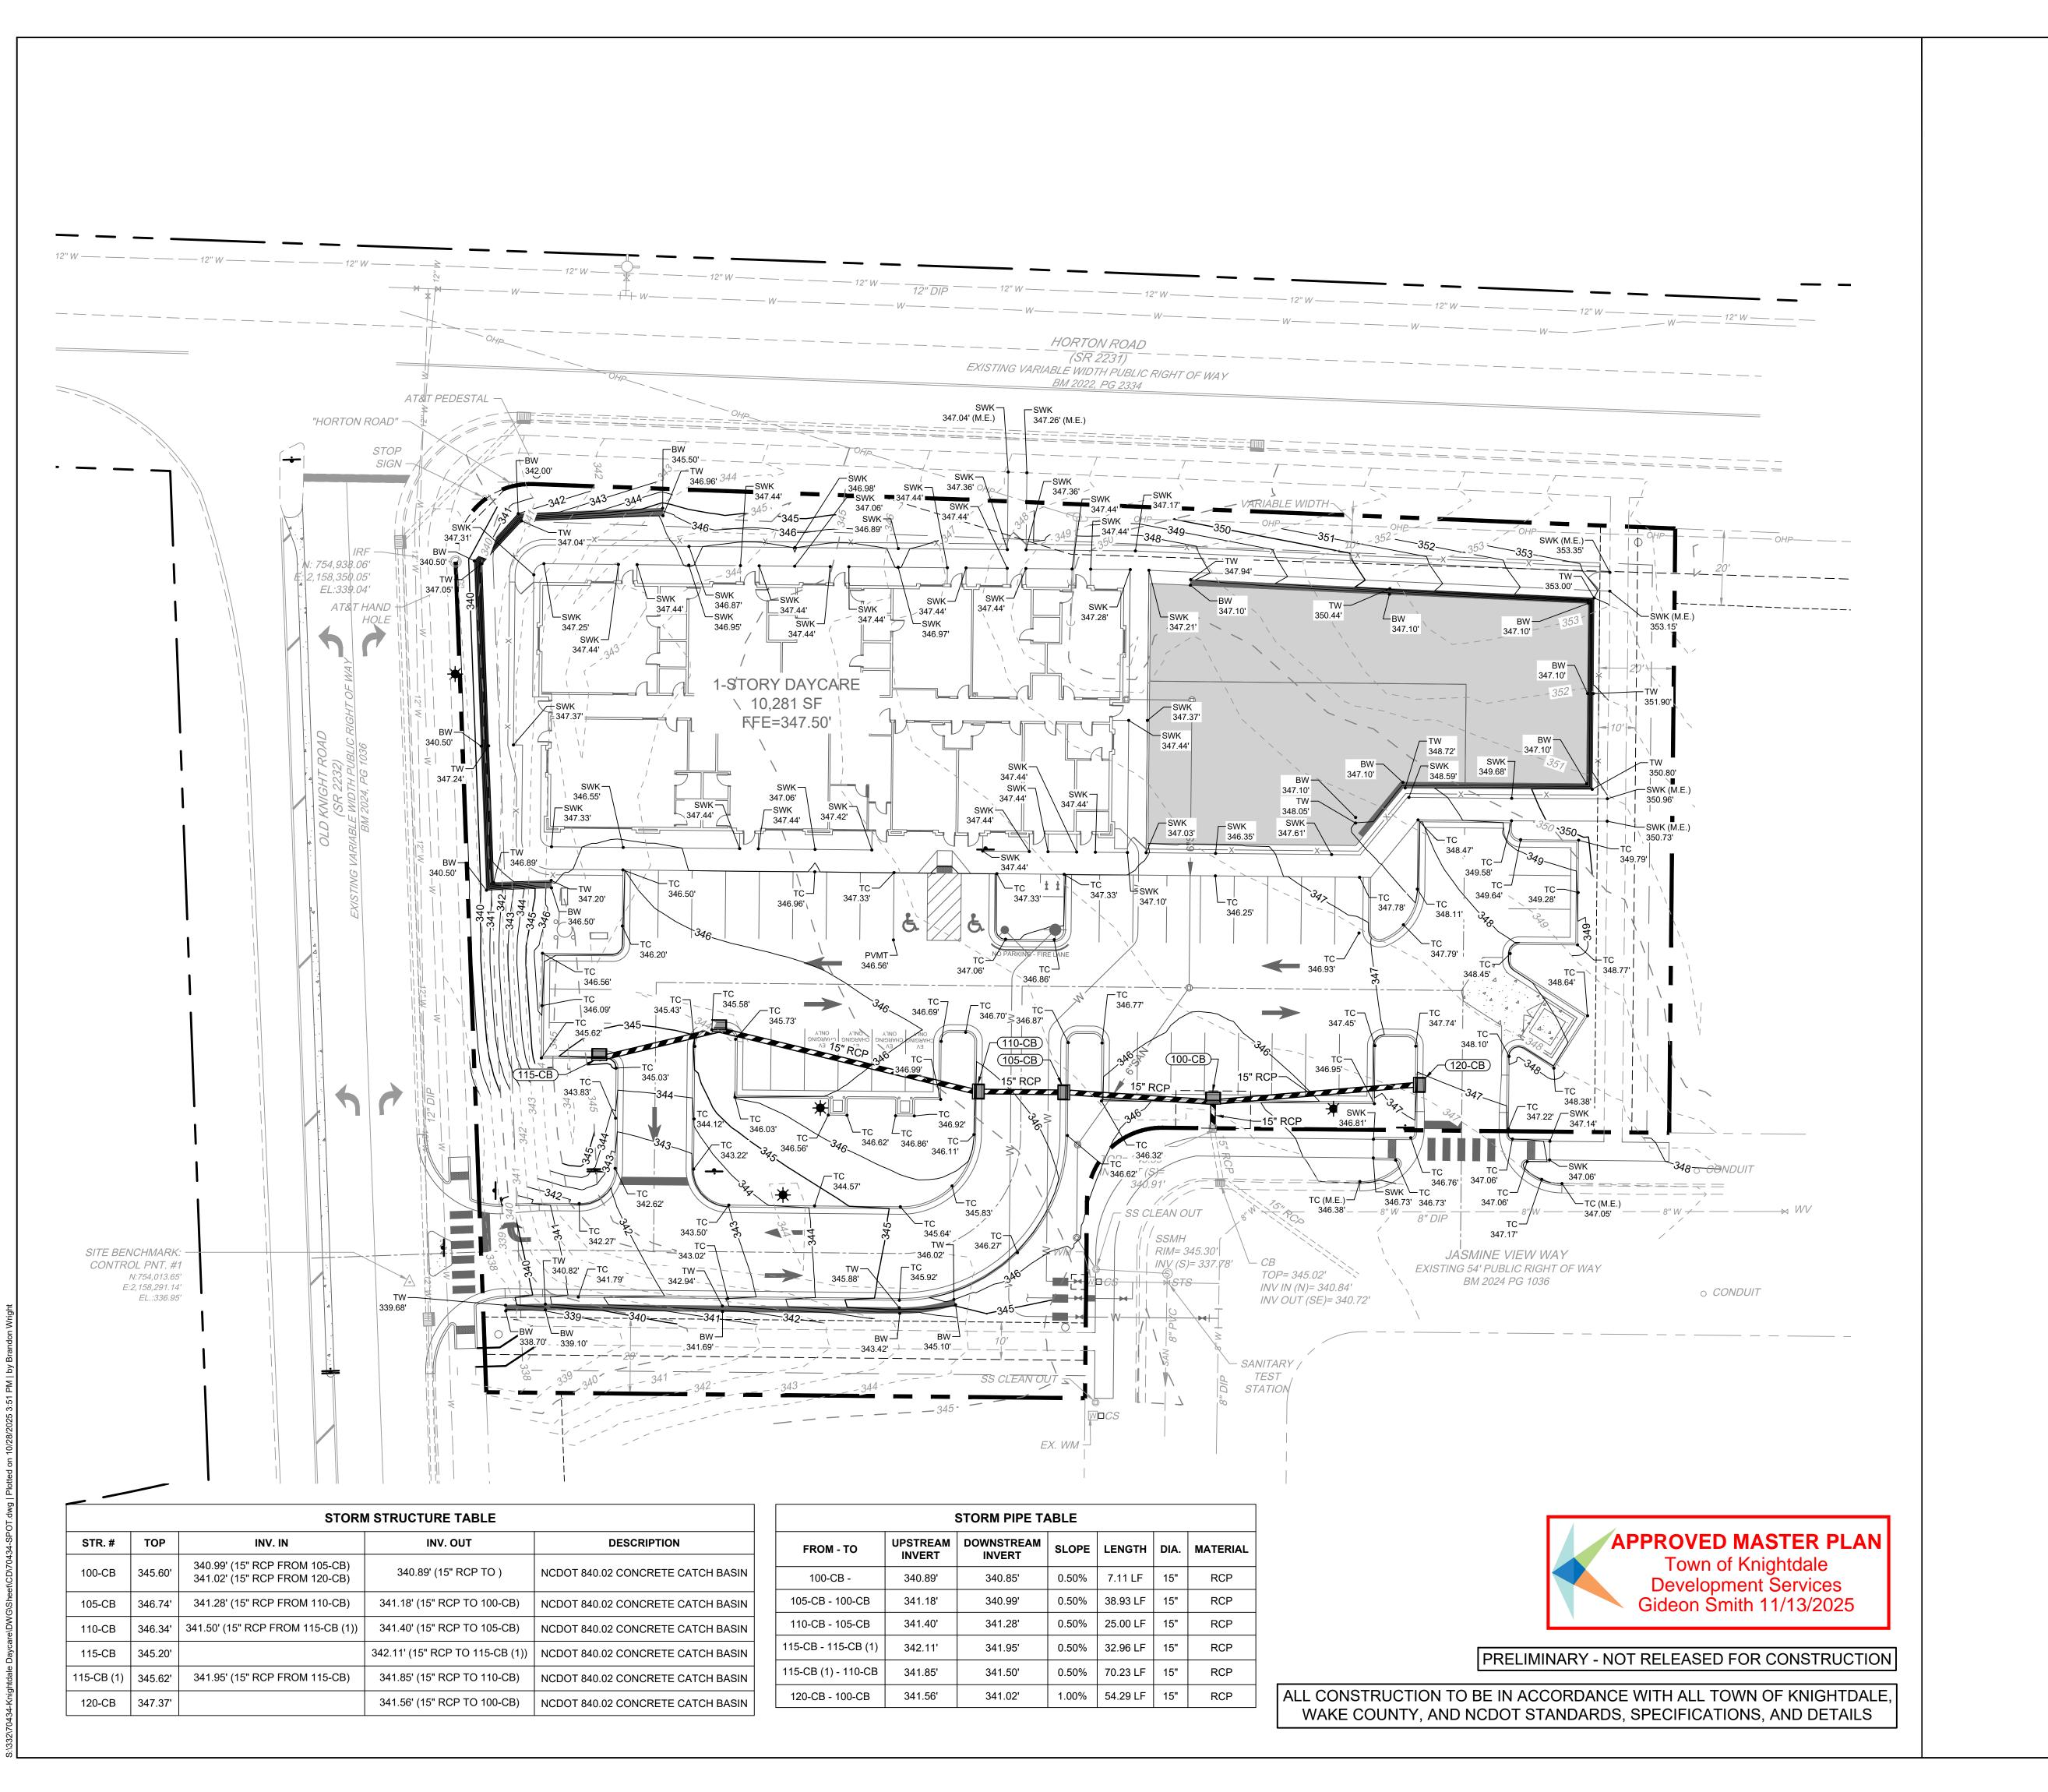

SPOT ELEVATION LEGEND TC = TOP OF CURB ME = MATCH EXISTING GND = GROUND SWK = SIDEWALK TW = TOP OF WALL BW = BOTTOM OF WALL HP = HIGH POINT FC = FLUSH CURB EOP = EDGE OF PAVEMENT PVMT = PAVEMENT

FL = FLOW LINE


1. TOP REFERS TO: 1.1. CATCH BASIN: TOP OF CURB 1.2. YARD INLET: SILL 2. SD* - SEE RISER DETAIL

SCALE 1"=20'

70434

SHEET NO. C3.1

DATE ----DRAWN BY DESIGNED BY CHECKED BY M. DAVIDSON AS SHOWN

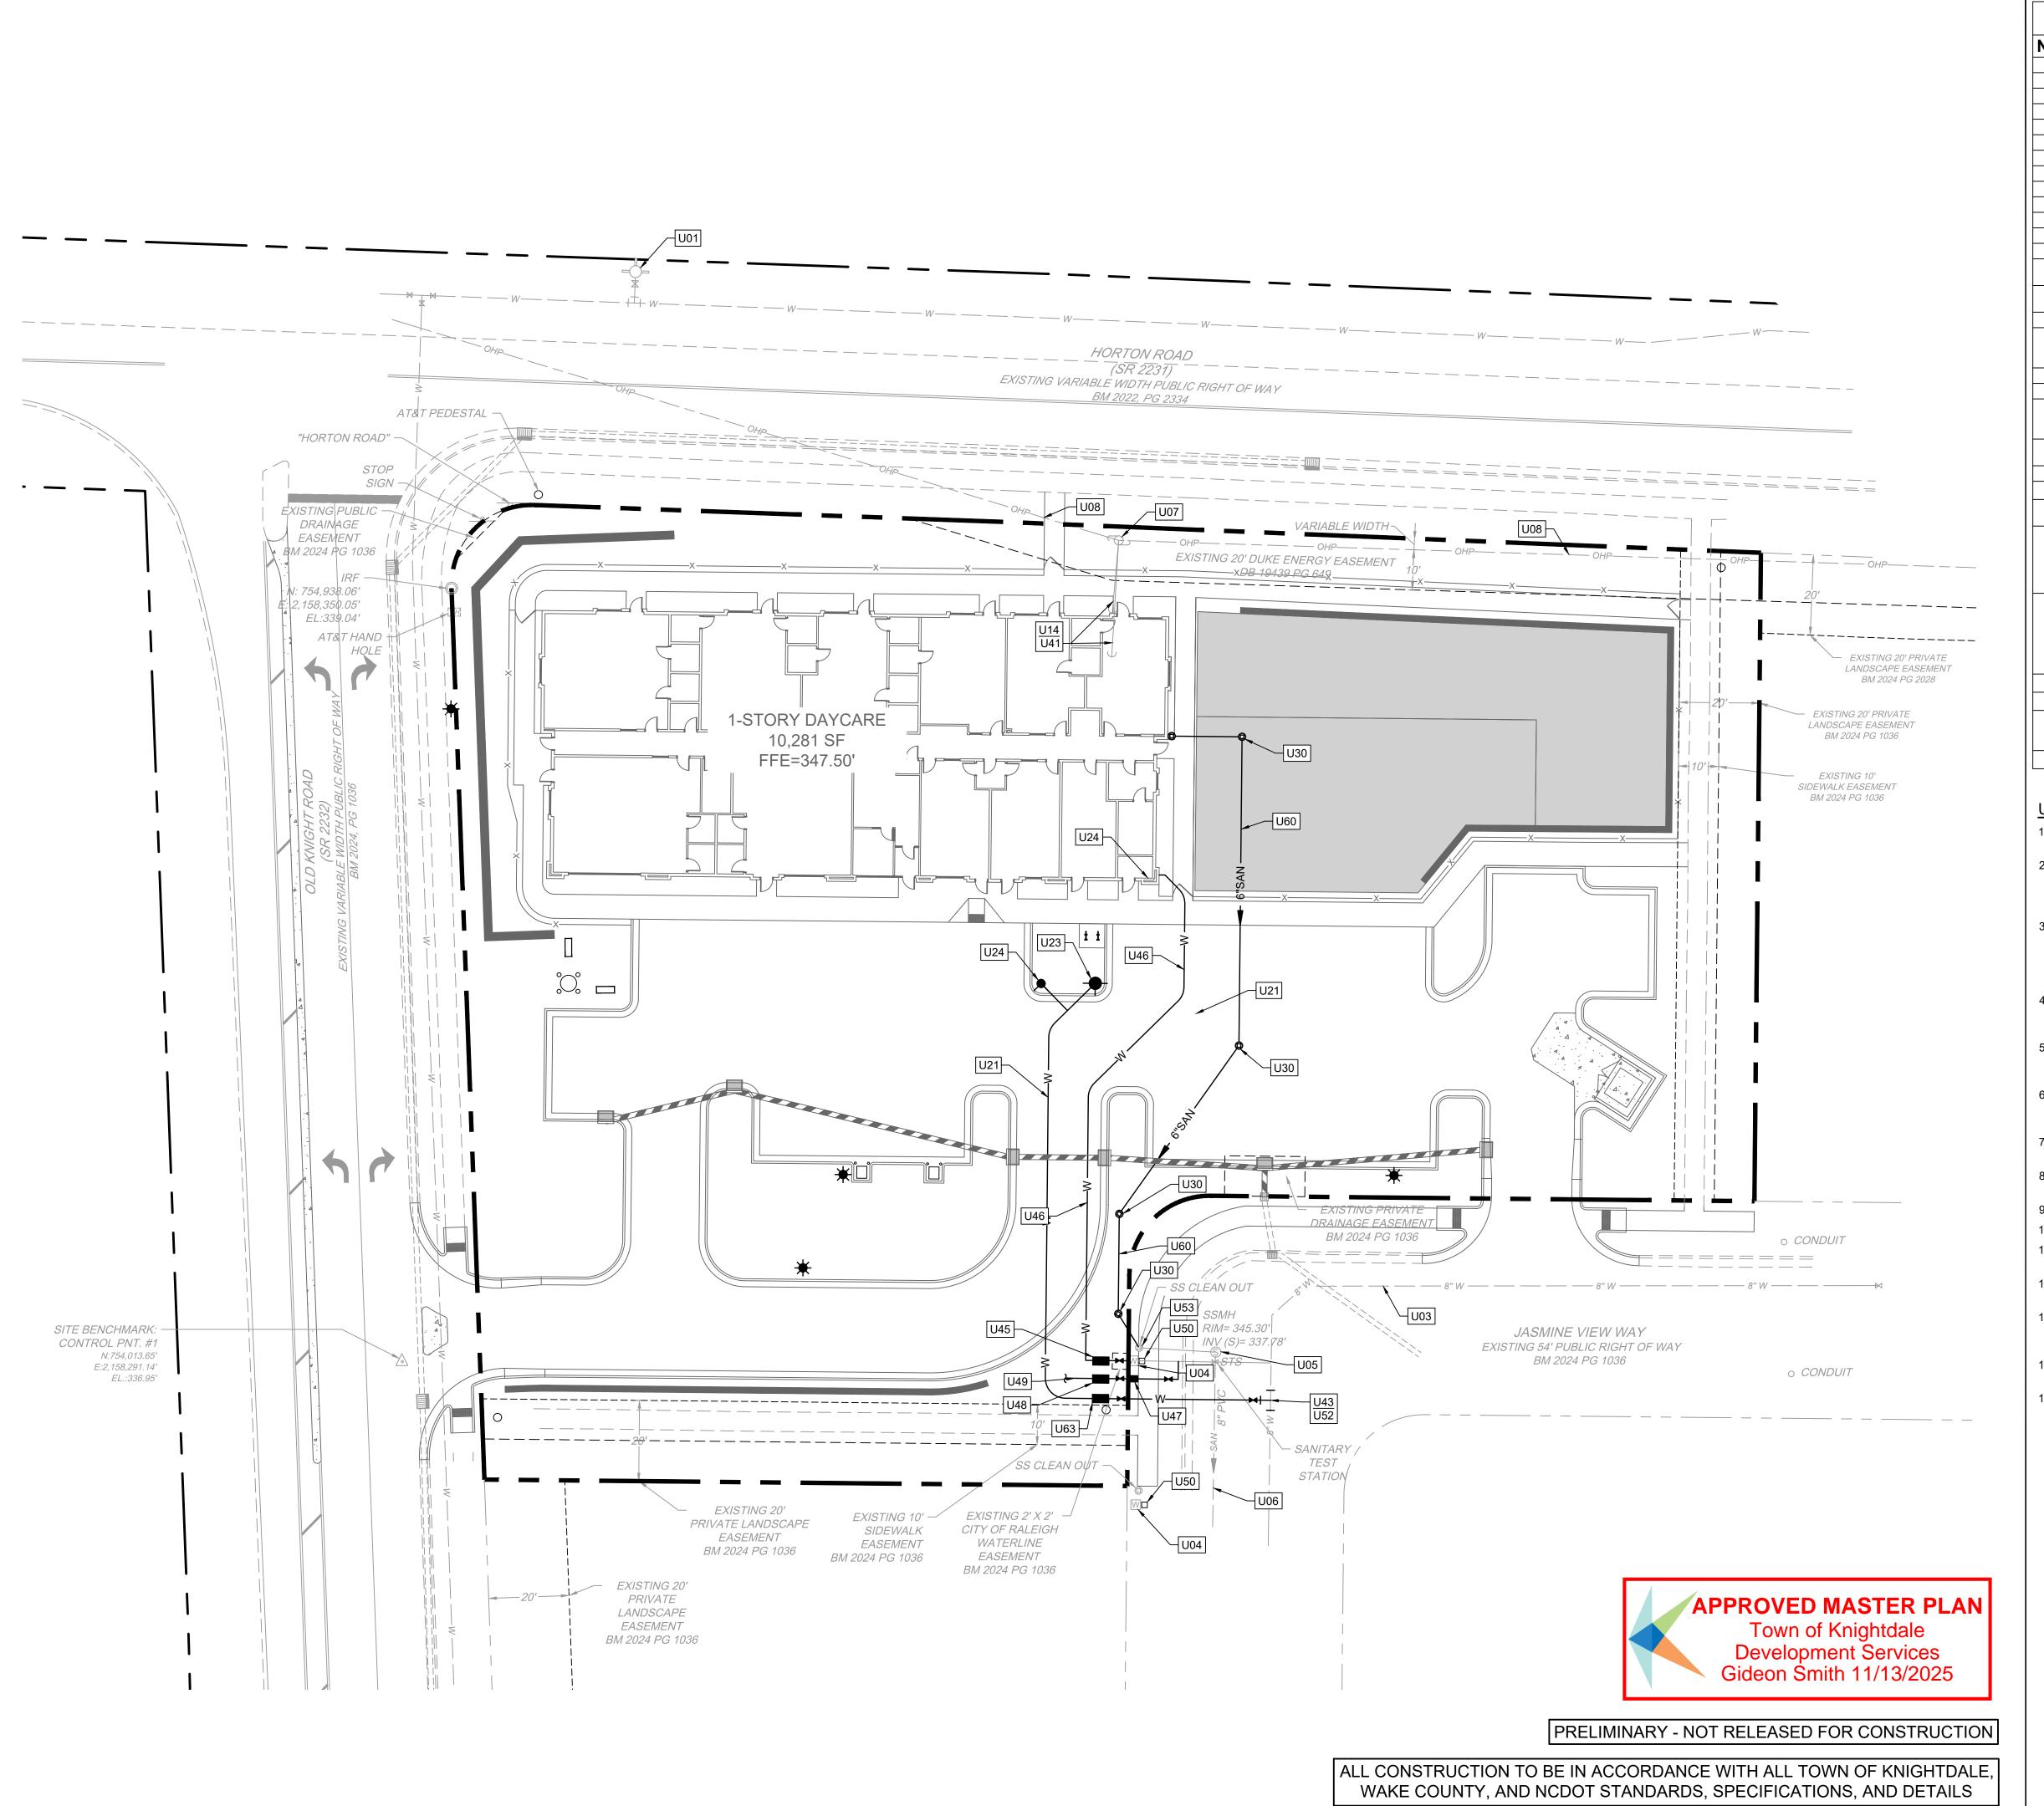


NUMBER	DESCRIPTION
U01	EXISTING FIRE HYDRANT
U03	EXISTING 8" WATERLINE
U04	EXISTING WATER METER (TYP.)
U05	EXISTING SANITARY SEWER MANHOLE (TYP.)
U06	EXISTING 8" PVC SANITARY SEWER MAIN (TYP.)
U07	EXISTING POWER POLE (TYP.)
U08	EXISTING OVERHEAD POWER LINE (TYP.)
U14	EXISTING GUY WIRE TO BE RELOCATED BY DUKE ENERGY
U16	EXISTING GAS MAIN TO REMAIN
U21	6" DIP WATER LINE
U23	FIRE HYDRANT ASSEMBLY (TYP.)
	5" STORZ FIRE DEPARTMENT CONNECTION (TYP.)
U24	
U29	HVAC UNITS AND CONCRETE PAD (TYP.)
U30	CLEANOUT (TYP.), TRAFFIC RATED IF LOCATED WITHIN PAVEMENT
	COORDINATE WITH DUKE ENERGY TO RESET EXISTING GUY WIRE
U41	TO MATCH FINISHED GRADE.
U43	TAP EXISTING 8" WATER MAIN WITH 8"X6" TEE.
0.0	2" RPZ DOMESTIC BFP IN ABOVE GRADE AND INSULATED
U45	ENCLOSURE (WILKINS 975 OR AS APPROVED BY CITY OF RALEIGH)
	REFER TO DETAIL W-36
U46	2" TYPE "K" SOFT COPPER DOMESTIC WATER SERVICE (TYP.)
U47	1" IRRIGATION METER
	1" RPZ IRRIGATION BFP IN ABOVE GRADE AND INSULATED
U48	ENCLOSURE (WILKINS 975 OR AS APPROVED BY CITY OF RALEIGH)
	REFER TO DETAIL W-36
U49	1" TYPE K COPPER WATER IRRIGATION LINE; COORDINATE
	IRRIGATION DESIGN
U50	EXISTING CURB STOP
U51	ADJUST EXISTING APPURTENANCE TO MATCH FINISHED GRADE.
U52	COORDINATE WITH WATER DEPARTMENT TO ENSURE THAT
	SERVICE IS NOT INTERRUPTED AT ANY TIME.
	CONNECT TO EXISTING SANITARY SERVICE. CONTRACTOR TO FIELD
U53	VERIFY LOCATION, SIZE, CONDITION, AND INVERT PRIOR TO ANY CONSTRUCTION. COORDINATE WITH UTILITY PROVIDER.
033	CONTRACTOR SHALL HAVE EXISTING LINE JETTED AND A CAMERA
	RUN THROUGH IT TO VERIFY PRIOR TO ANY CONSTRUCTION.
	ELECTRIC TRANSFORMER PAD LOCATION. COORDINATE WITH
	LOCAL PROVIDER. LOCAL PROVIDER CAN SUPERSEDE THE
1154	PROPOSED TRANSFORMER PAD LOCATION. PROVIDE TWO 6"
U54	CONDUITS BETWEEN POINT OF CONNECTION AND TRANSFORMER
	24" MINIMUM BURY DEPTH WITH 18" OF VERTICAL SEPARATION AT
	WATER AND SEWER CROSSINGS.
U60	6" PVC SANITARY SEWER SERVICE (TYP.)
U61	6" GATE VALVE (TYP.)
	8" RPDA FIRE BFP IN ABOVE GRADE AND INSULATED ENCLOSURE
U63	(WILKINS 975ADAR OR AS APPROVED BY CITY OF RALEIGH); REFER
	TO DETAIL W-37
U64	8" GATE VALVE (TYP.)

UTILITY NOTES

- 1. CONTRACTOR SHALL HAVE NORTH CAROLINA ONE CALL (811) LOCATE ALL EXISTING UTILITIES PRIOR TO BEGINNING CONSTRUCTION.
- ALL UNDERGROUND FEATURES INDICATED ON THE PLANS SHOULD BE CONSIDERED APPROXIMATE IN LOCATION AND SHOULD BE VERIFIED IN THE FIELD PRIOR TO CONSTRUCTION. NOTIFY THE DESIGN ENGINEER IMMEDIATELY IF ANY CONFLICTS OR DISCREPANCIES ARE NOTED.
- CONTRACTOR SHALL COORDINATE THE LOCATION OR RELOCATION OF ALL OVERHEAD AND UNDERGROUND COMMUNICATION LINES, ELECTRIC AND GAS SERVICE WITH THE APPROPRIATE UTILITY COMPANY AND/OR THE CITY PRIOR TO BEGINNING CONSTRUCTION. CONTRACTOR SHALL PROVIDE CONDUITS AS REQUIRED FOR THESE UTILITIES UNDER PAVED AREAS.
- . ALL ILLUSTRATED UTILITY INFRASTRUCTURE IS DIAGRAMMATIC AND MAY NOT REPRESENT THE ACTUAL SIZE OF INFRASTRUCTURE. NOTIFY THE DESIGN ENGINEER IMMEDIATELY IF ANY CONFLICTS OR DISCREPANCIES ARE NOTED.
- ALL MATERIALS AND METHODS OF CONSTRUCTION SHALL BE IN ACCORDANCE WITH THE CITY OF RALEIGH AND THE STATE OF NORTH CAROLINA STANDARDS AND SPECIFICATIONS.
- . CURB STOPS ARE REQUIRED AND SHALL BE LOCATED 1 FOOT FROM THE METER BOX. CURB STOPS SHALL BE INSTALLED IN A CURB STOP BOX AS MANUFACTURED BY FORD, A.Y. McDONALD, OR TRUMBULL.
- SERVICE SADDLES SHALL BE ALL BRONZE WITH DOUBLE BRONZE STRAPS WITH A NEOPRENE "O" RING GASKET ATTACHED TO THE BODY.
- B. ALL WATER METERS SHALL BE PROVIDED AND INSTALLED BY THE CITY OF RALEIGH PUBLIC UTILITIES DEPARTMENT METERS DIVISION.
- 9. METERS WILL BE THE SAME SIZE IN DIAMETER AS THE SERVICE. 10. A 3' CLEAR SPACE SHALL BE MAINTAINED AROUND ALL WATER METERS.
- 11. ALL 6" SANITARY SEWER SERVICES CONNECTIONS SHALL BE MADE INTO MANHOLES ONLY.
- 12. UTILITY TRENCHES SHALL BE CUT AND PAVEMENT REPAIRED TO CITY OF

KNIGHTDALE AND NCDOT STANDARDS AND SPECIFICATIONS.

- RALEIGH STANDARDS. 13. ALL DISTURBED HARDSCAPE AND LANDSCAPING (CONCRETE, ASPHALT, BRICK, TREES, SHRUBS, ETC) SHALL BE REPLACED ACCORDING TO TOWN OF
- 14. BOUNDARY AND SURVEY INFORMATION IS TAKEN FROM A SURVEY BY MCKIM
- & CREED (07/25/2023).
- 15. ALL OVERHEAD UTILITY LINES SHALL BE ADJUSTED TO MAINTAIN ACCEPTABLE CLEARANCES FOR FIRE APPARATUS, CONSTRUCTION EQUIPMENT, AND VEHICULAR ACCESS.

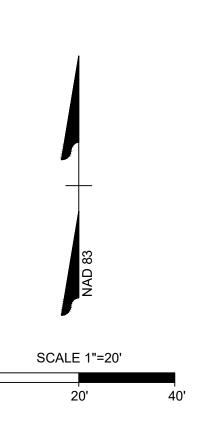

07/07/2025


DESIGNED BY


CHECKED BY M. DAVIDSON

AS SHOWN


JOB NO.

70434 SHEET NO. C5.0

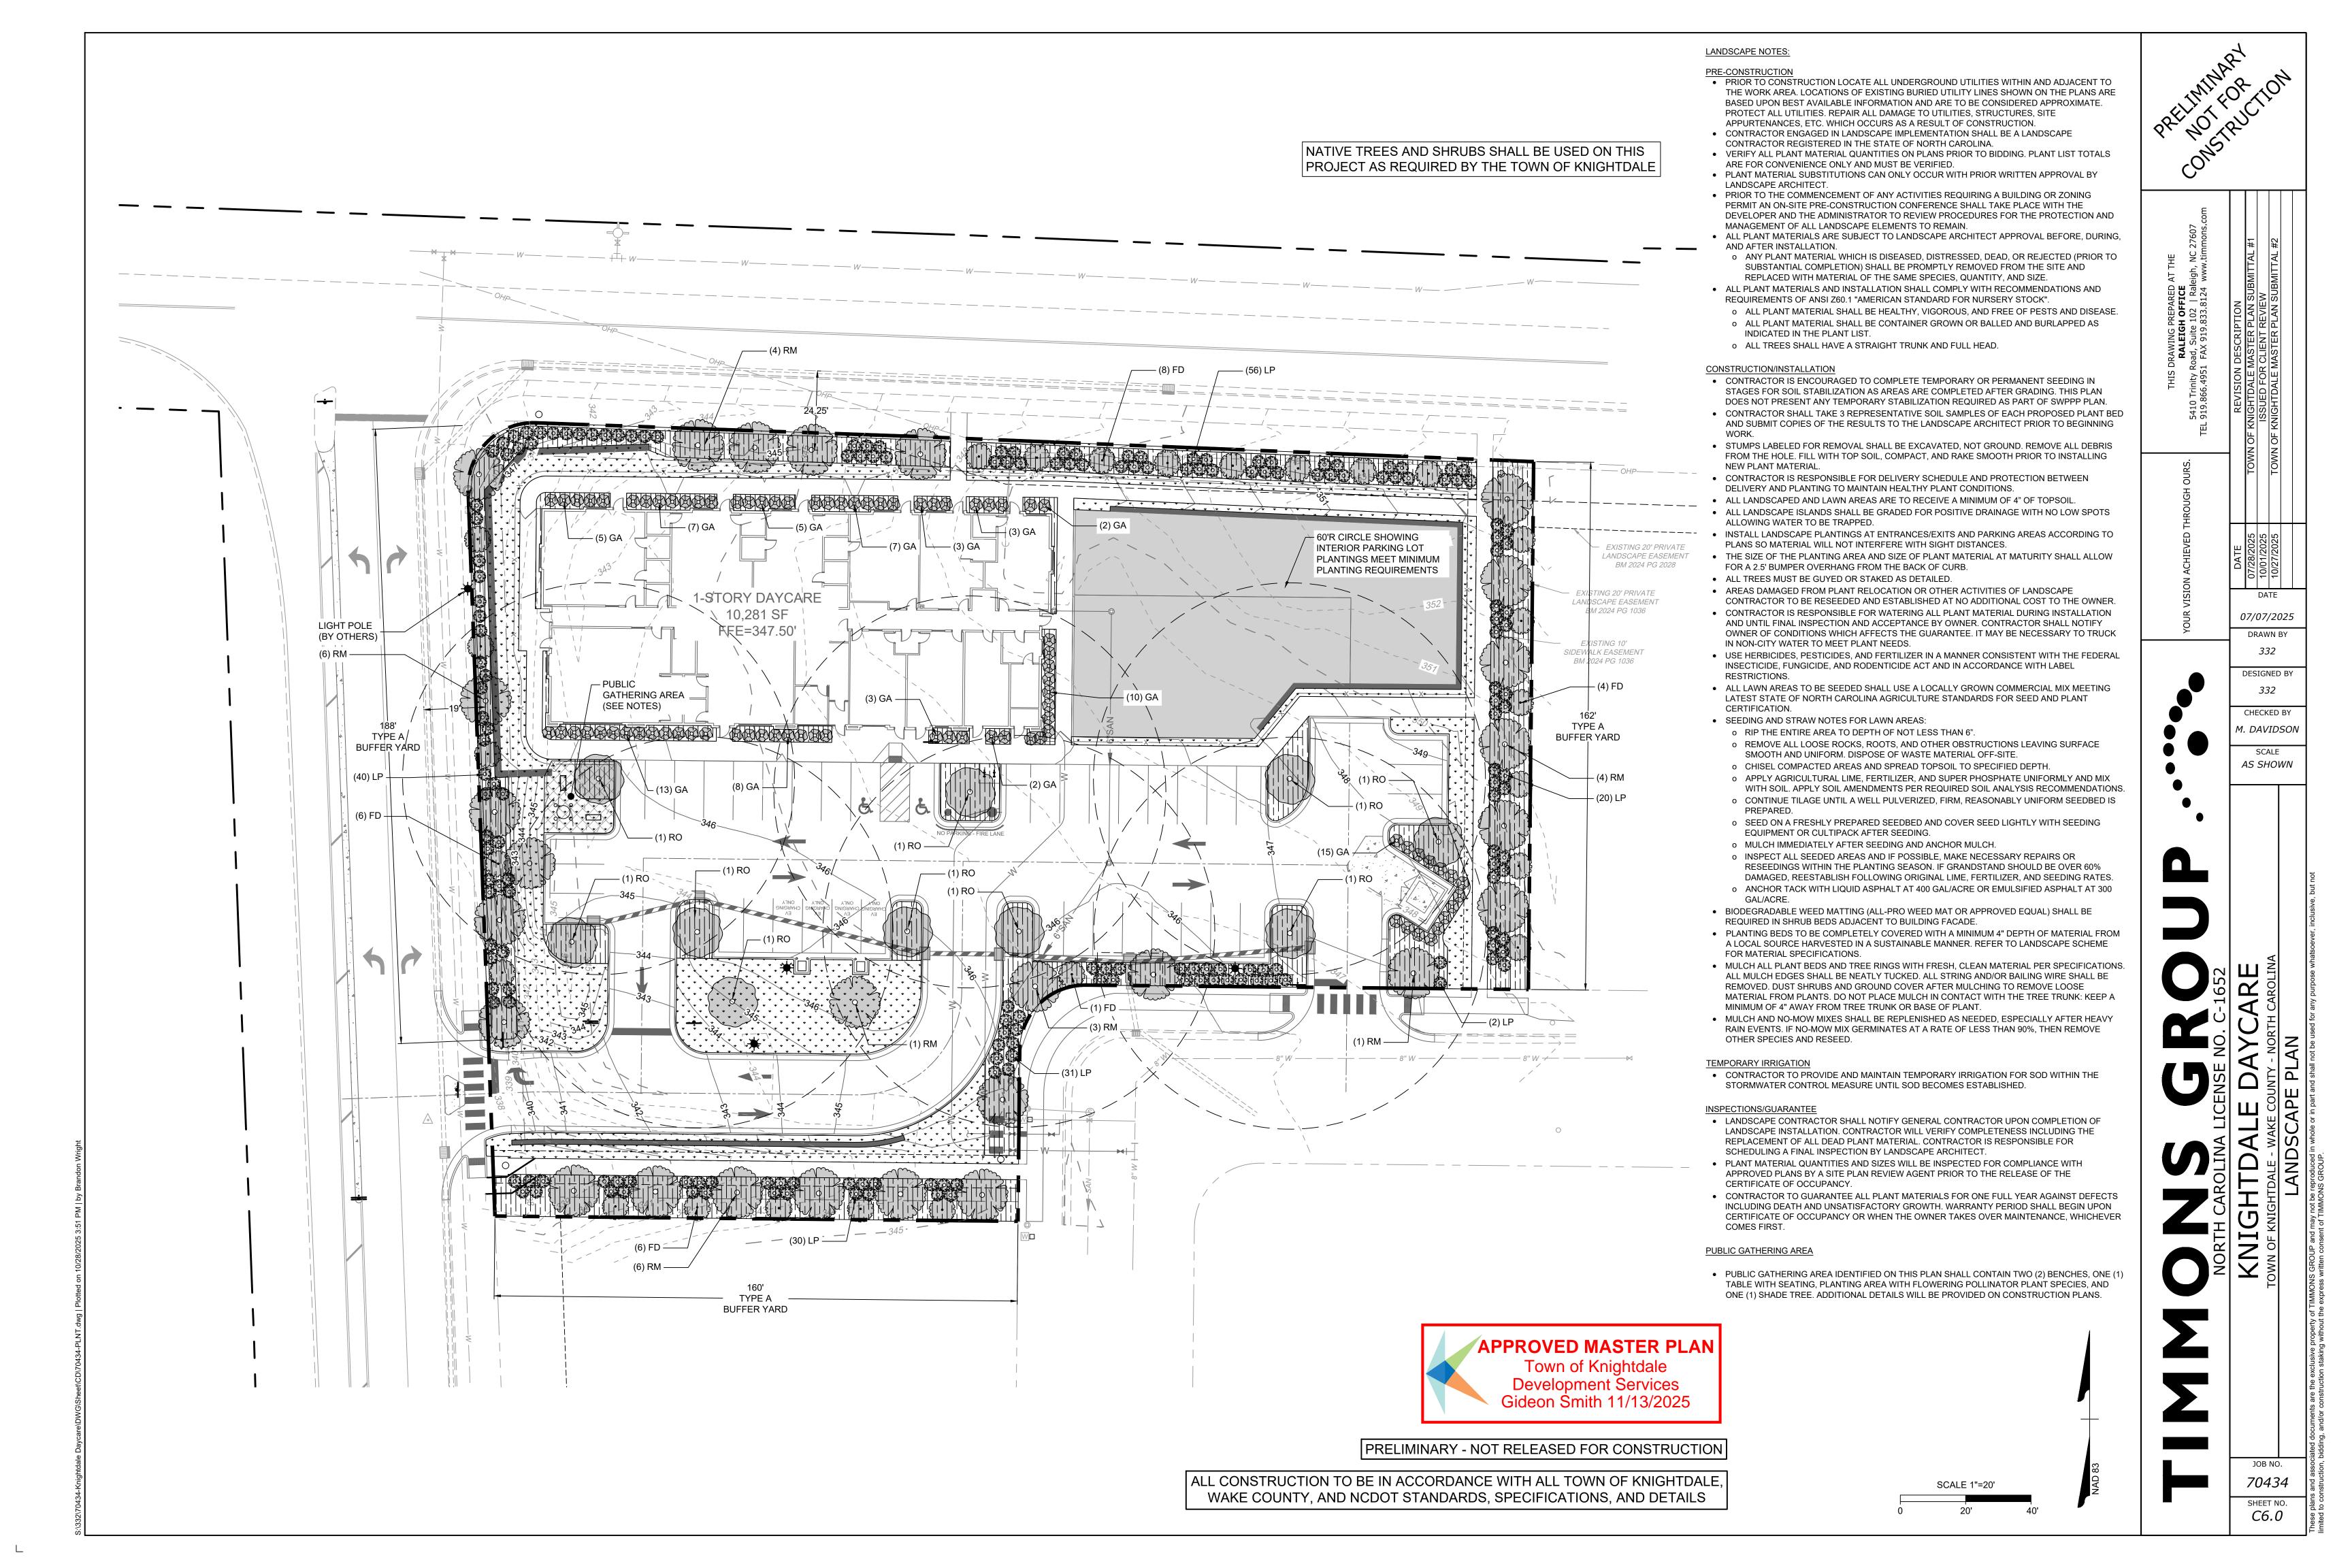


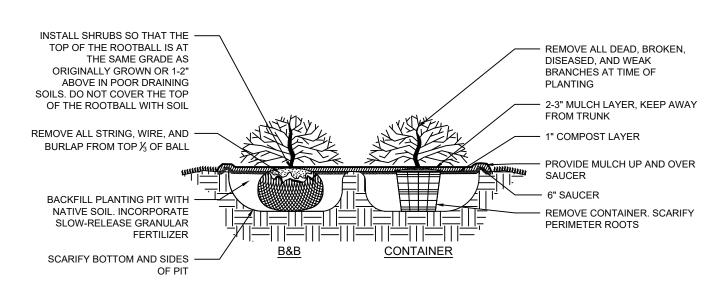



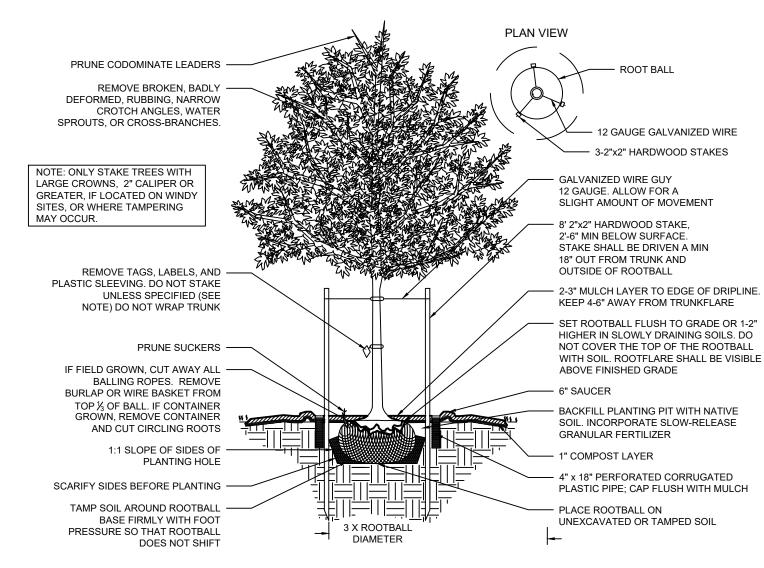


DECIDUOUS TREE - STAKING SPECIFIED

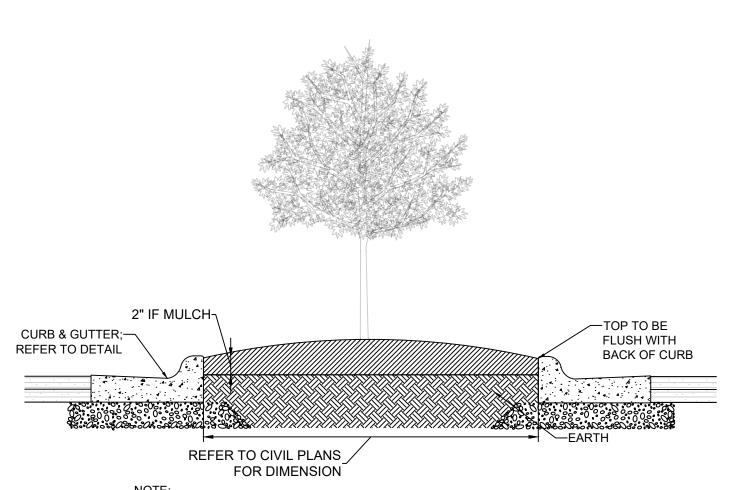

REFER TO LANDSCAPE PLAN FOR GROUNDCOVER AND PLANT MATERIAL INFORMATION.
 REFER TO TREE AND SHRUB DETAILS FOR ADDITIONAL SPECIFICATIONS.

LANDSCAPE ISLAND DETAIL

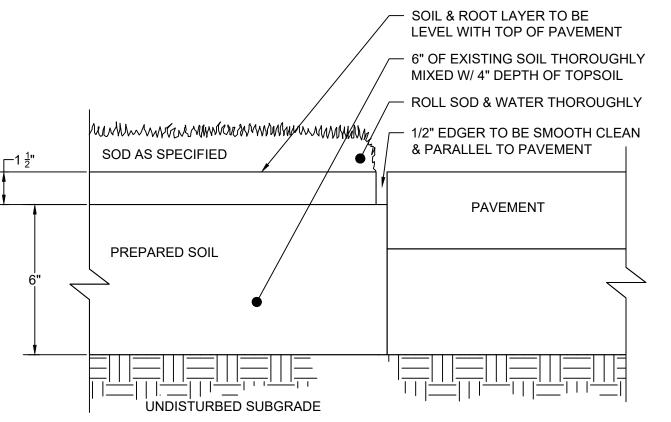

TOWN OF KNIGHTDALE LANDSCAPE REQUIREMENTS


REQUIREMENT	CALCULATION	PROVIDED	SIZE (AT TIME OF PLANTING)
INTERIOR PARKING LOT LANDSCAF	PING:		
UDO 7.4.J.: NO PARKING SPACE MORE THAN 60 LF FROM BASE OF CANOPY TREE	REFER TO PLAN - 60 FT RADIUS CIRCLES CENTERED ON TREES	10 CANOPY TREES	2" CALIPER AND 8 FT. MIN. HEIGHT CANOPY TREES
PARKING LOT SCREENING:			
U.D.O. 7.5.B PARKING LOTS: TYPE A BUFFER YARD SCREENING PARKING LOT FROM ROW. TYPE A BUFFER YARD REQUIREMENTS: 3 CANOPY TREES, 2 UNDERSTORY TREES & 20 SHRUBS PER 100 LF	667 LF OF TYPE A BUFFER YARD (667 / 100) X 3 CANOPY TREES = 20 TREES (667 / 100) X 2 UNDERSTORY TREES = 13.3 TREES (667 / 100) X 20 SHRUBS =133.4 SHRUBS	22 CANOPY TREES 17 UNDERSTORY TREES 134 SHRUBS	2" CALIPER AND 8 FT. MIN. HEIGHT CANOPY TREES 1.25" CALIPER AND 6 FT MIN. HEIGHT UNDERSTORY TREES 3 GALLON CONTAINER SIZE, 18" MIN, HEIGHT AND 12-15" MIN. SPREAD SHRUBS
STREET TREES:			
U.D.O. SEC. 7.4.L 1 CANOPY TREE PER 40 LF *UNDERSTORY TREES SUBSTITUTE CANOPY TREES WHERE OVERHEAD UTILITIES CONFLICT	OLD KNIGHT ROAD: 223 LF OF PROPERTY FRONTAGE (223 LF / 40 LF) = 5.6 TREES	6 CANOPY TREES	2" CALIPER AND 8 FT. MIN. HEIGHT CANOPY TREES
	HORTON ROAD: 306 LF OF PROPERTY FRONTAGE (306 LF / 40 LF) = 7.7 TREES	4 CANOPY TREES 8 UNDERSTORY TREES	2" CALIPER AND 8 FT. MIN. HEIGHT CANOPY TREES 1.25" CALIPER AND 6 FT MIN. HEIGHT UNDERSTORY TREES

PLANT SCHEDULE

SYMBOL TREE CANOPY		QTY.				
		PROV'D	BOTANICAL NAME	COMMON NAME	MIN. INSTALLATION SIZE	TREE LOCATIONS
0	RO	10	QUERCUS LYRATA (NATIVE)	OVERCUP OAK	MIN. CALIPER SIZE OF 2", MIN HEIGHT OF 8'	PARKING LOT
	RM	27	QUERCUS SHUMARDII (NATIVE)	SHUMARD OAK	MIN. CALIPER SIZE OF 2", MIN HEIGHT OF 8'	BUFFERS
	UNDERSTORY					
Ex 3	FD 25		CORNUS FLORIDA (NATIVE)	FLOWERING DOGWOOD	MIN. CALIPER SIZE OF 1.25", MIN HEIGHT OF 6'	BUFFERS
	SHRUBS					
0	LP	192 LOROPETALUM CHINENSE (NATIVE)		LOROPETALUM	MIN. 3 GALLON CONTAINER SIZE, MIN. HEIGHT OF 18" AND MIN. SPREAD OF 12-15"	
8	GA 83 ABELIA X GRANDIFLORA (NATIVE) GLOSSY AE		GLOSSY ABELIA	MIN. 3 GALLON CONTAINER SIZE, MIN. HEIGHT OF 18" AND MIN. SPREAD OF 12-15"		

GROUND COVER

+ + + + + + + + + + + + + + + + + + + +	CYNODON DACTYLON	BERMUDA GRASS	SOD
		RED BARK MULCH	

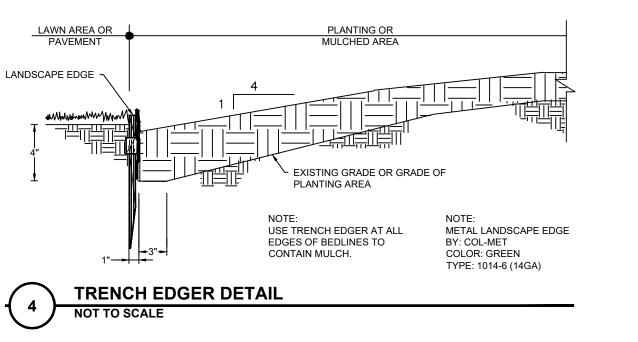

PRELIMINARY - NOT RELEASED FOR CONSTRUCTION

ALL CONSTRUCTION TO BE IN ACCORDANCE WITH ALL TOWN OF KNIGHTDALE, WAKE COUNTY, AND NCDOT STANDARDS, SPECIFICATIONS, AND DETAILS



DATE ----


DRAWN BY DESIGNED BY


CHECKED BY 1. DAVIDSON


AS SHOWN

JOB NO. 70434 SHEET NO.

C6.1

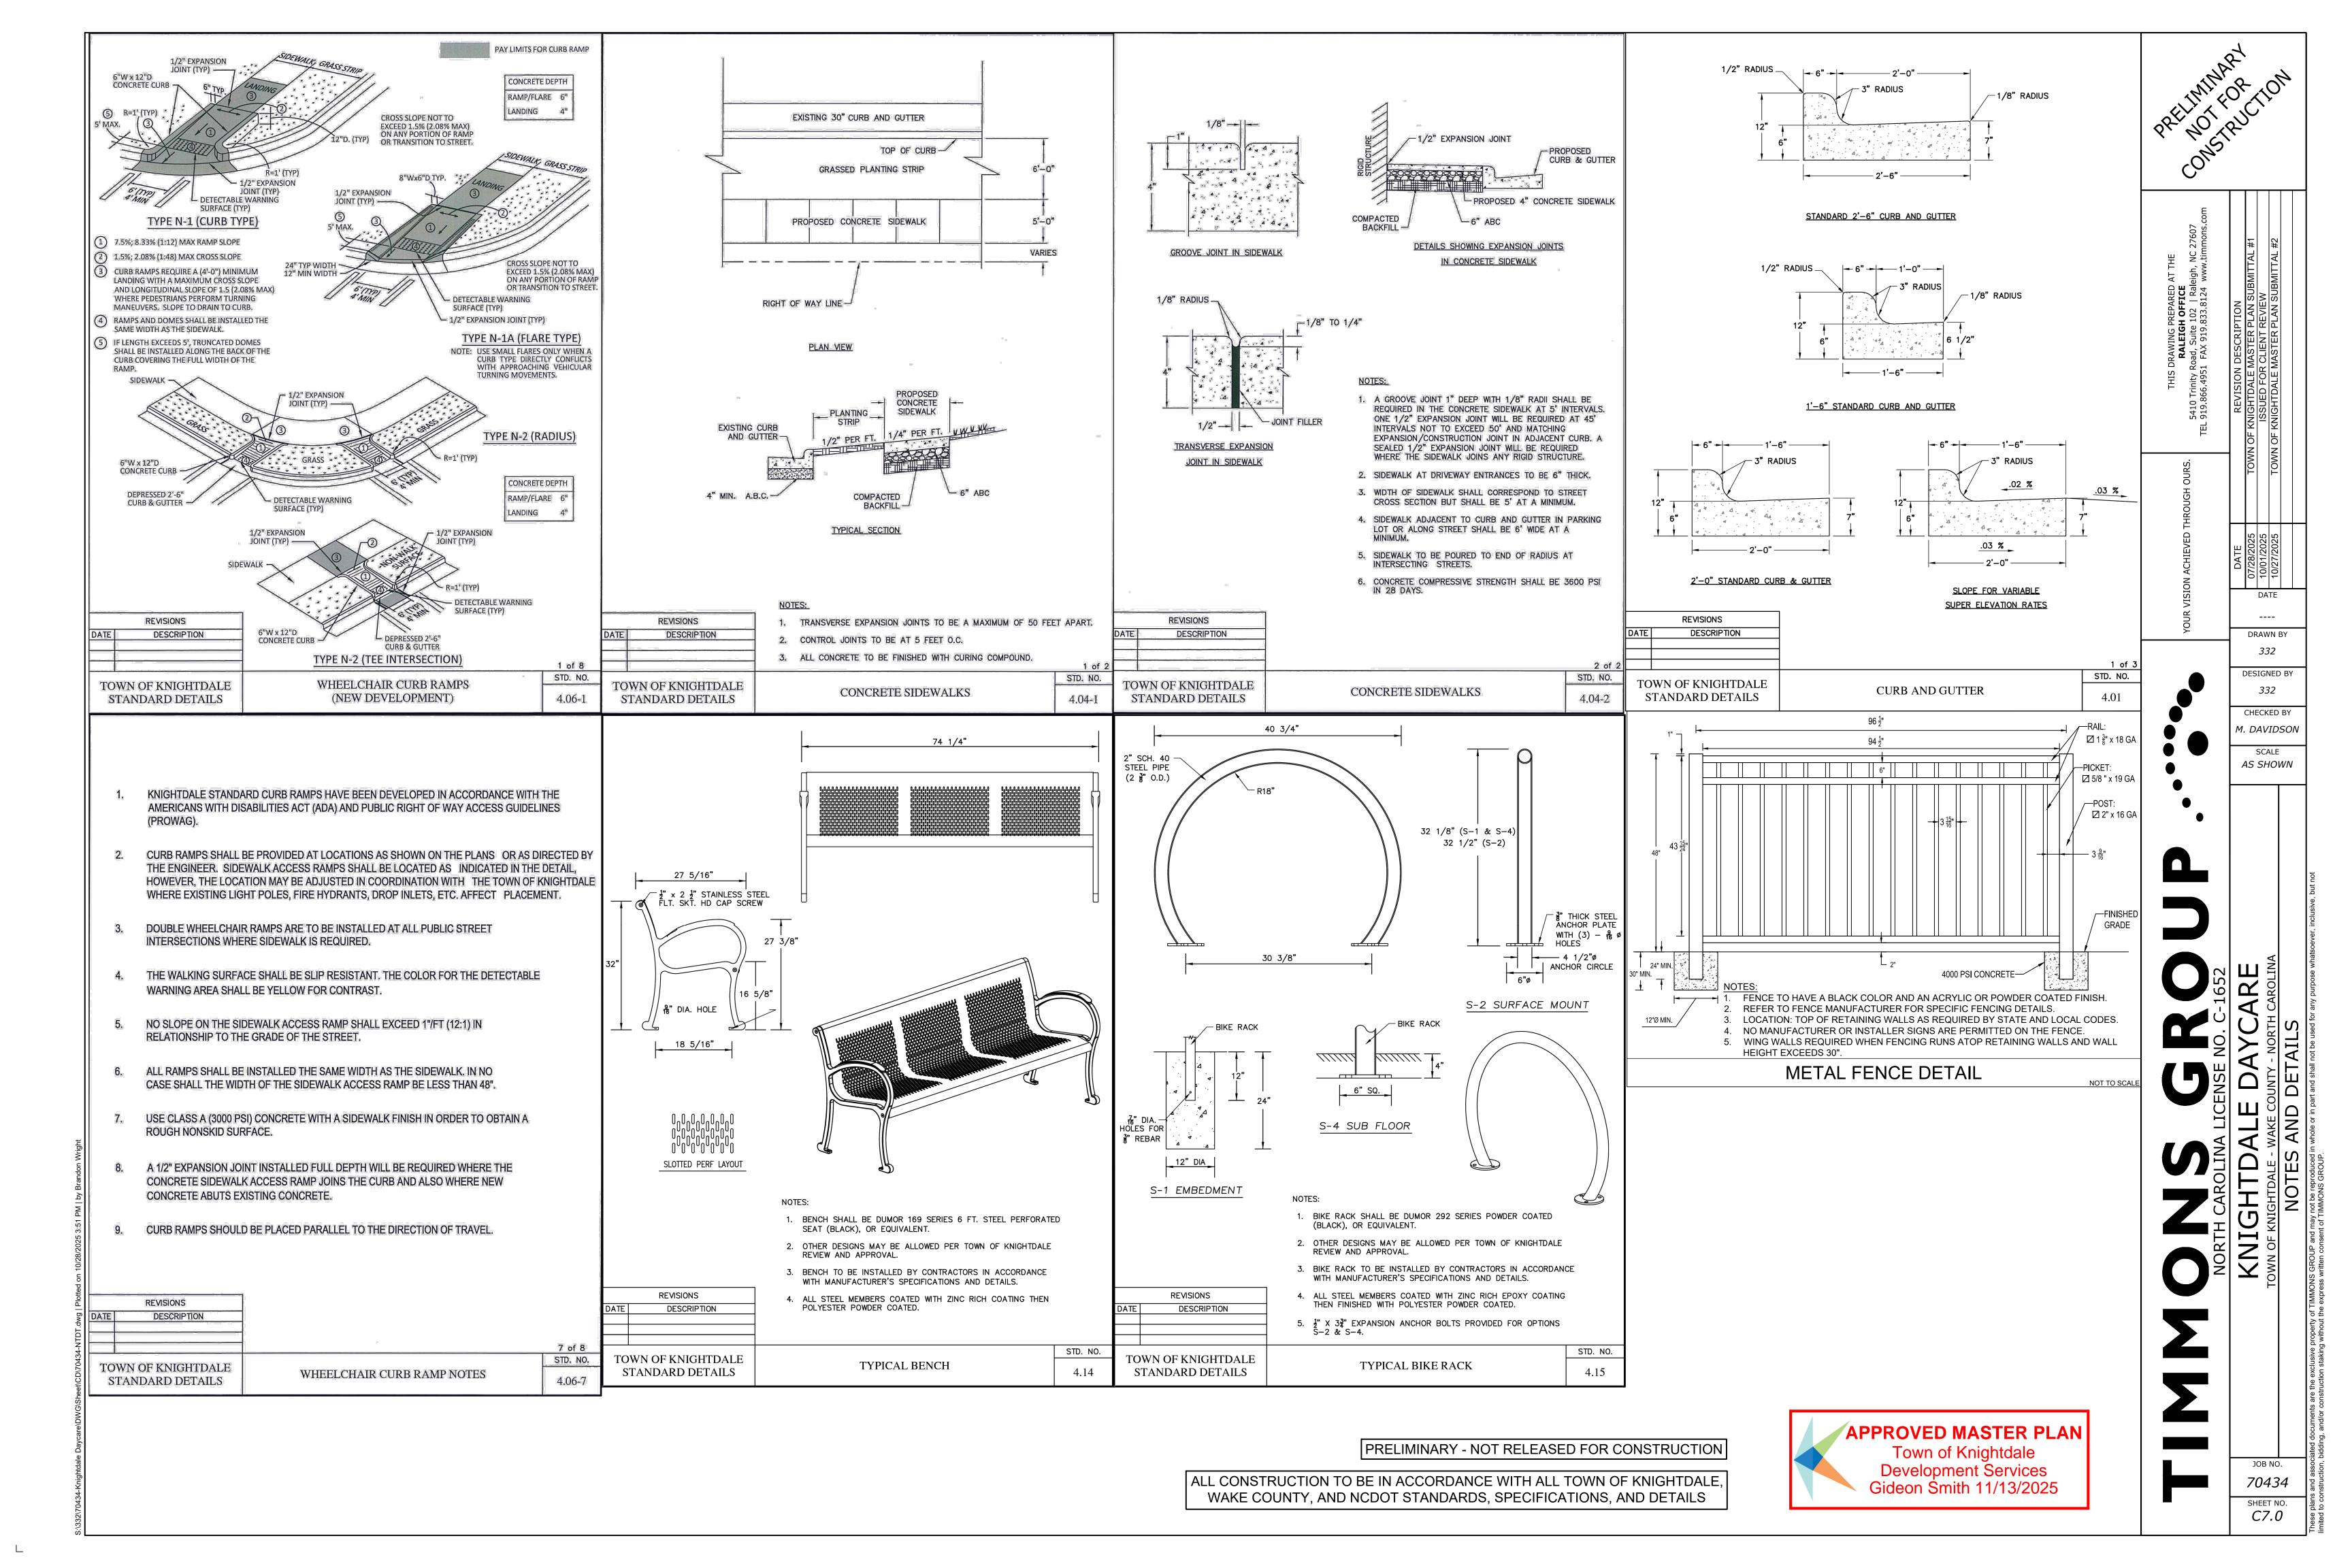

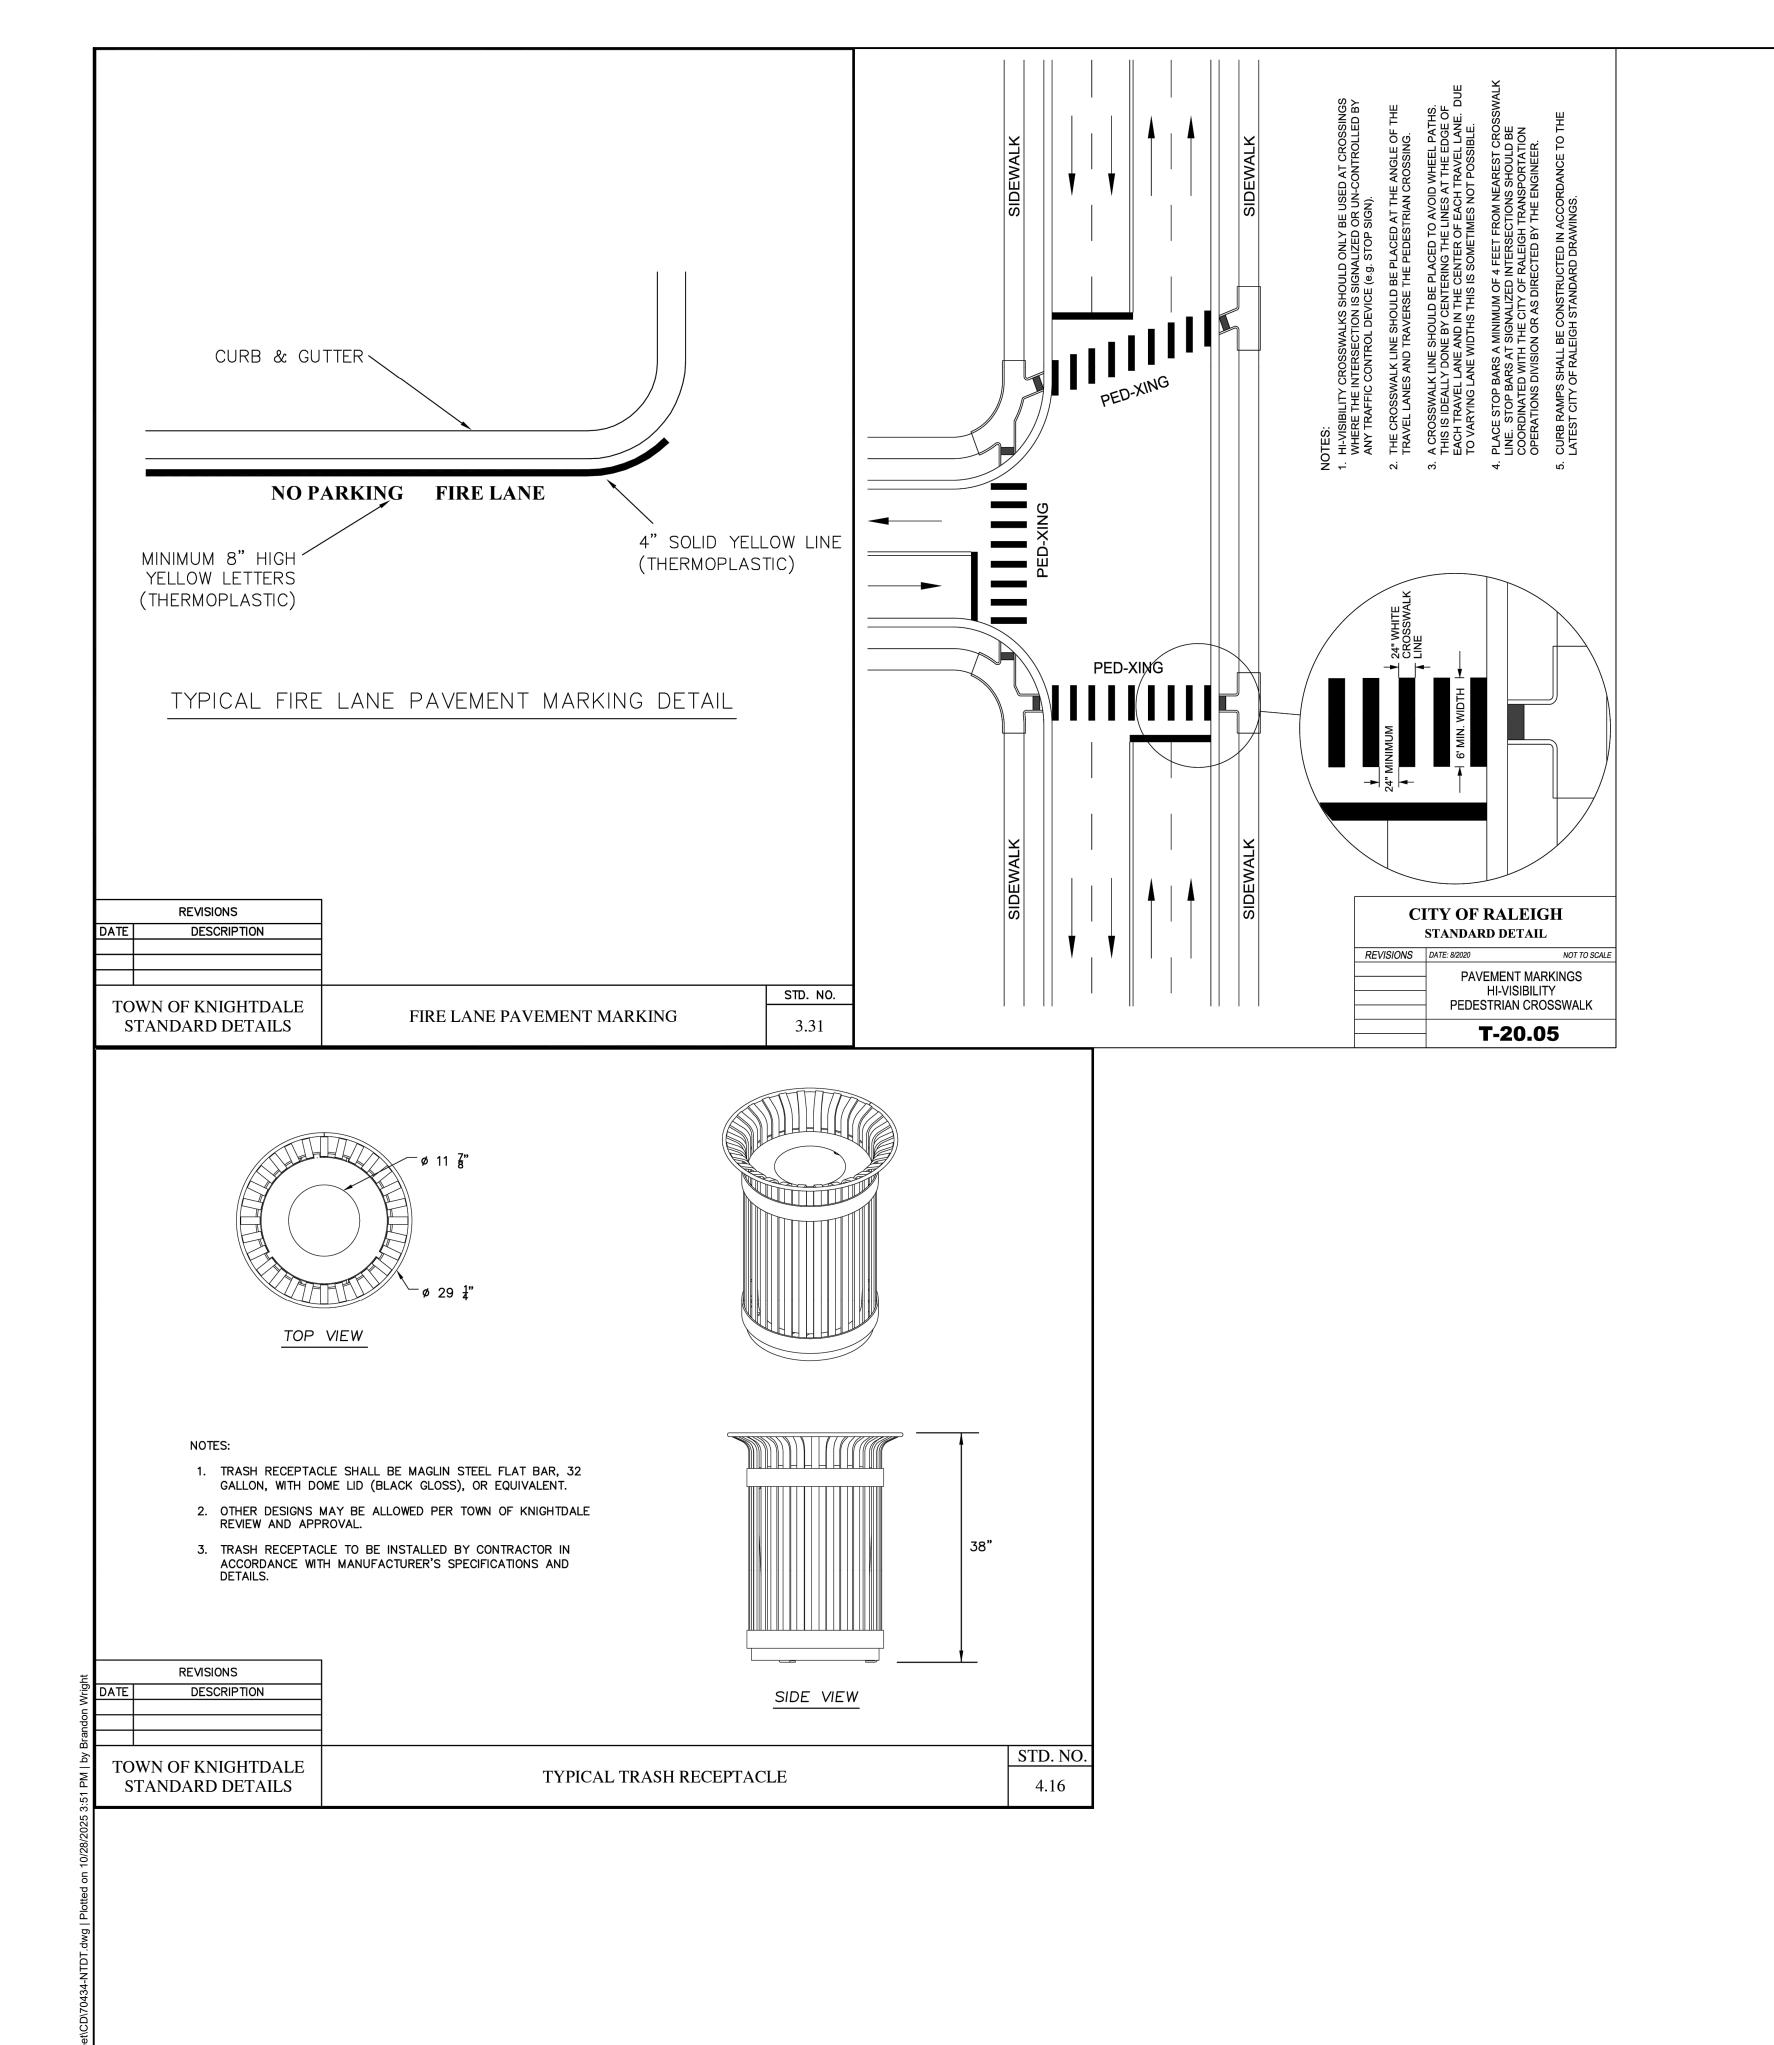

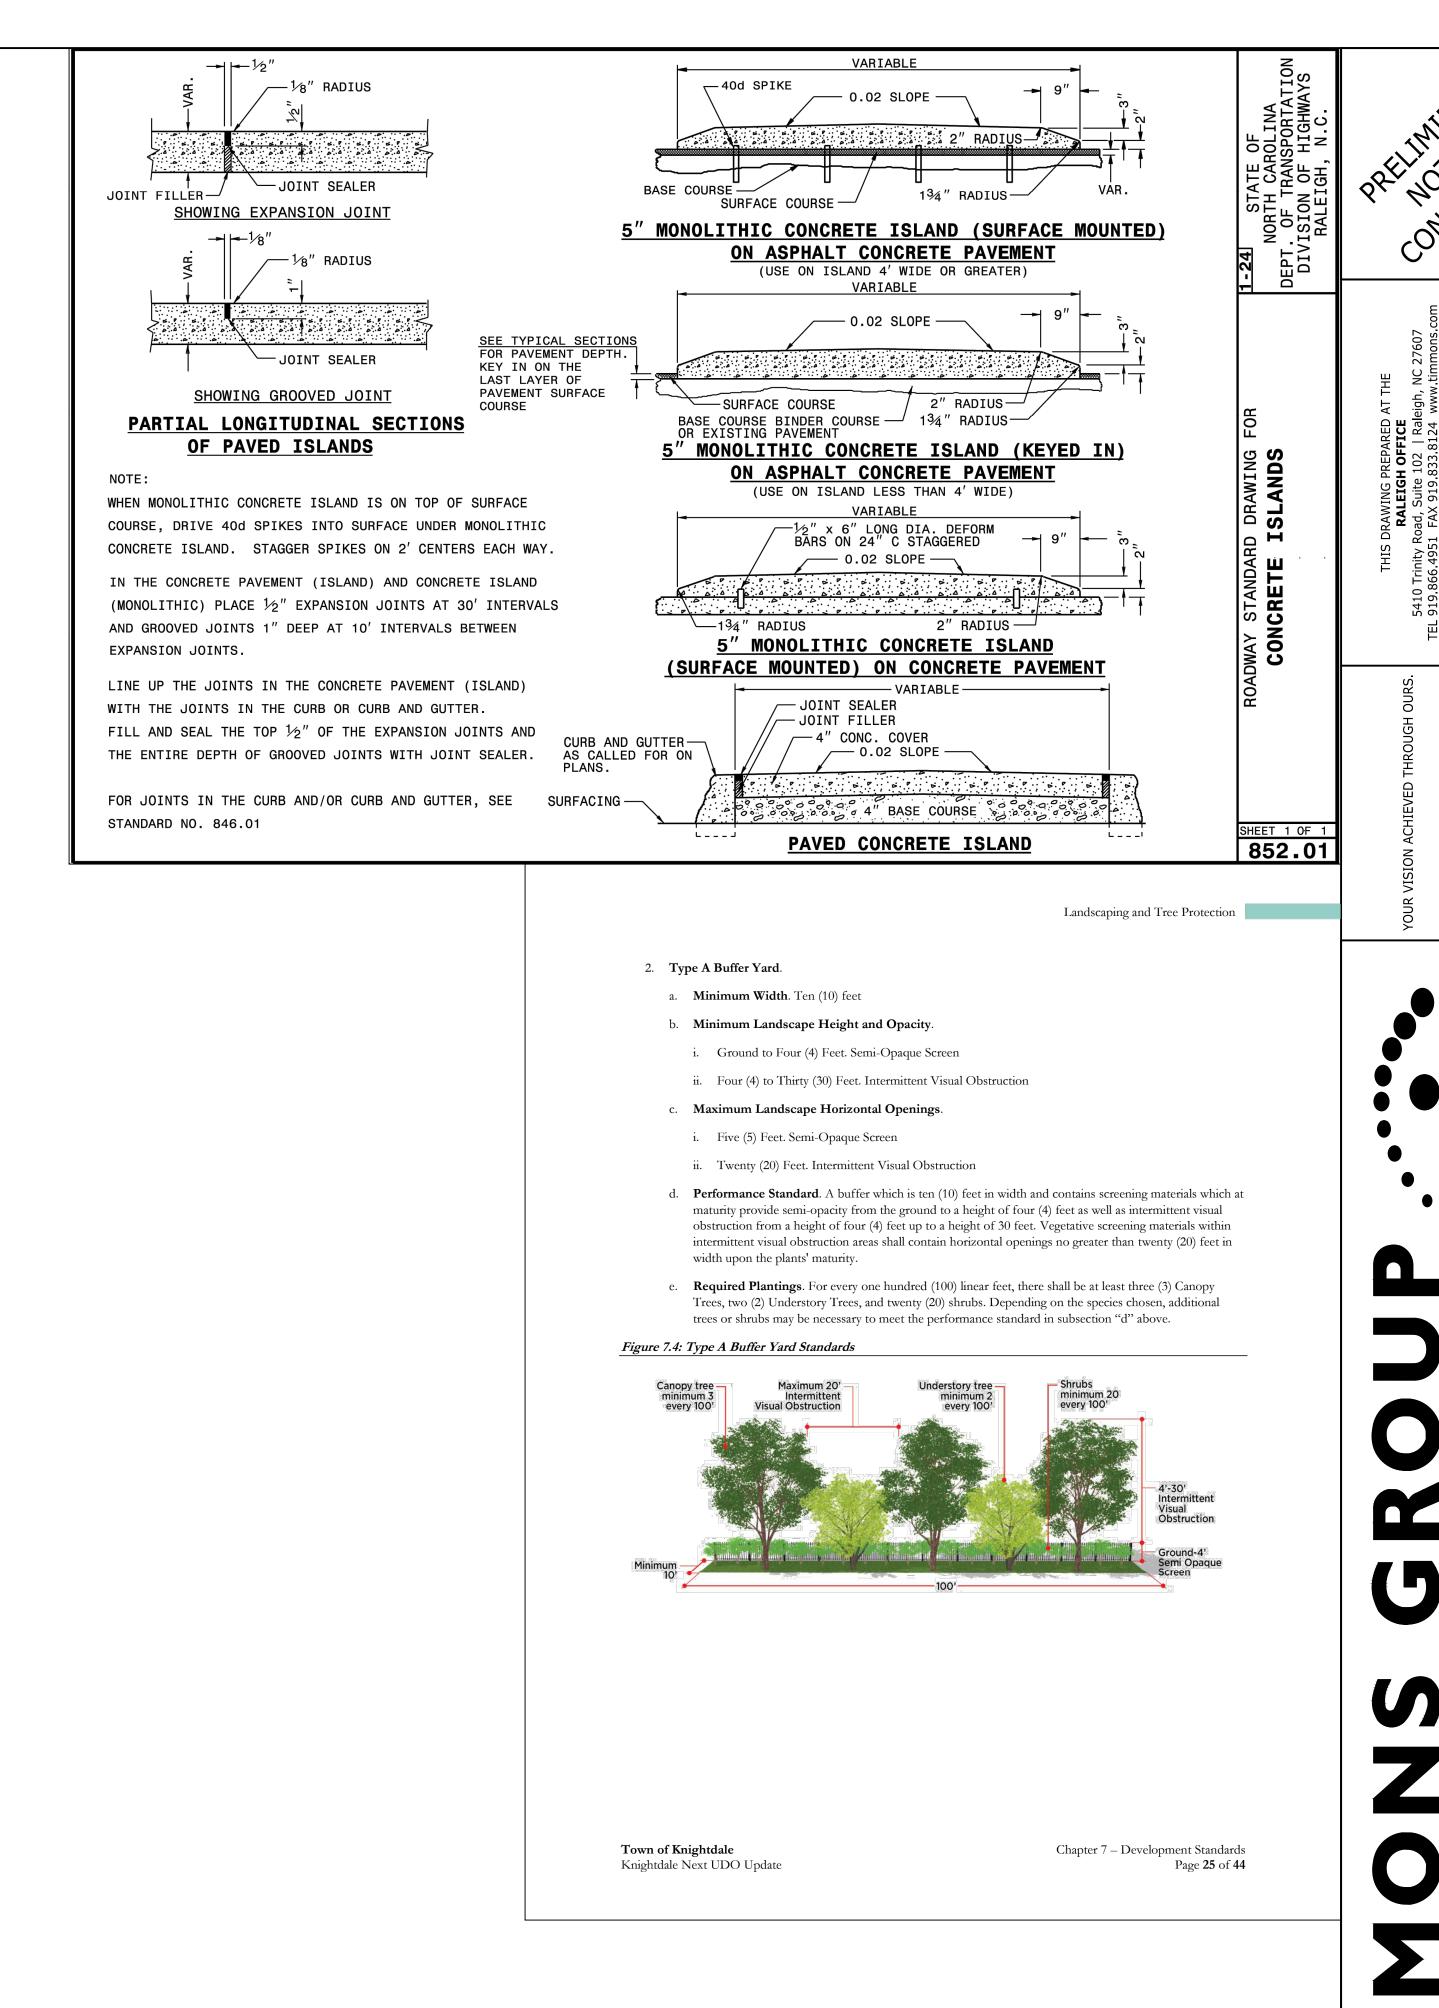

PRELIMINARY - NOT RELEASED FOR CONSTRUCTION

ALL CONSTRUCTION TO BE IN ACCORDANCE WITH ALL TOWN OF KNIGHTDALE, WAKE COUNTY, AND NCDOT STANDARDS, SPECIFICATIONS, AND DETAILS



JOB NO.
70434

SHEET NO.
C7.1

SHEET NO.

C7.1

DRAWN BY


DESIGNED BY


332

CHECKED BY

1. DAVIDSON

AS SHOWN

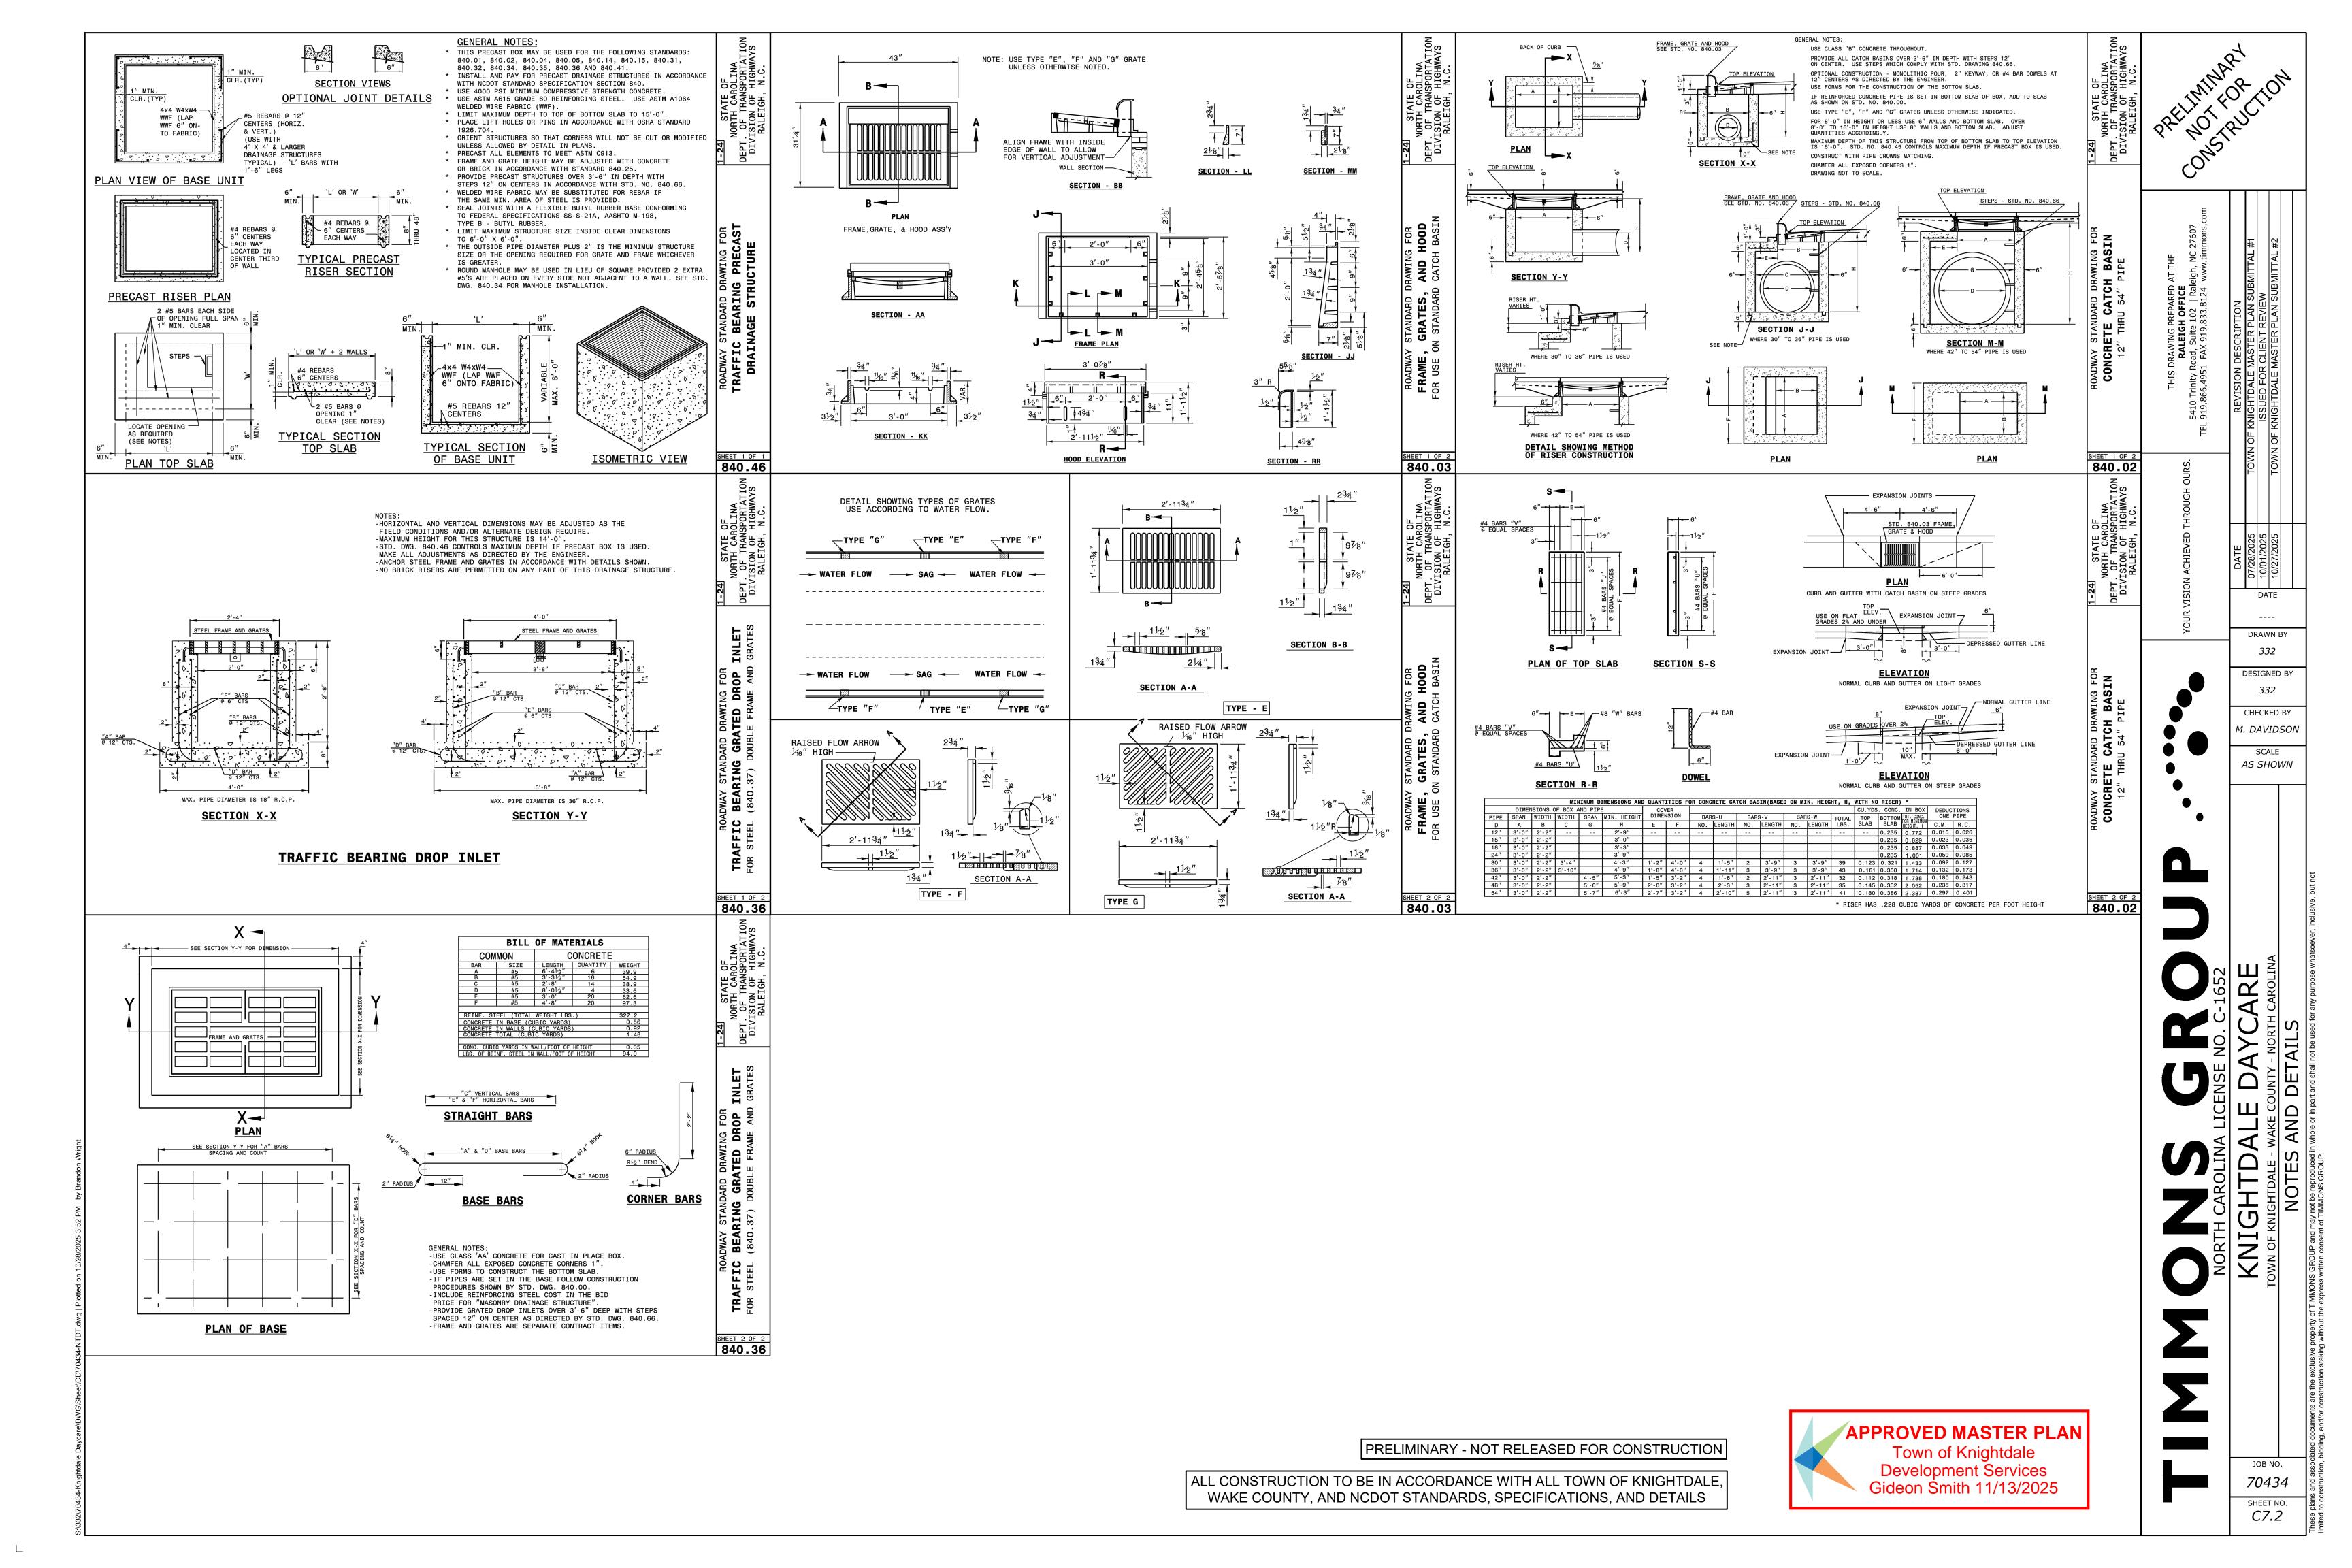

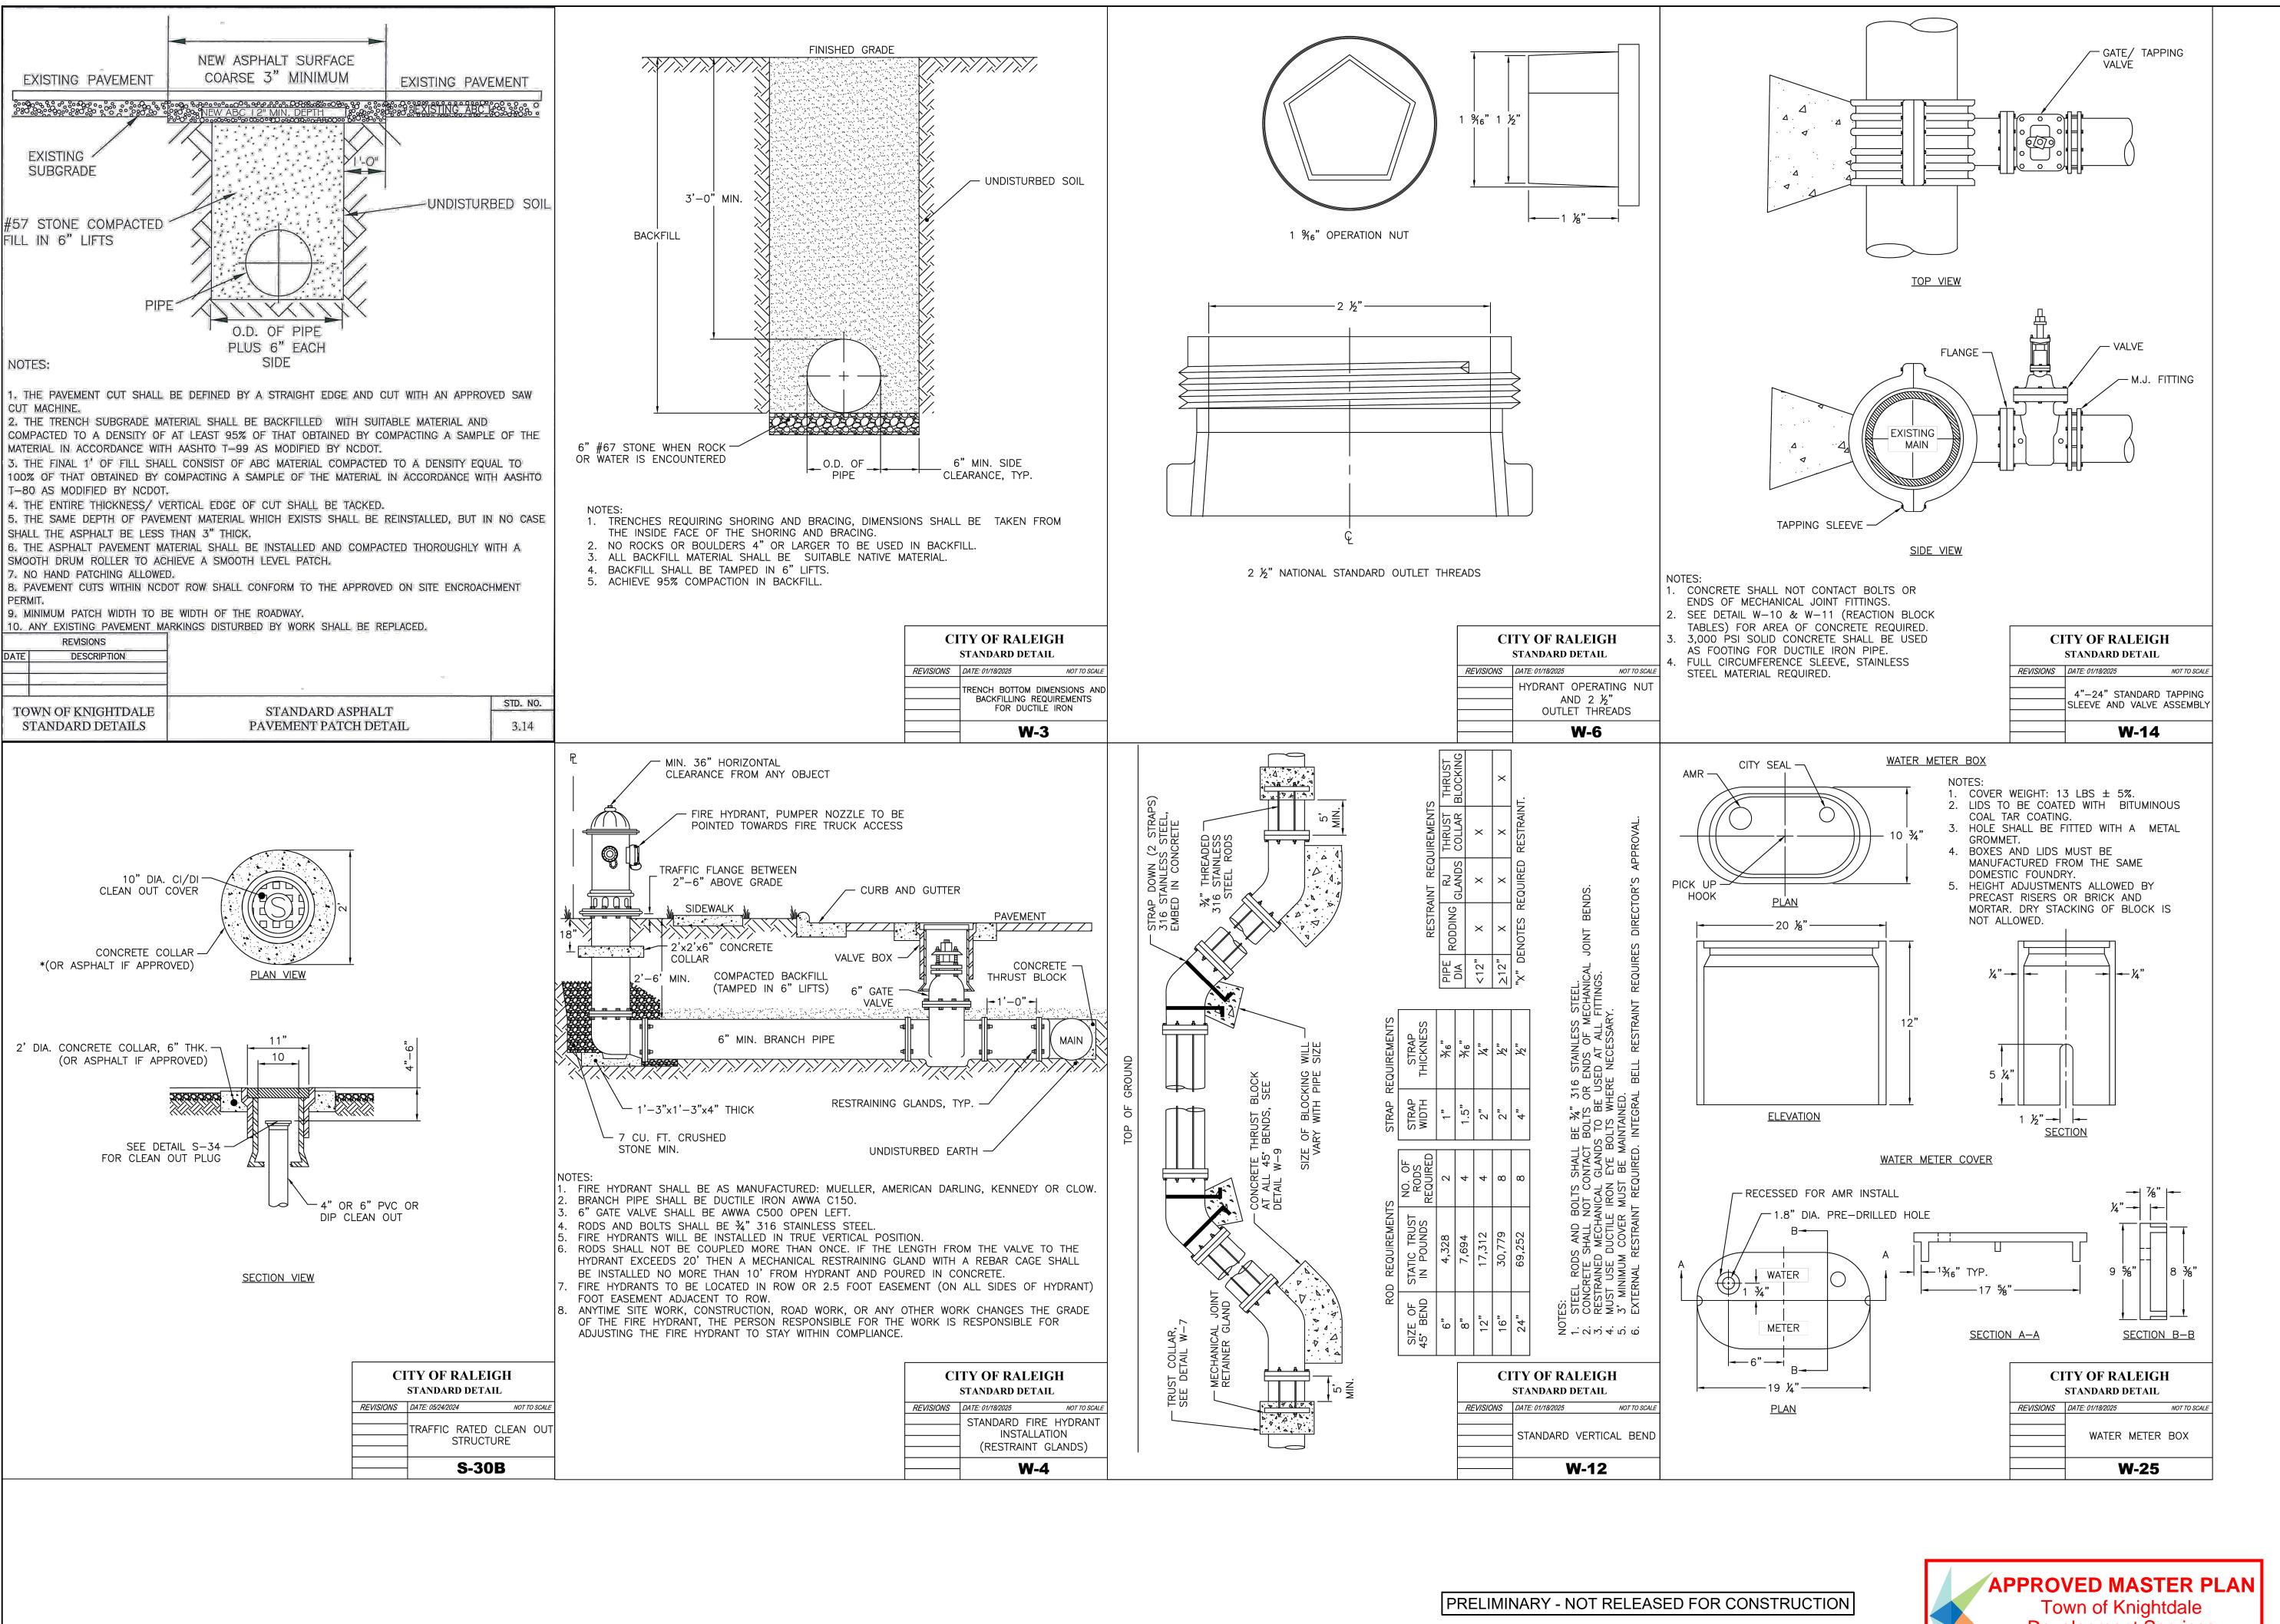


ALL CONSTRUCTION TO BE IN ACCORDANCE WITH ALL TOWN OF KNIGHTDALE. WAKE COUNTY, AND NCDOT STANDARDS, SPECIFICATIONS, AND DETAILS

Development Services Gideon Smith 11/13/2025

DATE ----DRAWN BY **DESIGNED BY** CHECKED BY 1. DAVIDSON AS SHOWN

JOB NO.

70434 SHEET NO. *C7.3*

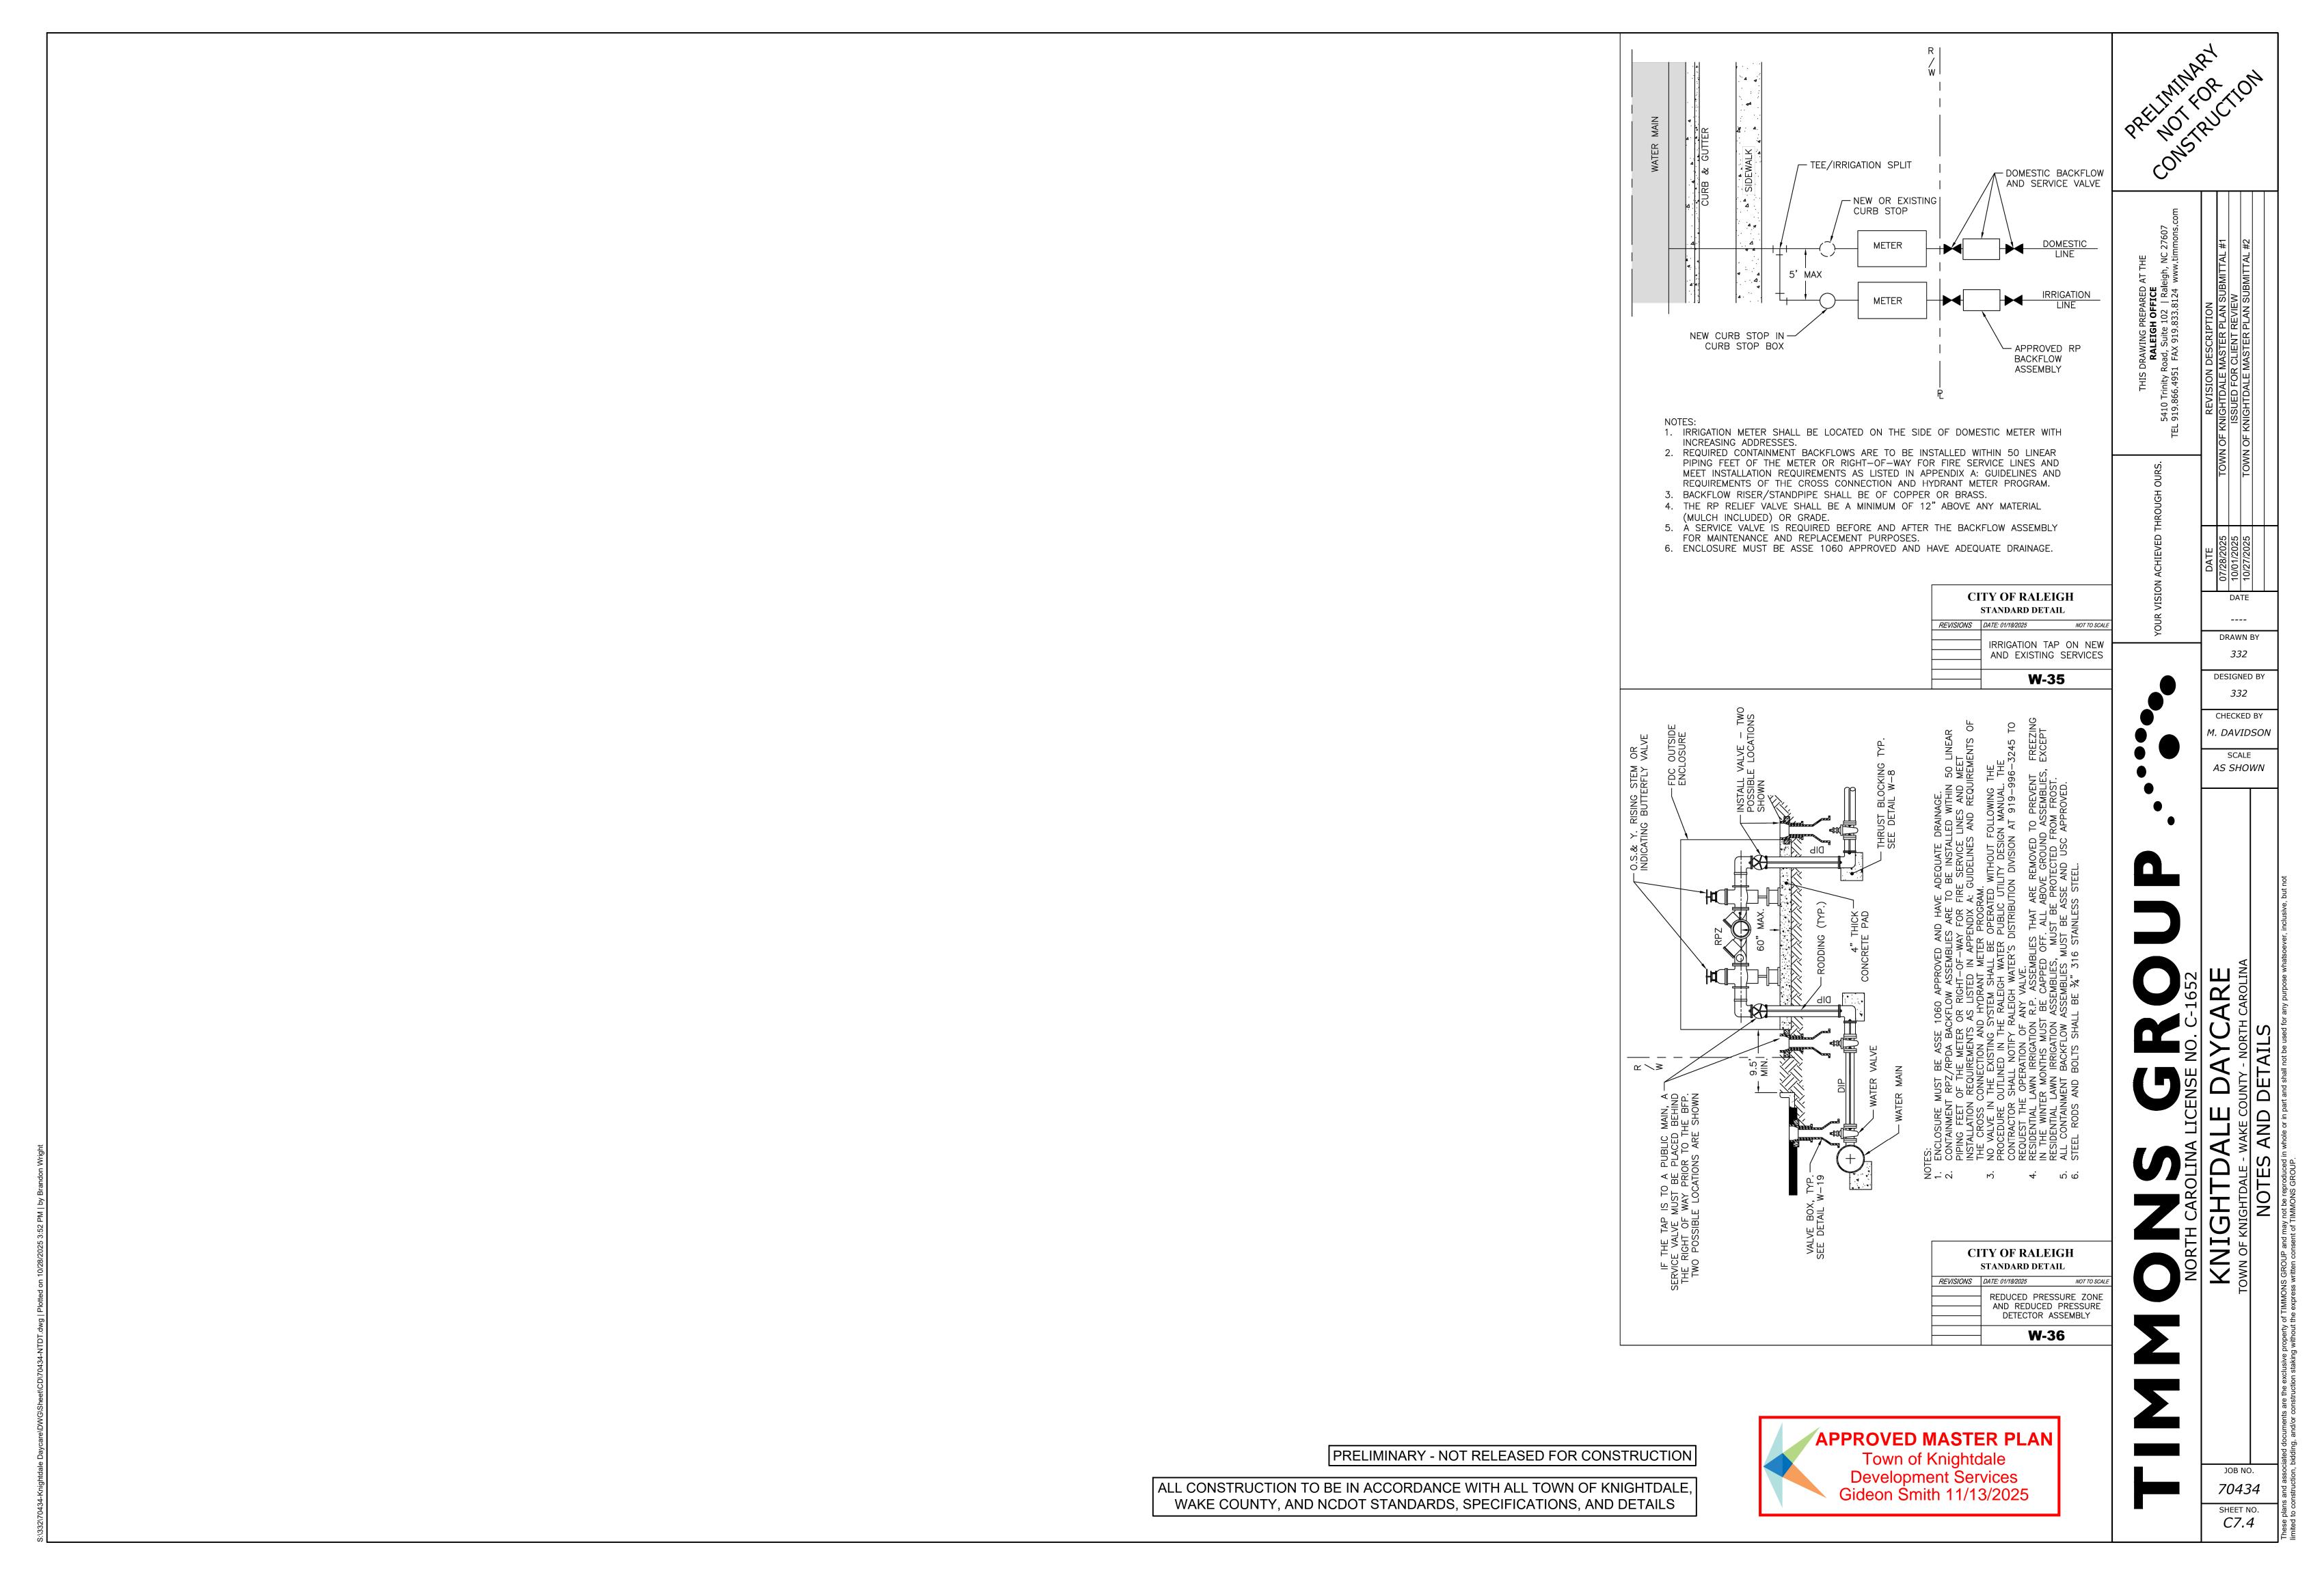

ı

1.6 1.9 1.9 1.8 2.4 2.9 2.0 1.8 1.9 1.9 1.2 0.6 0.3 0.1 +0.0 +0.0 +0.0 +0.0 +0.0 +0.0

BY

NO. DATE

REVISION



LUMENS - 18459
PATTERN TYPE IV 33-U0-G4 Czero Ught at or above 90 degrees)
NUTE: THE FUNTCANDLE READINGS BELOW ARE MAINTAINED AND HAVE
BEEN BEPRECIATED FOR LED LUMEN EMPRECIATION AND
LUMENAIRE BIRT DEPRECIATION, FOR JUSTIAL FOOTCANDLES,
DIVIDE THE READINGS BELOW 97, 68.

Schedule									
Symbol	Label	Quantity	Description	Number Lamps	Lumens Per Lamp	Light Loss Factor			
×	В	3	LED 150W Shoebox - Type IV - 4000K	48	385	0.85			

Statistic	Statistics								
Description	nSymbol	Av	9	Max	<	Mir	۱	Max/Min	Avg/Min
Parking	Ж	1.4	fc	3,3	fq	0.3	fc	11.0:1	4.7:1

LEGEND COUTER to INNERN 0.10 , 0.25 , 0.50 , 1.00 , 1.25

APPROVED MASTER PLAN Town of Knightdale **Development Services** Gideon Smith 11/13/2025

LIGHTING DESIGN TOLERANCE The calculated footcandle light levels in this lighting design

are predicted values and are based on specific information that has been supplied to Duke Energy. Any inaccuracies in the supplied information, differences in luminaire installation, lighted area geometry including elevation differences, reflective properties of surrounding surfaces, obstructions (foliage or otherwise) in the lighted area, or lighting from sources other than listed in this design may produce different results from the predicted values. Normal tolerances of voltage, lamp output, and ballast and luminaire manufacture will also affect



PROPRIETARY & CONFIDENTIAL

This document together with the concepts and designs presented herein, presented as an instrument of service, is the sole property of Duke Energy, and is intended only for the specific purpose and prospective client as stated in the title block of this drawing. Any use, copying, reproduction or disclosure of the drawing, design or any information contained herein by the prospective customer or other entities, including without limitation, architects, engineers, or equipment manufacturers is hereby expressly prohibited and shall not be permitted absent prior written consent from, and payment of compensation to Duke Energy. Duke Energy disclaims any liability or responsibility for any

KNIGHTDALE DAYCARE KNIGHTDALE, NC SITE LIGHTING ARRANGEMENT Designed by DUKE ENERGY PROGRESS LIGHTING SOLUTIONS Reviewed by A. Herrera _ Scale __1" = 20' Date 6/24/2025 _ Size _ Drawing size "D" Description LED Shoebox

25-0280A

Drawing No.

Sht. 1 OF 1

GENERAL NOTES:

- SEE DWG. G001 FOR LIST OF DRAWINGS AND BUILDING CODE NOTES. SEE DWG. G002 FOR GENERAL CONDITIONS.
- SEE DWG. A101 FOR CONSTRUCTION FLOOR PLAN. SEE DWG. A103 FOR REFLECTED CEILING PLAN.
- SEE DWG. A105 FOR EQUIPMENT AND FIXTURES PLAN. SEE DWG. A801-A804 FOR ARCHITECTURAL SPECIFICATIONS.
- **CONSTRUCTION NOTES:**

- REFER TO FINISH SCHEDULE FOR SPECIFIC PRODUCT INFORMATION. FLOORING INSTALLATION PATTERN SHALL FOLLOW FINISH PLAN INTENT. REFER TO INTERIOR ELEVATIONS FOR MORE INFORMATION.
- REFER TO THE PLUMBING DWGS. FOR FLOOR DRAIN AND SINK LOCATIONS. PROVIDE A "LEVEL-4" GYP. BD. FINISH AT ALL WALL. REFER TO SHEET A402 FOR TOILET ROOM INTERIOR ELEVATIONS.


FLOORING INSTALLER TO COORDINATE TOP OF FLOOR FINISH TO BE

- ALL PAINT MUST BE SPRAYED AND BACKROLLED. THE LVT FLOORING PATTERN SHALL BE CONTINUOUS FROM THE CORRIDOR INTO THE CLASSROOMS. CONTRACTOR SHALL INSTALL THE FLOORING IN THE CORRIDORS FIRST TO AVOID CUTTING TILE AT THE
- CLASSROOM DOORS. THE TENANT MAY ELECT TO INSTALL GRAPHICS IN SOME WALLS. CONTRACTOR SHALL COORDINATE WITH TENANT'S REPRESENTATIVE
- PRIOR TO START WALL PAINTING. 11. FINISH PRODUCT SUBSTITUTIONS ARE NOT ALLOWED.

ROOM FINISHES:

- ALL ROOM WALLS SHALL RECEIVE P-1 PAINT UNLESS NOTED OTHERWISE. REFER TO PLAN AND INTERIOR ELEVATIONS.
- ALL ROOMS SHALL RECEIVE FLOOR FINISHES AS INDICATED ON THE PLAN AND RB-1 WALL BASE UNLESS NOTED OTHERWISE.
- ALL TOILET ROOMS SHALL RECEIVE WALL PAINT PER PLANS, FRP-3
- WAINSCOTING AND SV-1 FLOORING AND WALL BASE. REFER TO FINISH SCHEDULE FOR SPECIFICATIONS.



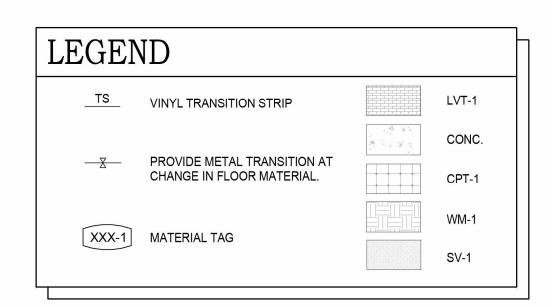

	PAINT SCHEDULE								
MARK	APPLICATION	LOCATIONS	MANUFACTURER	MODEL	FINISH	REMARKS			
T-1	1000 000 000 000 000 000 000 000 000 00	ALL GYPSUM BOARD NOT LISTED OTHERWISE	SHERWIN WILLIAMS	SW7070 - SITE WHITE	SATIN	-			
T-2	Search State Search Search	ALL GYPSUM BOARD CEILINGS & SOFFITS	SHERWIN WILLIAMS	SW7050 - PURE WHITE	FLAT. SEMI-GLOSS IN UTILITY, LAUNDRY, AND SUPPLY ROOMS	-			
T-5		DAYCARE ROOMS & TOILET ROOMS	SHERWIN WILLIAMS	SW6799 - SOAR	SOURCE STREET PARK 15	INFANTS, TODDLERS, TWOS & THE ATTACHED TOILET ROOMS			
T-6		DAYCARE ROOMS & TOILET ROOMS. LOBBY & OFFICE	SHERWIN WILLIAMS	SW6428 - HONEY DEW		ALL OTHER DAYCARE ROOMS & TOILETS. LOBBY & OFFICE			
T-10	EXTERIOR DOORS OTHER THAN ALUMINUM DOOR	INTERIOR FACE & HINGE SIDE	SHERWIN WILLIAMS	SW6802 - JACARANDA	SEMI-GLOSS	-			
T-10.E	EXTERIOR DOORS OTHER THAN ALUMINUM DOOR	EXTERIOR FACE & LATCH SIDE	SHERWIN WILLIAMS	SW7531 - CANVAS TAN	SEMI-GLOSS	-			

(A

C


INSTALL FULL

TRAVEL.

FLOOR MAT TILES IN

THE DIRECTIONS OF

INTERIOR FINISHES & MATERIALS SCHEDULE							
MARK	DESCRIPTION	MANUFACTURER	MODEL	FINISH	PATTERN	REMARKS	FLAME & SPREAD
ACT-1	ACOUSTIC CEILING TILE	ARMSTRONG	#513 - CIRRUS SECOND LOOK 2 SQUARE LAY-IN 15/16" BEVELED TEGULAR PRELUDE 15/16" SUSPENSION SYSTEM	WHITE		24"X48" - SCORED 24"X24" - GRID15/16" PRELUDE	CLASS A
ACT-2	ACOUSTIC CEILING TILE	ARMSTRONG	#870 CLEAN ROOM VL FIRE GUARD	WHITE		2X4 - TOILETROOMS, KITCHEN, UTILITY ROOMS	CLASS A
AL-1	ANODIZED ALUMINUM			BRONZE			
AWS-1	ROLLER SHADE	HUNTER DOUGLAS CONTRACT		M SCREEN: 8505 LINEN STONE, FASCIA: WHITE (TYPICAL)		DAYCARE ROOMS	CLASS A
AWS-2	ROLLER SHADE	HUNTER DOUGLAS CONTRACT	RB 500 - PROVIDE PERMANENTLY ATTACHED MANUAL CRANK. TREATMENT: FASCIA, HEMBAR: SEALED HEMBAR	BLACKOUT SCREEN: PERFECT GREIZE FASCIA: WHITE		MULTIPURPOSE ROOM	B1/C1
CG-1	CORNER GUARD	-				NOT USED	
CPT-1	CARPET TILE	MANNINGTON COMMERICAL	MEDIA LINE - 2'X2'	35204 TWEET		OFFICE	CLASS 1
FRP-1	FIBERGLASS REINFORCED PLASTIC	CRANE COMPOSITES	GLASBORD	EMBOSSED WHITE 85		KITCHEN	CLASS A
FRP-3	FIBERGLASS REINFORCED PLASTIC	CRANE COMPOSITES	GLASBORD	EMBOSSED IVORY 84		TOILET ROOMS	CLASS A
GL-2	GLAZING						
GYP	GYPSUM WALL BOARD	USG					
LVT-1	LUXURY VINYL TILE	MANNINGTON COMMERICAL	SPACIA	WARM TEAK SS5W2517		MAIN FLOORS	
PL-1	PLASTIC LAMINATE	WILSONART / PANOLAM		7816-60 SOLAR OAK / W375 CASTLE OAK II		MILLWORK	
PL-4	PLASTIC LAMINATE	WILSONART		5009-60 PEBBLE PIAZZA		LAUNDRY ROOM COUNTERTOP	CLASS B
RB-1	RUBBER BASE	MANNINGTON COMMERICAL	BURKEBASE - 4" TP TYPE	503 GINGER			CLASS 1
RWC-1	RIGID WALL COVERING	INPRO	PALLADIUM RIGID VINYL SHEET - 60 MIL THICKNESS	SEAGRASS 0230		SEE CORRIDOR ELEVATIONS. PROVIDE T-3 AND T-6 CAP AND TRIM	CLASS A
SS-1	SOLID SURFACE COUNTERTOP & WINDOWSILLS	WILSONART		9220CE TUMBLED STONE		COUNTERTOPS & WINDOW SILLS	
	SHEET VINYL FLOORING & INTEGRAL BASE	MANNINGTON COMMERICAL	BIOSPEC MD	MOJAVE 15525		INTERGRAL COVE WITH COVE STICK	
T-2	F.R.P. TRIM	CRANE COMPOSITES		IVORY 84		INSIDE CORNER - IC CAP - CP - DIVISON BAR - DB	
Г-3	R.W.C. TRIM	INPRO	RIGID WALL COVERING TRIM	SEAGRASS 0230		CAP, VERTICAL DIVIDER, INSIDE CORNER TRIM	CLASS A
T-5	F.R.P. TRIM	CRANE COMPOSITES		WHITE 85		INSIDE CORNER - IC . CAP - CP, DIVISON BAR - DB	
Г-6	R.W.C. CORNER TRIM	INPRO	RWC HIGH IMPACT CORNER TRIM - #160	SEAGRASS 0230		USE ON R.W.C. OUTSIDE CORNERS	
ΓS-1	VINYL TRANSITION	TARKETT				-	
ΓS-2	METAL TRANSITION	SCHLUTER				-	
ND-1	MAPLE VENEER	-		CLEAR FINISH		REFER TO DOOR SCHEDULE	
WD-2	MAPLE SCREED	-	1 1/2" X 1/4"	NATURAL MAPLE - CLEAR FINISH		REFER TO INTERIOR ELEVATIONS. INSTALL WITH BOTH GLUE AND NAILS, TYPICAL. ROUNDED EDGES	
/VM-1	WALK-OFF MAT	MANNINGTON COMMERICAL	FRICTION COLLECTION - FORCE - 18"X36"	KINETIC 11360	PARALLEL TO L.V.T.	24"X24". WALK OFF MAT CARPET TILES AT SIDE AND MAIN ENTRIES	CLASS 1

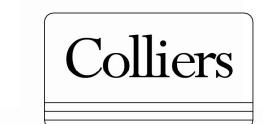

Engineering & Design

Architecture, Landscape Architecture, Surveying, CT P.C.

www.colliersengineering.com opyright © 2024. Colliers Engineering & Design All Rights Reserved. This drawing and all the information contained herein is authorized for use only by the party for whom the services vere contracted or to whom it is certified. This drawing may not be copied, reused, disclosed, distributed or relied upon for any other purpose without the express written consent of

JAM ARCH Formerly Known as

REV DATE

DESCRIPTION 07/07/2025 PROGRESS SET

Michelle Simms

LEARNING CARE GROUP

OLD KNIGHT RD. & HORTON KNIGHTDALE, NC 27545

> NC ARCHITECTURE FIRM LICENSE # 54174

NOT FOR CONSTRUCTION Project Kick Off SUBMISSION

WOODCLIFF LAKE 300 Tice Blvd, Ste 101 Colliers Woodcliff Lake, NJ 07677 Phone: 845.352.0411

Engineering

Colliers Engineering & Design, Architecture, Landscape Architecture, & Design Surveying, CT P.C. Architecture, Landscape PROJECT MANAGER: DISCIPLINE LEAD:

SO DESIGNER: REVIEWER: CJCPROJECT NUMBER:

FINISH FLOOR PLAN

25002372A

DRAWING NUMBER: A104

NOTE: DO NOT SCALE DRAWING FOR CONSTRUCTION.

- SHEET VINYL FLOORING TERMINATION BAR TO MATCH FLOOR FINISH COLOR


SHEET VINYL FLOOR

— 6" HIGH SHEET VINYL COVE BASE - COVE

BASE TO BE INSTALLED PER MANUFACTURER SPECIFICATION

- WALL FINISH WITH TRIM PER SPECS. RUBBER COVE BASE. INSTALLED PER MANUFACTURER RECOMMENDATIONS - FINISH FLOOR AS SCHEDULED

RUBBER BASE DETAIL

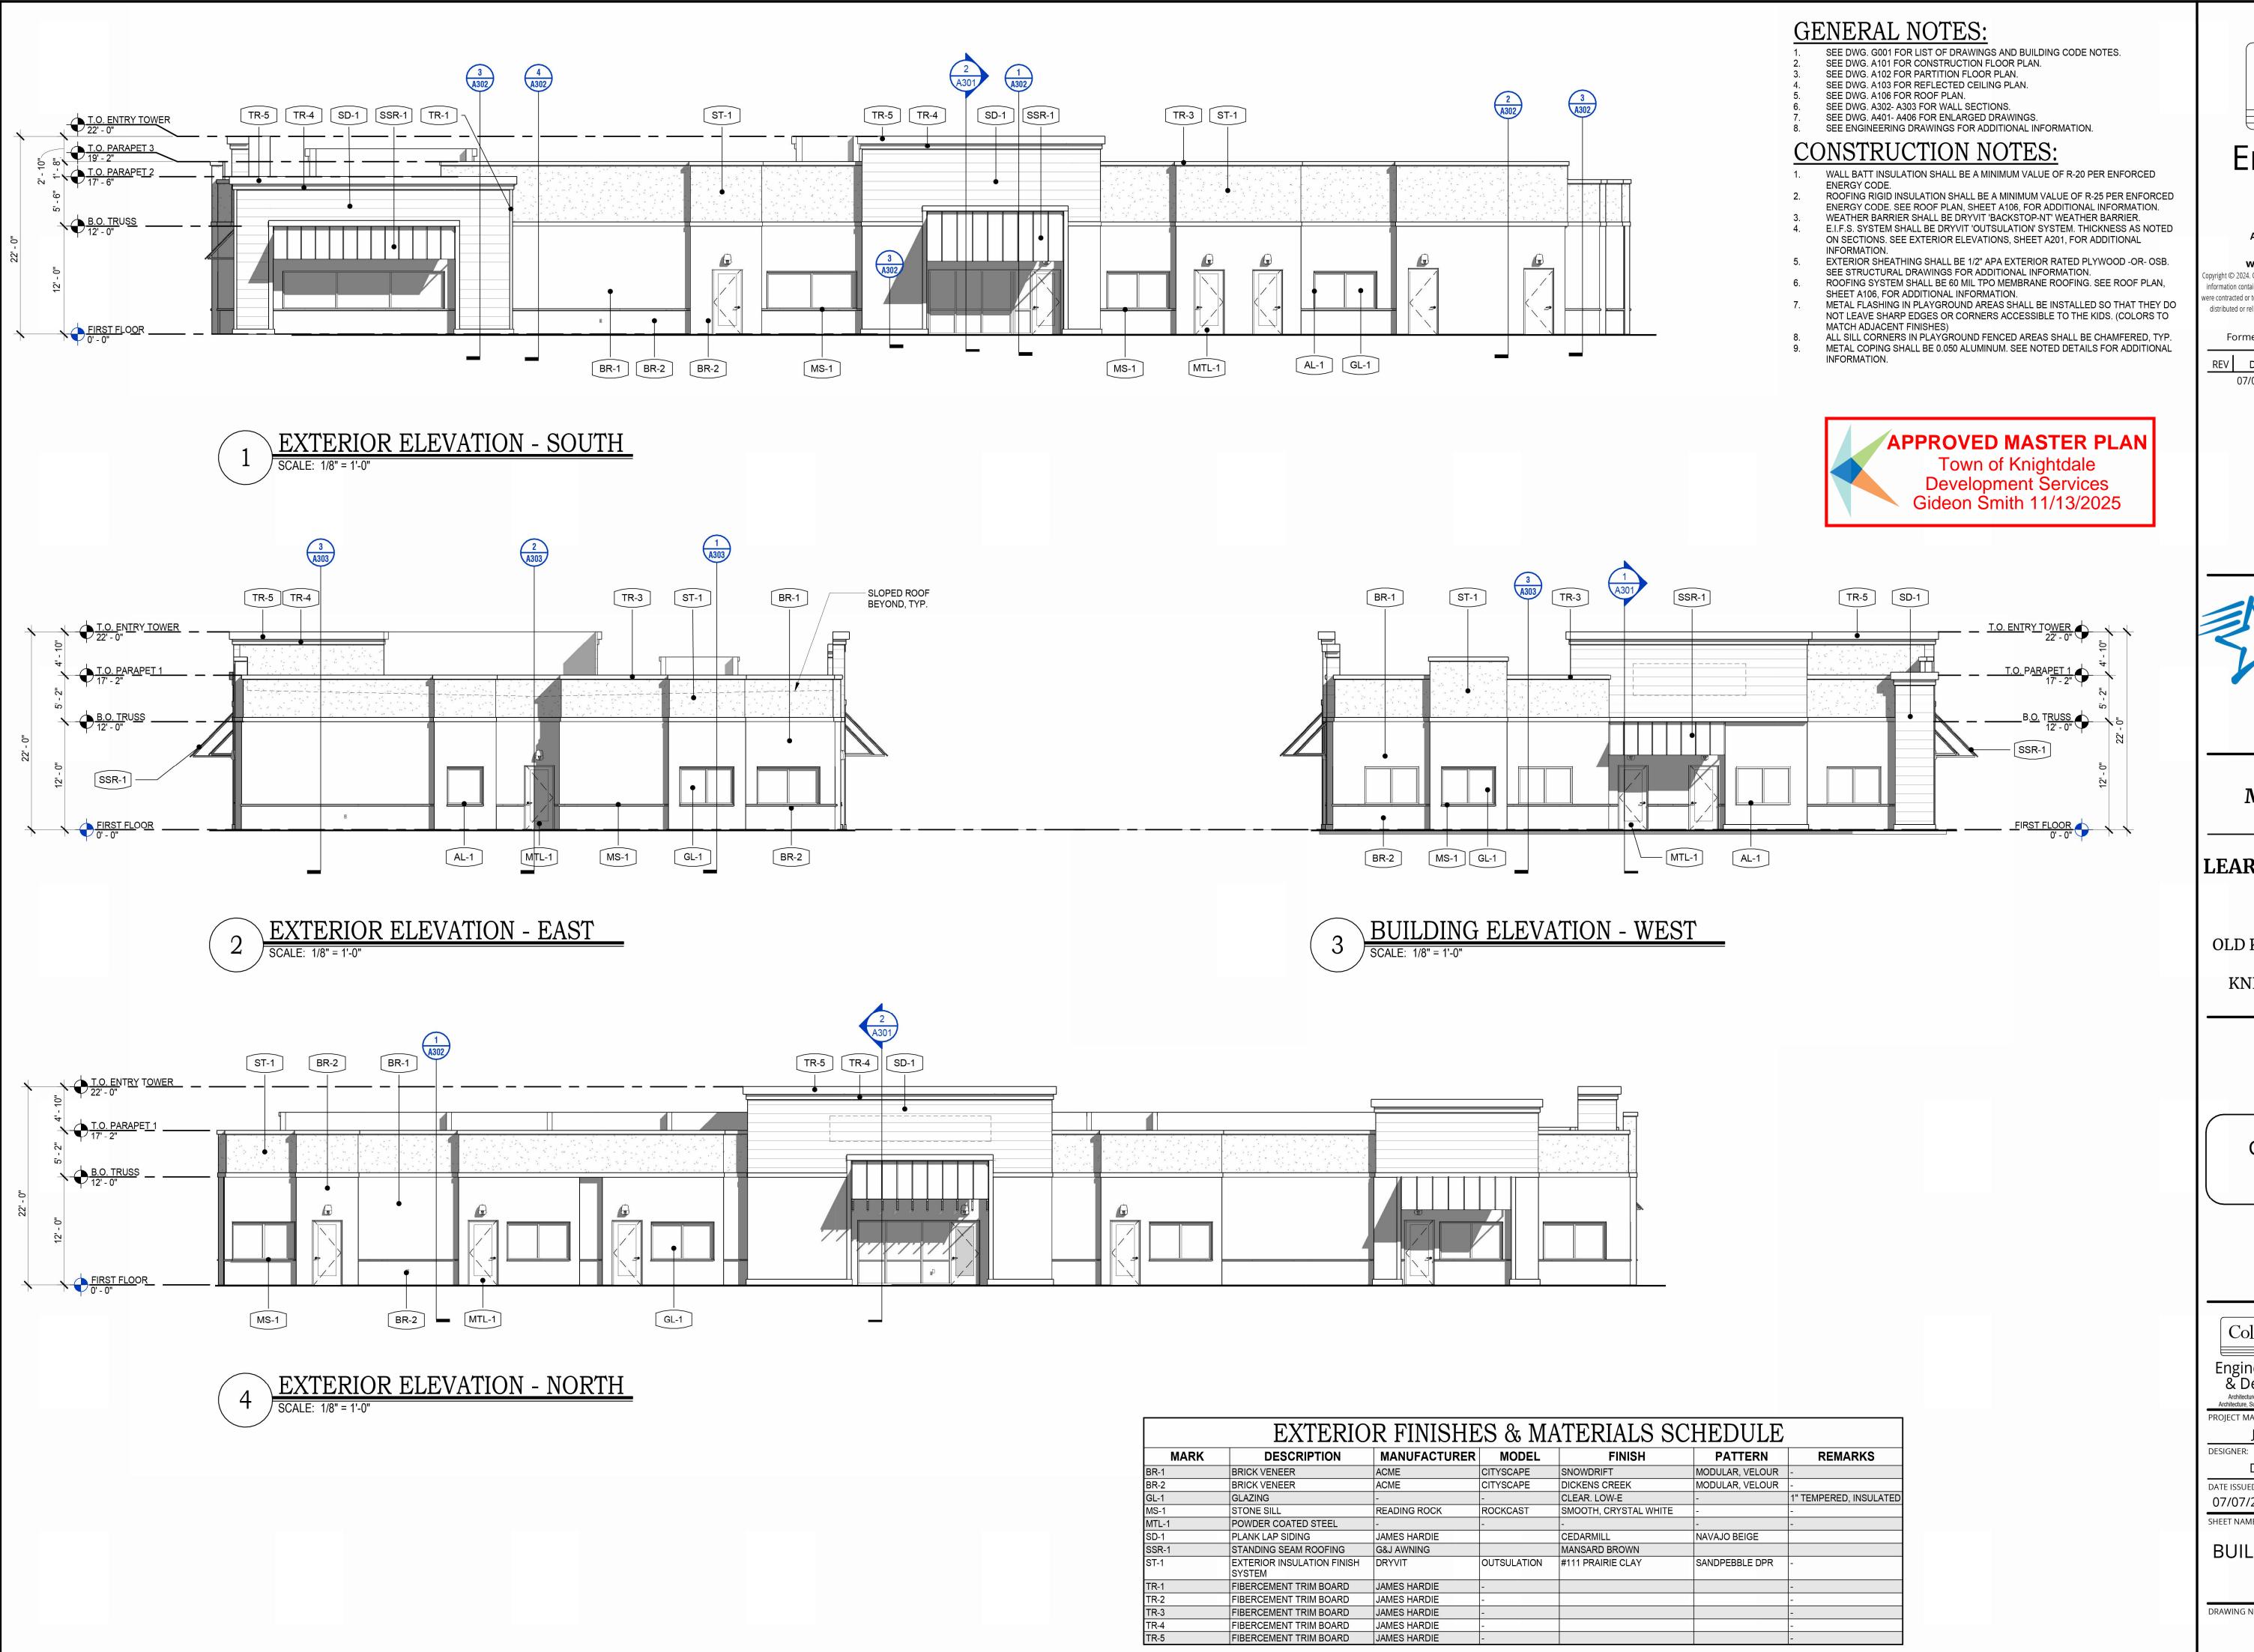

Colliers

Engineering & Design

Architecture, Landscape Architecture, Surveying, CT P.C.

www.colliersengineering.com

ppyright © 2024. Colliers Engineering & Design All Rights Reserved. This drawing and all the information contained herein is authorized for use only by the party for whom the services ere contracted or to whom it is certified. This drawing may not be copied, reused, disclosed, distributed or relied upon for any other purpose without the express written consent of

Formerly Known as

JAM ARCH REV DATE DESCRIPTION

07/07/2025 PROGRESS SET

Michelle Simms

LEARNING CARE GROUP

OLD KNIGHT RD. & HORTON KNIGHTDALE, NC 27545

> NC ARCHITECTURE FIRM LICENSE # 54174

NOT FOR CONSTRUCTION Project Kick Off SUBMISSION

Colliers

300 Tice Blvd, Ste 101 Woodcliff Lake, NJ 07677 Phone: 845.352.0411

WOODCLIFF LAKE

Engineering & Design Architecture, Landscape Architecture, Surveying, CT I

Colliers Engineering & Design, Architecture, Landscape Architecture, Surveying, CT P.C.

PROJECT MANAGER: DISCIPLINE LEAD: SO

REVIEWER: CJC


DATE ISSUED: 07/07/2025

PROJECT NUMBER: 25002372A

BUILDING ELEVATIONS & NOTES

DRAWING NUMBER:

A201

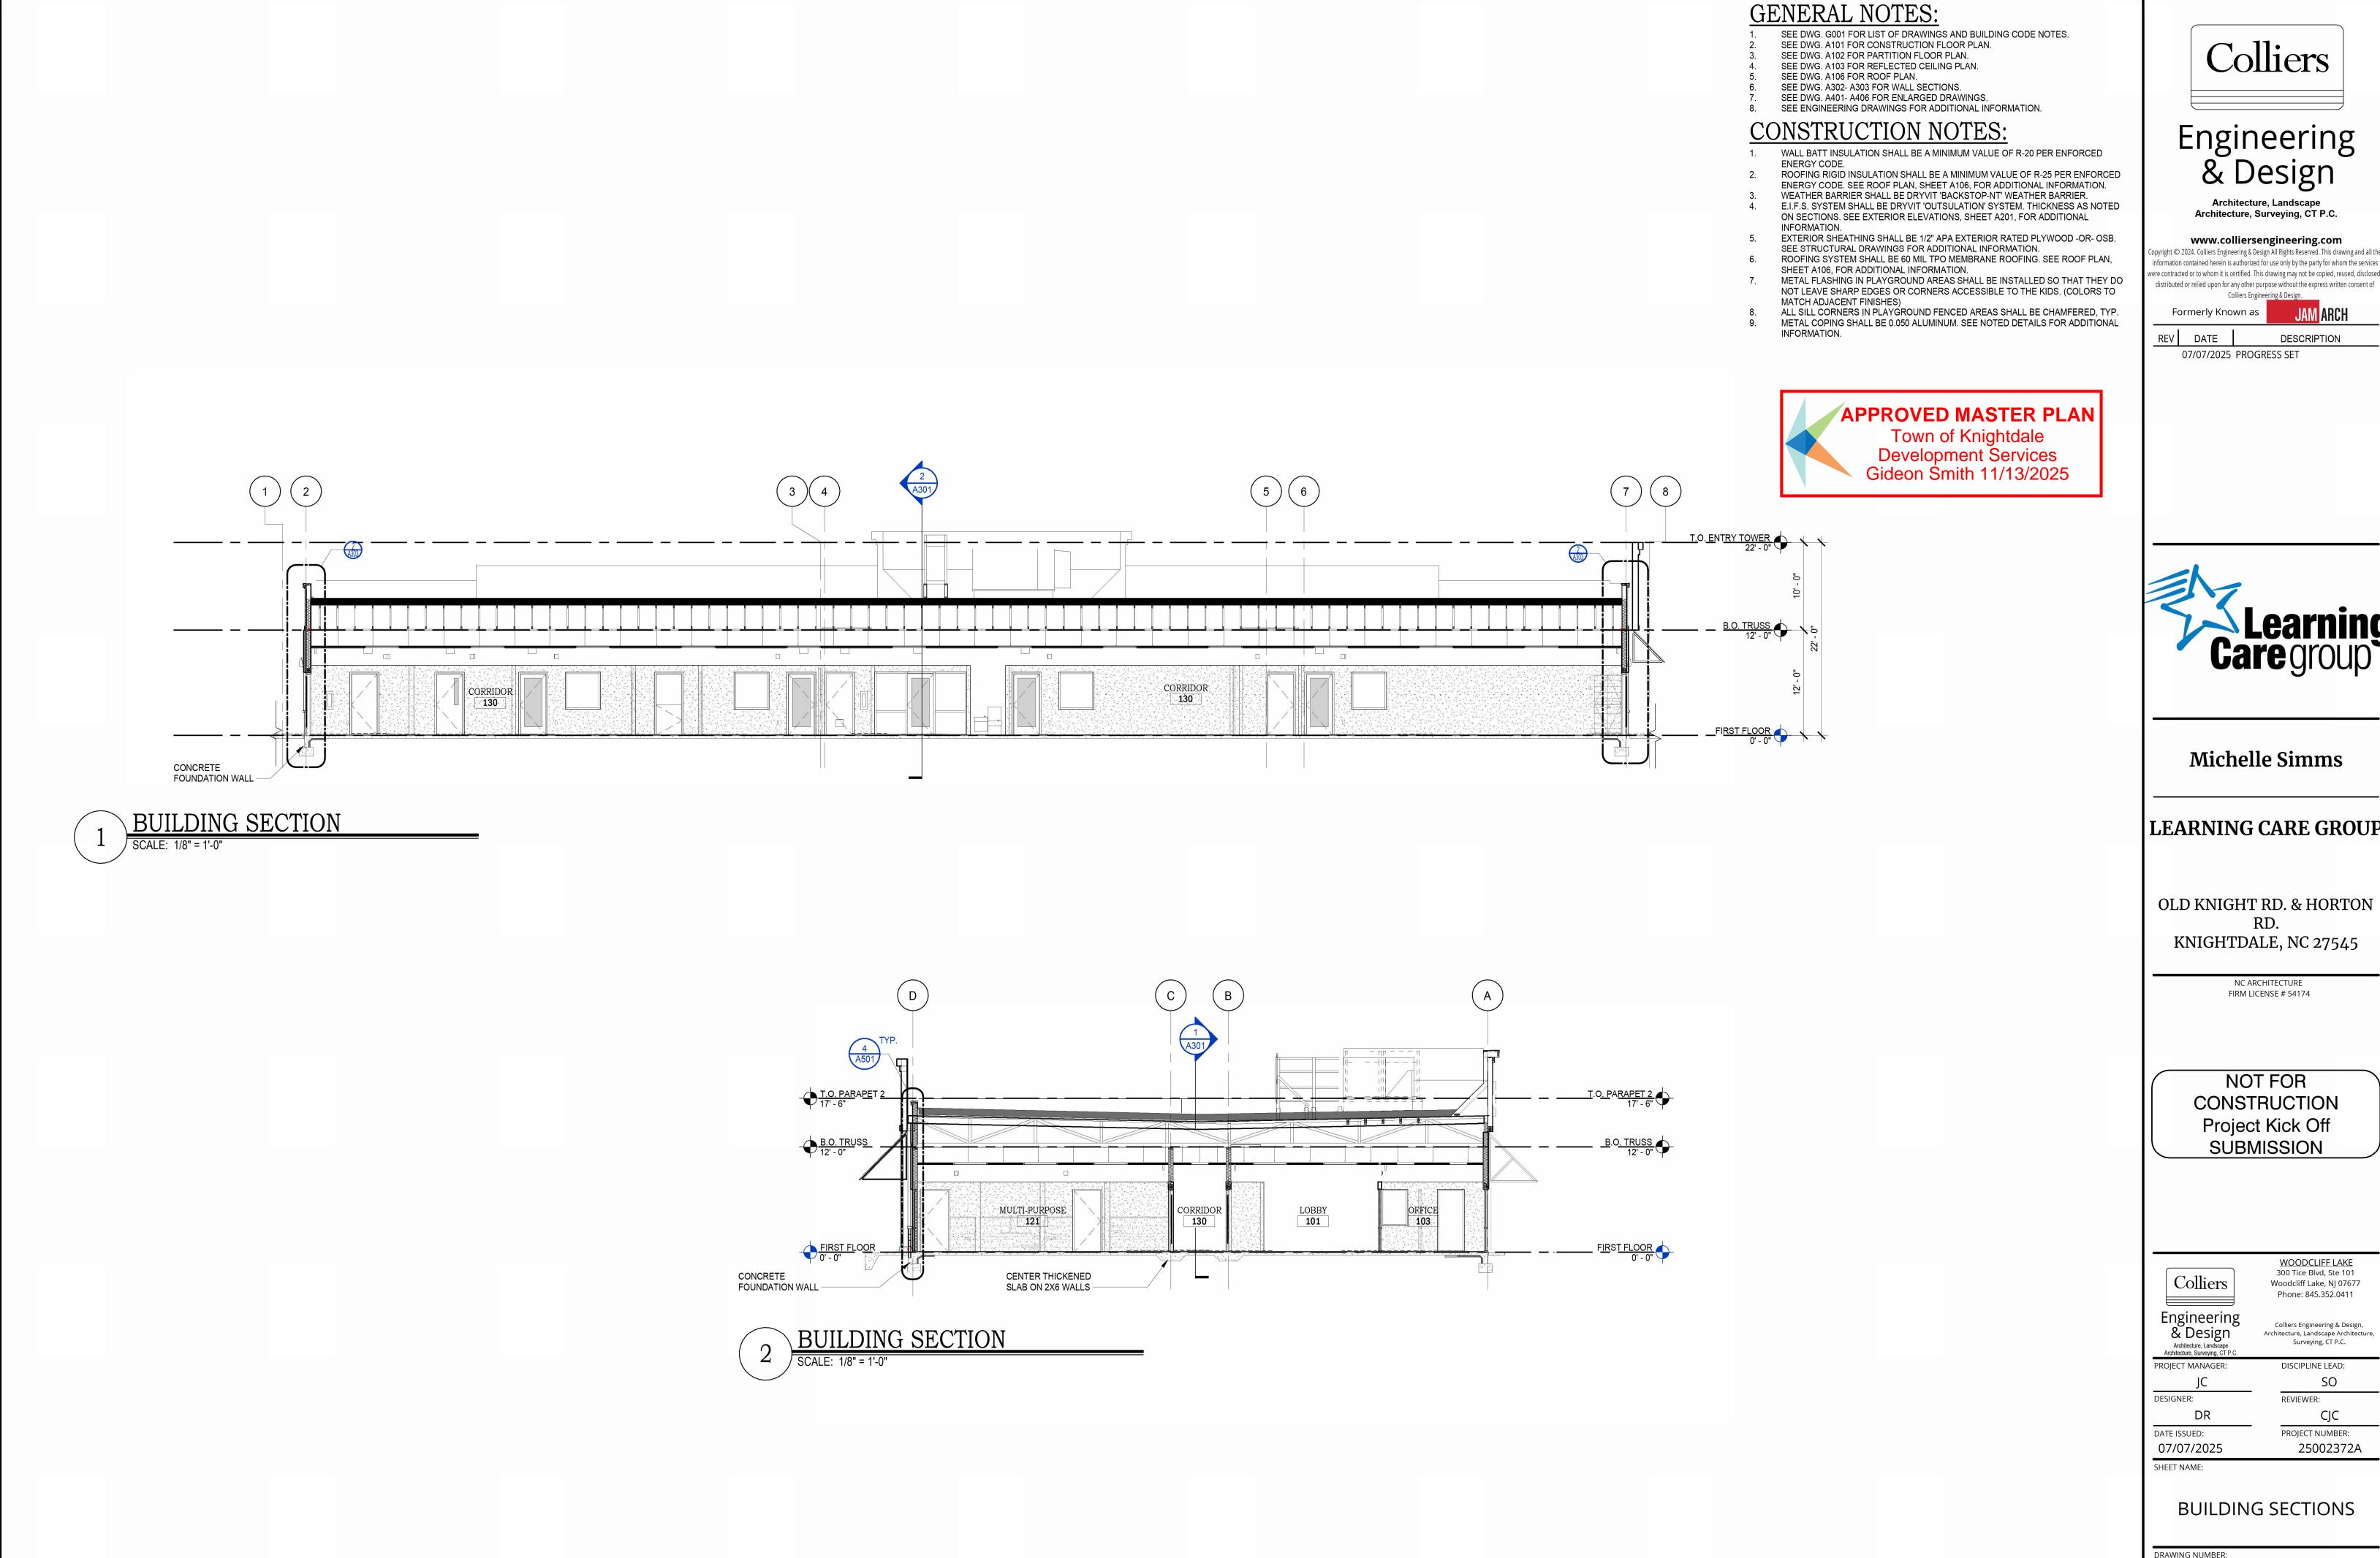

Colliers

Engineering & Design

Architecture, Landscape Architecture, Surveying, CT P.C.

www.colliersengineering.com iopyright © 2024. Colliers Engineering & Design All Rights Reserved. This drawing and all the information contained herein is authorized for use only by the party for whom the services vere contracted or to whom it is certified. This drawing may not be copied, reused, disclosed,

Colliers Engineering & Design. Formerly Known as

JAM ARCH DESCRIPTION

REV DATE

07/07/2025 PROGRESS SET

Michelle Simms

LEARNING CARE GROUP

OLD KNIGHT RD. & HORTON KNIGHTDALE, NC 27545

> NC ARCHITECTURE FIRM LICENSE # 54174

NOT FOR CONSTRUCTION Project Kick Off SUBMISSION

Colliers

300 Tice Blvd, Ste 101 Woodcliff Lake, NJ 07677 Phone: 845.352.0411

Engineering & Design Architecture, Landscape Architecture, Surveying, CT F

Colliers Engineering & Design, Architecture, Landscape Architecture, Surveying, CT P.C.

WOODCLIFF LAKE


PROJECT MANAGER: DISCIPLINE LEAD: SO REVIEWER:

CJC PROJECT NUMBER: 25002372A

BUILDING SECTIONS

DRAWING NUMBER:

A301

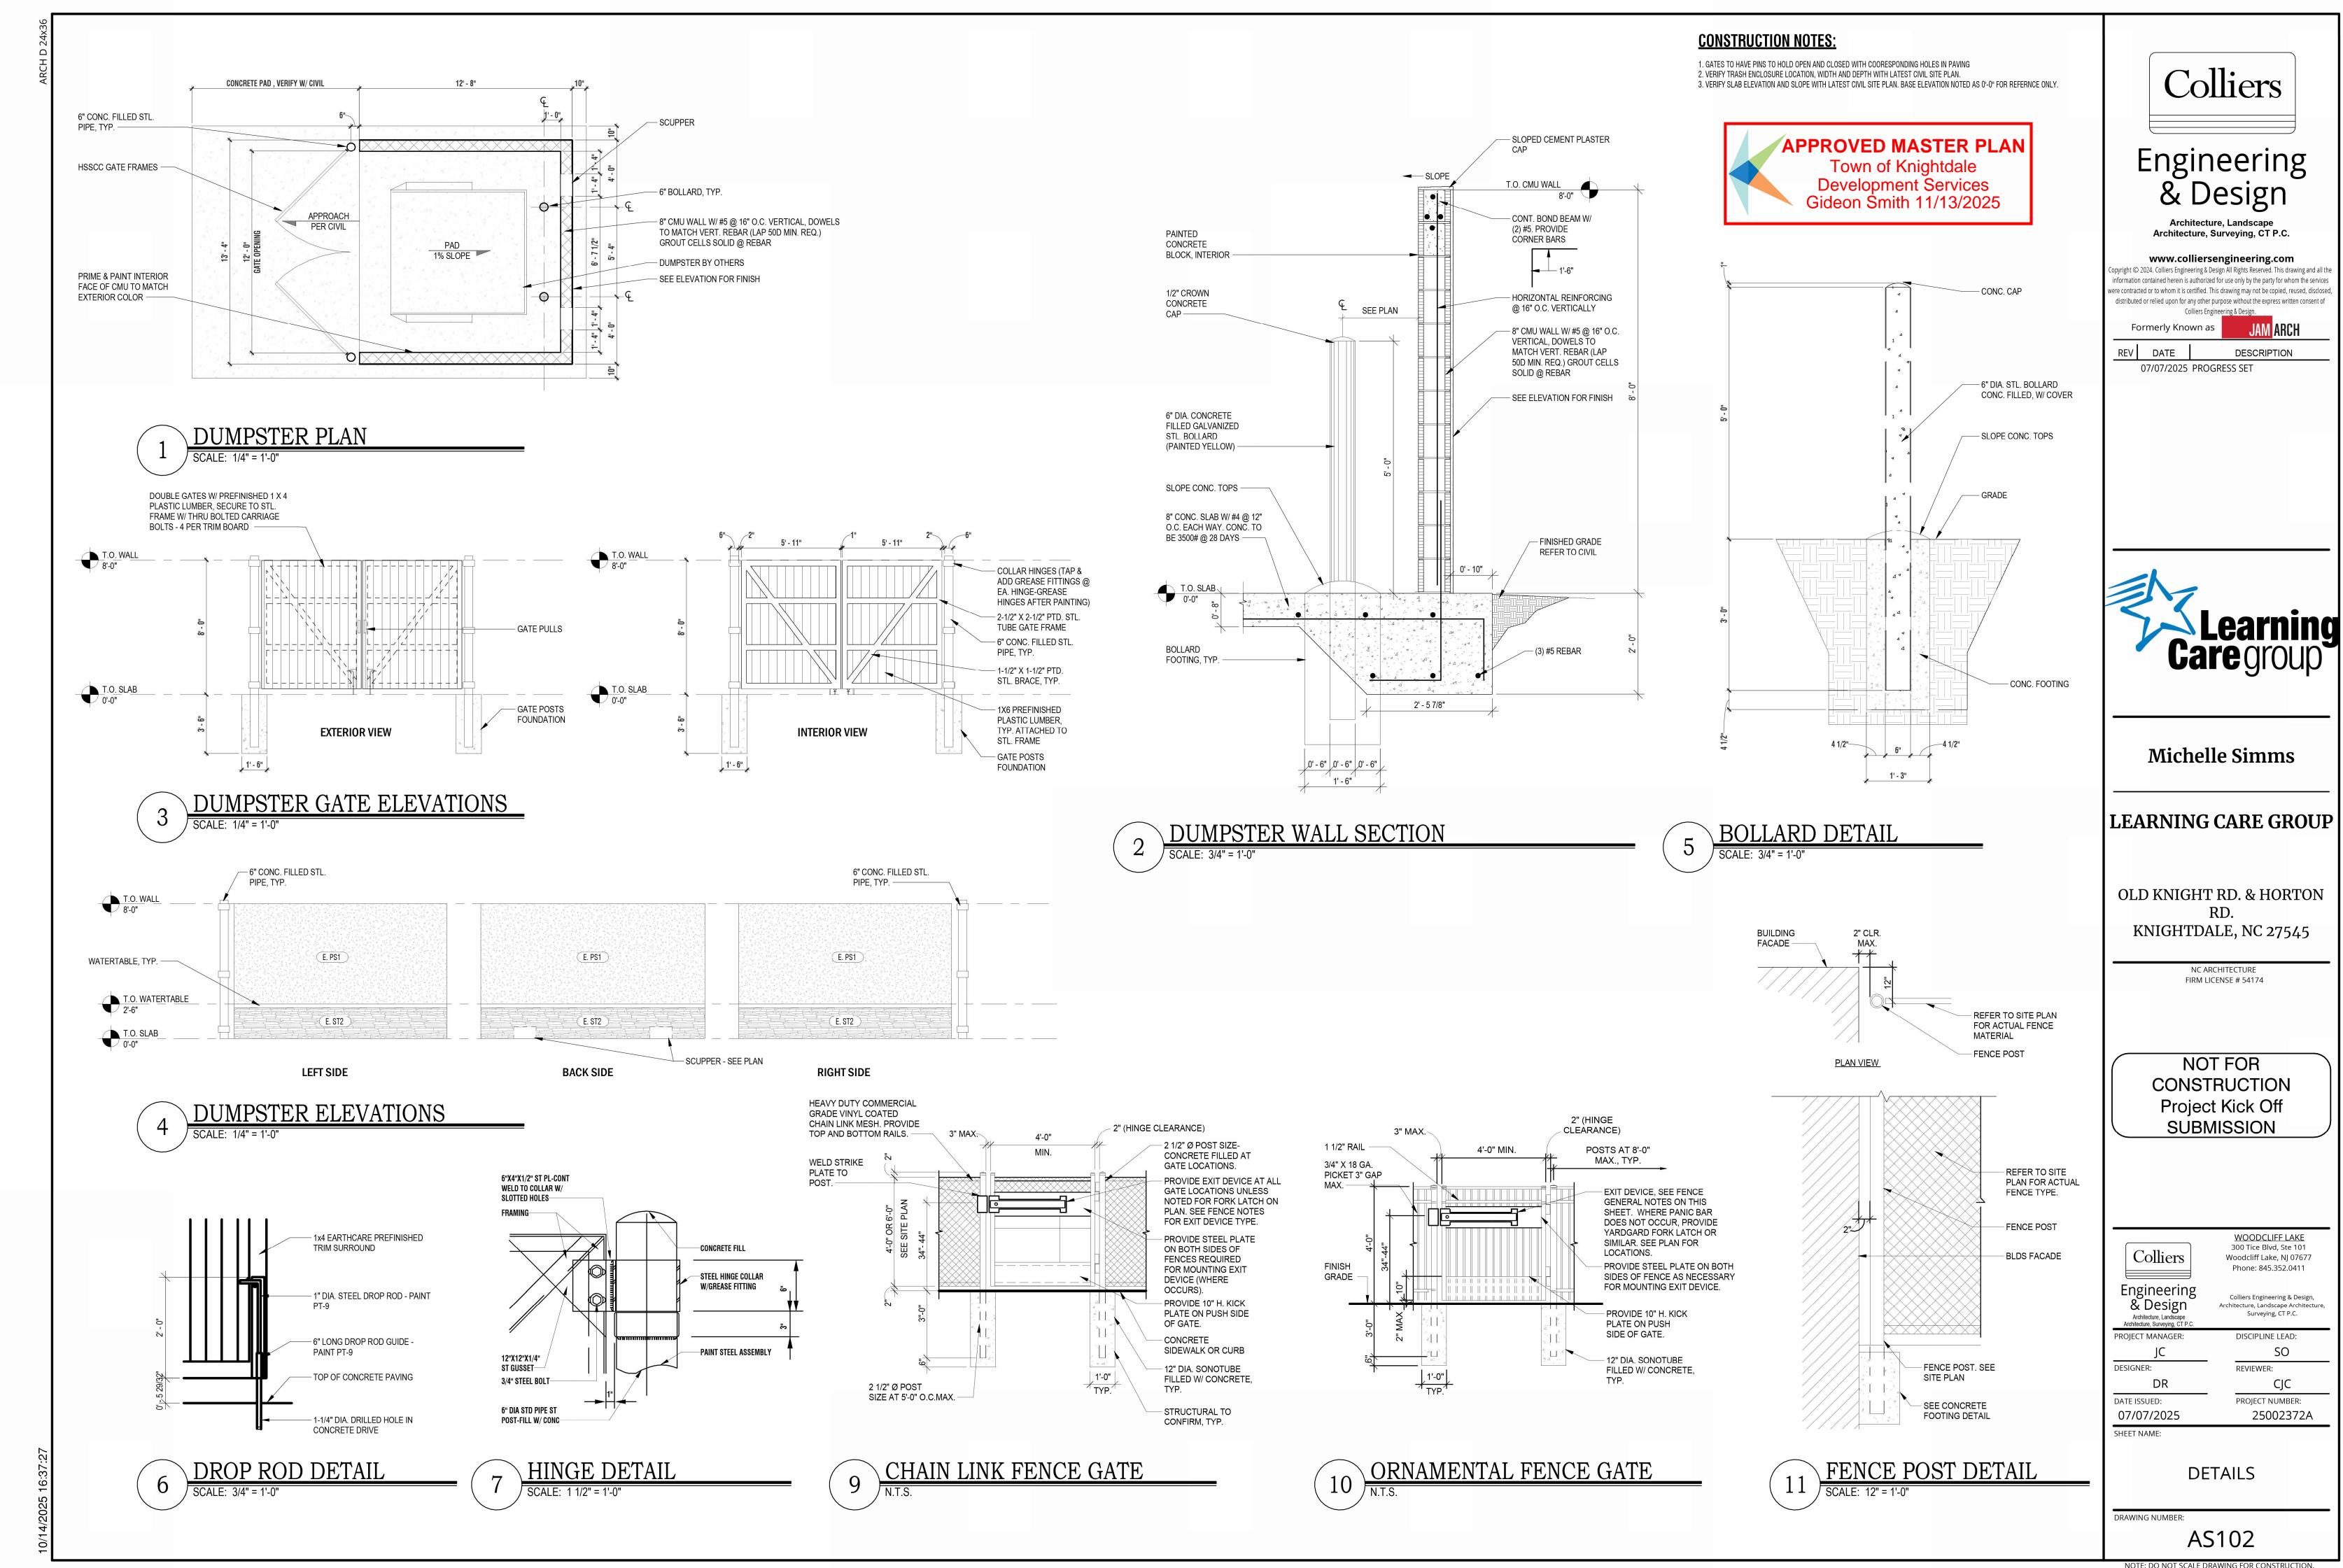

- 1. THE CONSTRUCTION DOCUMENTS CONSIST OF THE WORKING DRAWINGS HEREIN, THE PROJECT MANUAL AND ALL ADDENDA. IN THE EVENT OF A CONFLICT OF DISCREPANCY BETWEEN THE DOCUMENTS, THE CONTRACTOR SHALL BRING SUCH CONFLICT OR DISCREPANCY TO THE ATTENTION OF THE ARCHITECT FOR CLARITY PRIOR TO SUBMITTING A BID.
- 2. THE ARCHITECT HAS BEEN RETAINED TO PERFORM AT NORMAL SERVICE STANDARDS FOR THE PREPARATION OF THESE PLANS AND SPECIFICATIONS. THE ARCHITECT HAS NOT BEEN RETAINED TO PERFORM OTHER SERVICES SUCH AS: CIVIL, SOILS, SPECIAL INSPECTIONS OR SERVICES SUCH AS LEGAL, ENVIRONMENTAL, REAL ESTATE, CONSTRUCTION CONTRACTING OR CONTRACTOR SUPERVISOR.
- 3. THE ARCHITECT SHALL NOT BE RESPONSIBLE FOR SOILS OR SUBSURFACE ENGINEERING OR
- 4. THE ARCHITECT SHALL NOT BE RESPONSIBLE FOR OBTAINING MUNICIPAL APPROVALS, SUCH AS BUILDING DEPARTMENT, ENVIRONMENTAL OR ZONING. THE ARCHITECT SHALL ASSIST THE OWNER AND CONTRACTOR IN THAT EFFORT AS THE NEED ARISES.
- 5. THE ARCHITECT SHALL NOT BE RESPONSIBLE FOR ACTIONS OF THE OWNER OR CONTRACTOR. NOR HAS THE ARCHITECT BEEN RETAINED OR ARE THEY RESPONSIBLE FOR SUPERVISION OF THE CONTRACTOR, DESIGN OF SAFETY PROVISIONS AT THE SITE, CONSTRUCTION SCHEDULES OR MEANS AND METHODS OF THE CONSTRUCTION.
- 6. THE CONTRACTOR AND OWNER SHALL BE RESPONSIBLE FOR THE SAFE MAINTENANCE OF THE **BUILDING AND IT'S FACILITIES.**
- 7. ALL MATERIALS, FORMS, ASSEMBLIES AND METHODS OF CONSTRUCTION AND SERVICE EQUIPMENT SHALL BE THE RESPONSIBILITY OF THE CONTRACTOR AND MEET ALL MUNICIPAL REQUIREMENTS.
- 8. INTENT OF THIS SPECIFICATION AND GENERAL CONDITIONS:

MENTIONED HEREIN OR INDICATIONS ON DRAWINGS OR ARTICLES, OPERATIONS, METHODS OR MATERIALS, REQUIRES THAT THE CONTRACTOR PROVIDE EACH ITEM MENTIONED, INDICATED OR IMPLIED TO ACHIEVE THE INTENDED "PROJECT", BUILDING AND SITE WORK, ACCORDING TO THE METHODS OF BEST CONSTRUCTION PRACTICE (OR OF QUALITY OR METHOD SPECIFICALLY NOTED.) IN NO EVENT IS ANY ARTICLE, OPERATION, METHOD OR MATERIAL TO FALL BELOW BEST QUALITY AND FIRST CLASS TRADE. SAFETY STANDARDS AND ZONING AND CODE REQUIREMENTS. IN EVENT OF CONFLICTING STANDARDS, CODES OR SPECIFICATION REQUIREMENTS, THE METHOD, EQUIPMENT AND OPERATION OR MATERIAL OF BEST AND SAFEST QUALITY IS TO GOVERN THE WORK. ALL EQUIPMENT AND MATERIAL IS TO BE NEW AND IS TO BE INSTALLED ACCORDING TO MANUFACTURER'S RECOMMENDATIONS UNLESS OTHERWISE SPECIFIED. ALL WORK, ARTICLES, OPERATIONS, METHODS AND MATERIALS ARE TO BE APPROVED BY GOVERNING BUILDING OFFICIALS.

9. GENERAL RESPONSIBILITY:

THE CONTRACTOR SHALL LAY OUT ALL WORK AND BE RESPONSIBLE FOR IT'S CORRECTNESS AND SAFETY AND SHALL PROVIDE ALL NECESSARY LINES, LEVELS AND DIMENSIONS AS NOTED. ALL MEASUREMENTS SHALL BE VERIFIED AT THE SITE AND BUILDING BY THE CONTRACTOR AND TRADES BEFORE ORDERING MATERIALS OR DOING ANY WORK. ANY DISCREPANCIES IN SITE, SOIL CONDITIONS, EXISTING BUILDING CONDITIONS, PLANS AND DETAILS MUST BE REPORTED TO THE ARCHITECT AT ONCE. NO CHANGES OR SUBSTITUTIONS MAY BE MADE UNLESS APPROVED BY OWNER AND ARCHITECT.

- 10. THE CONTRACTOR SHALL BE RESPONSIBLE FOR THE SAFE MAINTENANCE OF THE SITE, BUILDING AND ITS FACILITIES AND PROVIDE INSURANCE COVERAGE REQUIRED BY LAW AND GOOD STANDARD
- 11. ALL MATERIALS, FORM ASSEMBLIES AND METHODS OF CONSTRUCTION AND SERVICE EQUIPMENT SHALL MEET THE FOLLOWING REQUIREMENTS AND ARE THE RESPONSIBILITY OF THE CONTRACTOR: 11.1 THEY SHALL HAVE BEEN ACCEPTED BY GOVERNING LOCAL AND STATE AGENCIES CODES AT THE EFFECTED DATE OF THE CONTRACT.
- 11.2. SHALL HAVE BEEN ACCEPTED FOR USE UNDER THE PRESCRIBED CODE TEST METHODS.
- 12. AT LEAST 48 HOURS WRITTEN NOTICE SHALL BE GIVEN TO THE BUILDING DEPARTMENT BEFORE COMMENCEMENT OF WORK AND A BUILDING PERMIT OBTAINED BEFORE STARTING ANY WORK.
- 13. ALTERED GRADES EXCEEDING 30 DEGREE SLOPE SHALL HAVE A RETAINING WALL FILED AND APPROVED BY THE DEPARTMENT OF BUILDING BEFORE START OF SUCH WORK.

14.ARCHITECT'S STATUS:

THE ARCHITECT IS RESPONSIBLE ONLY TO THE EXTENT OF PROVIDING THE CONSTRUCTION DOCUMENTS. PLANS AND SPECIFICATIONS FOR THIS PROJECT SCOPE. THE ARCHITECT SHALL INTERPRET CONSTRUCTION DOCUMENTS TO THE BEST OF HIS KNOWLEDGE AND BASED ON HIS PROFESSIONAL OPINION, WILL DEFINE THEIR MEANING. THE ARCHITECT IS NOT RESPONSIBLE FOR MEANS AND METHODS OF THE CONTRACTOR AND IS NOT RESPONSIBLE FOR SAFETY ON THE JOB OR DELAYS IN CONSTRUCTION. THE ARCHITECT SHALL NOT BE RESPONSIBLE NOR BE HELD LIABLE FOR SITE OR CONSTRUCTION SAFETY CONDITIONS, CONSTRUCTION MEANS OR METHODS. THE ARCHITECT IS NOT RESPONSIBLE FOR ADMINISTRATION OF THE CONSTRUCTION. THE ARCHITECT IS NOT RESPONSIBLE FOR ACTIONS OF THE DEVELOPER, CONTRACTOR, SUB CONTRACTORS OR OWNER-

15.SCOPE OF WORK:

THE CONTRACTOR SHALL CONSTRUCT THE PROJECT AS DESCRIBED IN THE CONTRACT DOCUMENTS (THE WORKING DRAWINGS AND SPECIFICATIONS). THE WORD "ARCHITECT" SHALL DESCRIBE JUSTIN A. MIHALIK, A.I.A. THE PROJECT IS DESIGNED TO CONFORM WITH ALL GOVERNING BUILDING CODES AND ZONING REQUIREMENTS AND THOSE ENGAGED IN THE WORK ARE DIRECTED TO MEET THOSE ENDS. ANY DISCREPANCIES ARE TO BE REPORTED TO THE ARCHITECT IMMEDIATELY.

16. CONTRACTOR'S INSURANCE:

THE CONTRACTOR SHALL FILE WITH THE OWNER, CERTIFICATES OF THE FOLLOWING COVERAGE **INCLUDED BUT NOT LIMITED TO:**

A. WORKMEN'S COMPENSATION INSURANCE AS REQUIRED BY ALL GOVERNING LAW. B. PUBLIC LIABILITY INSURANCE COVERING ANY ONE PERSON AND COVERING SEVERAL PERSONS PER THE A.I.A. DOCUMENTS AS A MINIMUM. MORE COVERAGE MAY BE DESIRED OR NEEDED. C. PROPERTY DAMAGE INSURANCE: THE CONTRACTOR SHALL OBTAIN AND FILE WITH THE OWNER A CERTIFICATE FOR PROPERTY DAMAGE INSURANCE COVERING EACH ACCIDENT AND COVERING THE AGGREGATE OF OPERATIONS MINIMUM PER THE ABOVE MENTIONED A.I.A. DOCUMENT REQUIRES "AS A MINIMUM". MORE COVERAGE MAY BE DESIRED OR NEEDED.

THE CONTRACTOR SHALL OBTAIN INSURANCE AND PROVIDE CERTIFICATES OF INSURANCE TO THE OWNER. THE CERTIFICATES SHALL CONTAIN A 30 DAY NOTICE OF CANCELLATION CLAUSE ADDRESSED TO OWNER.

17. REQUIRED DOCUMENTATION:

THE OWNER SHALL PROVIDE ALL NECESSARY SURVEYS, SOIL REPORTS AND PERTINENT DATA NEEDED OR REQUESTED BY THE ARCHITECT IN ORDER TO PREPARE PLANS AND SPECIFICATIONS.

18. OWNER'S INSURANCE:

THE OWNER SHALL EFFECT AND MAINTAIN ALL INSURANCE COVERAGES AS REQUIRED. ALL INSURANCE DESCRIBED HEREIN IS A RECOMMENDED MINIMUM. MORE COVERAGE MAY BE

19. VISITING THE SITE:

THE CONTRACTOR SHALL VISIT THE SITE AND FAMILIARIZE THEMSELVES WITH THE CONDITIONS THAT EXIST. THE CONTRACTOR SHALL INFORM THE OWNER AND ARCHITECT OF ANY CONDITIONS WHICH ARE NOT COVERED BY THE WORKING DRAWINGS OR SPECIFICATIONS OR DISCREPANCIES IN EXISTING CONDITIONS.

20.LAYOUT OF WORK:

A SURVEY IS TO BE MADE AVAILABLE FROM THE OWNER TO THE CONTRACTOR BEFORE STARTING WORK. THE CONTRACTOR SHALL LAY OUT THE WORK AND ESTABLISH ELEVATIONS, ACCURATELY MARKED ON SUBSTANTIAL BATTER BOARDS.

21.MEASUREMENTS AND DIMENSIONS:

MEASUREMENTS AND DIMENSIONS, INDICATED ON THE DRAWINGS ARE NOMINAL. THEY SHALL BE ADHERED TO WHEREVER PRACTICAL. MAJOR DEVIATIONS IN DIMENSIONS SHALL BE BROUGHT TO THE ARCHITECT'S ATTENTION BEFORE PROCEEDING WITH WORK. PRIOR TO CONTRACTOR'S PURCHASE OF ANY BUILT-IN EQUIPMENT OR CABINETS, THE CONTRACTOR IS TO TAKE FIELD DIMENSIONS AND SHALL BE RESPONSIBLE FOR THEIR CORRECTNESS.

22.<u>TAXES:</u>

THE CONTRACTOR IS LIABLE FOR ALL STATE AND FEDERAL EMPLOYER'S AND EMPLOYEE'S TAXES, SALES TAXES AND WITHHOLDING TAXES.

23. GUARANTEE:

THE CONTRACTOR SHALL UNCONDITIONALLY GUARANTEE ALL WORK FOR A PERIOD OF ONE YEAR FROM THE DATE OF FINALACCEPTANCE OF THE BUILDING AND A CERTIFICATE OF OCCUPANCY IS OBTAINED.

24. CONTRACT DRAWINGS:

THE CONTRACT DRAWINGS. WHICH ACCOMPANY AND FORM A PART OF THESE DOCUMENTS ARE ATTACHED HEREINAFTER. THE CONTRACT DRAWINGS DO NOT SHOW ALL THE DETAILS OF THE WORK AND ARE INTENDED ONLY TO ILLUSTRATE THE CHARACTER AND EXTENT OF THE WORK TO BE PERFORMED. ACCORDINGLY, THEY MAY BE SUPPLEMENTED DURING THE PERFORMANCE OF THE WORK BY THE ARCHITECT OR BY THE CONTRACTOR SUBJECT TO THE APPROVAL OF THE ARCHITECT TO THE EXTENT NECESSARY TO FURTHER ILLUSTRATE THE WORK AND SHALL, AT ALL TIMES, REMAIN THE POSSESSION OF THE ARCHITECT.

25.ADDITIONAL DRAWINGS:

THE CONTRACTOR SHALL PROVIDE ALL SHOP DRAWINGS WHICH MAY BE NECESSARY OR REQUIRED. THE SIZE OF THE DRAWINGS. THE NUMBER OF COPIES AND THE DETAILS TO BE SHOWN THEREON SHALL BE AS APPROVED BY THE OWNER IN ADVANCE OF THEIR PREPARATION. BEFORE ISSUING ANY SHOP DRAWINGS, THE CONTRACTOR SHALL SUBMIT PRINTS THEREOF, INCLUDING THE REQUIRED NUMBER OF REVISED PRINTS, UNTIL THE DRAWINGS ARE APPROVED BY THE OWNER. AFTER APPROVAL THEREOF, NO CHANGE SHALL BE MADE THEREON UNLESS APPROVED, IN WRITING, BY THE OWNER. TRACINGS OF SHOP DRAWINGS SHALL BE DELIVERED TO THE OWNER PRIOR TO FINAL PAYMENT.

26.LAWS AND ORDINANCES:

IN ORDER TO EFFECTUATE THE WORK PROPERLY, THE CONTRACTOR SHALL COMPLY WITH ALL PROVISIONS OF FEDERAL, STATE, MUNICIPAL AND DEPARTMENTAL LAWS, CODES ORDINANCES, RULES, REGULATIONS AND ORDERS WHICH WOULD AFFECT THE WORK AND ITS PERFORMANCE AND THOSE ENGAGED THEREIN. THE WORK IS TO CONFORM WITH ALL GOVERNING BUILDING CODES, AND ZONING REQUIREMENTS AND THOSE ENGAGED THEREIN ARE DIRECTED TO MEET THOSE ENDS. ANY DISCREPANCIES ARE TO BE REPORTED TO THE ARCHITECTS IMMEDIATELY.

27.APPROVALS:

ANY APPROVAL BY THE ARCHITECT OR ANYTHING DONE OR PROPOSED TO BE DONE BY THE CONTRACTOR SHALL BE CONSTRUED MERELY TO MEAN THAT AT THAT TIME THE ARCHITECT KNOWS OF NO GOOD REASON FOR OBJECTING TO THERETO: AND NO SUCH APPROVAL SHALL RELIEVE THE CONTRACTOR FROM HIS FULL RESPONSIBILITY FOR THE COMPLETE AND ACCURATE PERFORMANCE OF THE WORK IN ACCORDANCE HEREWITH OR FROM ANY DUTY. OBLIGATION OR LIABILITY IMPOSED UPON HIM BY THE CONTRACT OR FROM RESPONSIBILITY FOR INJURIES TO PERSONS OR DAMAGE TO PROPERTY.

28. CONTRACTOR'S REPRESENTATIVE:

DURING THE PERFORMANCE OF ANY WORK AT THE SITE, THE CONTRACTOR SHALL HAVE A REPRESENTATIVE PRESENT WHO SHALL BE AUTHORIZED BY THE CONTRACTOR TO SUPERVISE THE WORK AND BE RESPONSIBLE FOR SAFELY CONDUCTING OPERATIONS AND ACTIVITIES. THE SUPERVISOR SHOULD BE DEDICATED TO THE PROJECT FOR ITS DURATION AND NOT BE REPLACED WITHOUT 30 DAYS NOTICE TO THE OWNER.

29. INSPECTIONS:

ALL CONTROLLED INSPECTIONS SHALL BE PERFORMED BY THE BUILDING DEPARTMENT. THE CONTRACTOR SHALL PROVIDE THE REQUIRED NOTICE FOR SAME AND BE PRESENT FOR ALL SUCH INSPECTIONS.

THE CONTRACTOR SHALL BE RESPONSIBLE FOR CONTACTING THE PERSON DESIGNATED, WITH AMPLE NOTICE, TO MAKE SUCH INSPECTIONS.

REPORTS OF ALL INSPECTIONS OF MATERIALS AND REQUIRED TESTS SHALL BE FILED WITH THE OWNER WITH A SIGNED STATEMENT BY THE PERSON DESIGNATED FOR SUCH INSPECTION BEFORE FINAL PAYMENT.

INSPECTIONS INCLUDE BUT SHALL NOT BE LIMITED TO:

A. SUB SOIL TEST

- B. INSPECTION OF SUB-GRADE PRIOR TO INSTALLATION OF ANY FOOTINGS.
- C. PLACEMENT OF CONCRETE MATERIALS FOR STRUCTURAL ELEMENTS
- D. FOUNDATIONS
- E. STRUCTURAL STEEL
- F. LIGHT GAUGE METAL FRAMING
- G. FIRE STOPPING FOR PENETRATIONS

H. ELECTRICAL, PLUMBING AND MECHANICAL.

30.FINAL INSPECTION:

WHEN, IN THE OPINION OF THE CONTRACTOR, THE WORK IS COMPLETED AND READY FOR FINAL INSPECTION, HE SHALL NOTIFY THE OWNER AND BUILDING DEPARTMENT OFFICIAL AND THE OWNER EITHER IN PERSON OR BY A DESIGNATED REPRESENTATIVE, WILL INSPECT THE WORK. BEFORE A CERTIFICATE OF FINAL COMPLETION WILL BE ISSUED BY THE OWNER AND BUILDING DEPARTMENT OFFICIALS, ANY DEFECTS OR OMISSIONS NOTED ON THIS INSPECTION MUST BE MADE GOOD BY THE CONTRACTOR.

31.<u>SURVEYS:</u>

FINAL SURVEY - AN ACCURATE AND COMPLETE PROPERTY SURVEY, MADE AND SEALED BY A PROFESSIONAL LICENSED LAND SURVEYOR, MAY BE REQUIRED. AFTER COMPLETION OF ALL WORK, THIS SURVEY MAY BE REQUIRED TO SHOW LOCATION OF NEW WORK, ELEVATION OF FLOOR LEVELS, ELEVATIONS OF FINISHED GRADES AND ELEVATIONS AT PROPERTY LINE INTERSECTIONS, LOCATION AND BOUNDARIES OF THE LOT, AND ALL BUILDINGS. IF MUNICIPAL OR OTHER AGENCIES REQUIRE SUCH A SURVEY, IT SHALL BE ORDERED BY THE CONTRACTOR AND PAID FOR BY THE OWNER.

THE CONTRACTOR SHALL PROTECT AREAS ADJACENT TO THE WORK AND SHALL BE RESPONSIBLE FOR ANY DAMAGE CAUSED DURING THE PERFORMANCE OF THE WORK. THE CONTRACTOR SHALL MAINTAIN THE JOB SITE AND BUILDING IN A NEAT, CLEAN AND SAFE CONDITION AND SHALL, AT COMPLETION OF THE JOB, TURN OVER THE SITE AND BUILDING TO THE OWNERS IN A CONDITION SUITABLE TO MOVE IN, ALL SURFACES SHALL BE CLEAN AND READY FOR FURNISHING.

THE CONTRACTOR SHALL BE RESPONSIBLE FOR THE SAFE MAINTENANCE OF THE BUILDING AND ITS FACILITIES AND IS RESPONSIBLE FOR CONSTRUCTING THE WORK ACCORDING TO PLANS AND SPECIFICATIONS.

THE CONTRACTOR SHALL CHECK AND VERIFY ALL DIMENSIONS, CONDITIONS, NOTES, WORK, ETC. AT THE JOB SITE BEFORE ANY WORK IS STARTED, BE RESPONSIBLE FOR SAME AND REPORT ANY AND ALL DISCREPANCIES TO THE ARCHITECT BEFORE WORK IS STARTED WITH AMPLE TIME FOR CHANGES TO BE MADE.

ALL PLANS ARE REQUIRED TO HAVE THE APPROVAL OF THE MUNICIPAL AUTHORITIES AND OTHER AGENCIES. THE PLANS ARE SUBJECT TO REVIEW AND COMMENT PRIOR TO COMMENCEMENT OF CONSTRUCTION. THE ARCHITECT WILL SUPPLY THREE (3) COPIES OF SIGNED AND SEALED SETS OF PLANS FOR THE CONTRACTOR TO PRESENT TO MUNICIPAL AUTHORITIES. NO WORK IS TO BE DONE UNTIL A BUILDING PERMIT IS OBTAINED.

32. CHANGES TO THE BUILDING DESIGN:

NO CHANGES ARE TO BE MADE TO THE BUILDING WHICH DEVIATE FROM THESE GENERAL CONDITIONS, TECHNICAL NOTES OR CONSTRUCTION DOCUMENTS, WITHOUT THE PRIOR APPROVAL OF THE ARCHITECT. IF THE CONTRACTOR OR OWNER PROCEED WITH ANY CHANGES WITHOUT PRIOR APPROVAL BY THE ARCHITECT THEY WILL DO SO AT THEIR OWN RISK AND SUCH CHANGES MAY REQUIRE REMOVAL.

33.WORK INCLUDED:

THE CONTRACTOR SHALL FURNISH ALL LABOR, MATERIALS AND EQUIPMENT REQUIRED TO COMPLETE ALL WORK DESCRIBED WITHIN THE CONSTRUCTION DOCUMENTS.

LEGEND 1 / A101 🚤 DRAWING REFERENCE SECTION DRAWING NOTATION SHEET NUMBER SECTION TAIL DRAWING NUMBER SECTION DIRECTION INDICATOR **ENLARGED DRAWING CALLOUT** SIMILAR OR TYPICAL INDICATOR - ROOM NOTATION ROOM NUMBER DRAWING NUMBER **ROOM AREA & OTHER** SHEET NUMBER ADDTITIONAL INFORMATION DRAWING REFERENCE - ELEVATION MARK **ELEVATION INDICATOR** - DRAWING REVISION NOTATION DRAWING NUMBER SHEET NUMBER REVISED AREA CLOUD

ABBREVIATIONS FLOOR DRAIN UNDERCUT DIAG. DIAGONAL F.D. JSTS. JOISTS P.T. PRESSURE TREATED U.C. ACOUSTICAL CLG. TILE DEMO. DEMOLITION UNFINISHED PTD. PAINTED DET. PART. UNLESS OTHERWISE NOTED U.O.N. F.A.C.P. FIRE ALARM CONTROL PANEL L.P. LOW POINT PARTITION ADJACENT DETAIL D.F. A.F.F. ABOVE FINISH FLOOR DRINKING FOUNTAIN F.A.R.P. FIRE ALARM REMOTE PANEL PLATE VINYL COMPOSITION TILE ALUM. ALUMINUM DIA. DIAMETER FAST. **FASTENED** MAR. MARBLE PLASTIC LAMINATE V.C.T. ANG. DIM. MAX. DIMENSION FIREPROOF MAXIMUM PLYWD. PLYWOOD **VESTIBULE** ANGI F APPROX. APPROXIMATELY DN. F.P.S.C. FIREPROOF SELF-CLOSING MECHANICAL VEST. VERIFY IN FIELD DOWN A.S.M.L. ABOVE MEAN SEA LEVEL DOOR FLOOR MANUFACTURER REINFORCEMENT V.I.F. D.O DITTO FIRE RATED REQD. WOOD MIN MINIMIM REQUIRED BLOCKING DWG. DRAWING FRM FRAME MISC **MISCELLANEOUS** WD. WITH BOARD FLUOR. FLUORESCENT M.O. MASONRY OPENING SIM. W/ WITHOUT BLDG. BUILDING EA. **EACH SPECIFICATIONS** W/O FEET MTL. **METAL** SPEC. ELEC. **ELECTRICA** SQUARE FEET B.O. **BOTTOM OF** ELEV. NOM. **ELEVATOR** GALV. **GALVANIZED** NOMINAL S.S. SOLID SURFACE ST. STL. STAINLESS STEEL **ELEVATION** NORTH EL. GAUGE N. CLG. GENERAL CONTRACTOR CEILING **EQUIP EQUIPMENT** NON-CORROSIVE STL. STEEL CENTER LINE EXIST. STRUCT. STRUCTURAL **EXISTING** N.I.C. NOT IN CONTRACT GLAZ. GLAZING GYPSUM WALL BOARD CONC. CONCRETE EQ. **EQUAL** G.W.B. N.T.E. NOT TO EXCEED SUSP. SUSPENDED CONST. EXTERIOR INSULATION FINISH CONSTRUCTION E.I.F.S. GYP. **GYPSUM** N.T.S. NOT TO SCALE CONT. NO. T&S TAPE & SPACKLE CONTINUOUS SYSTEM NUMBER C.M.U. CONCRETE MASONRY UNIT TEL. TELEPHONE THK. O.C. HEIGHT ON CENTER THICK **HOLLOW METAL** OPENING T.O. TOP OF OPNG OPPOSITE TYP. TYPICAL ORIENTED STRAND BD. INSUL. INSULATION OSB

Colliers

Engineering

www.colliersengineering.com ere contracted or to whom it is certified. This drawing may not be copied, reused, disclosed distributed or relied upon for any other purpose without the express written consent of

JAM ARCH

Architecture, Surveying, CT P.C.

REV DATE

APPROVED MASTER PLAN

Town of Knightdale

Development Services

Gideon Smith 11/13/2025

DESCRIPTION 07/07/2025 PROGRESS SET

Michelle Simms

LEARNING CARE GROUP

OLD KNIGHT RD. & HORTON KNIGHTDALE, NC 27545

> NC ARCHITECTURE FIRM LICENSE # 54174

NOT FOR CONSTRUCTION **Project Kick Off** SUBMISSION

WOODCLIFF LAKE 300 Tice Blvd. Ste 10 Colliers Woodcliff Lake, NJ 07677 Phone: 845.352.0411 Engineerin Colliers Engineering & Design, & Design Architecture, Landscape Architectur Surveying, CT P.C. Architecture, Landscap Architecture, Surveying, CT PROJECT MANAGER: DISCIPLINE LEAD: DESIGNER: REVIEWER: DR

07/07/2025

DRAWING NUMBER:

GENERAL CONDITIONS & RESPONSIBILITY MATRIX


SO

CJC

25002372A

PROJECT NUMBER:

G002

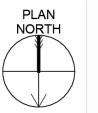



GENERAL NOTES:

SEE DWG. G001 FOR LIST OF DRAWINGS AND BUILDING CODE NOTES. SEE DWG. G002 FOR GENERAL CONDITIONS.

SEE DWG. G003 FOR RESPONSIBLITY MATRIX. SEE DWG. G005-G006 FOR ACCESSIBILITY DETAILS. SEE DWG. G101 FOR LIFE SAFETY PLAN AND LIFE SAFETY CODE NOTES. SEE DWG. A101 FOR CONSTRUCTION FLOOR PLAN.

SEE DWG. A701 FOR PLAYGROUND PLAN.



Engineering & Design

Architecture, Landscape Architecture, Surveying, CT P.C.

www.colliersengineering.com

Copyright © 2024. Colliers Engineering & Design All Rights Reserved. This drawing and all the information contained herein is authorized for use only by the party for whom the services were contracted or to whom it is certified. This drawing may not be copied, reused, disclosed, distributed or relied upon for any other purpose without the express written consent of

JAM ARCH Formerly Known as

REV DATE DESCRIPTION 07/07/2025 PROGRESS SET

APPROVED MASTER PLAN Town of Knightdale Development Services Gideon Smith 11/13/2025



Michelle Simms

LEARNING CARE GROUP

OLD KNIGHT RD. & HORTON KNIGHTDALE, NC 27545

NC ARCHITECTURE FIRM LICENSE # 54174

NOT FOR CONSTRUCTION Project Kick Off SUBMISSION

Colliers

Engineering & Design

Architecture, Landscape Architecture, Surveying, CT P.C PROJECT MANAGER:

DESIGNER:

07/07/2025

WOODCLIFF LAKE 300 Tice Blvd, Ste 101

Woodcliff Lake, NJ 07677 Phone: 845.352.0411

Colliers Engineering & Design, Architecture, Landscape Architecture, Surveying, CT P.C.

DISCIPLINE LEAD:

PROJECT NUMBER:

REVIEWER:

SO

CJC

25002372A

TDADND
LECTENT)
LEGEND

AREA BOUNDARY LINE

ROOM NAME AGE DESCRIPTION ACTUAL S.F. REQUIRED MINIMUM AREA

NO. OF STAFF

MINIMUM - MAXIMUM AGE

ROOM LICENSING TAG TEACHER : CHILD RATIO NO. OF CHILDREN

LICENSING PLAN, CHILDCARE LICENSING SCHEDULE & NOTES

G102

DRAWING NUMBER:

NORTH CAROLINA CHILDCARE LICENSING							
AGE RANGE	DESIGNATION	MAX GROUP	TEACHER TO CHILD RATIO	AREA PER CHILD			
0 MO TO 12 MO	INFANT	10	1 TO 5	25 SF			
1 YR TO 2 YR	TODDLER	12	1 TO 6	25 SF			
2 YR TO 3 YR	TODDLEN	20	1 TO 10	25 SF			
3 YR TO 4 YR		25 1 TO 1		25 SF			
4 YR TO 5 YR	PRESCHOOL (IF NOT ENROLLED IN SCHOOL)	25	1 TO 20	25 SF			
5 YR +	Thirdeles in concept	25	1 TO 25	25 SF			
	OUTDOOR PLAY AREA		M	75 SF			

CHILDCARE LICENSING								
ROOM	ACTUAL	REQUIRED	AGE RANGE	DESIGNATION	TEACHER TO CHILD RATIO	AREA PER CHILD	# OF CHILDREN	# OF STAFF
OFFICE	120 SF				•			2
LOBBY	282 SF						l [1
STAFF LOUNGE	104 SF						l [0
KITÇHEN	363 SF							1
DAYCARE #1	436 SF	400 SF	BIRTH to 12 MO	INFANT	1 to 4	50 SF	8	.2
DAYCARE #2	434 SF	400 SF	BIRTH to 12 MO	INFANT	1 to 4	50 SF	8	2
DAYCARE #3	444 SF	360 SF	12 MO to 24 MO	TODDLER	1 to 6	30 SF	12	2
DAYCARE #4	429 SF	360 SF	12 MO to 24 MO	TODDLER	1 to 6	30 SF	12	.2
DAYCARE #5	544 SF	540 SF	2 YR to 3 YR	TWO'S	1 to 9	30 SF	18	.2
DAYCARE #6	534 SF	510 SF	#	MULTI-PURPOSE	EE .	30 SF	#	
DAYCARE #7	623 SF	540 SF	2 YR to 3 YR	EARLY PRESCHOOL	1 to 9	30 SF	18	2
DAYCARE #8	868 SF	750 SF	5 YR to	SCHOOL AGE	1 to 15	30 SF	25	2
DAYCARE #9	984 SF	750 SF	4 YR to 5 YR	PRE-K	1 to 13	30 SF	25	2
DAYCARE #10	779 SF	600 SF	3 YR to 4 YR	PRESCHOOL	1 to 10	30 SF	20	2
	6944 SF	5210 SF					146	22