OLD FAISON PLACE

OLD FASION RD, KNIGHTDALE, WAKE COUNTY, NC 27545

OWNER

ASHBURY & THE HOLDING COMPANY L.L.C. RALEIGH, NC

PO BOX 90427 RALEIGH, NC 27675-0427 (919) 741-7993

Contact: TOM QUACKENBUSH TOM@GLENWOODHOMES.COM


CIVIL ENGINEER

Rivers & Associates, Inc.
Raleigh, NC

353 E. Six Forks Rd. Raleigh, NC 27609 (919) 594-1626


Contact: Stephen Ballentine, PE

sballentine@riversandassociates.com

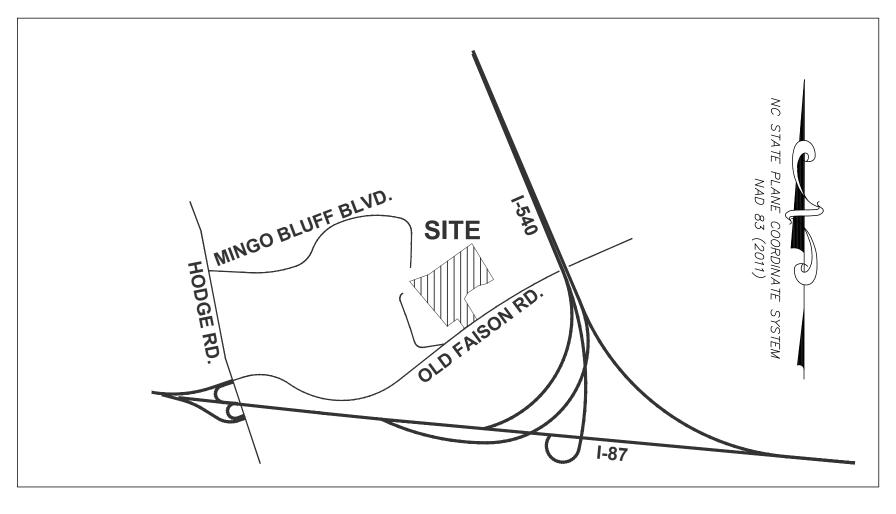


VICINITY MAP
N.T.S.

Sheet List Table	
Sheet Number	Sheet Title
C-1	Cover Sheet
S-1	Existing Conditions
S-2	Sketch Plan
S-3	Stormwater Flow

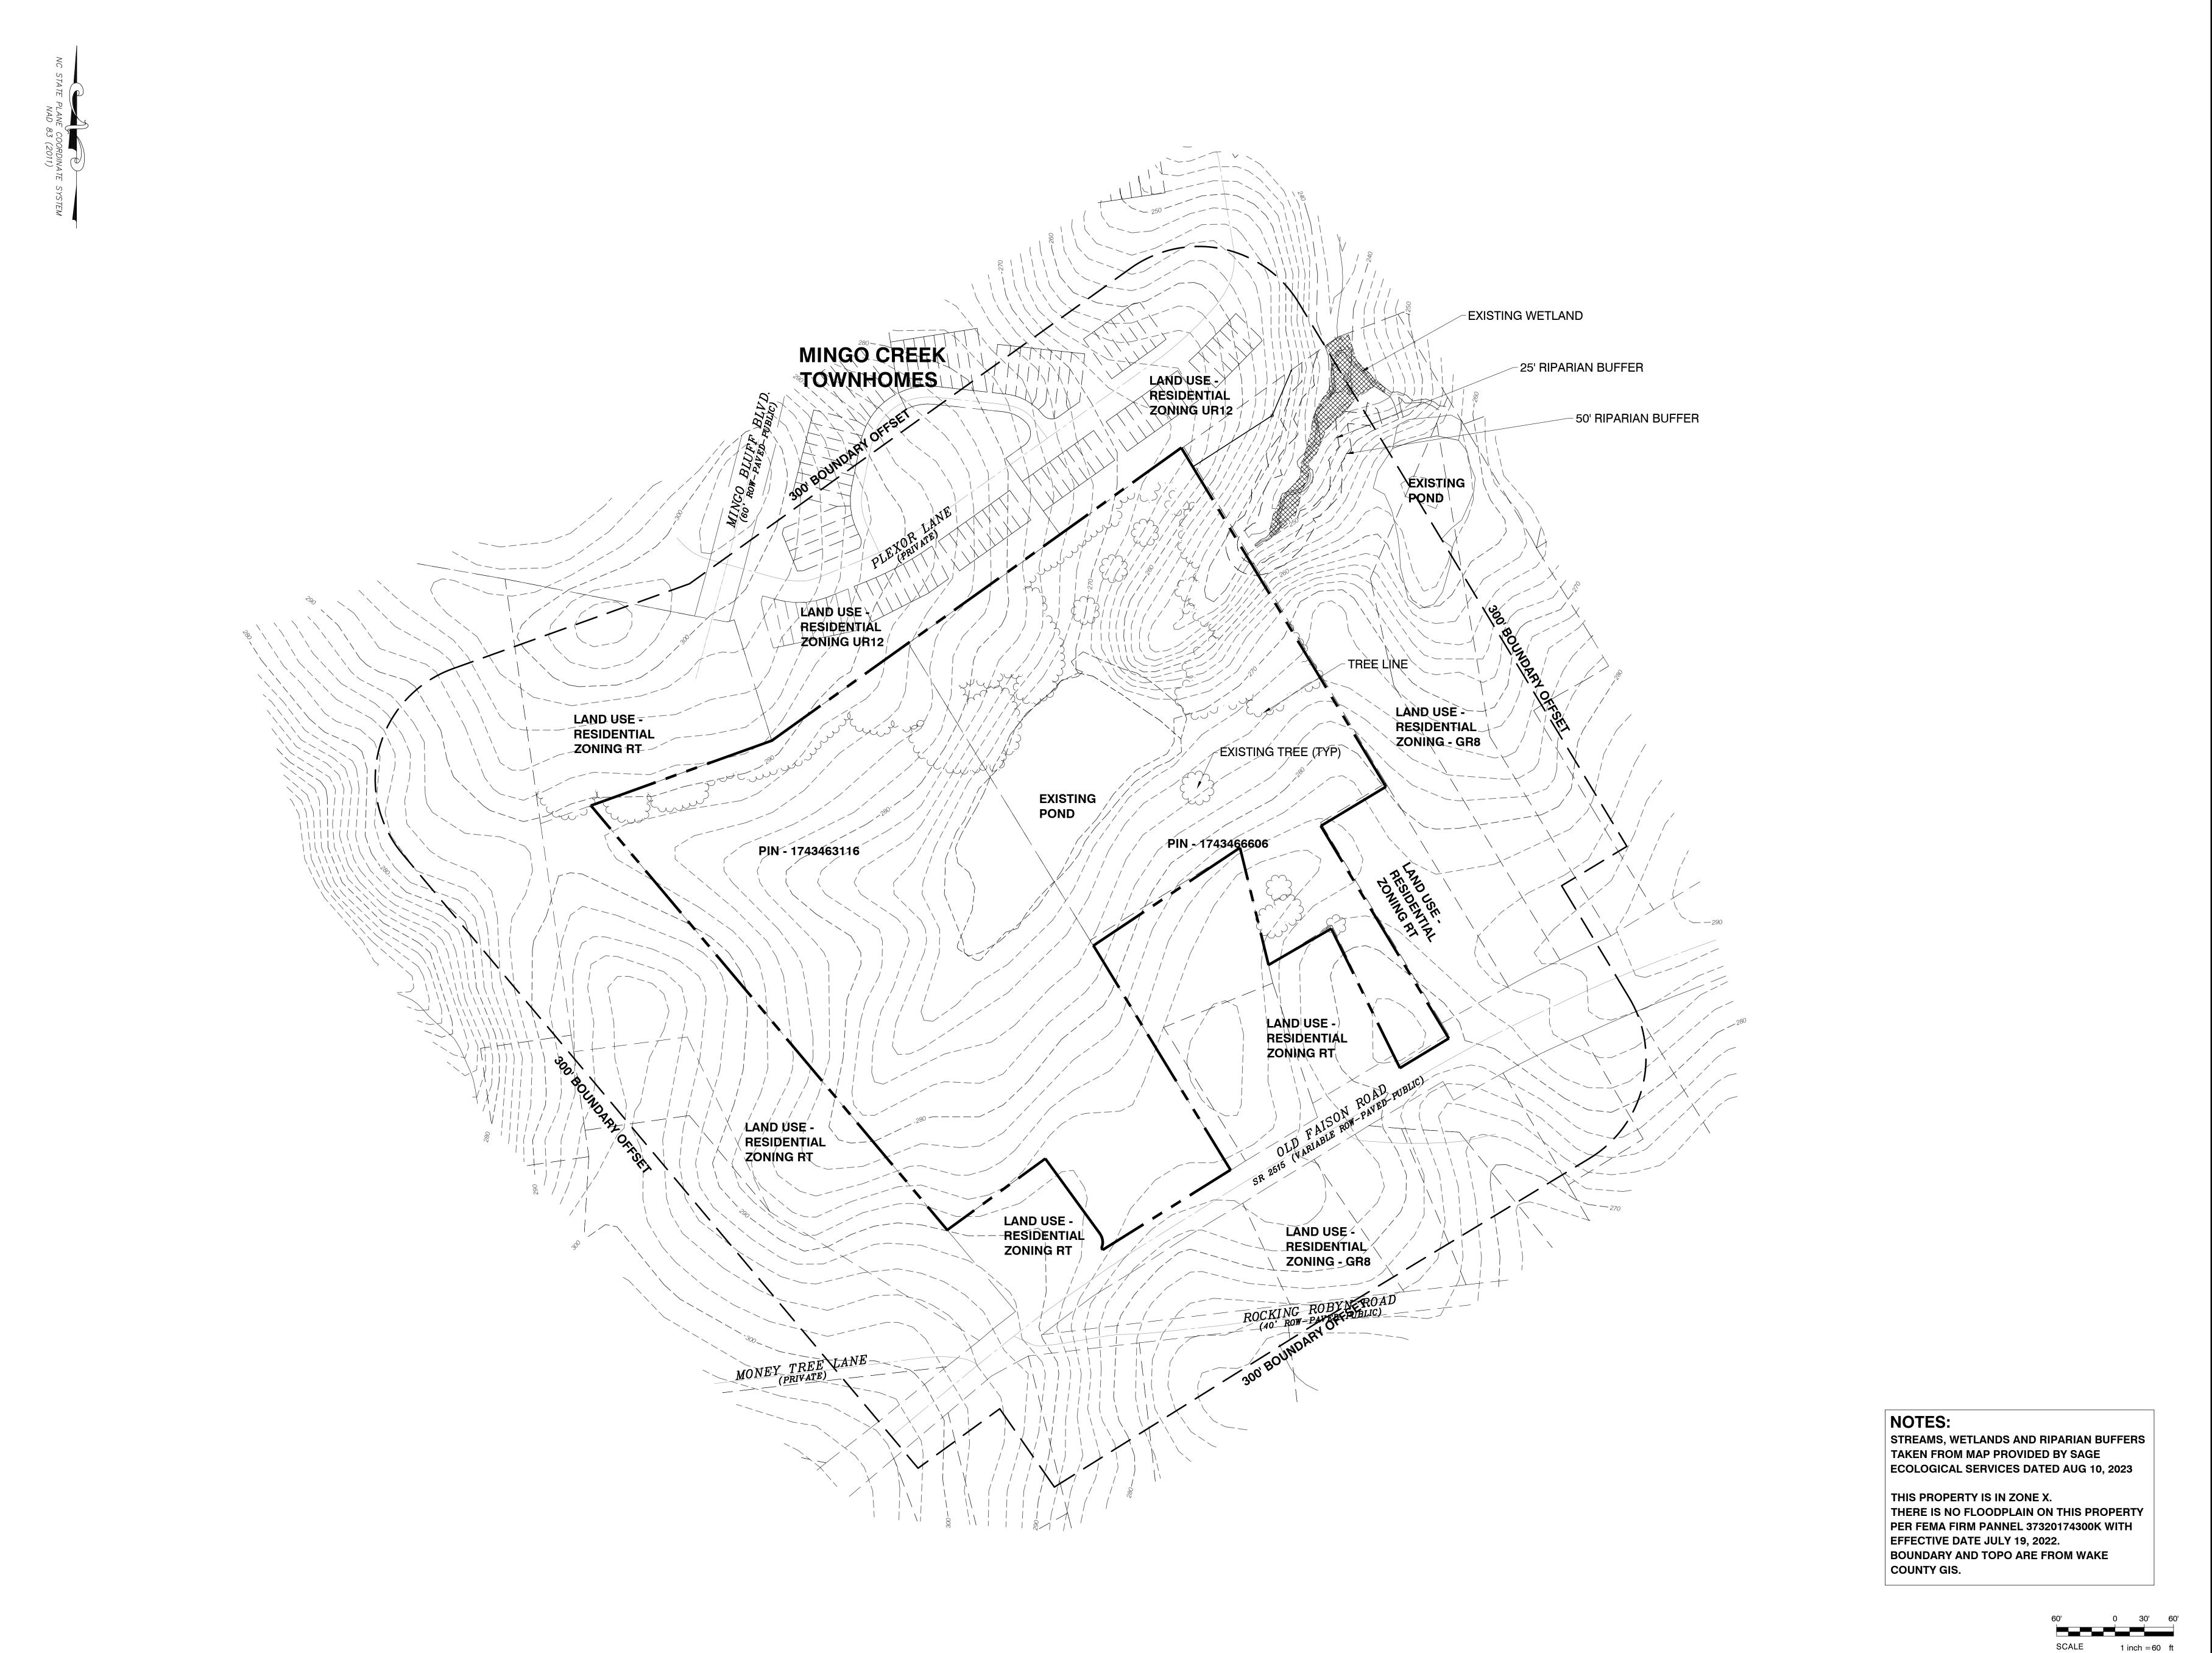

REVISIONS:

DESIGNED BY: SJB, SBF CHECKED BY: SJB, TRN PROJECT No. **2022113** DRAWING No. W-4104 SCALE: AS SHOWN

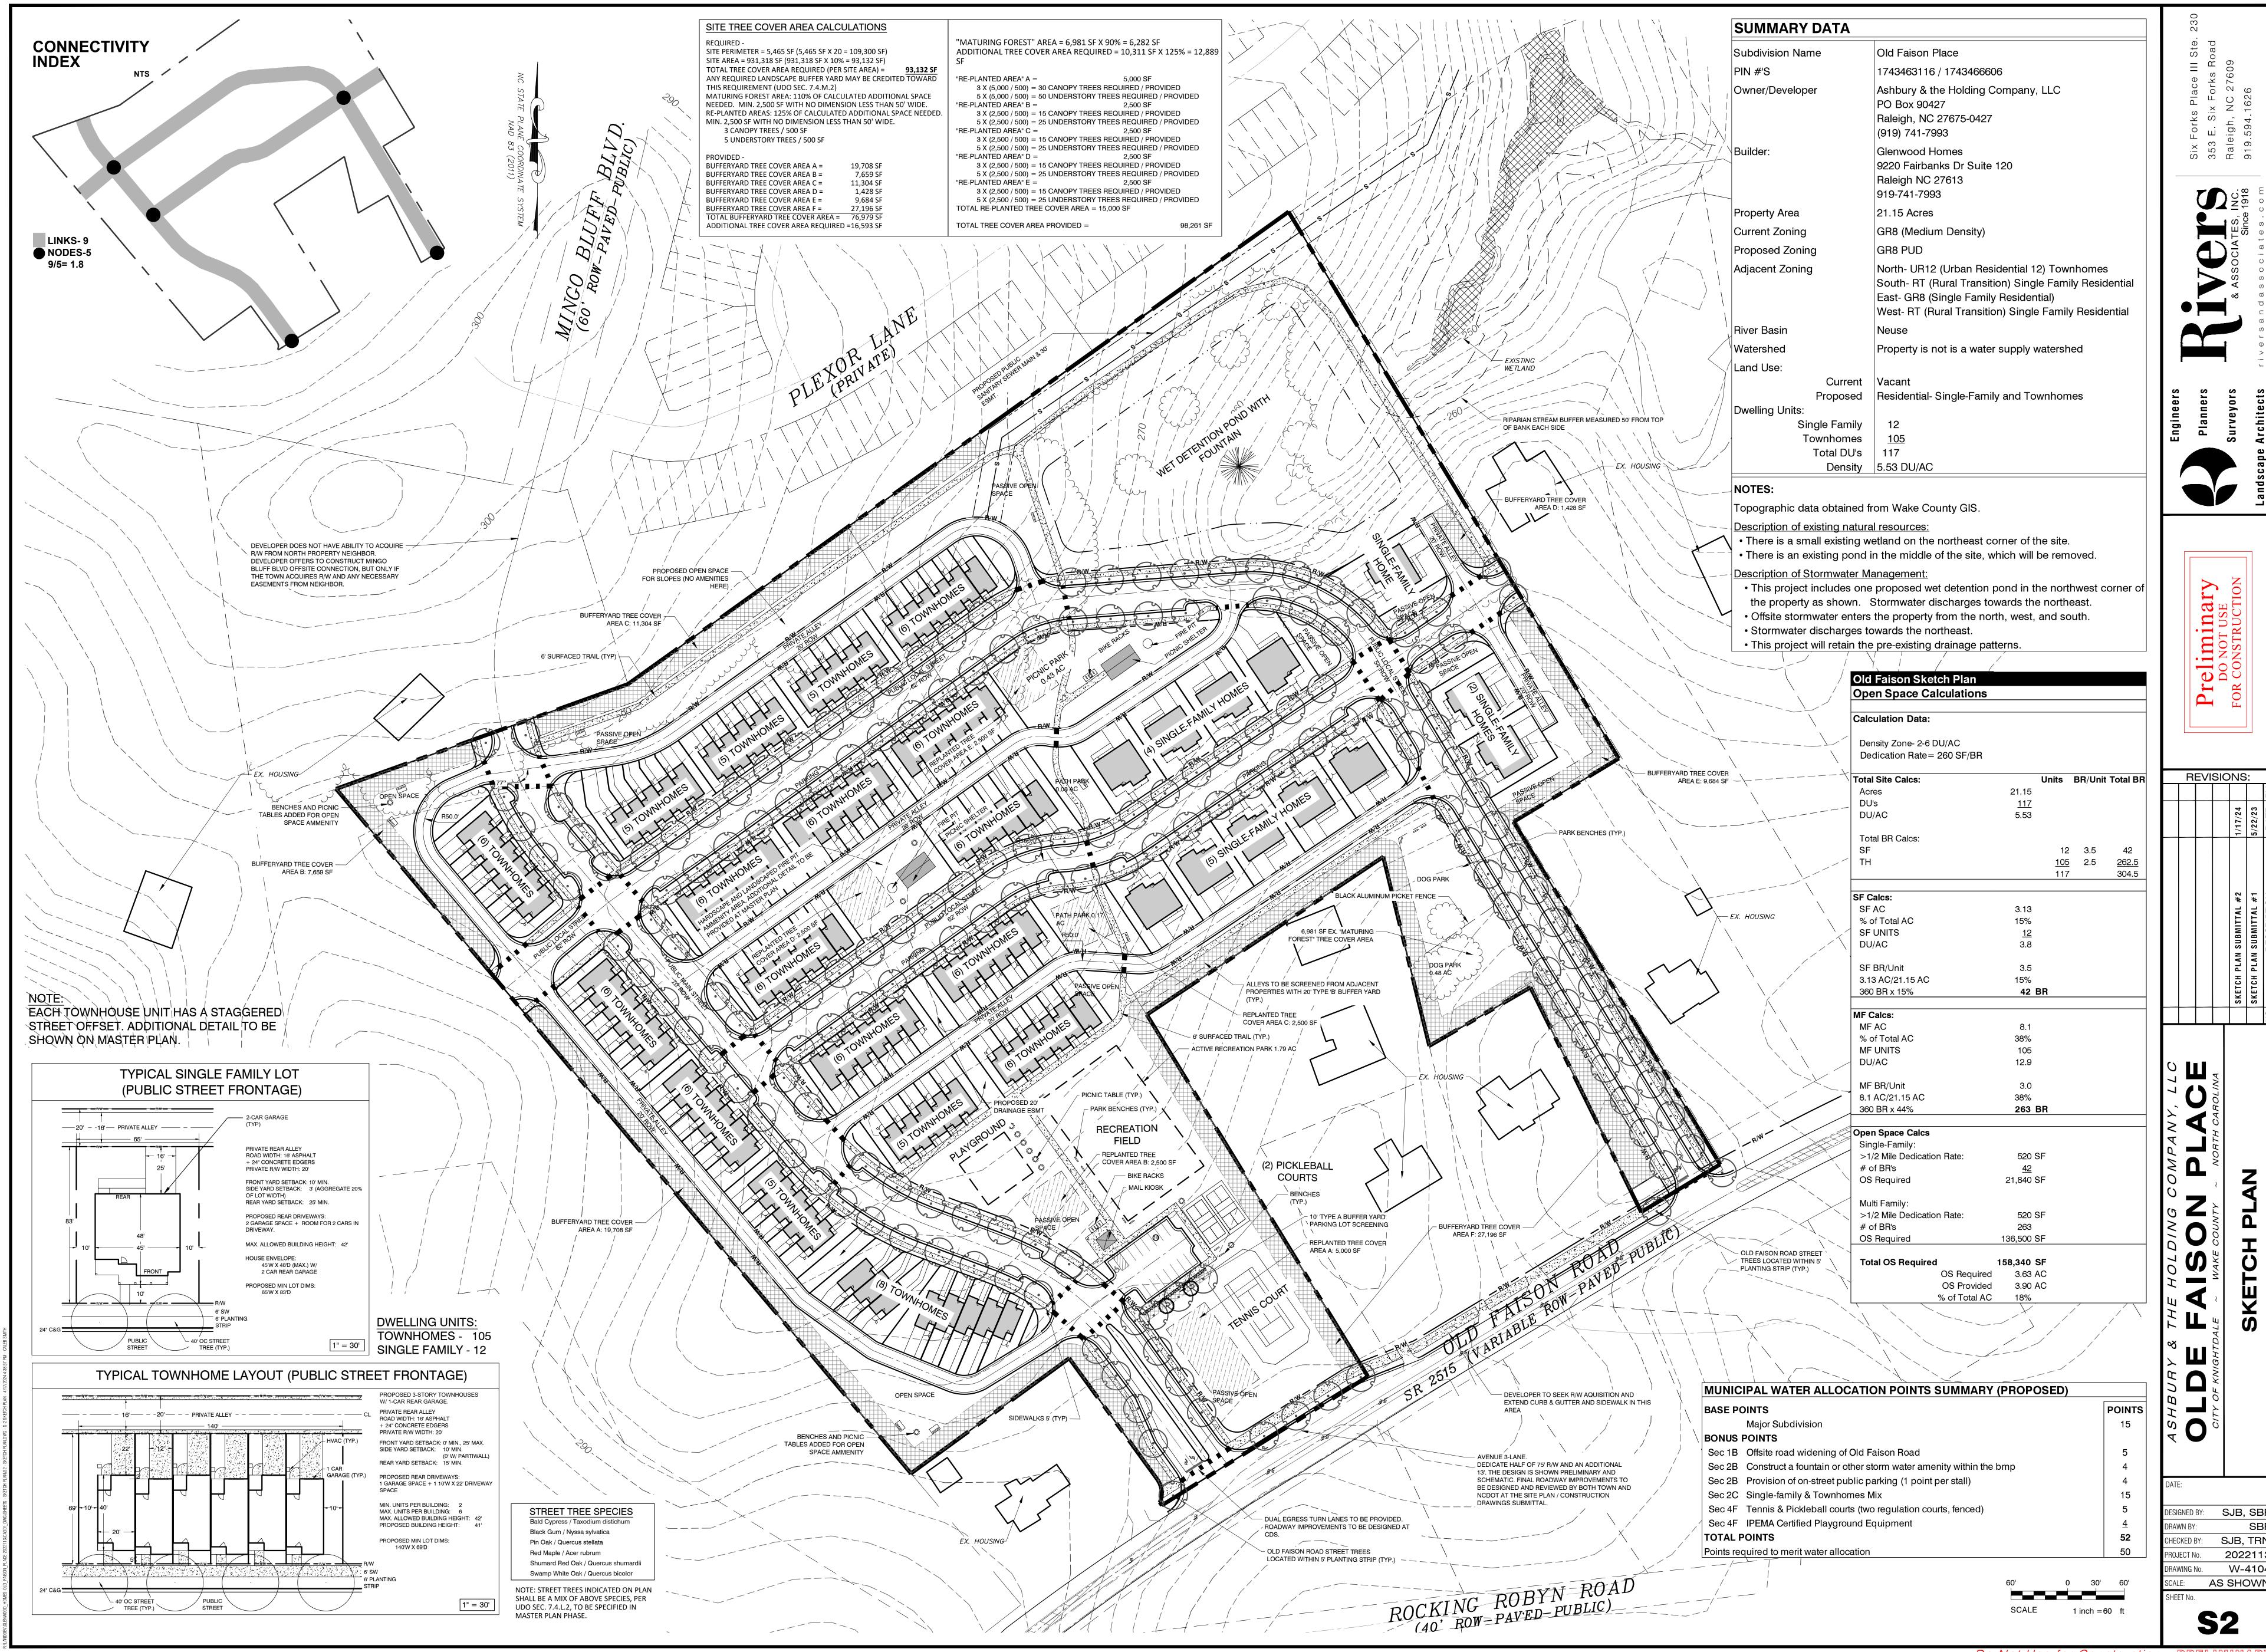

Do Not Use for Construction - PRELIMINARY

ESIGNED BY: SJB, SBF SJB, TRN 2022113 W-4104 AS SHOWN

REVISIONS:

DESIGNED BY: SJB, SBF CHECKED BY: SJB, TRN PROJECT No. **2022113** DRAWING No. VV-4104 SCALE: AS SHOWN

S3

OVERLAND FLOW DIRECTION

ALL STORMWATER CONTROL

SYSTEMS WILL BE DESIGNED AT THE CONSTRUCTION DRAWING SUBMITTAL.



- Elevation Offsets Between Units
- Covered Front Porches
- Recessed Front Doors
- Variety of Window Fenestrations
- Bay Windows & Dormers
- Stone Veneer on Front Elevation
- Fiber Cement Siding
- Mix of Lap and Vertical Siding
- Composite Roof Shingles
- Wrapped Porch Columns
- Blended Siding Color Variations



5-Plex - Front Elevation

20' 3-Story Rear Load Townhomes - Knightdale, NC



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5-Plex - Rear Elevation

20' 3-Story Rear Load Townhomes - Knightdale, NC







5-Plex - Sides Elevations

20' 3-Story Rear Load Townhomes - Knightdale, NC



Proposed Architectural Zoning Conditions – Townhomes

- Dwelling units shall have a variety of siding materials, which will include the following: Fiber cement lap siding, Fiber cement shake, Fiber cement board and batten, Fiber cement smooth panel, Stone veneer, Adhered stone veneer, Brick veneer.
- Dwelling units shall have a variety of siding colors. No adjacent unit shall be painted the same color.
- Dwelling units shall have architectural style roof shingles.
- Dwelling unit roofs shall have a minimum main roof pitch of 5:12. Forward facing Gables shall be between 8:12-14:12 roof pitch. Accent and porch roofs shall be between 3:12-6:12 pitch. Accent elements consisting of Gable dormers, shed dormers are to be utilized when consistent with the style of the home.
- Metal accent roofs are encouraged.
- Dwelling units shall have front covered porches, min 4' deep x 4' wide.
- Dwelling units shall have 18% of glazing on the front.
- Dwelling units shall have rear loaded garages.
- Adjacent townhouse units shall have staggered setbacks as shown on the plan.
- Townhomes shall be a minimum of 19'-8" wide and a minimum of 1500 heated square feet.
- Roof eave overhang shall be a minimum of 12", Tight rake overhangs are permitted on porches and main roofs between townhome units. 12" min. rake overhangs on end unit exposed elevation.
- 18" minimum raised foundation (finished floor to average grade) brick or adhered stone face.



- Covered Front Porches
- Variety of Window Fenestrations
- Dormers

- Brick Veneer on Front Elevation
- Mix of Lap & Board &Batten Siding
- Composite Roof Shingles
- Wrapped Porch Columns w/Brackets



Denmark '1' - Front Elevation Knightdale, NC

11.10.2023





- Covered Front Porches
- Wrapped Porch Columns
- Variety of Window Fenestrations
- Brick Veneer on Front Elevation
- Mix of Lap & Board &Batten Siding
- 12/12 Roof Pitch-Front Gables

Composite Roof Shingles



Denmark '2' - Front Elevation

Knightdale, NC

11.10.2023



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e drawings presented are illustrative of character and design intent only, and a subject to change based upon final design considerations (i.e. applicable code structural, and MEP design requirements, unit plan / floor plan changes, etc © 2023 gmodesignarupy carolinas, in



- Covered Front Porches
- Porch Columns with Trim Details
- Variety of Window Fenestrations
- Brick Veneer on Front Elevation
- Mix of Lap/Shingle/Board &Batten Siding12/14 Roof Pitch-Front Gables

• Composite Roof Shingles



Denmark '3' - Front Elevation

Knightdale, NC

11.10.2023





- Covered Front Porches
- Tapered Porch Columns
- Variety of Window Fenestrations
- Stone Veneer on Front Elevation
- Mix of Lap/Shingle/Board &Batten Siding
- 12/12 Roof Pitch-Front Gables

Composite Roof Shingles



Denmark '4' - Front Elevation

Knightdale, NC

11.10.2023



carolinas, inc. 2023 d ore illustrative of character and design intent only, a based upon final design considerations (i.e. applicable

Proposed Architectural Zoning Conditions - Single Family

- Dwelling units shall have a variety of siding materials, which will include the following: Fiber cement lap siding, Fiber cement shake, Fiber cement board and batten, Fiber cement smooth panel, Stone veneer, Adhered stone veneer, Brick veneer.
- Dwelling units shall have a variety of siding colors. No adjacent unit shall be painted the same color.
- Dwelling units shall have architectural style roof shingles.
- Dwelling unit roofs shall have a minimum main roof pitch of 5:12. Forward facing Gables shall be between 8:12-14:12 roof pitch. Accent and porch roofs shall be between 3:12-6:12 pitch. Accent elements consisting of Gable dormers, shed dormers are to be utilized when consistent with the style of the home.
- Metal accent roofs are encouraged.
- Dwelling units shall have front covered porches, min 4' deep x 4' wide.
- Dwelling units shall have 18% of glazing on the front.
- Dwelling units shall have rear loaded garages.
- Adjacent townhouse units shall have staggered setbacks as shown on the plan.
- Townhomes shall be a minimum of 19'-8" wide and a minimum of 1500 heated square feet.
- Single Family Detached homes shall have a minimum of 1500 heated square feet
- Roof eave overhang shall be a minimum of 12", Tight rake overhangs are permitted on porches and main roofs between townhome units. 12" min. rake overhangs on end unit exposed elevation.
- 18" minimum raised foundation (finished floor to average grade) brick or adhered stone face.