MASTER PLAN REVIEW

KNIGHTDALE DAYCARE (ZCP-3-25)

0 JASMINE VIEW WAY KNIGHTDALE, NORTH CAROLINA 27545 WAKE COUNTY

OWNER/DEVELOPER:

HAYWOOD GLEN INVESTMENTS LLC MICHELLE SIMMS-REITER AND PABLO REITER MICHELLE@PRMSINV.COM 919-796-6783

CIVIL ENGINEER/ LANDSCAPE ARCHITECT:

TIMMONS GROUP MIKE DAVIDSON 5410 TRINITY ROAD SUITE 102 RALEIGH, NC 27607 MIKE.DAVIDSON@TIMMONS.COM PH: (984) 222-1610

ARCHITECT:

COLLIERS ENGINEERING & DESIGN JONATHAN CREEL 5901 VEGA AVE, SUITE 100 AUSTIN, TX 78735 JONATHAN.CREEL@COLLIERSENG.COM PH: 432.770.3630

SURVEYOR:

MCKIM & CREED KEVIN D. MEDEIROS 4300 EDWARDS MILL ROAD RALEIGH, NC 27612 CSEAMSTER@MCKIMCREED.COM PH: (919) 233-8091

	SITE PLAN SUMMARY					
PROJECT:	KNIGHTDALE DAYCARE					
OWNER:	HAYWOOD GLEN INVESTMENTS LLC					
PROJECT ADDRESSES:	0 JASMINE VIEW WAY, KNIGHTDALE, NORTH CAROLINA 27545					
PIN(S):	1755-84-4894					
JURISDICTION:	TOWN OF KNIGHTDALE					
ZONING:	RMX-PUD					
EXISTING USE:	VACANT					
PROPOSED USE:	DAYCARE					
FLOOD ZONE:	NOT LOCATED IN FLOOD HAZARDS AREA PER FEMA MAP #3720175500K (EFFECTIVE 07/19/2022)					
TOTAL LOT AREA:	1.50 AC.±					
EXISTING IMPERVIOUS SURFACE AREA:	1,555 SF					
PROPOSED IMPERVIOUS SURFACE AREA:	34,691 SF					
PROPOSED DAYCARE BUILDING SQUARE FOOTAGE:	10,235 SF					
REQUIRED BUILDING SETBACKS	FRONT SETBACK (MIN.) - 10' FRONT SETBACK (MAX.) - 30' SIDE SETBACK - 6'					
VEHICULAR PARKING FOR CHILD DAYCARE CENTER WITH MORE THAN SIX (6) PERSONS	MAXIMUM SPACES = 0.35 VEHICULAR SPACES PER PERSON LICENSED CAP. MINIMUM SPACES = $\frac{1}{2}$ MAXIMUM # OF LICENSED CHILDREN = 146 , # OF LICENSED STAFF = 22 , TOTAL = 168 $168 \times 0.35 = 59$ MAXIMUM SPACES $59/2 = 30$ MINIMUM SPACES 39 VEHICULAR PARKING SPACES					
VEHICLE PARKING SUMMARY: PROVIDED	(INCLUDES 1 ADA SPACE THAT IS VAN ACCESSIBLE & SPACES)					



VICINITY MAP SCALE: 1" = 500'

Sheet List Table						
Sheet Number	Sheet Title					
C0.0	COVER SHEET					
C0.1	SURVEY					
C2.0	SITE LAYOUT PLAN					
C3.0	GRADING AND DRAINAGE PLAN					
C3.1	SPOT GRADING PLAN AND STORM TABLES					
C5.0	UTILITY PLAN					
C6.0	LANDSCAPE PLAN					
C6.1	LANDSCAPE NOTES AND DETAILS					
C7.0	NOTES AND DETAILS					
25-0280A	SITE LIGHTING ARRANGEMENT					
PR02	PROPOSED ELEVATIONS					
PR03	PROPOSED FINISHES					
PR04	PROPOSED ELEVATIONS					

PRELIMINARY - NOT RELEASED FOR CONSTRUCTION


ALL CONSTRUCTION TO BE IN ACCORDANCE WITH ALL TOWN OF KNIGHTDALE, WAKE COUNTY, AND NCDOT STANDARDS, SPECIFICATIONS, AND DETAILS


07/07/2025 DRAWN BY

CHECKED BY 1. DAVIDSON AS SHOWN

70434

SHEET NO. C0.0

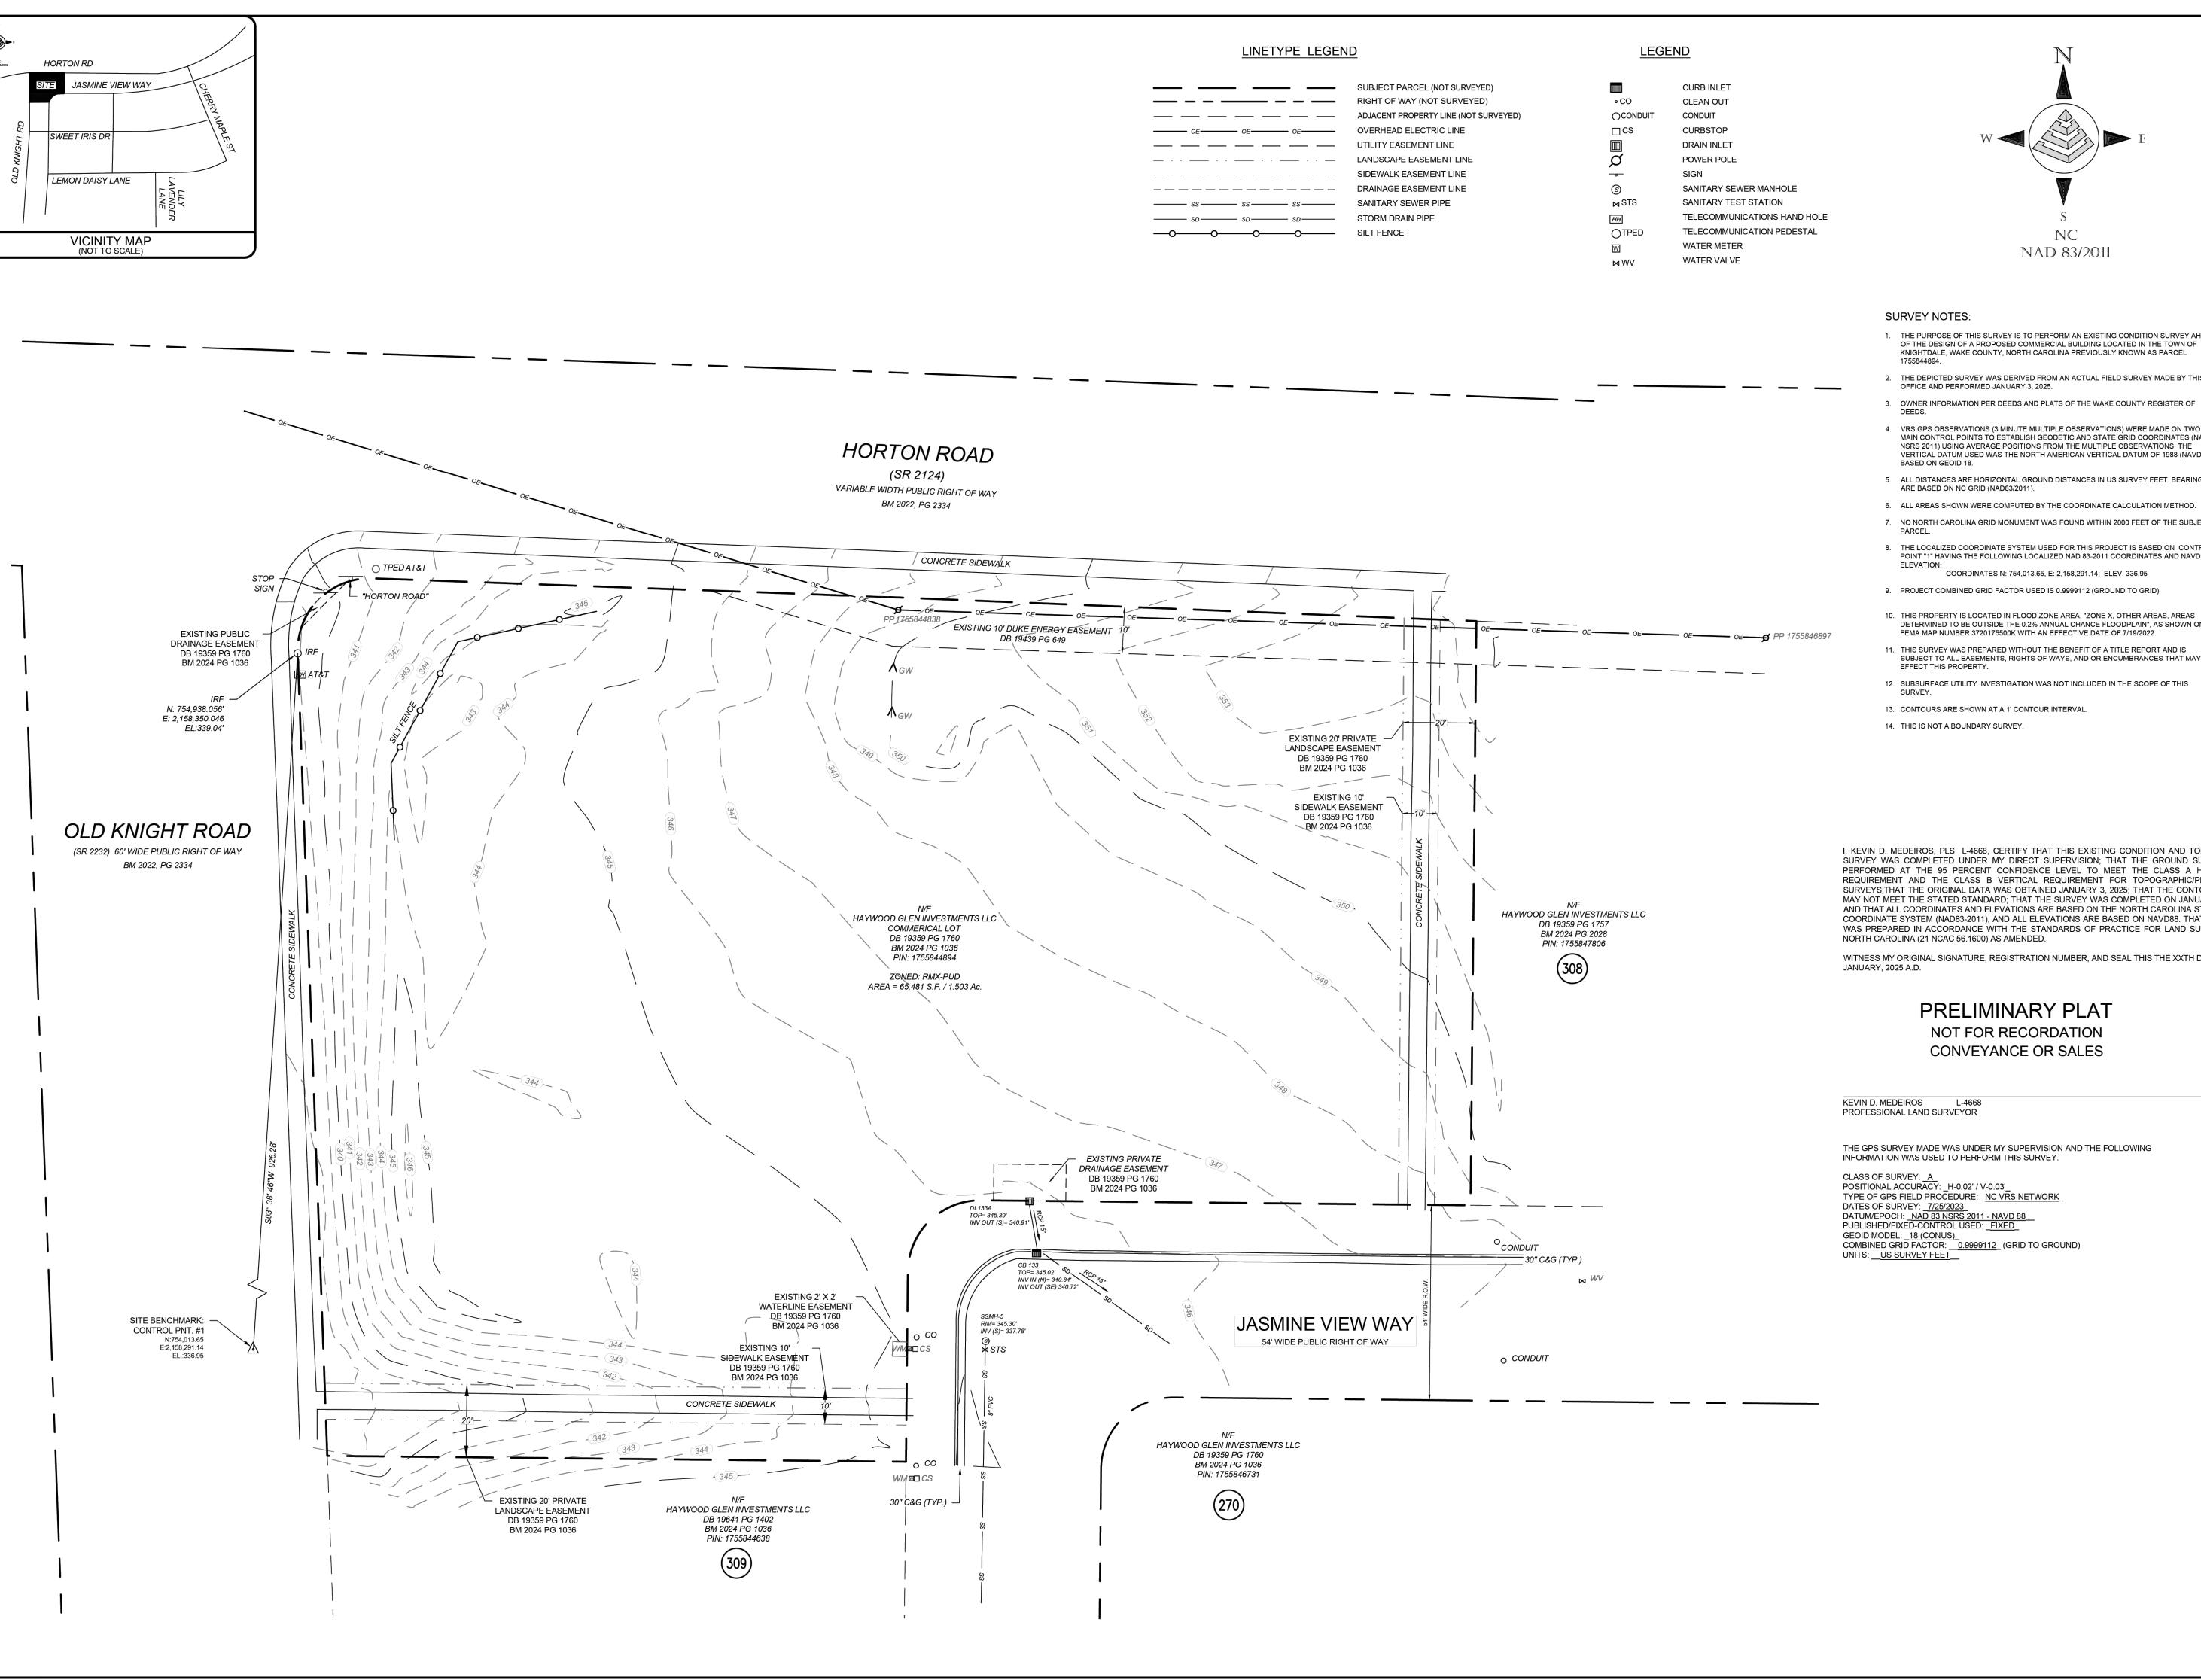

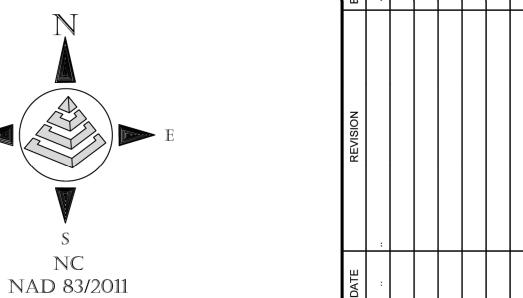

- 1. THE PURPOSE OF THIS SURVEY IS TO PERFORM AN EXISTING CONDITION SURVEY AHEAD OF THE DESIGN OF A PROPOSED COMMERCIAL BUILDING LOCATED IN THE TOWN OF KNIGHTDALE, WAKE COUNTY, NORTH CAROLINA PREVIOUSLY KNOWN AS PARCEL
- 2. THE DEPICTED SURVEY WAS DERIVED FROM AN ACTUAL FIELD SURVEY MADE BY THIS
- 4. VRS GPS OBSERVATIONS (3 MINUTE MULTIPLE OBSERVATIONS) WERE MADE ON TWO (2) MAIN CONTROL POINTS TO ESTABLISH GEODETIC AND STATE GRID COORDINATES (NAD83 NSRS 2011) USING AVERAGE POSITIONS FROM THE MULTIPLE OBSERVATIONS. THE VERTICAL DATUM USED WAS THE NORTH AMERICAN VERTICAL DATUM OF 1988 (NAVD 88)
- 5. ALL DISTANCES ARE HORIZONTAL GROUND DISTANCES IN US SURVEY FEET. BEARINGS
- 6. ALL AREAS SHOWN WERE COMPUTED BY THE COORDINATE CALCULATION METHOD.
- 7. NO NORTH CAROLINA GRID MONUMENT WAS FOUND WITHIN 2000 FEET OF THE SUBJECT
- THE LOCALIZED COORDINATE SYSTEM USED FOR THIS PROJECT IS BASED ON CONTROL POINT "1" HAVING THE FOLLOWING LOCALIZED NAD 83-2011 COORDINATES AND NAVD 88 COORDINATES N: 754,013.65, E: 2,158,291.14; ELEV. 336.95
- 9. PROJECT COMBINED GRID FACTOR USED IS 0.9999112 (GROUND TO GRID)
- 10. THIS PROPERTY IS LOCATED IN FLOOD ZONE AREA, "ZONE X, OTHER AREAS, AREAS DETERMINED TO BE OUTSIDE THE 0.2% ANNUAL CHANCE FLOODPLAIN", AS SHOWN ON FEMA MAP NUMBER 3720175500K WITH AN EFFECTIVE DATE OF 7/19/2022.
- 11. THIS SURVEY WAS PREPARED WITHOUT THE BENEFIT OF A TITLE REPORT AND IS SUBJECT TO ALL EASEMENTS, RIGHTS OF WAYS, AND OR ENCUMBRANCES THAT MAY
- 12. SUBSURFACE UTILITY INVESTIGATION WAS NOT INCLUDED IN THE SCOPE OF THIS

I, KEVIN D. MEDEIROS, PLS L-4668, CERTIFY THAT THIS EXISTING CONDITION AND TOPOGRAPHIC SURVEY WAS COMPLETED UNDER MY DIRECT SUPERVISION; THAT THE GROUND SURVEY WAS PERFORMED AT THE 95 PERCENT CONFIDENCE LEVEL TO MEET THE CLASS A HORIZONTAL REQUIREMENT AND THE CLASS B VERTICAL REQUIREMENT FOR TOPOGRAPHIC/PLANIMETRIC SURVEYS:THAT THE ORIGINAL DATA WAS OBTAINED JANUARY 3, 2025; THAT THE CONTOURS LINES MAY NOT MEET THE STATED STANDARD; THAT THE SURVEY WAS COMPLETED ON JANUARY 3, 2025; AND THAT ALL COORDINATES AND ELEVATIONS ARE BASED ON THE NORTH CAROLINA STATE PLANE COORDINATE SYSTEM (NAD83-2011), AND ALL ELEVATIONS ARE BASED ON NAVD88. THAT THIS PLAT WAS PREPARED IN ACCORDANCE WITH THE STANDARDS OF PRACTICE FOR LAND SURVEYING IN

WITNESS MY ORIGINAL SIGNATURE, REGISTRATION NUMBER, AND SEAL THIS THE XXTH DAY OF


PRELIMINARY PLAT NOT FOR RECORDATION CONVEYANCE OR SALES


THE GPS SURVEY MADE WAS UNDER MY SUPERVISION AND THE FOLLOWING

TYPE OF GPS FIELD PROCEDURE: NC VRS NETWORK GEOID MODEL: _18 (CONUS)

COMBINED GRID FACTOR: __0.9999112_ (GRID TO GROUND)

UNITS: __US SURVEY FEET__

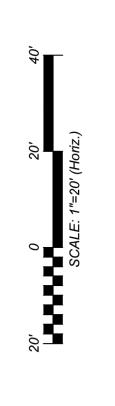

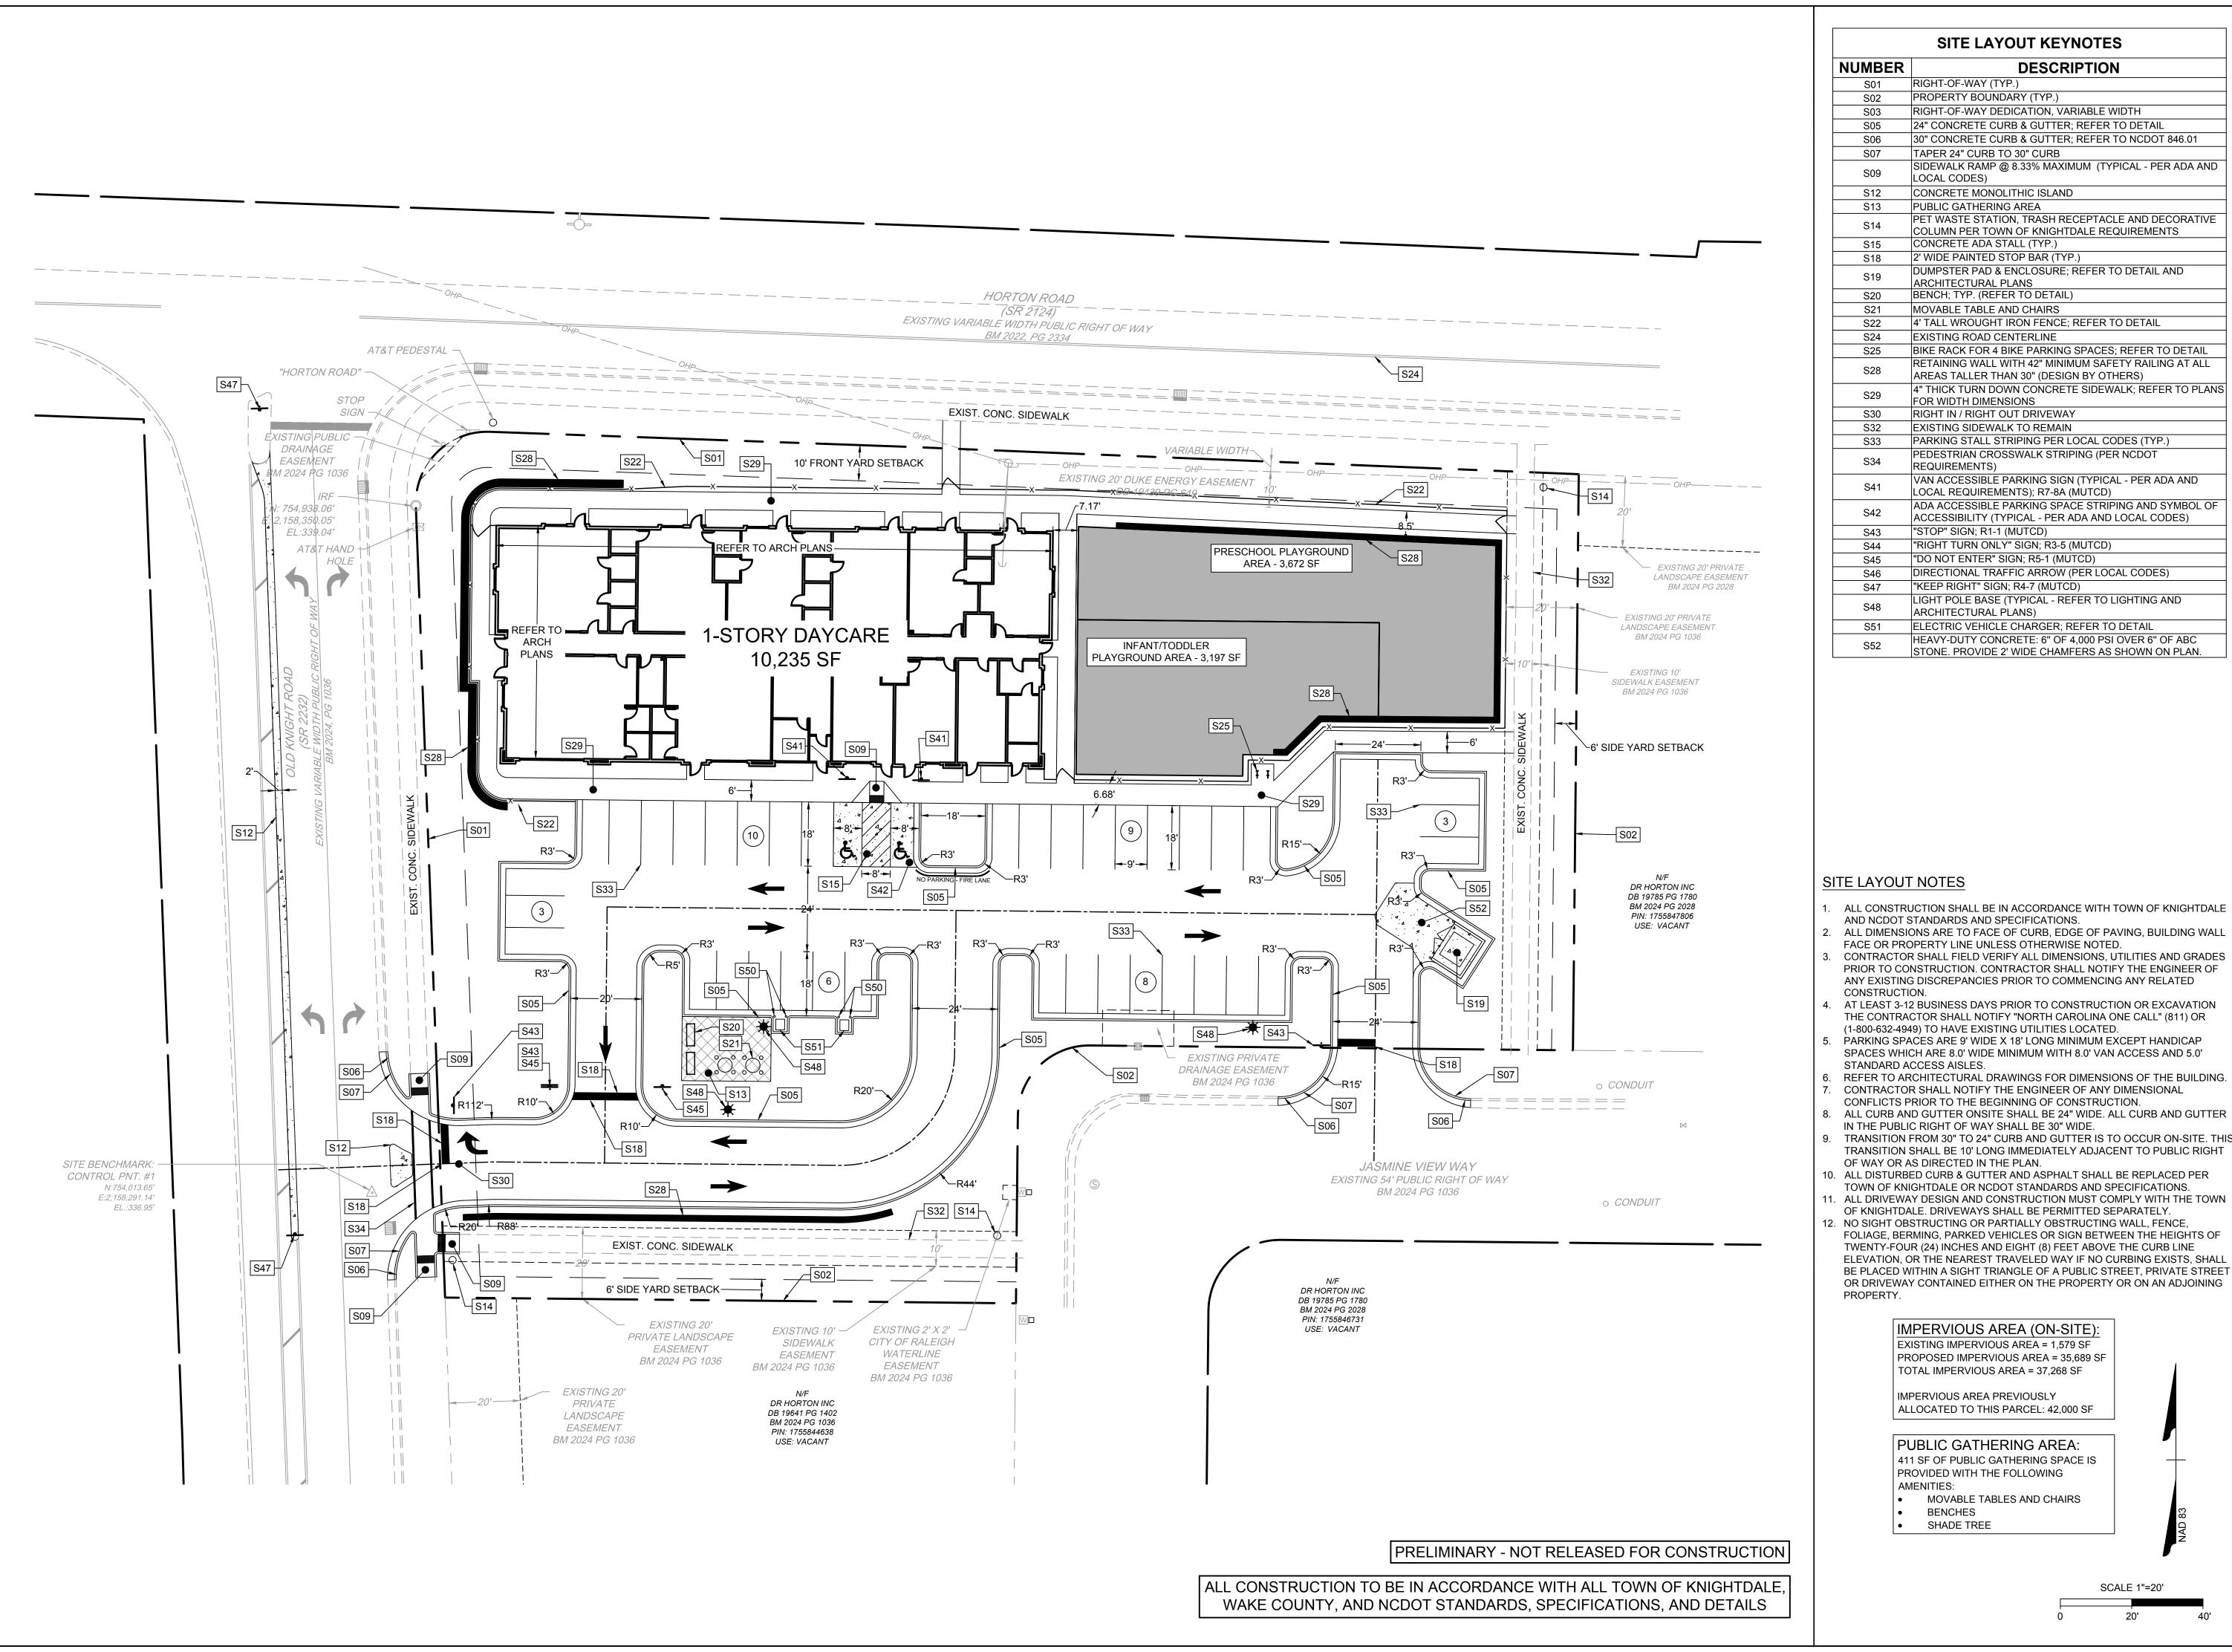

DATE 07/07/2025

DESIGNED BY

DRAWN BY


CHECKED BY 1. DAVIDSON

AS SHOWN

TRANSITION FROM 30" TO 24" CURB AND GUTTER IS TO OCCUR ON-SITE. THIS TRANSITION SHALL BE 10' LONG IMMEDIATELY ADJACENT TO PUBLIC RIGHT

JOB NO.

70434 SHEET NO. C2.0

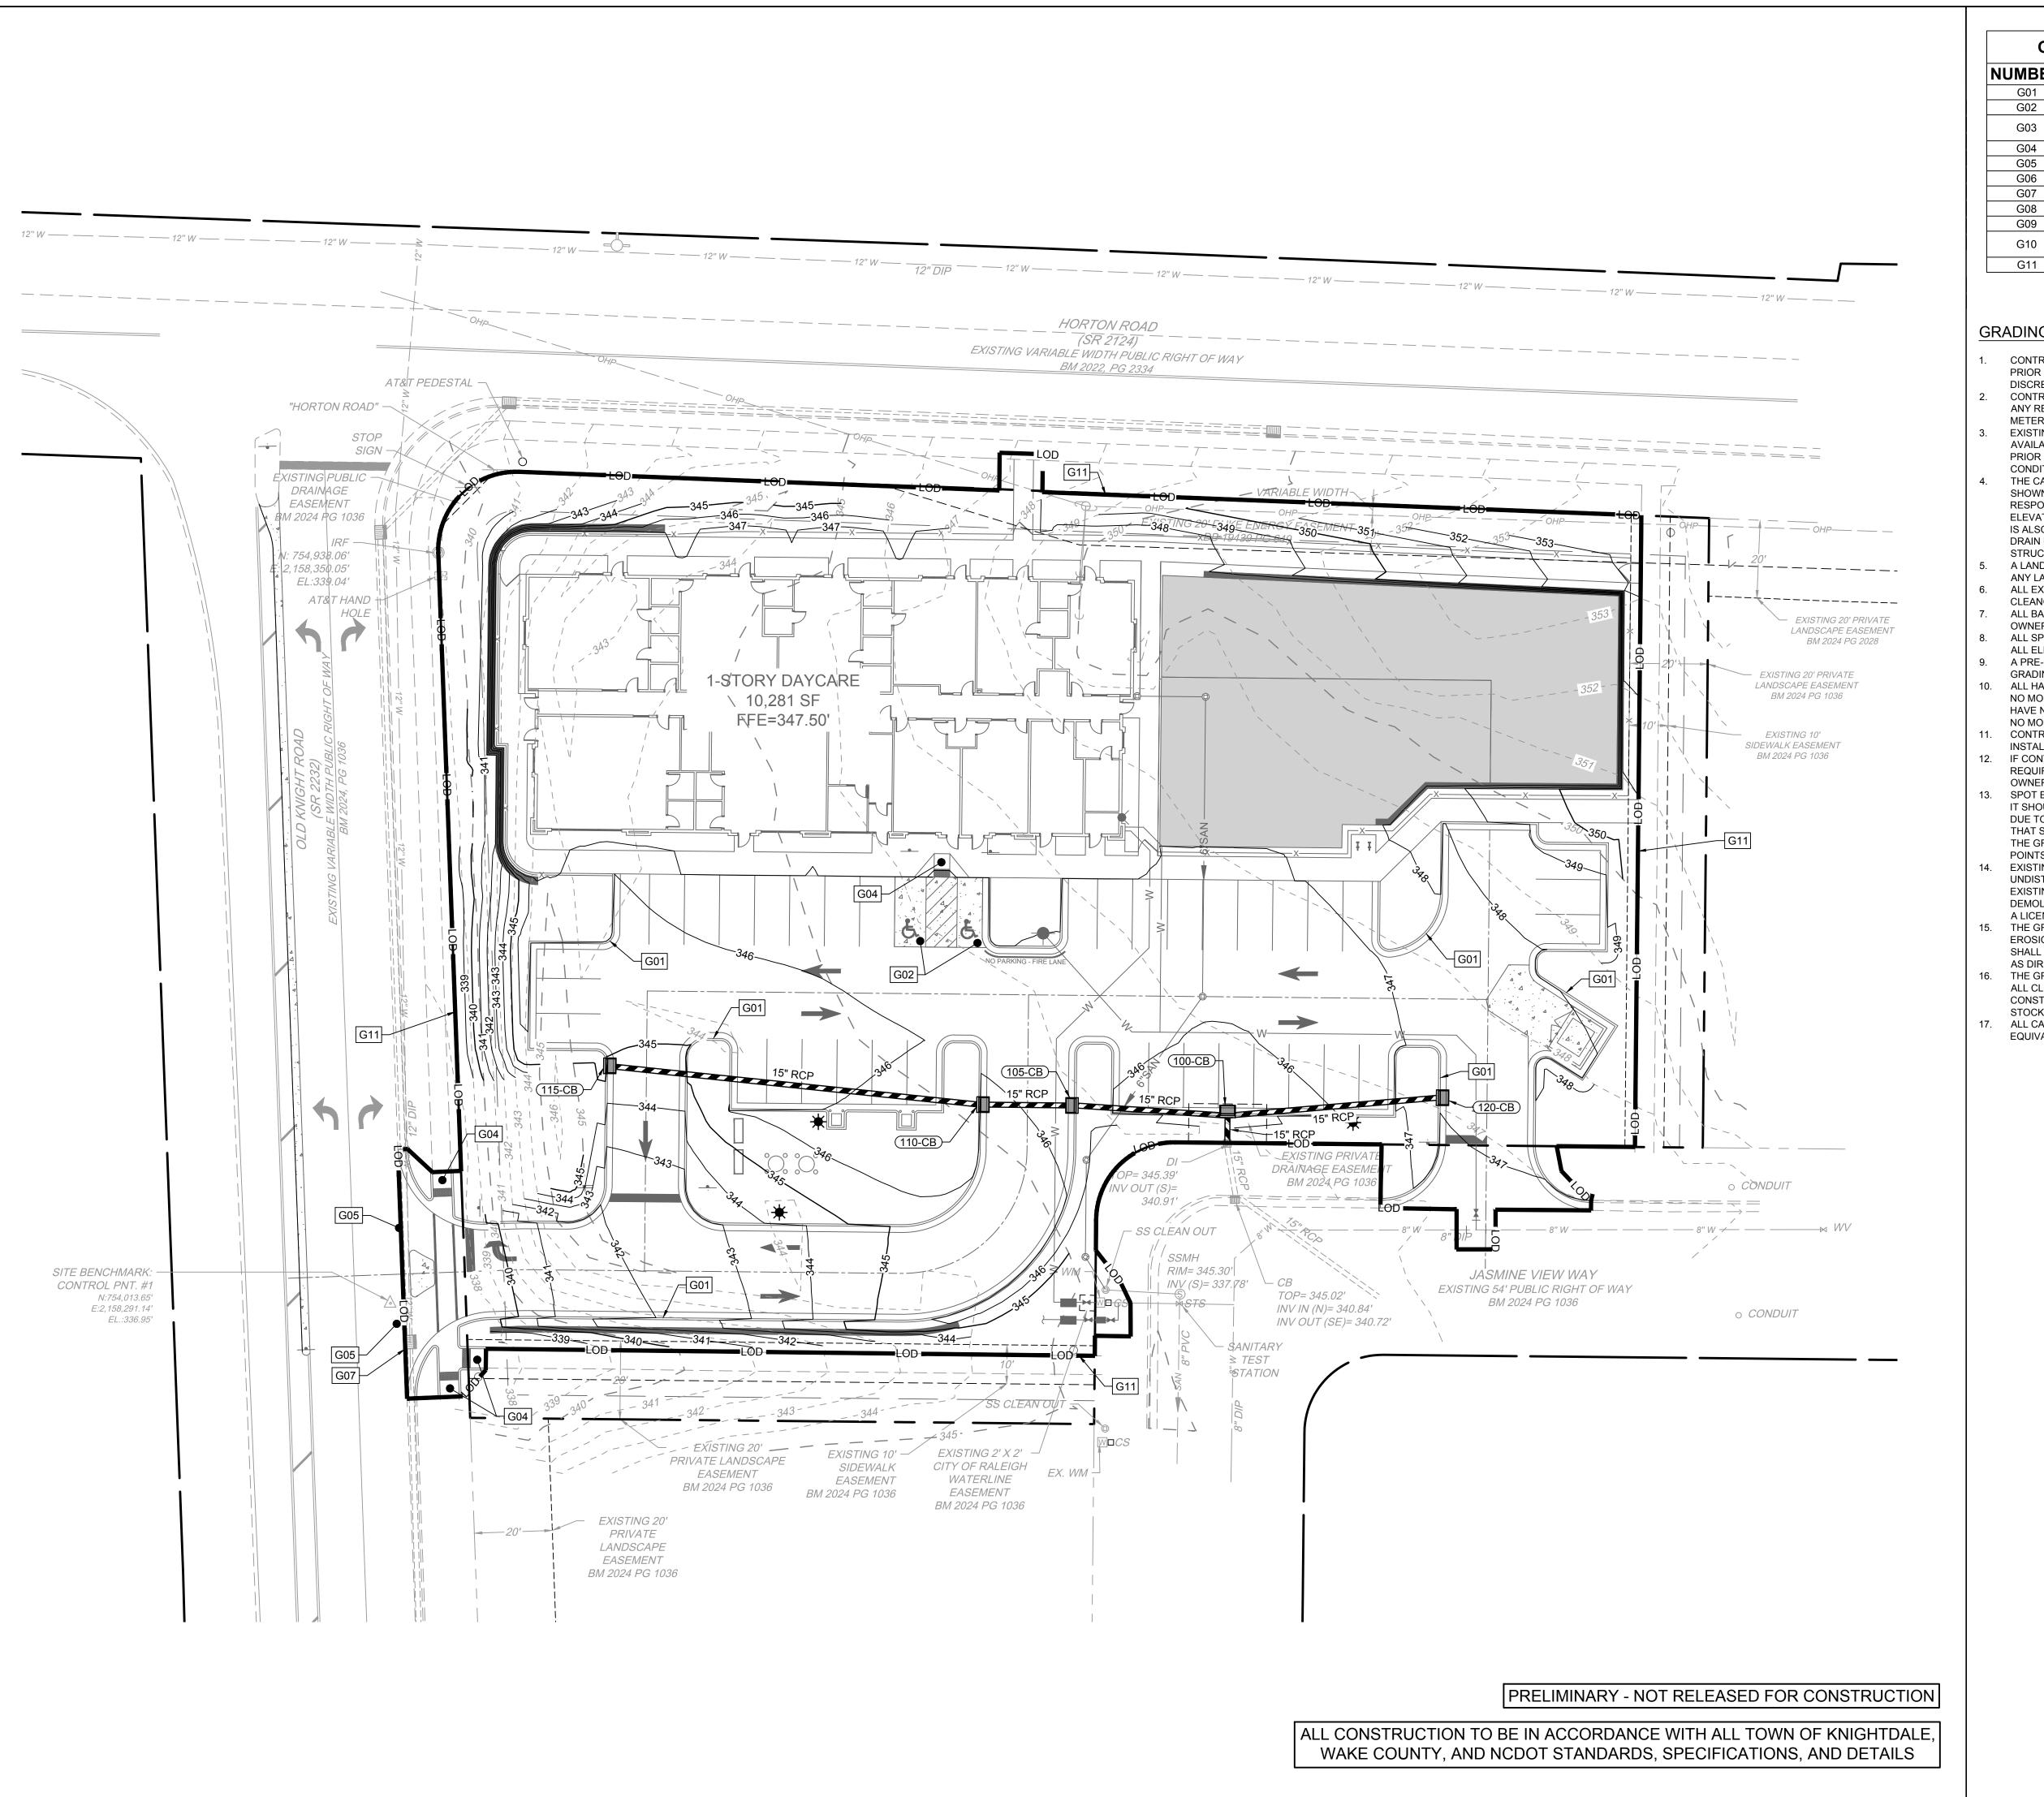

GRADING & STORMWATER KEYNOTES DESCRIPTION NUMBER G01 24" CURB & GUTTER (TYP.) ADA STALLS (MAX SLOPE 1:50) ADA ACCESS ROUTE MAX CROSS SLOPE 1:50; MAX LONG. ADA RAMP (TYP.) MATCH EXISTING PAVEMENT ELEVATION LIMITS OF SAWCUT AND PAVEMENT REMOVAL CONVERT EXISTING STRUCTURE TO DROP INLET

EXISTING PERMANENT DRAINAGE EASEMENT EXISTING PERMANENT UTILITY EASEMENT

ROOF DRAIN (TYP.); MIN. COVER OF 2' AND MIN. SLOPE OF

GRADING AND STORM DRAINAGE NOTES

LIMITS OF DISTURBANCE (TYP.)

- CONTRACTOR SHALL CALL "NORTH CAROLINA ONE CALL" (811) AT LEAST 3 DAYS PRIOR TO DIGGING TO HAVE EXISTING UTILITIES LOCATED. REPORT ANY DISCREPANCIES TO THE ENGINEER.
- CONTRACTOR TO COORDINATE ACTIVITIES WITH UTILITY COMPANIES INVOLVED IN ANY RELATED RELOCATION (I.E. POWER POLES, TELEPHONE PEDESTALS, WATER METERS, ETC.).
- EXISTING UTILITIES SHOWN ARE BASED ON FIELD SURVEYS AND THE BEST AVAILABLE RECORD DRAWINGS. THE CONTRACTOR SHALL VERIFY CONDITIONS PRIOR TO BEGINNING CONSTRUCTION. ANY DISCREPANCIES BETWEEN ACTUAL FIELD CONDITIONS AND THE PLANS SHALL BE REPORTED TO THE ENGINEER IMMEDIATELY. THE CATCH BASINS AND YARD INLETS SHALL BE CONSTRUCTED IN THE LOCATIONS SHOWN UNLESS OTHERWISE DIRECTED BY THE ENGINEER. THE CONTRACTOR IS RESPONSIBLE FOR REPORTING ANY DISCREPANCIES IN THE CATCH BASIN ELEVATIONS OR THE PROPOSED PIPE SLOPES TO THE ENGINEER. THE CONTRACTOR IS ALSO RESPONSIBLE TO REPORT ANY CONFLICTS BETWEEN ANY UTILITY, STORM DRAIN LINE, WATER LINE, SEWER LINE OR ANY OTHER PROPOSED OR EXISTING STRUCTURE TO THE ENGINEER.
- A LAND DISTURBING PERMIT WILL BE REQUIRED PRIOR TO THE COMMENCEMENT OF ANY LAND-DISTURBING ACTIVITIES.
- ALL EXISTING VAULTS, MANHOLES, STORM DRAIN STRUCTURES, VALVE BOXES, CLEANOUTS, ETC. SHALL BE ADJUSTED AS NEEDED TO MATCH FINISHED GRADE. ALL BACKFILL, COMPACTION, SOILS TESTING, ETC. SHALL BE PERFORMED BY THE
- OWNER'S INDEPENDENT TESTING LABORATORY. ALL SPOT ELEVATIONS INDICATED ARE AT TOP OF CURB UNLESS NOTED OTHERWISE
- ALL ELEVATIONS ARE BASED ON VERTICAL DATUM NAVD88. A PRE-CONSTRUCTION MEETING MUST BE SCHEDULED PRIOR TO ANY WORK,
- GRADING OR INSTALLATION OF EROSION CONTROL MEASURES. ALL HANDICAP PARKING SPACES AND STRIPED ACCESSIBILITY AISLES ARE TO HAVE NO MORE THAN A 1:50 (2.0%) SLOPE IN ALL DIRECTIONS. ALL SIDEWALKS ARE TO
- HAVE NO MORE THAN A 1:20 (5.0%) SLOPE FOR THE LENGTH OF THE SIDEWALK AND NO MORE THAN A 1:50 (2.0%) SLOPE FOR THE WIDTH OF THE SIDEWALK. CONTRACTOR TO IDENTIFY ALL NECESSARY SPILL CURB SECTION LOCATIONS AND
- INSTALL TO ENSURE POSITIVE DRAINAGE TO STORM STRUCTURES. IF CONTRACTOR NOTICES ANY DISCREPANCIES IN ANY OF THESE SLOPE REQUIREMENTS, IT IS THE CONTRACTOR'S RESPONSIBILITY TO CONTACT THE
- OWNER PRIOR TO POURING ANY CONCRETE SO THAT A SOLUTION CAN BE FOUND. SPOT ELEVATIONS ARE GIVEN AT THE MAJORITY OF THE MAJOR BREAK POINTS BUT IT SHOULD NOT BE ASSUMED THAT ALL NECESSARY SPOT ELEVATIONS ARE SHOWN. DUE TO SPACE LIMITATIONS, THERE MAY BE OTHER CRITICAL SPOTS NOT LABELED THAT SHOULD BE TAKEN INTO CONSIDERATION. THE CONTRACTOR SHALL REVIEW
- THE GRADING PLAN IN DETAIL AND SHALL ENSURE THAT ALL CRITICAL GRADE POINTS ARE STAKED AND FOLLOWED TO PROVIDE POSITIVE DRAINAGE. EXISTING VEGETATION WITHIN TREE PROTECTIVE AREAS SHALL REMAIN UNDISTURBED UNLESS NOTED OTHERWISE. ANY AND ALL LANDSCAPING AND EXISTING TREES AND SHRUBS TO REMAIN WHICH ARE DAMAGED DURING DEMOLITION OR CONSTRUCTION SHALL BE REPLACED BY THE CONTRACTOR USING
- A LICENSED LANDSCAPE CONTRACTOR AT NO ADDITIONAL COST TO THE OWNER. THE GRADING CONTRACTOR SHALL COMPLY WITH ALL STATE CODES IN OBSERVING EROSION CONTROL MEASURES BOTH ON AND OFF-SITE. THE GRADING CONTRACTOR SHALL MAINTAIN ALL EROSION CONTROL DEVICES AFTER EACH RAINFALL EVENT OR AS DIRECTED BY THE EROSION CONTROL INSPECTOR OR THE ENGINEER.
- THE GRADING CONTRACTOR SHALL BE RESPONSIBLE FOR OFF-SITE DISPOSAL OF ALL CLEARING AND GRADING WASTE MATERIALS GENERATED DURING CONSTRUCTION AND FOR OBTAINING ALL APPLICABLE PERMITS FOR OFF-SITE STOCKPILES AND/OR WASTE AREAS.
- ALL CATCH BASINS MUST BE MARKED "DUMP NO WASTE DRAINS TO STREAM" OR EQUIVALENT.

LAND USE TOTALS:

TOTAL SITE AREA: 65,480 SF


ON-SITE IMPERVIOUS: PROPOSED BUILDING: 10,281 SF PROPOSED SIDEWALK / RETAINING WALL: 5,280 SF PROPOSED VUA: 20,128 SF EXISTING IMPERVIOUS (SIDEWALK): 1,579 SF

ON-SITE IMPERVIOUS TOTAL: 37,268 SF

ON-SITE PERVIOUS: LANDSCAPED AREAS: 21,343 PLAYGROUND: 6,869 SF

ON-SITE PERVIOUS TOTAL: 28,212 SF

PROPOSED OFF-SITE IMPERVIOUS AREA: 833 SF

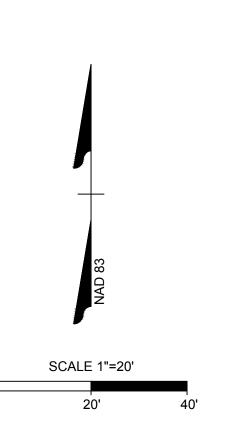

DATE

07/07/2025 *332*


DESIGNED BY 332

CHECKED BY M. DAVIDSON

AS SHOWN

JOB NO. 70434 SHEET NO.

C3.0

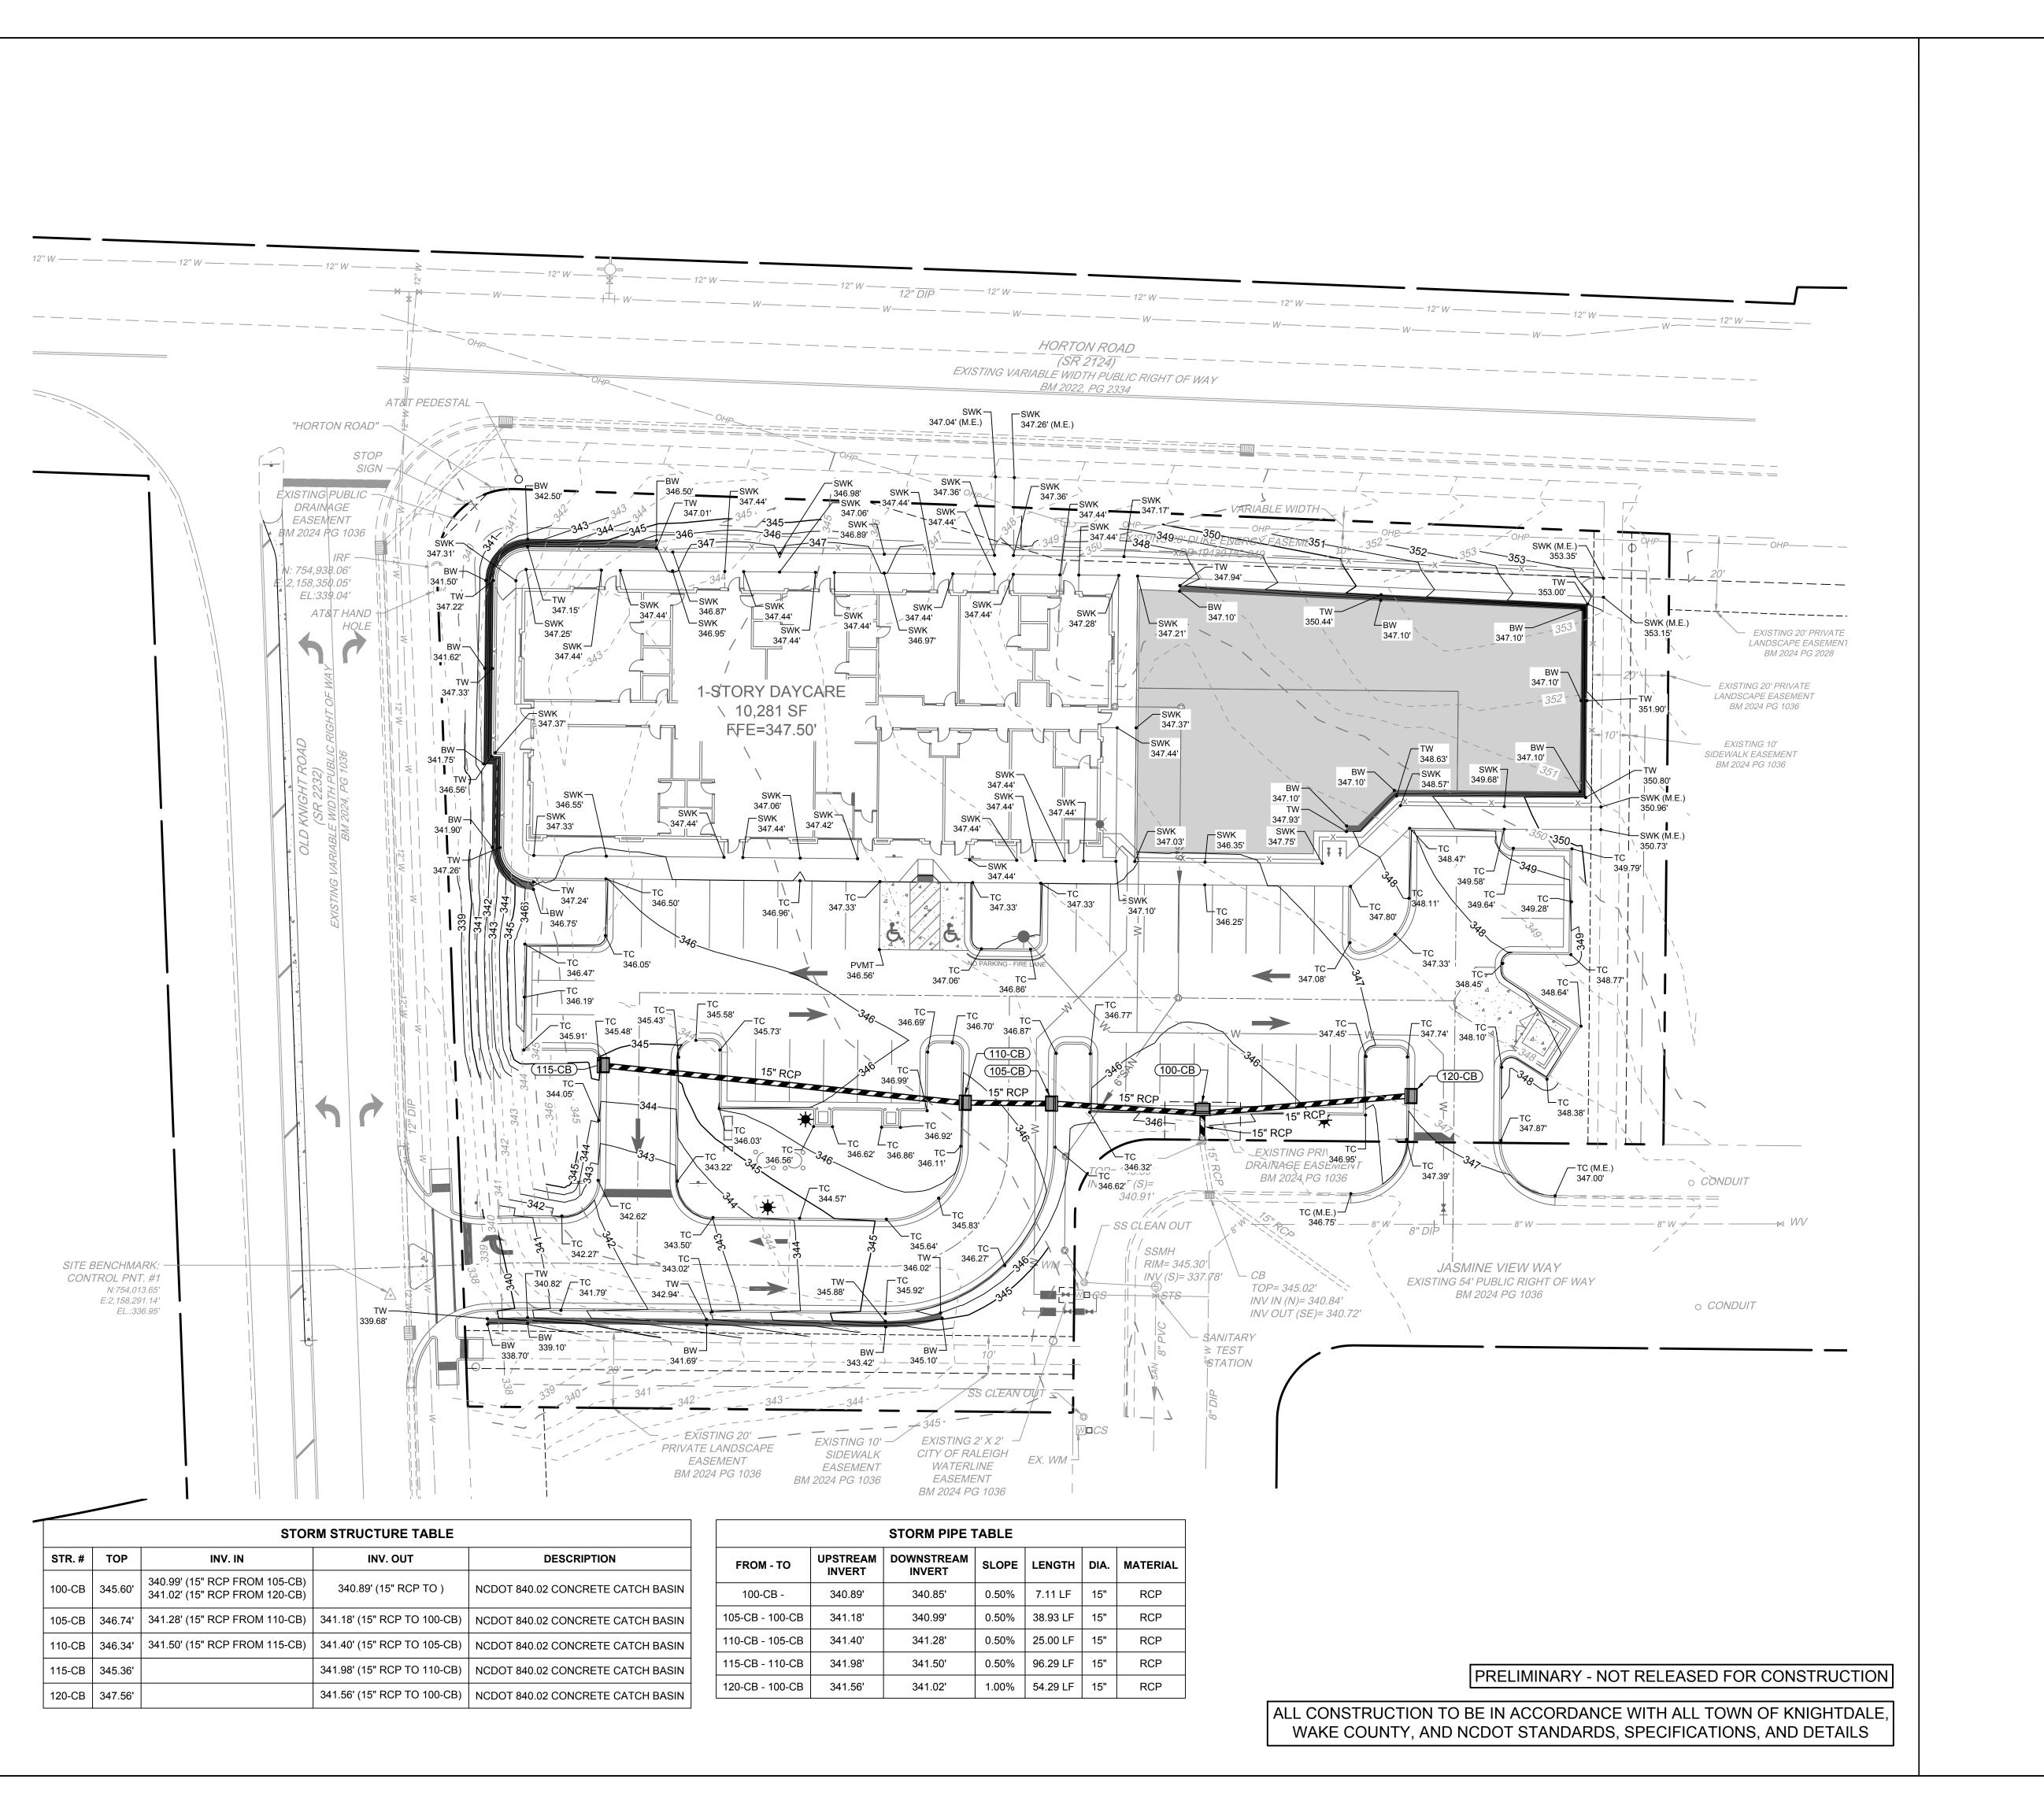

SPOT ELEVATION LEGEND TC = TOP OF CURB ME = MATCH EXISTING GND = GROUND SWK = SIDEWALK TW = TOP OF WALL BW = BOTTOM OF WALL HP = HIGH POINT FC = FLUSH CURB EOP = EDGE OF PAVEMENT PVMT = PAVEMENT FL = FLOW LINE

 TOP REFERS TO: 1.1. CATCH BASIN: TOP OF CURB 1.2. YARD INLET: SILL 2. SD* - SEE RISER DETAIL

SCALE 1"=20'

DATE

----DRAWN BY


DESIGNED BY

CHECKED BY

M. DAVIDSON

AS SHOWN


JOB NO. 70434 SHEET NO. C3.1

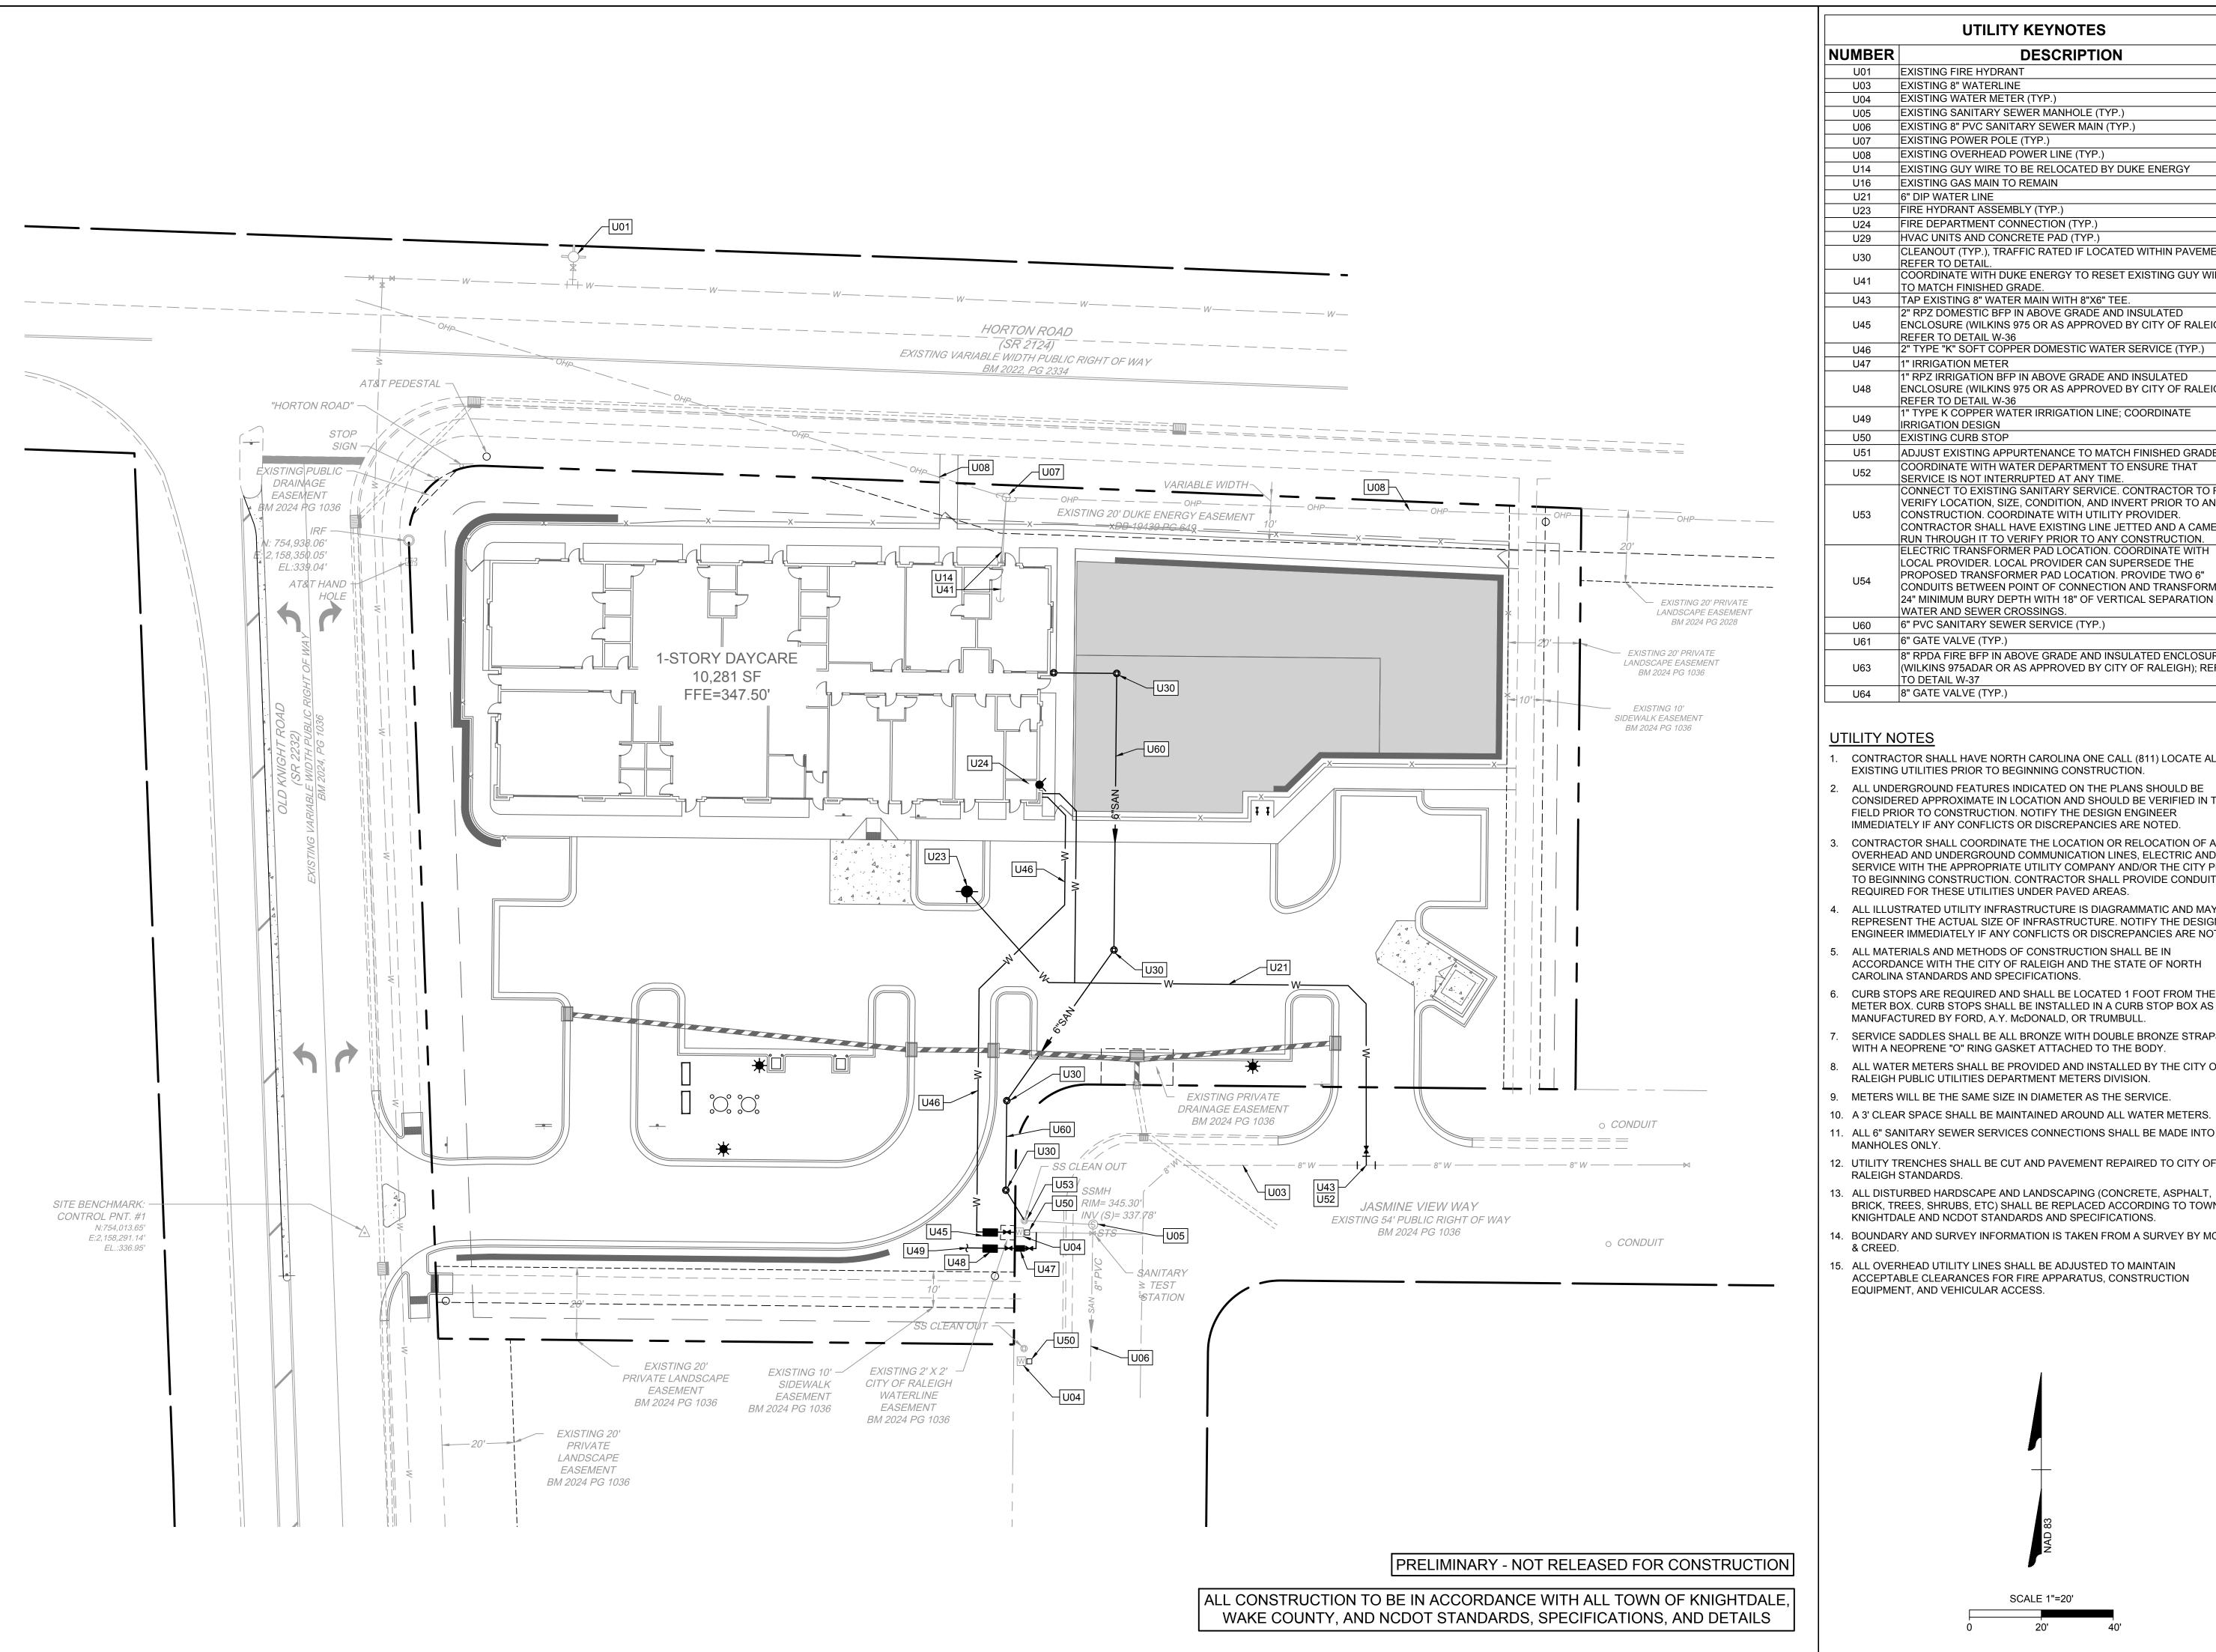

MADED	DECORIDATION
NUMBER	DESCRIPTION
U01	EXISTING FIRE HYDRANT
U03	EXISTING 8" WATERLINE
U04	EXISTING WATER METER (TYP.)
U05	EXISTING SANITARY SEWER MANHOLE (TYP.)
U06	EXISTING 8" PVC SANITARY SEWER MAIN (TYP.)
U07	EXISTING POWER POLE (TYP.)
U08	EXISTING OVERHEAD POWER LINE (TYP.)
U14	EXISTING GUY WIRE TO BE RELOCATED BY DUKE ENERGY
U16	EXISTING GAS MAIN TO REMAIN
U21	6" DIP WATER LINE
U23	FIRE HYDRANT ASSEMBLY (TYP.)
U24	FIRE DEPARTMENT CONNECTION (TYP.)
U29	HVAC UNITS AND CONCRETE PAD (TYP.)
	CLEANOUT (TYP.), TRAFFIC RATED IF LOCATED WITHIN PAVEMENT
U30	REFER TO DETAIL.
U41	COORDINATE WITH DUKE ENERGY TO RESET EXISTING GUY WIRE
	TO MATCH FINISHED GRADE.
U43	TAP EXISTING 8" WATER MAIN WITH 8"X6" TEE.
	2" RPZ DOMESTIC BFP IN ABOVE GRADE AND INSULATED
U45	ENCLOSURE (WILKINS 975 OR AS APPROVED BY CITY OF RALEIGH
1110	REFER TO DETAIL W-36
U46	2" TYPE "K" SOFT COPPER DOMESTIC WATER SERVICE (TYP.)
U47	1" IRRIGATION METER
1140	1" RPZ IRRIGATION BFP IN ABOVE GRADE AND INSULATED
U48	ENCLOSURE (WILKINS 975 OR AS APPROVED BY CITY OF RALEIGH REFER TO DETAIL W-36
	1" TYPE K COPPER WATER IRRIGATION LINE; COORDINATE
U49	IRRIGATION DESIGN
U50	EXISTING CURB STOP
U51	ADJUST EXISTING APPURTENANCE TO MATCH FINISHED GRADE.
	COORDINATE WITH WATER DEPARTMENT TO ENSURE THAT
U52	SERVICE IS NOT INTERRUPTED AT ANY TIME.
	CONNECT TO EXISTING SANITARY SERVICE. CONTRACTOR TO FIE
	VERIFY LOCATION, SIZE, CONDITION, AND INVERT PRIOR TO ANY
U53	CONSTRUCTION. COORDINATE WITH UTILITY PROVIDER.
	CONTRACTOR SHALL HAVE EXISTING LINE JETTED AND A CAMERA
	RUN THROUGH IT TO VERIFY PRIOR TO ANY CONSTRUCTION.
	ELECTRIC TRANSFORMER PAD LOCATION. COORDINATE WITH
	LOCAL PROVIDER. LOCAL PROVIDER CAN SUPERSEDE THE PROPOSED TRANSFORMER PAD LOCATION. PROVIDE TWO 6"
U54	CONDUITS BETWEEN POINT OF CONNECTION AND TRANSFORMER
	24" MINIMUM BURY DEPTH WITH 18" OF VERTICAL SEPARATION AT
	WATER AND SEWER CROSSINGS.
U60	6" PVC SANITARY SEWER SERVICE (TYP.)
U61	6" GATE VALVE (TYP.)
	8" RPDA FIRE BFP IN ABOVE GRADE AND INSULATED ENCLOSURE
U63	(WILKINS 975ADAR OR AS APPROVED BY CITY OF RALEIGH); REFEI
200	TO DETAIL W-37
U64	8" GATE VALVE (TYP.)

UTILITY NOTES

- 1. CONTRACTOR SHALL HAVE NORTH CAROLINA ONE CALL (811) LOCATE ALL EXISTING UTILITIES PRIOR TO BEGINNING CONSTRUCTION.
- . ALL UNDERGROUND FEATURES INDICATED ON THE PLANS SHOULD BE CONSIDERED APPROXIMATE IN LOCATION AND SHOULD BE VERIFIED IN THE FIELD PRIOR TO CONSTRUCTION. NOTIFY THE DESIGN ENGINEER IMMEDIATELY IF ANY CONFLICTS OR DISCREPANCIES ARE NOTED.
- CONTRACTOR SHALL COORDINATE THE LOCATION OR RELOCATION OF ALL OVERHEAD AND UNDERGROUND COMMUNICATION LINES, ELECTRIC AND GAS SERVICE WITH THE APPROPRIATE UTILITY COMPANY AND/OR THE CITY PRIOR TO BEGINNING CONSTRUCTION. CONTRACTOR SHALL PROVIDE CONDUITS AS REQUIRED FOR THESE UTILITIES UNDER PAVED AREAS.
- ALL ILLUSTRATED UTILITY INFRASTRUCTURE IS DIAGRAMMATIC AND MAY NOT REPRESENT THE ACTUAL SIZE OF INFRASTRUCTURE. NOTIFY THE DESIGN ENGINEER IMMEDIATELY IF ANY CONFLICTS OR DISCREPANCIES ARE NOTED.
- 5. ALL MATERIALS AND METHODS OF CONSTRUCTION SHALL BE IN ACCORDANCE WITH THE CITY OF RALEIGH AND THE STATE OF NORTH CAROLINA STANDARDS AND SPECIFICATIONS.
- 3. CURB STOPS ARE REQUIRED AND SHALL BE LOCATED 1 FOOT FROM THE METER BOX. CURB STOPS SHALL BE INSTALLED IN A CURB STOP BOX AS MANUFACTURED BY FORD, A.Y. McDONALD, OR TRUMBULL.
- SERVICE SADDLES SHALL BE ALL BRONZE WITH DOUBLE BRONZE STRAPS WITH A NEOPRENE "O" RING GASKET ATTACHED TO THE BODY.
- 8. ALL WATER METERS SHALL BE PROVIDED AND INSTALLED BY THE CITY OF RALEIGH PUBLIC UTILITIES DEPARTMENT METERS DIVISION.
- 9. METERS WILL BE THE SAME SIZE IN DIAMETER AS THE SERVICE.
- 10. A 3' CLEAR SPACE SHALL BE MAINTAINED AROUND ALL WATER METERS.
- 11. ALL 6" SANITARY SEWER SERVICES CONNECTIONS SHALL BE MADE INTO MANHOLES ONLY.
- RALEIGH STANDARDS.
- 13. ALL DISTURBED HARDSCAPE AND LANDSCAPING (CONCRETE, ASPHALT, BRICK, TREES, SHRUBS, ETC) SHALL BE REPLACED ACCORDING TO TOWN OF KNIGHTDALE AND NCDOT STANDARDS AND SPECIFICATIONS.
- 14. BOUNDARY AND SURVEY INFORMATION IS TAKEN FROM A SURVEY BY MCKIM
- 15. ALL OVERHEAD UTILITY LINES SHALL BE ADJUSTED TO MAINTAIN ACCEPTABLE CLEARANCES FOR FIRE APPARATUS, CONSTRUCTION EQUIPMENT, AND VEHICULAR ACCESS.

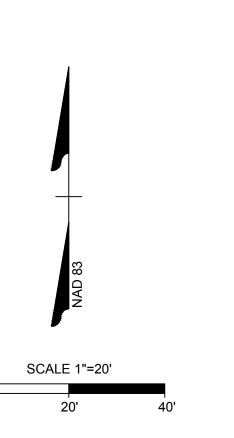

THIS DRAWING PREPARED AT THE	RALEIGH OFFICE	5410 Trinity Road, Suite 102 Raleigh, NC 27607	919.866.4951 FAX 919.833.8124 www.timmons.con	REVISION DESCRIPTION
		5410 Tr	919.866	REVI

07/07/2025


DESIGNED BY

CHECKED BY

M. DAVIDSON

AS SHOWN

JOB NO. 70434 SHEET NO. C5.0

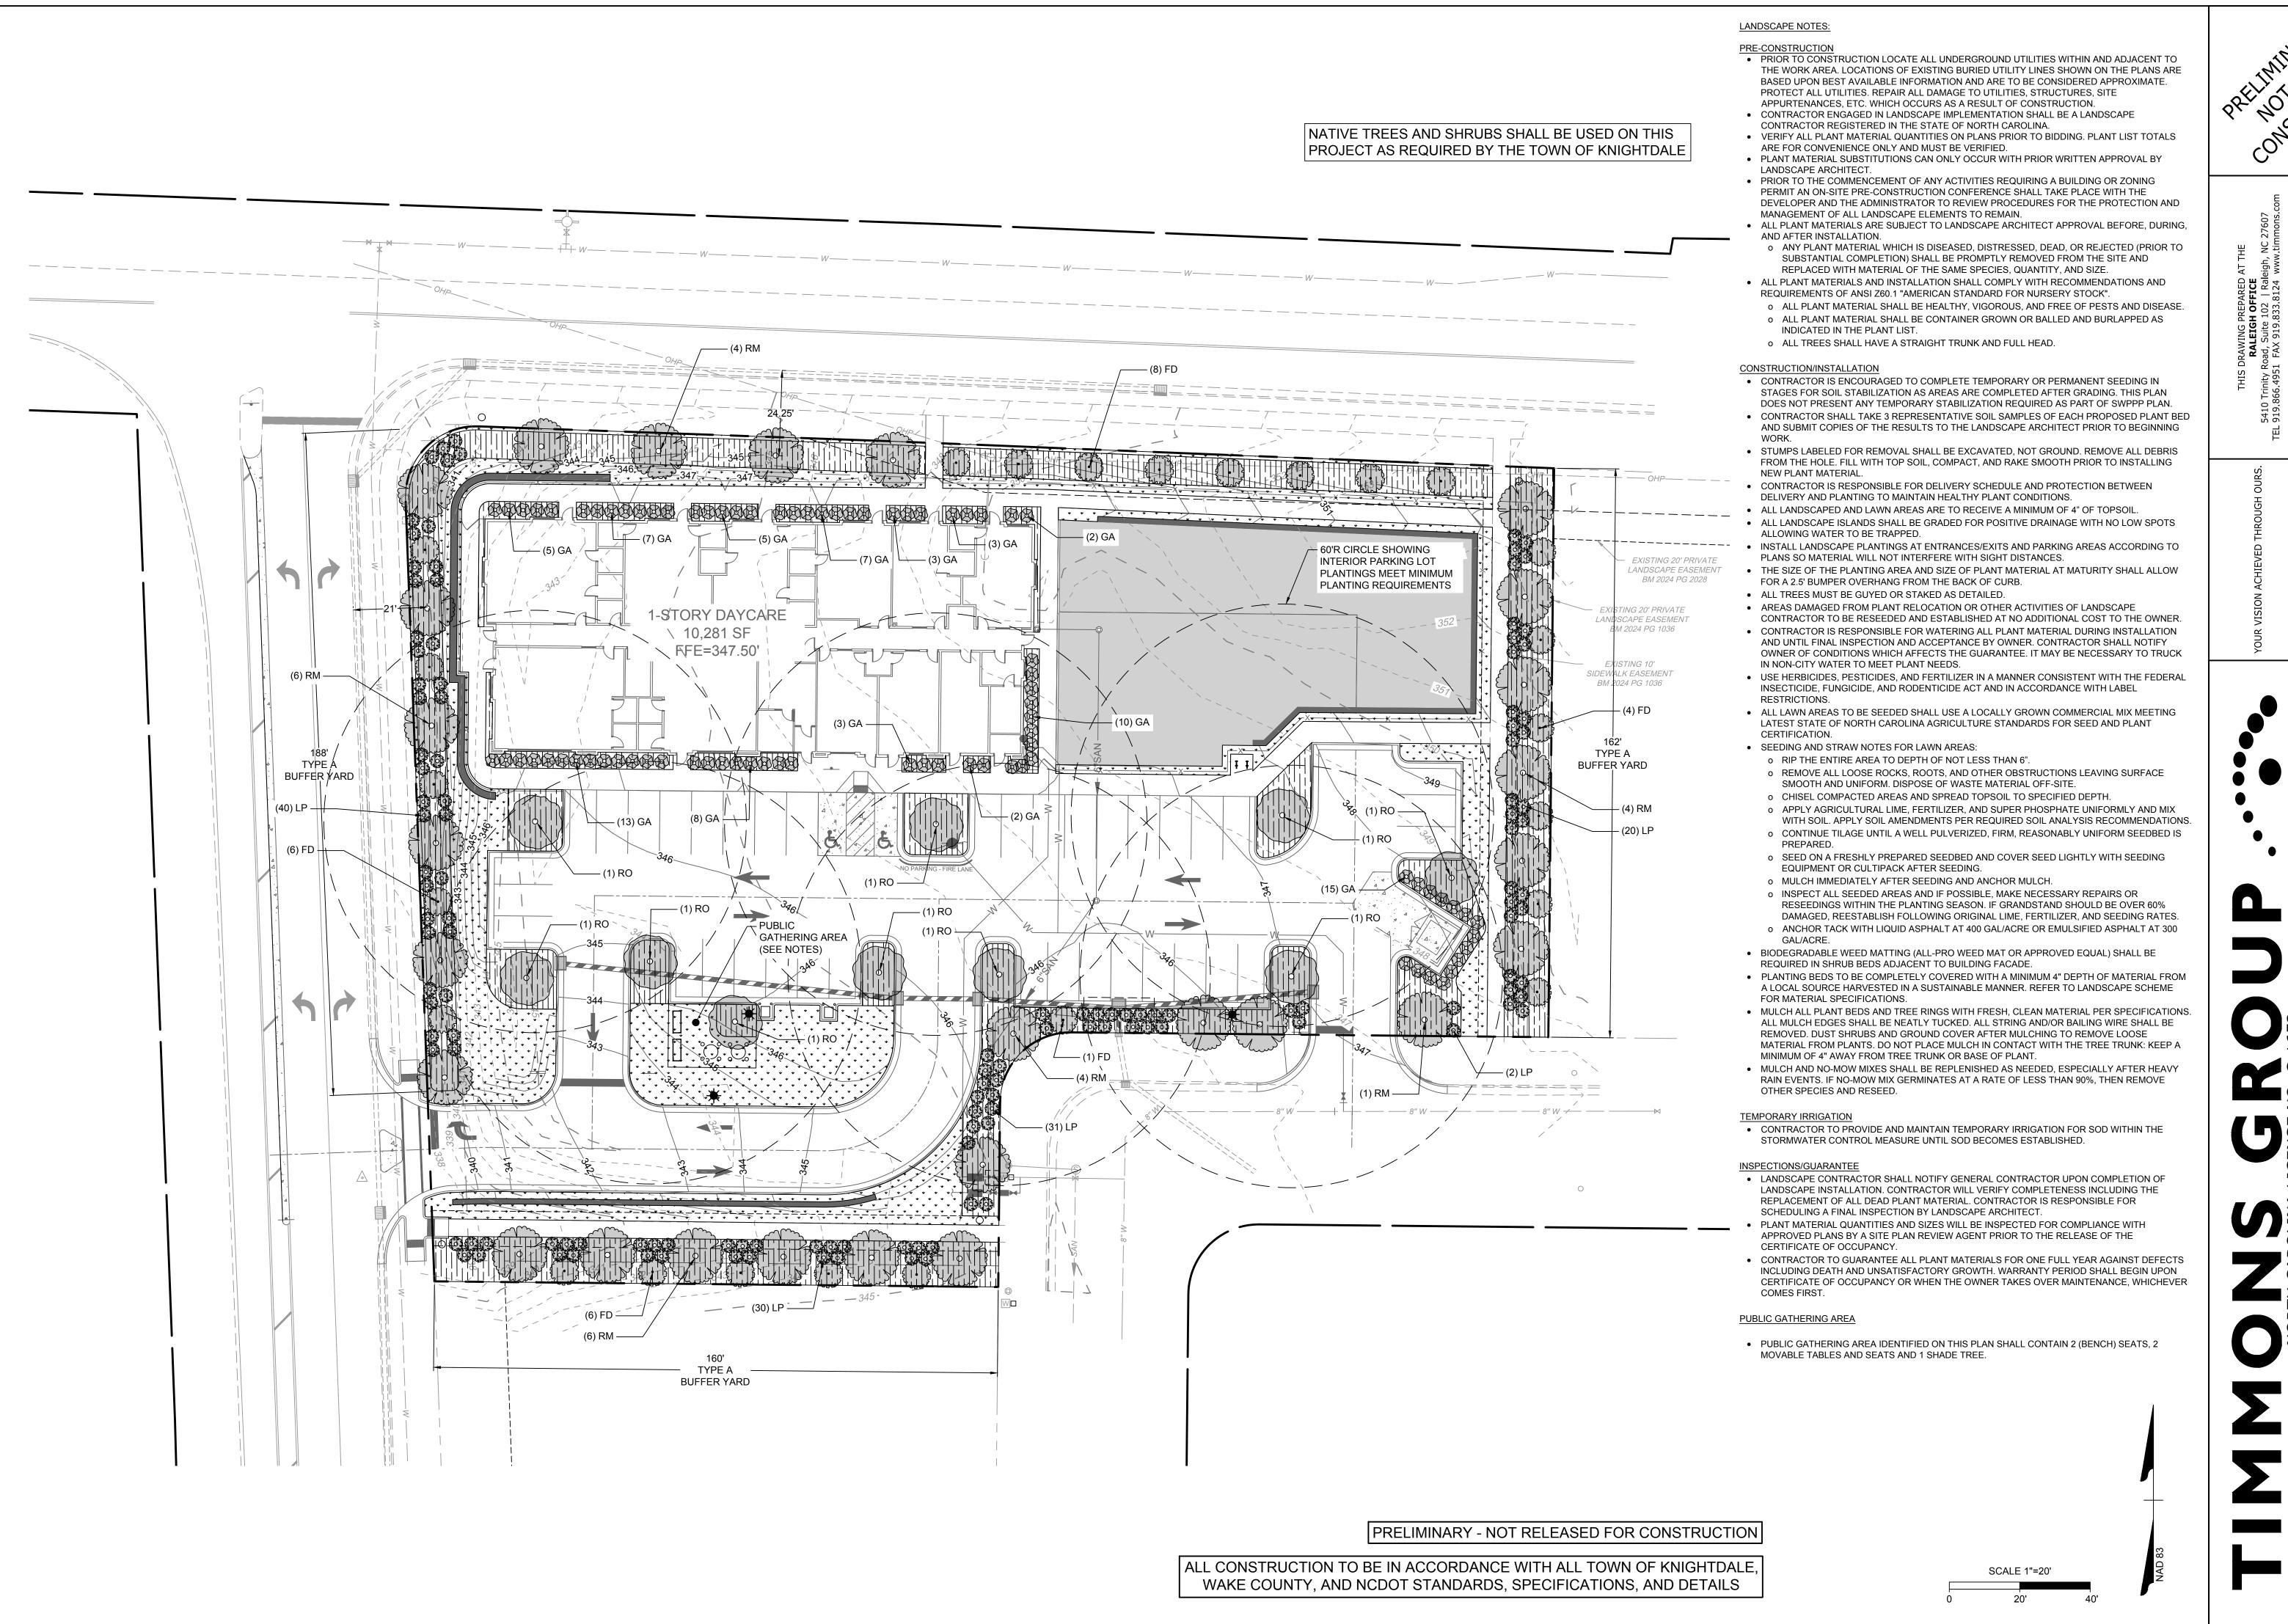

DATE 07/07/2025


DESIGNED BY

CHECKED BY 1. DAVIDSON

AS SHOWN

JOB NO.

70434 SHEET NO. C6.0

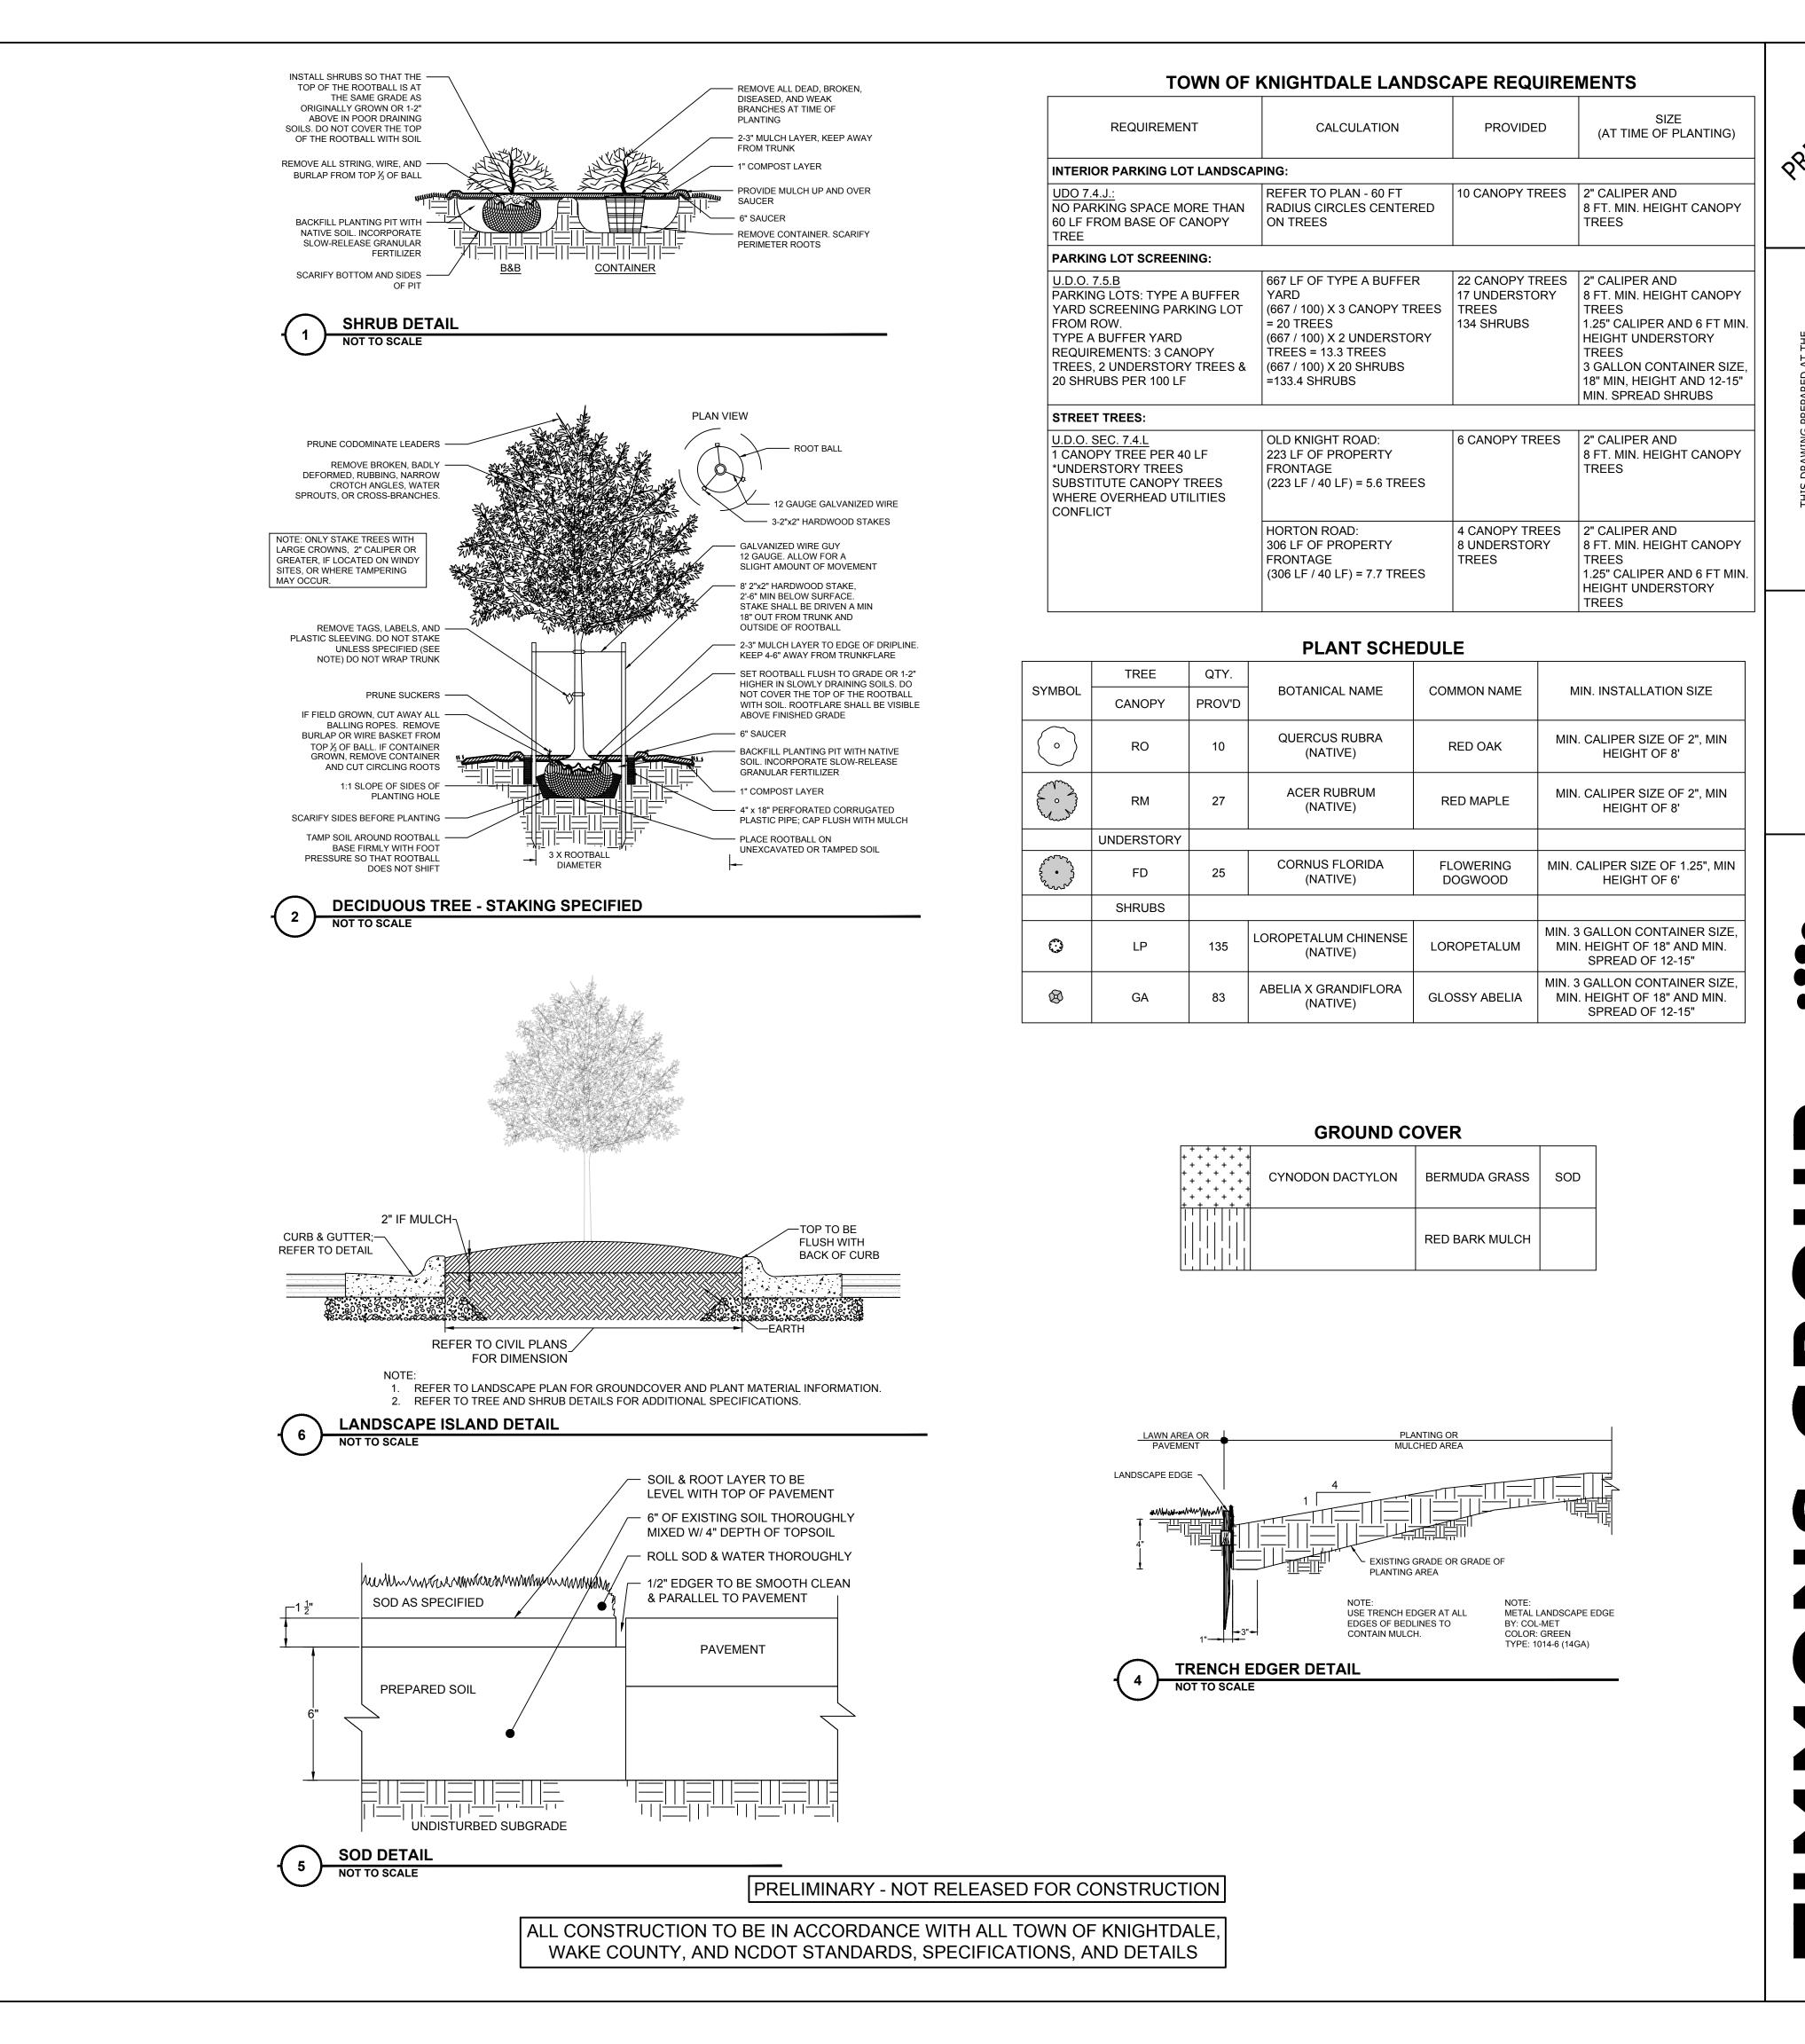

DATE

DRAWN BY

332

DESIGNED BY

CHECKED BY

1. DAVIDSON

SCALE

AS SHOWN


JOB NO.


70434

SHEET NO. **C6.1**

332

.

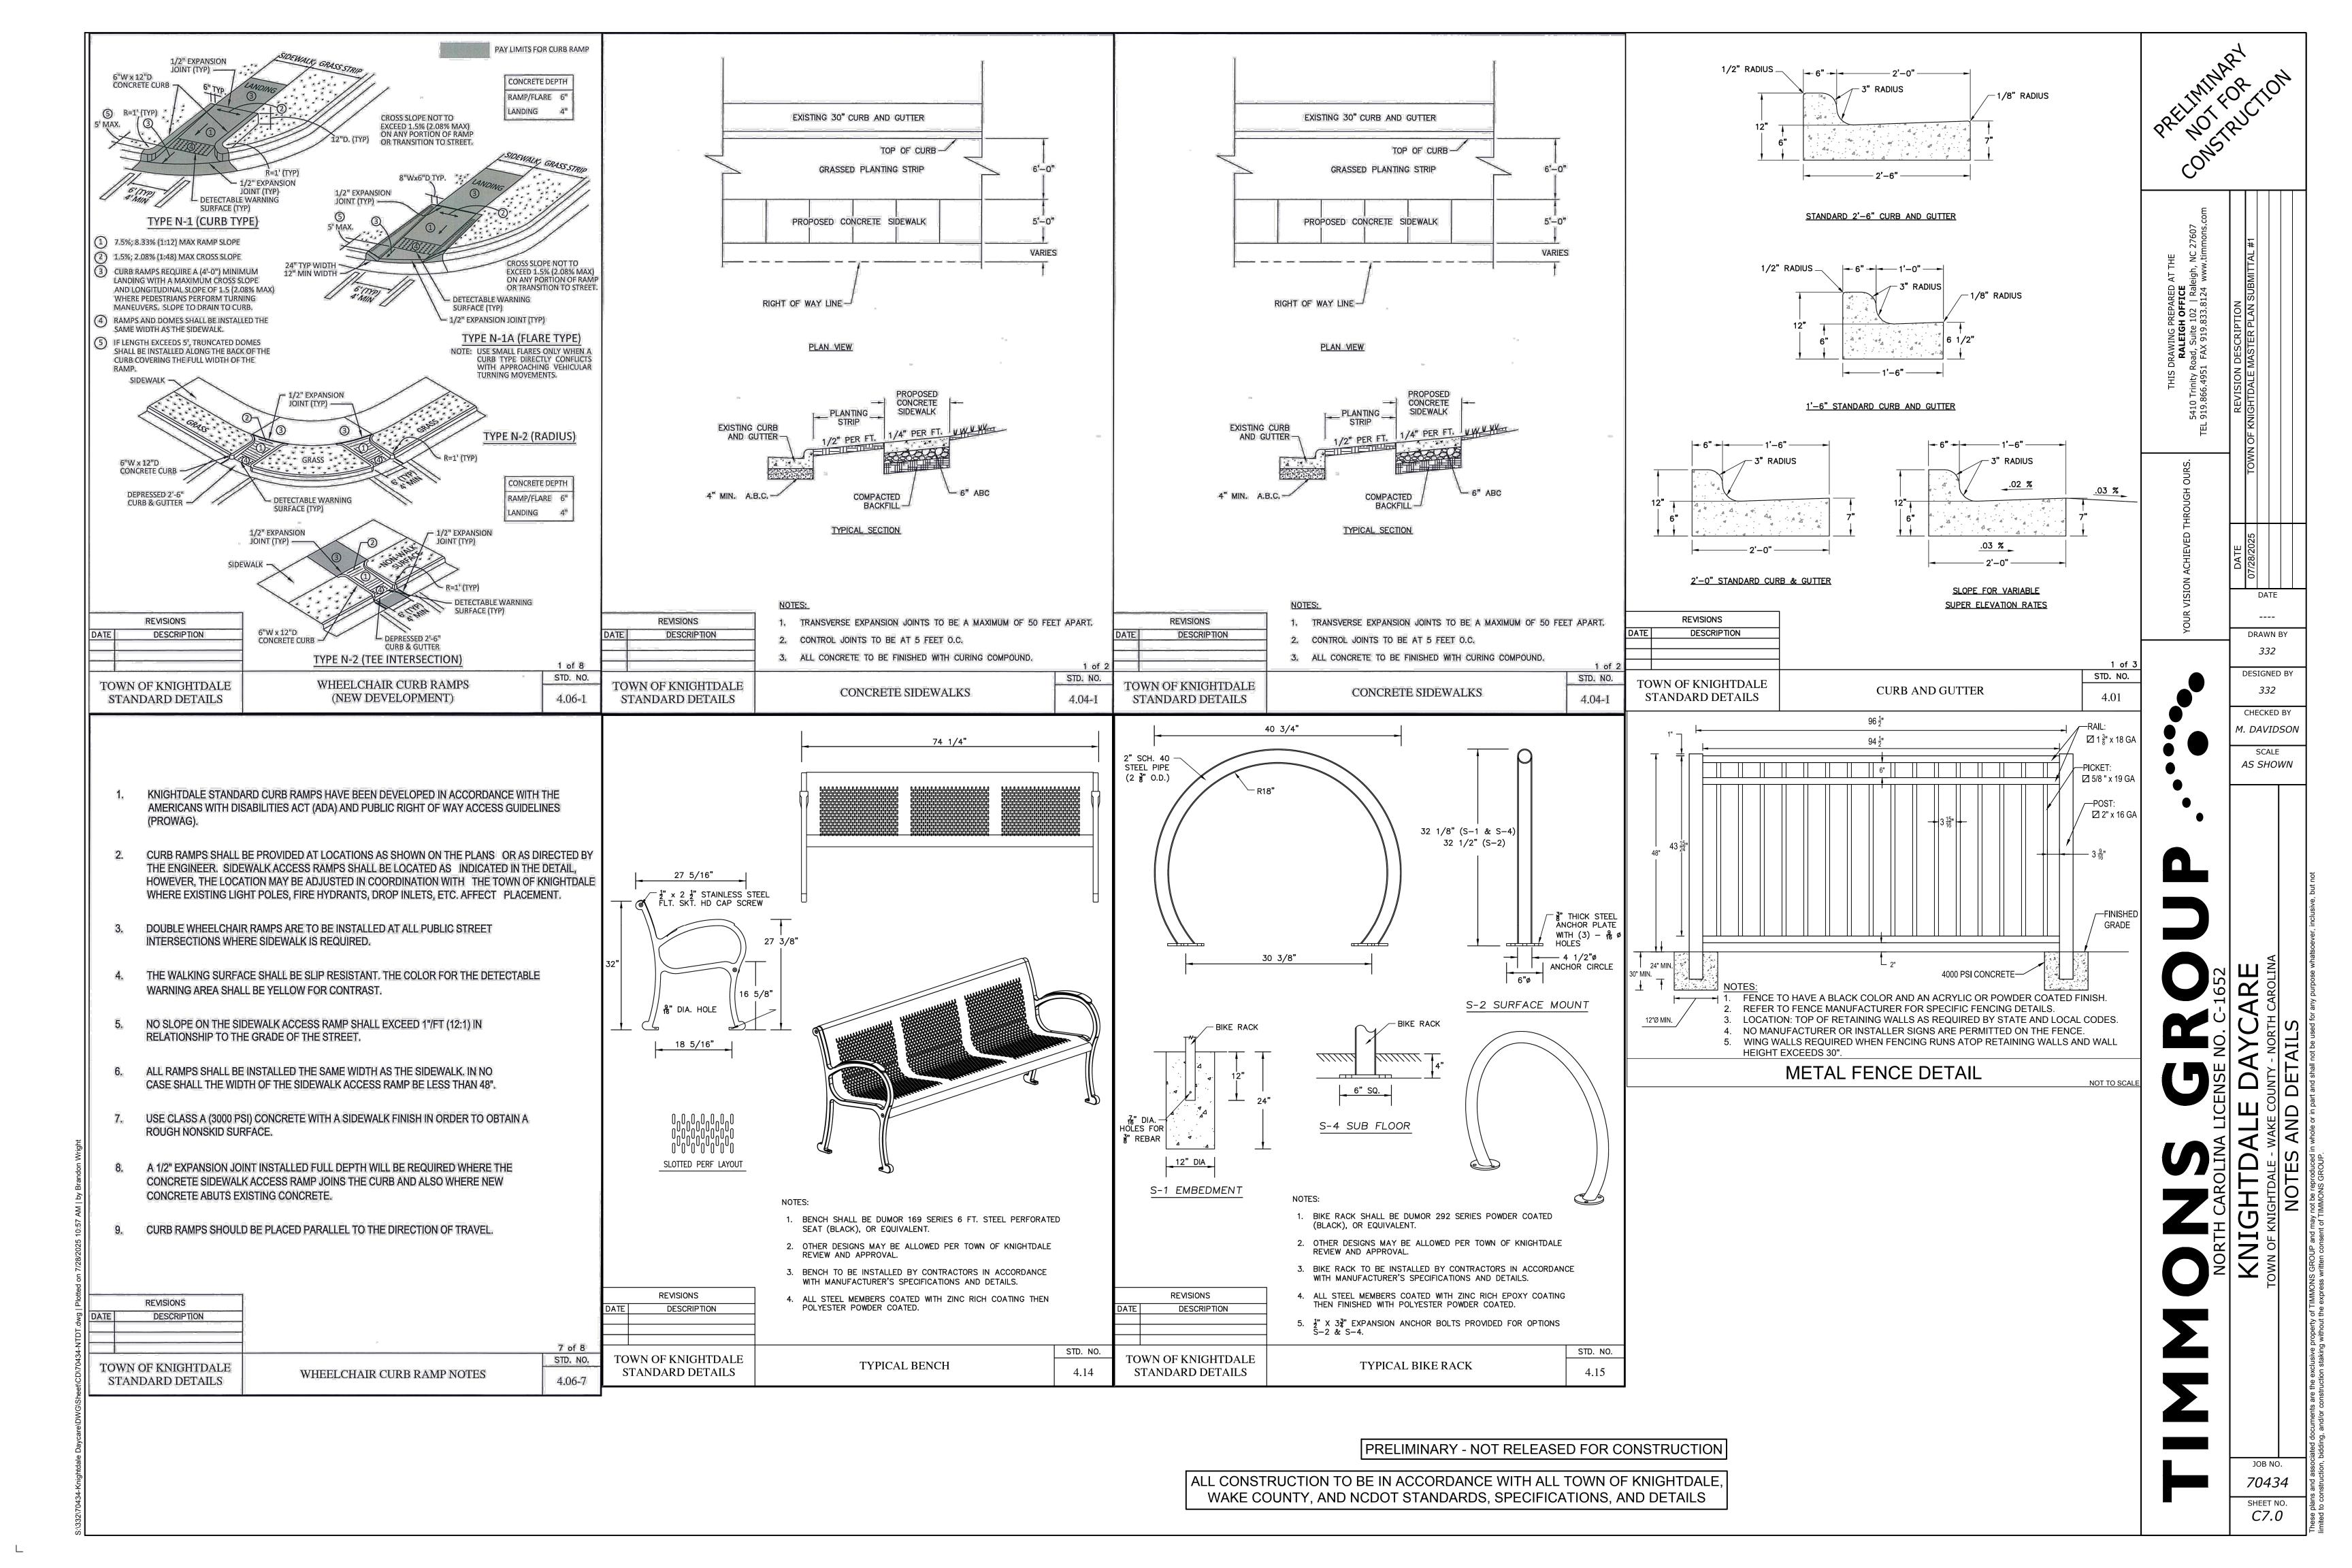

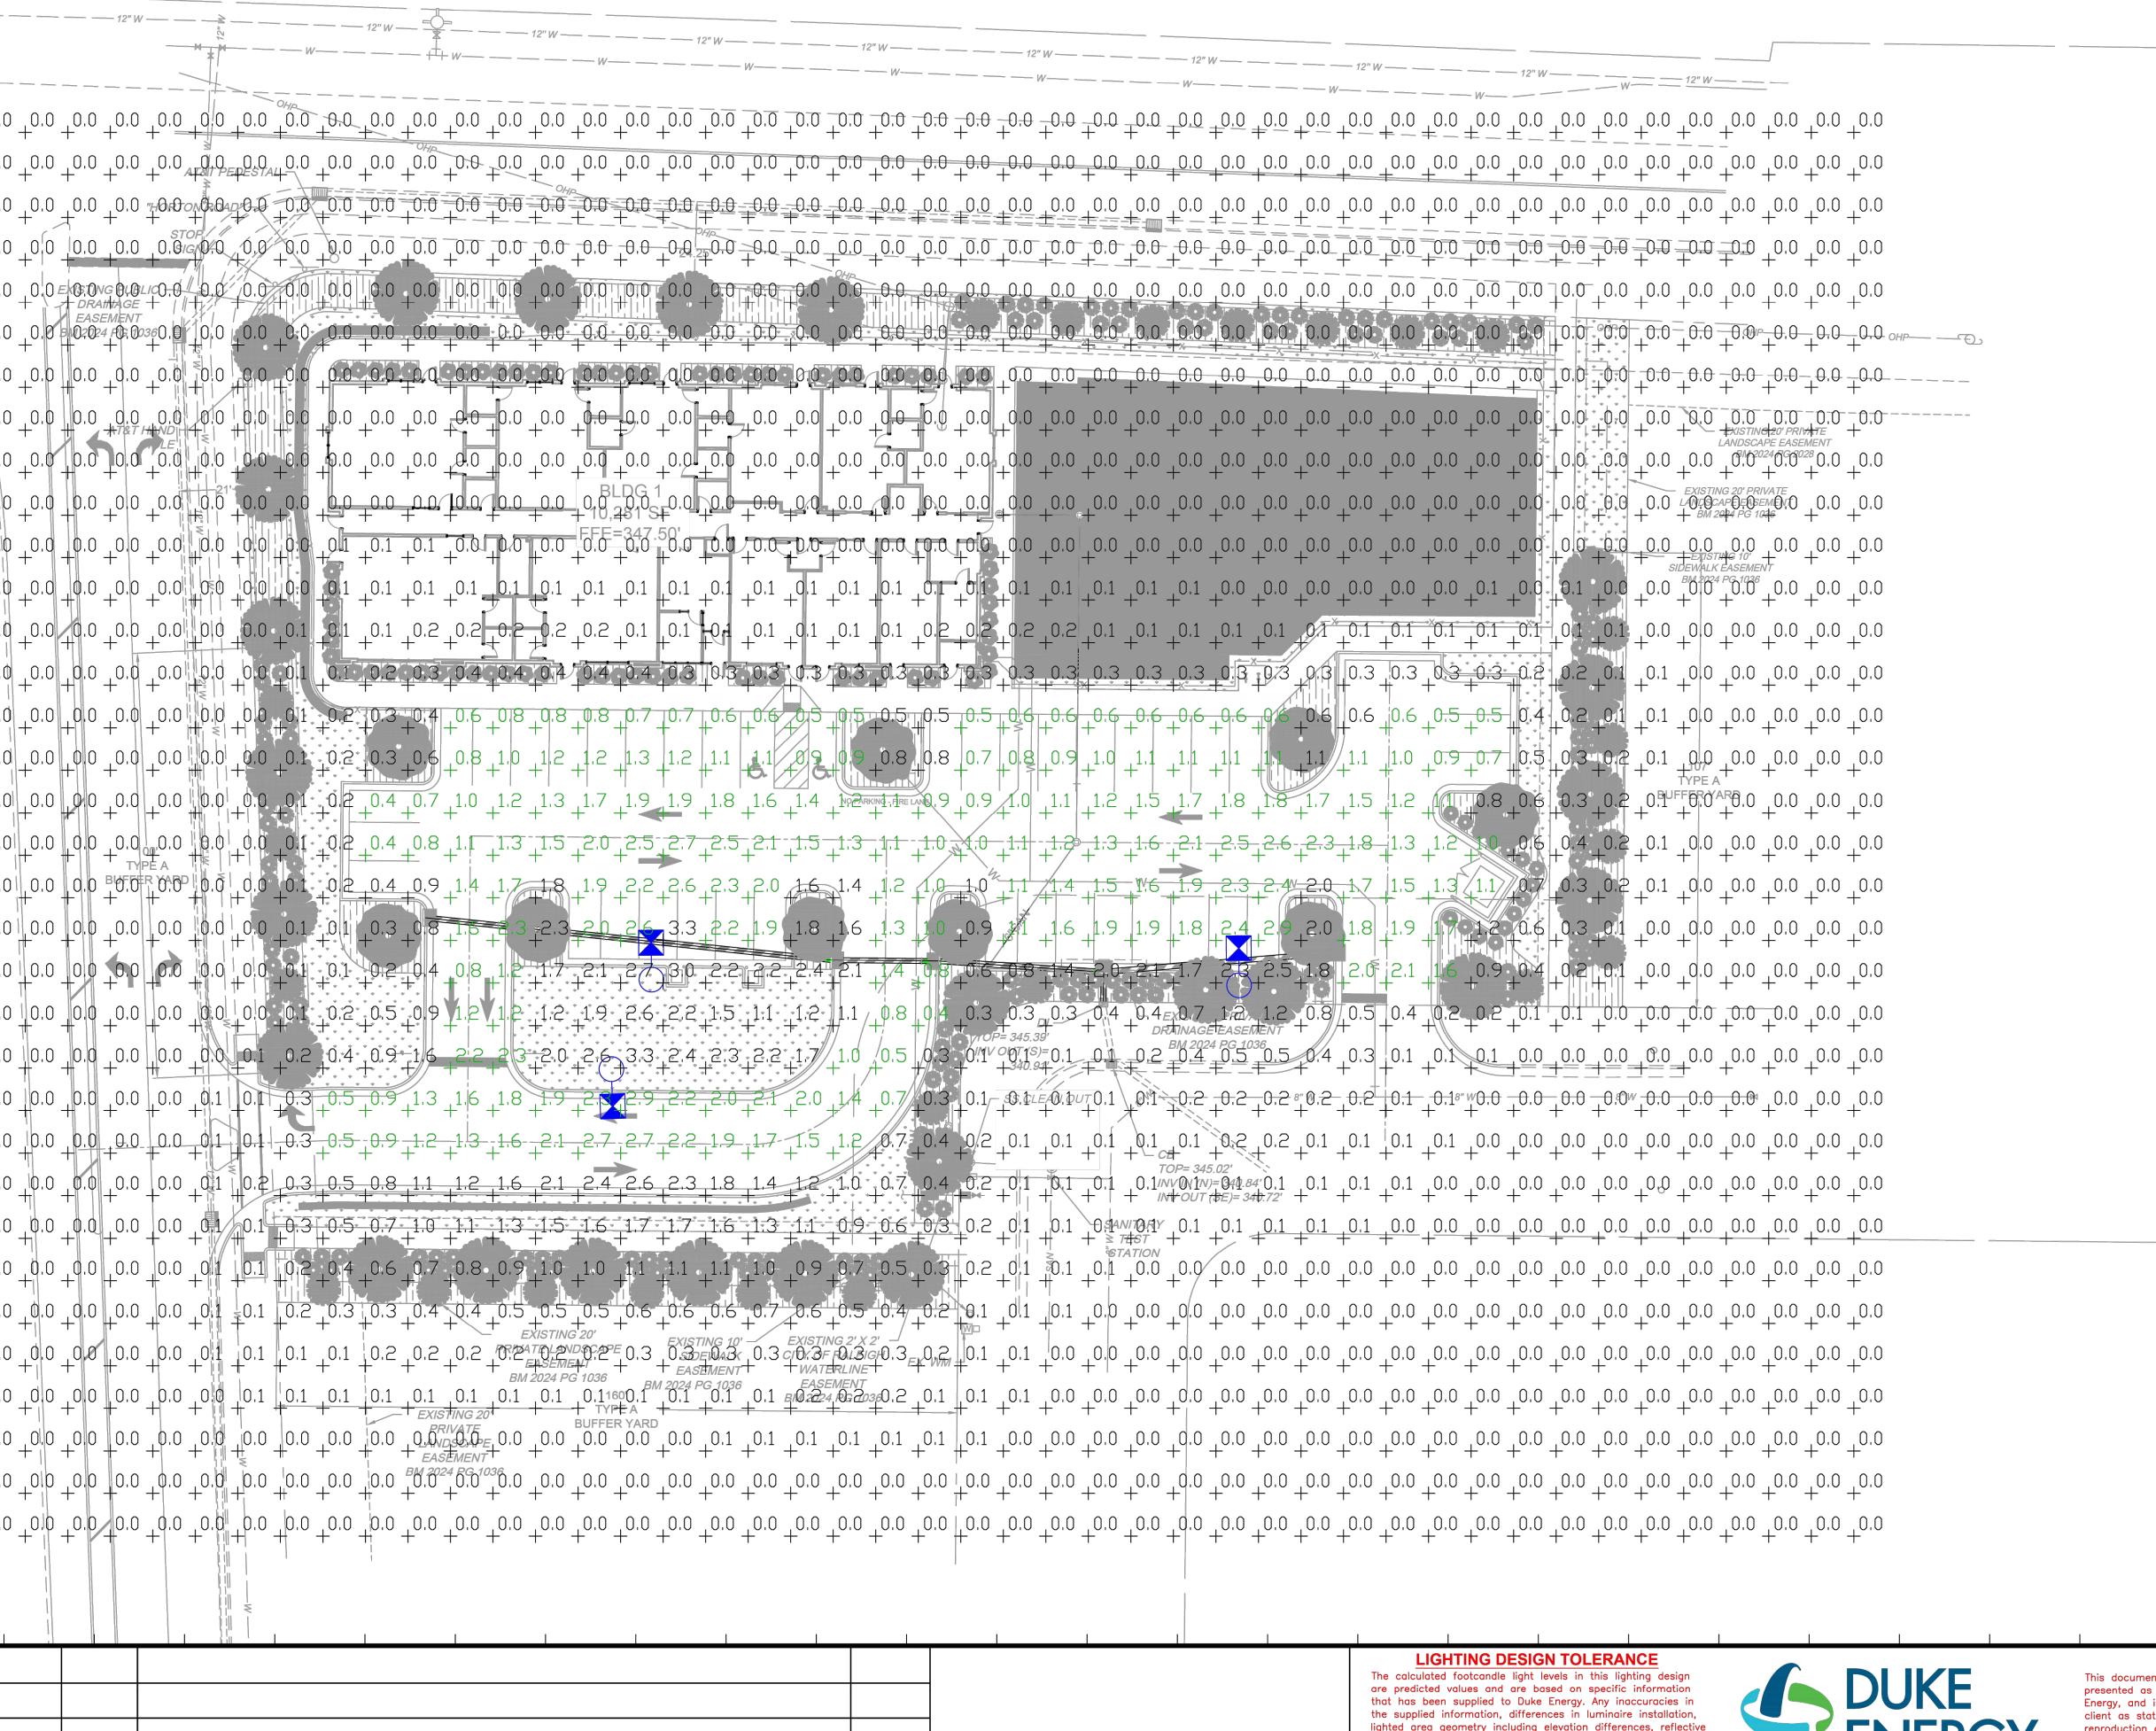

BY

NO. DATE

REVISION



NTUBE LEDISON SHORBOX

ANYTHIG HEIGHT ES FT

PULL ABSYN LFUL-NB-SIT-ESYT-BLK-SG-_P GLACIO

BRANCH ASSYN LFUL-NB-SIT-ESYT-BLK-SG-_P GLACIO

BRANCH ASSYN LFUL-SIDE-EIN-BLK-WA-SIT-__P GLACIO LUMENS - 18459
PATTERN TYPE IV 33-U0-G4 Czero Ught at or above 90 degrees)
NUTE: THE FUNTCANDLE READINGS BELOW ARE MAINTAINED AND HAVE
BEEN BEPRECIATED FOR LED LUMEN EMPRECIATION AND
LUMENAIRE BIRT DEPRECIATION, FOR JUSTIAL FOOTCANDLES,
DIVIDE THE READINGS BELOW 97, 68. LEGEND COUTER to INNERD: 0.10 , 0.25 , 0.50 , 1.00 , 1.25

Schedul	e					
Symbol	Label	Quantity	Description	Number Lamps	Lumens Per Lamp	Light Loss Factor
×	В	3	LED 150W Shoebox - Type IV - 4000K	48	385	0.85

Statistic	T S					
Description	nSymbol	Avg	Max	Min	Max/Min	Avg/Min
Parking	Ж	1.4 fc	3,3 fc	0.3 fc	11.0:1	4.7:1

lighted area geometry including elevation differences, reflective properties of surrounding surfaces, obstructions (foliage or otherwise) in the lighted area, or lighting from sources other than listed in this design may produce different results from the predicted values. Normal tolerances of voltage, lamp output, and ballast and luminaire manufacture will also affect



PROPRIETARY & CONFIDENTIAL

This document together with the concepts and designs presented herein, presented as an instrument of service, is the sole property of Duke Energy, and is intended only for the specific purpose and prospective client as stated in the title block of this drawing. Any use, copying, reproduction or disclosure of the drawing, design or any information contained herein by the prospective customer or other entities, including without limitation, architects, engineers, or equipment manufacturers is hereby expressly prohibited and shall not be permitted absent prior written consent from, and payment of compensation to Duke Energy. Duke Energy disclaims any liability or responsibility for any unauthorized use of or reliance on this document.


KNIGHTDALE DAYCARE							
	KNIGHTDALE, NC						
		NG ARRANGI					
Designed by DUKE ENERGY PROGRESS LIGHTING SOLUTION							
Reviewed by		Scale					
Date6/24/202	25	Size	Drawing	size "D"			
Description LE	D Shoebox						
Drawing No		280A	Sht	1 OF 1			



	EXTERIOR FINISHES & MATERIALS SCHEDULE							
MARK	DESCRIPTION	MANUFACTURER	MODEL	FINISH	PATTERN	REMARKS		
BR-1	BRICK VENEER	ACME	CITYSCAPE	SNOWDRIFT	MODULAR, VELOUR	-		
BR-2	BRICK VENEER	ACME	CITYSCAPE	DICKENS CREEK	MODULAR, VELOUR	-		
GL-1	GLAZING	-	-	CLEAR. LOW-E	-	1" TEMPERED, INSULATED		
MS-1	STONE SILL	READING ROCK	ROCKCAST	SMOOTH, CRYSTAL WHITE	-	=.		
MTL-1	POWDER COATED STEEL	-	-	-	-	-		
SD-1	PLANK LAP SIDING	JAMES HARDIE		CEDARMILL	NAVAJO BEIGE			
SSR-1	STANDING SEAM ROOFING	G&J AWNING		MANSARD BROWN				
ST-1	EXTERIOR INSULATION FINISH SYSTEM	DRYVIT	OUTSULATION	#111 PRAIRIE CLAY	SANDPEBBLE DPR	-		
TR-1	FIBERCEMENT TRIM BOARD	JAMES HARDIE	-			-		
TR-2	FIBERCEMENT TRIM BOARD	JAMES HARDIE	-			-		
TR-3	FIBERCEMENT TRIM BOARD	JAMES HARDIE	-			-		
TR-4	FIBERCEMENT TRIM BOARD	JAMES HARDIE	-			-		
TR-5	FIBERCEMENT TRIM BOARD	JAMES HARDIE	=			-		

MATERIAL CALCULATIONS							
ELEVATION	GLAZING LINEAR %						
NORTH	79%	21%		45%			
EAST	62%	38%		31%			
SOUTH	51%	49%		44%			
WEST	50%	50%		54%			

EXTERIOR ELEVATION - SOUTH

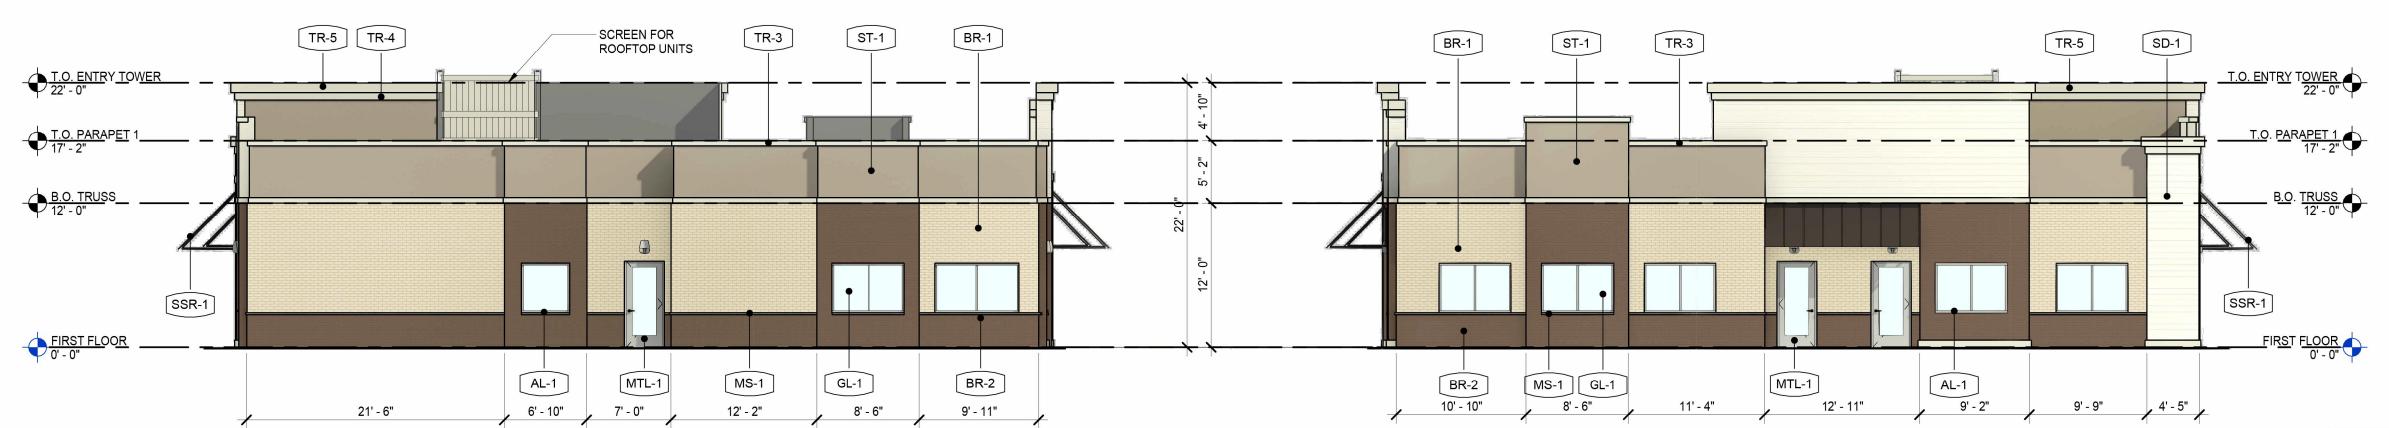

EXTERIOR ELEVATION - EAST





OLD KNIGHT RD. & HORTON RD. KNIGHTDALE, NC 27545

General Building Design Requirements

Per UDO Chapter 6

A. Architectural Style. The building design standards of this Chapter intentionally do not mandate a particular style and permit a wide variety of architectural unless the local architectural vernacular in the region provides an alternate precedent for a detail.

B. Frontage. All buildings shall share a frontage line (primary façade) with a street or square. (Exception: Buildings that are interior to a site that has buildings that otherwise meet the frontage requirement) C. Termination of Vistas. Important street vistas (such as along Town gateways and primary pedestrian streets) should terminate in a focal point, such as a building or

other architectural or natural feature. D. Compatibility. Adjacent buildings should relate in similarity of scale, height, architectural style, and/or configuration. Exceptions to this rule include civic buildings such as churches and schools which through their massing and height serve as landmarks for the community.

E. Proportions. Vertically proportioned windows (height exceeds width), doors, columns, eaves, parapets, and other building components shall be proportional to the overall scale of the building.

Wall Materials.

1. Buildings shall be designed in compliance with four-sided design standards, with visually interesting and compatible design on front, side and rear façades. 2. Walls of apartment, mixed-use, and nonresidential buildings shall be clad pursuant to the following regulations. Material percentages exclude windows, display windows, doors, roofing, fascia, and soffit materials.

a. Primary Materials. At least 50% of a building's facades shall be brick, stone (natural/cultured, limestone, marble, or granite), or a combination thereof. b. Secondary Materials. Not more than 50% of a building's facades shall be clapboard, stucco, cementitious fiber board, glass, decorative concrete masonry units (CMU), or exterior insulation finishing systems (EIFS).

c. Accent Materials. Not more than 20% of a building's facades shall be wood shingle, wood drop siding, wood board and batten, or decorative metal panels.

3. When two or more materials are used on a façade, the heavier material (i.e. stone, brick) should be placed below the lighter material (i.e. siding, shakes) to give the sense of support and grounding.

Façade Articulation.

Buildings shall not have long, monotonous, uninterrupted walls of twenty (20) feet or more on any floor of a façade clearly visible from a public right-of-way. Verticallyproportioned windows and spandrel glass, doors, stairwells, porches, pilasters (minimum twelve [12] inch width with minimum one to four (1:4) projection to width ratio), and other architectural elements as approved by the DRC will be used in order to: add architectural interest and variety; relieve the visual effect of a single, long wall; and subdivide a horizontal wall into human-scale vertical proportions.

1. Flat roofs and roof pitches less than three to twelve (3:12) will require a parapet wall along all sides visible from a public street. 2. All pitched roofs shall be profiled by eaves projecting a minimum of ten (10) inches from the building face which may include gutters.

3. Eaves may expose rafters. K. Rooftop Equipment. All rooftop equipment shall be screened from view from any public right-of-way through the use of parapet walls

and/or a central screened corral.

Signs erected parallel to the façade of any building or yard wall (Section 7.6) to which it is attached and supported throughout its entire length by the building or yard wall face shall:

1. Preferably be located between the top of the first floor window and the sill of the second floor window, or on a sign frieze area;

2. Project no more than twelve (12) inches from the building wall; 3. Not obscure architectural features;

4. Be integrated with the design of the building;

5. Not cover any window or part of a window; and 6. Not extend above a parapet.

7. Not placed on a roof or mansard roof.

8. Number of Signs.

a. A maximum of one (1) primary wall sign shall be permitted per lot facade of a single-tenant building or unit of a multi-tenant building. b. A maximum of three (3) secondary wall signs may be authorized for buildings with a façade width in excess of seventy-five (75) feet by the Land Use Administrator provided such additional signage is:

i. In keeping with the overall design and architecture of the building; ii. A minimum of twenty (20) feet from the primary wall sign and other secondary wall signs;


iii. A maximum of fifty (50) percent of the size of the façade's primary wall sign;

iv. Accessory to the façade's primary wall sign; and v. The total area of all primary and secondary wall signs does not exceed the maximum wall sign area as established in Section 8.5.

25002372A

Drawing Number:

07/25/2025

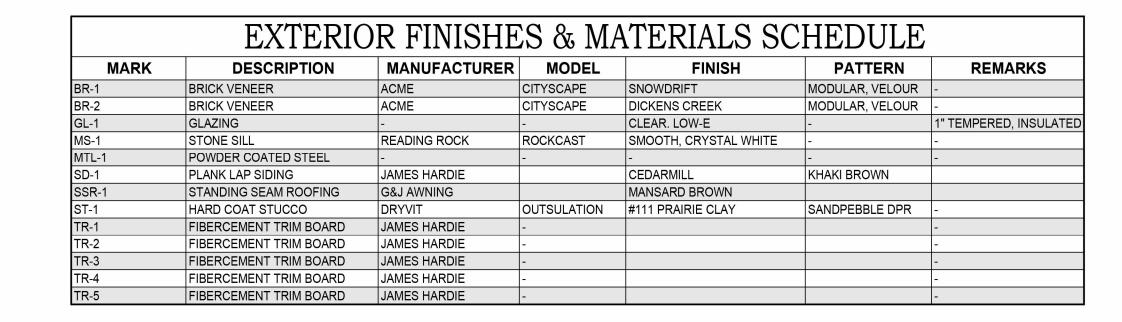

<u>SIDING</u>



KHAKI BROWN



ARCTIC WHITE

OLD KNIGHT RD. & HORTON RD. KNIGHTDALE, NC 27545

PR03







OLD KNIGHT RD. & HORTON RD. KNIGHTDALE, NC 27545

PR04