
BIG OAK VET HOSPITAL

MASTER PLAN TOWN OF KNIGHTDALE TOK Project# ZCP-11-24



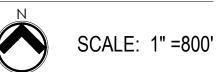

	SHEET INDEX
L/	ANDSCAPE ARCHITECTURE
COV	COVER
L001	STANDARD NOTES
L100	EXISTING CONDITIONS PLAN
L101	DEMOLITION PLAN
L200	LAYOUT PLAN
L201	HARDSCAPE PLAN
L202	VICINITY MAP
L203	SIGNS & PAVEMENT MARKINGS
L204	SITE DETAILS
L205	SITE DETAILS
L206	SITE DETAILS
L207	SITE DETAILS
L208	TOWN DETAILS
L209	TOWN DETAILS
L300	GRADING PLAN
L400	PLANTING PLAN
L401	FULL PLANTING SCHEDULE
L402	PLANTING DETAILS
L500	LIGHTING PLAN
	CIVIL
C-400	UTILITY PLAN
C-401	UTILITY DETAILS
C-500	STORMDRAIN & STORMWATER MANAGEMENT PLAN
C-501	STORMDRAIN DETAILS
	ARCHITECTURE
A1.1	ARCHITECTURAL FLOOR PLAN
A2.1	SOUTH ELEVATION
A2.2	WEST ELEVATION
A2.3	NORTH ELEVATION
A2.4	EAST ELEVATION
A3.1	CROSS SECTIONS
A4.0	MATERIAL BOARD

PROPOSED S	ITE DATA
PROPOSED	
PROJECT NAME	BIG OAK VET HOSPITAL
PROPOSED USE	ANIMAL SERVICES, NON BOARDING
PARKING	
REQUIRED	
MAX: 6 PER 1,000 GFA	35 SPACES
MIN: $\frac{1}{2}$ MAXIMUM	18 SPACES
PROVIDED	
STANDARD SPACES	29 SPACES
ADA SPACES	2 SPACES
ELECTRIC CHARGING: 1 PER 40	2 SPACES
TOTA	L 33 SPACES
BICYCLE PARKING	
REQUIRED: 1 PER 40 SPACES (MIN. 2 SPACES)	2 SPACES
PROVIDED: 1 PER 40 SPACES	2 SPACES
TOTA	L 2 SPACES
IMPERVIOUS SURFACE AREA	
EXISTING	11,239 SF
PROPOSED	
BUILDING	5,815 SF
CONCRETE	3,050 SF
ASPHALT	15,847 SF
TOTAL AREA PROPOSE	D 24,712 SF
PERCENT OF THE SIT	E 61%
NET CHANGE OF IMPERVIOU	s 13,473 SF
AREA FOR STORMWATER DEVICE	
PROVIDED	1,500 SF

EVICTING CITE DATA			
EXISTING SITE DATA			
EXISTING STREET ADDRESS	1004 BIG OAK COURT, KNIGHTDALE NC		
LOT AREA (CURRENT)	46,677 SF / 1.07 AC		
CURRENT ZONING	NMX		
PARCEL NUMBER	1744445693		
REID	0195735		
DEED BOOK / DEED PAGE	DB 017157, PG 02669		
EXISTING GROSS BUILDING AREA	1,652 SF		
EXISTING BUILDING USE	RESTAURANT		
EXISTING IMPERVIOUS AREA	11,239 SF		

WATER ALLOCATION TABLE

CATEGORY	POINTS	
BASE: SINGLE USE OFFICE	41	
BONUS 1A: ABATEMENT OF ANY EXISTING NON-CONFORMING STRUCTURES	3	
BONUS 2B: STORMWATER - BIORETENTION	5	
BONUS 3A: ENHANCED ROADSIDE LANDSCAPING AND HARDSCAPING 2	2	
TOTAL	51	

CONTACT INFORMATION

OWNER
ROWDY RIDGEBACKS HOLDINGS LLC
325 NASH ST E
WILSON NC 27893-4130

PHONE: 919.266.9852

LANDSCAPE ARCHITECT
SITE COLLABORATIVE, INC.
1620 HILLSBOROUGH ST. SUITE 100
RALEIGH, NC 27605
CONTACT: GRAHAM H. SMITH
PHONE: 919.805.3586


EMAIL: GRAHAM@SITECOLLABORATIVE.COM

ENGINEER

RESPEC
555 FAYETTEVILLE ST. SUITE 300
CONTACT: TRAVIS TYBOROSKI
PHONE: 919.230.1597

EMAIL: TRAVIS.TYBOROSKI@RESPEC.COM

ARCHITECT
CLINE DESIGN ASSOCIATES
125 N. HARRINGTON ST
RALEIGH, NC 27603
CONTACT: KELLY SYNNOTT
PHONE: 919.833.6413
EMAIL: KELLYS@CLINEDESIGNASSOC.COM

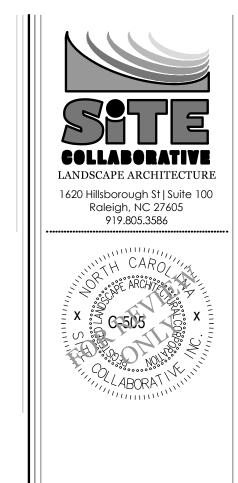

REUSE OF DOCUMENT
This document is the property of Site
Collaborative Inc. The ideas and design
incorporated on this document is an
instrument of professional service and
shall not be used for any other project
without written authorization of Site
Collaborative Inc.

BIG OAK VET HOSPITA VETS PETS 1004 BIG OAK COURT

PROJECT NUMBER:

TOK PROJECT #: ZCP-11-24

PROJECT PHASE:

MASTER PLAN

DATE: 08.11.2025

-- -- --

SHEET TITLE:

COVER SHEET

COV

DEMOLITION NOTES

- THE CONTRACTOR SHALL NOTIFY THE N.C. ONE CALL CENTER AT 811 OR 1-800-632-4949 PRIOR TO STARTING WORK.
- 2. THE CONTRACTOR SHALL NOTIFY THE LOCAL GOVERNING PUBLIC UTILITIES DEPARTMENT PRIOR TO STARTING WORK.
- 3. ALL DEMOLITION, AND ANY SUBSEQUENT CONSTRUCTION, SHALL BE PERFORMED IN ACCORDANCE WITH THESE PLANS AND SPECIFICATIONS SET FORTH AND APPROVED BY THE LOCAL GOVERNING MUNICIPALITY OR THE STATE. THE CONTRACTOR IS RESPONSIBLE FOR OBTAINING ALL REQUIRED PERMITS.
- 4. THE CONTRACTOR SHALL NOT MAKE ANY LANE CLOSURES OR CHANGES TO THE EXISTING TRAVEL PATTERNS ON ANY PUBLIC STREET WITHOUT PRIOR APPROVAL FROM THE LOCAL GOVERNING MUNICIPALITY TRANSPORTATION DEPARTMENT AND/OR STATE TRANSPORTATION DEPARTMENT.
- 5. LANE CLOSURE, TRAFFIC CONTROL PLAN, OR PEDESTRIAN CONTROL PLAN TO BE COORDINATED WITH APPROPRIATE STAFF OF THE LOCAL GOVERNING MUNICIPALITY AND/OR STATE DEPARTMENT OF TRANSPORTATION PRIOR TO ANY CONSTRUCTION IN PUBLIC RIGHT-OF-WAY
- THE CONTRACTOR IS RESPONSIBLE FOR CONFORMING TO ALL LOCAL, STATE AND FEDERAL REQUIREMENTS REGARDING REMOVAL AND DISPOSAL OF MATERIALS AND DEBRIS.
- 7. CONTRACTOR SHALL REFER TO CIVIL SHEETS FOR SANITARY SEWER AND WATER REMOVALS AND RELOCATIONS.
- RELOCATION OF EXISTING UTILITIES TO BE COORDINATED WITH THE LOCAL UTILITY PROVIDER(S).
- WHERE UTILITIES (TO BE REMOVED) IMPACT THE FOOTPRINT OF THE NEW BUILDING, CONTRACTOR SHALL EXCAVATE AND REMOVE AN ADDITIONAL 2 FEET OF SOILS TO EITHER SIDE OF PIPE, AND 1 FOOT BELOW TO REMOVE UNSUITABLE SOILS, IF UNSUITABLE SOILS EXIST.
- 10. CLEANOUTS LOCATED IN AREAS OF DEMOLITION OR SUBSEQUENT CONSTRUCTION THAT ARE TO REMAIN, SHALL BE PROTECTED FROM DAMAGE AND RAISED TO FLUSH WITH NEW GRADE.
- 11. ELECTRICAL OR GAS UTILITY SERVICES TO BE REMOVED SHALL BE REMOVED AND RELOCATED (AS INDICATED) BY THE UTILITY PROVIDER. CONTRACTOR SHALL SCHEDULE AND COORDINATE THIS WORK WITH THE APPROPRIATE SERVICE PROVIDER. ALL SERVICES SHOULD BE RE-INSTALLED PRIOR TO THE INSTALLATION OF PAVEMENT, SIDEWALKS, CURB AND GUTTER, OR OTHER PERMANENT FEATURES.
- 12. REMOVE EXISTING CONCRETE (WHERE REQUESTED) TO FIRST COLD JOINT OR SAWCUT JOINT TO OBTAIN A CLEAN EDGE FOR NEW CONSTRUCTION. SAWCUT EXISTING ASPHALT DRIVE AT LIMITS OF NEW CURBING TO OBTAIN A CLEAN EDGE
- 13. CONTRACTOR SHALL RETAIN AND STOCKPILE CONCRETE WHEELSTOPS WHICH ARE IN USEABLE CONDITION FOR RE-INSTALLATION AT THE END OF THE PROJECT.
- CONTRACTOR SHALL RESTORE THE LAYDOWN AND STAGING AREA TO ORIGINAL CONDITIONS AND TO THE SATISFACTION OF THE OWNER, PRIOR TO DEMOBILIZATION AT THE CONCLUSION OF THE PROJECT.
- 15. CLEAN SOILS SHALL BE UTILIZED FOR BACKFILL. COMPACTION OF THESE SOILS PERFORMED IN ACCORDANCE WITH SPECIFICATIONS, GEOTECHNICAL REPORT, AND SITE PLAN.
- 16. ALL FENCING TO BE REMOVED SHALL BE REMOVED AT NEXT NEAREST POLE.
- 17. ALL GRAVEL TO BE REMOVED (SURFACE OR SUBSURFACE) SHALL BE STOCKPILED AND REUSED ON SITE WHERE POSSIBLE.
- 18. ALL ITEMS DESIGNATED TO BE REMOVED SHALL BE REMOVED COMPLETELY, INCLUDING ALL SUBGRADE MATERIALS DIRECTLY ASSOCIATED WITH ITEMS TO BE REMOVED.
- 19. ALL ITEMS DESIGNATED TO BE REMOVED SHALL BE DISPOSED OF LEGALLY OFFSITE UNLESS OTHERWISE NOTED ON THIS PLAN.
- 20. ALL TREES TO BE REMOVED SHALL BE GROUND DOWN TO A MINIMUM DEPTH OF 12" BELOW PROPOSED FINISH GRADE.
- 21. ALL TREE PROTECTION FENCING SHALL REMAIN IN PLACE DURING DEMOLITION AND CONSTRUCTION.
- 22. CONTRACTOR SHALL NOT STOCKPILE SOILS OR CONSTRUCTION EQUIPMENT WITHIN ROOT ZONES OF EXISTING TREES TO REMAIN. ANY DAMAGED TREES SHALL BE REPLACED AT CONTRACTOR'S

GRADING NOTES

- 1. ORIGINAL EXISTING CONDITIONS SHOWN AS 'EXISTING' IN THIS PLAN SET HAS BEEN COMPILED FROM SURVEY DATA PROVIDED BY JAECO. CONTRACTOR TO FIELD VERIFY ALL INFORMATION AND REPORT ANY DISCREPANCIES.
- 2. ALL DIMENSIONS AND GRADES SHOWN ON THE PLANS SHALL BE FIELD VERIFIED BY THE CONTRACTOR PRIOR TO CONSTRUCTION. CONTRACTOR SHALL NOTIFY LANDSCAPE ARCHITECT IF ANY DISCREPANCIES EXIST PRIOR TO PROCEEDING WITH CONSTRUCTION FOR NECESSARY PLAN OR GRADE CHANGES. NO EXTRA COMPENSATION SHALL BE PAID TO CONTRACTOR FOR ANY WORK DONE DUE TO DIMENSIONS OR GRADES SHOWN INCORRECTLY ON THESE PLANS IF SUCH NOTIFICATION HAS NOT BEEN GIVEN.
- 3. ALL PAVEMENTS TO SLOPE POSITIVELY AWAY FROM ALL BUILDINGS. PONDING OF WATER IS PROHIBITED.
- 4. THE GENERAL CONTRACTOR IS RESPONSIBLE FOR MAINTENANCE OF EROSION CONTROL METHODS DURING CONSTRUCTION, AND THE OWNER IS RESPONSIBLE FOR MAINTENANCE OF ALL PERMANENT EROSION CONTROL METHODS AFTER CONSTRUCTION IS COMPLETE, IF ANY PERMANENT METHODS ARE REQUIRED.
- CONSTRUCTION AND MAINTENANCE OF ALL EROSION CONTROL DEVICES SHALL CONFORM TO THE STANDARDS SET FORTH IN THE CITY OF RALEIGH EROSION AND SEDIMENT CONTROL MANUAL.
- 6. INSPECTOR REFERS TO AUTHORIZED REGULATORY AGENCY SEDIMENTATION AND EROSION CONTROL INSPECTOR OR HIS/HER REPRESENTATIVE. FIELD INSPECTIONS MAY REQUIRE ADDITIONAL SEDIMENTATION AND EROSION CONTROL MEASURES AS DEEMED NECESSARY BY THE INSPECTOR. CLIENT. AND/OR CLIENT'S REPRESENTATIVES.
- 7. WHEN HAND PLANTING, MULCH (HAY OR STRAW) SHOULD BE UNIFORMLY SPREAD OVER SEEDED AREA WITHIN 24 HOURS OF SEEDING
- 8. DURING UNSUITABLE GROWING SEASONS, MULCH WILL BE USED AS A TEMPORARY COVER ON SLOPES THAT ARE 4:1 OR STEEPER, MULCH WILL BE ANCHORED.
- 9. EROSION AND SEDIMENT CONTROL DEVICES MUST BE INSTALLED AND INSPECTED PRIOR TO ANY GRADING ON SITE. PLEASE CALL THE REGULATORY AUTHORITY FOR AN INSPECTION.
- 10. INSPECT AND MAINTAIN ALL EROSION CONTROL MEASURES EVERY 7 DAYS AND AFTER EACH SIGNIFICANT RAINFALL (0.5 INCHES OR GREATER) AND DOCUMENT WITH INSPECTION REPORTS.
- 11. EACH DEVICE IS TO BE MAINTAINED OR REPLACED IF SEDIMENT ACCUMULATION HAS REACHED ONE HALF THE CAPACITY OF THE DEVICE.
- 12. LOCATE STOCKPILES UPSLOPE FROM EROSION CONTROL MEASURES. ALL SOIL STOCK PILES SHALL HAVE APPROPRIATE EROSION CONTROL PER THE LATEST VERSION OF THE CITY OF RALEIGH EROSION AND SEDIMENT CONTROL MANUAL INCLUDING SEEDING AND SILT FENCE AROUND THE BASE OF THE STOCK PILE.

GENERAL SITE NOTES

- 1. ALL CONSTRUCTION IN RIGHT-OF-WAY PER TOWN OF KNIGHTDALE STANDARD
- SIDEWALKS ALONG RIGHT-OF-WAY ARE PUBLIC AND MUST BE ACCESSIBLE TO PERSONS WHO ARE BLIND, HAVE LOW VISION AND PEOPLE WITH MOBILITY DISABILITIES. EXISTING PEDESTRIAN ROUTES AND ALTERNATE PEDESTRIAN ROUTES DURING CONSTRUCTION ARE REQUIRED TO BE COMPLIANT WITH THE PUBLIC RIGHTS OF WAY ACCESSIBILITY GUIDELINES (PROWAG), 2010 ADA STANDARDS FOR ACCESSIBLE DESIGN AND THE MANUAL ON UNIFORM TRAFFIC CONTROL DEVICES (MUTCD).
- ALL PAVEMENTS TO SLOPE POSITIVELY AWAY FROM ALL BUILDINGS.PONDING OF WATER IS PROHIBITED.
- 4. PROVIDE CONSTRUCTION JOINTS IN CONCRETE WALKWAYS AS SHOWN IN PLANS. IF NOT SHOWN ON PLANS - MAX SPACING @ 10'
- THROUGHOUT PROJECT SITE, ALL DIMENSIONS TO BE FIELD VERIFIED. NOTIFY THE LANDSCAPE ARCHITECT OF ANY DISCREPANCY. ALL DIMENSIONS ARE TO OUTSIDE FACE OF BUILDING, TO CENTERLINE, CENTER TO CENTER ON STRIPES, AND/OR FACE OF CURB, UNLESS OTHERWISE NOTED.
- 6. BUILDING AND PUBLIC ROADWAY STAKE OUT SHALL BE PERFORMED BY A REGISTERED LAND SURVEYOR.
- GUARDRAILS MUST BE INSTALLED ON THE OPEN SIDES OF ELEVATED WALKING SURFACES THAT EXCEED 30 INCHES IN HEIGHT. ALL GUARDRAILS MUST BE A MINIMUM HEIGHT OF 42 INCHES ABOVE THE LEADING EDGE OF THE TREAD OR WALKING SURFACE. GUARDRAILS SHALL HAVE BALUSTERS SUCH THAT A 4 INCH DIAMETER SPHERE CANNOT PASS THROUGH ANY OPENING UP TO A HEIGHT OF 34 INCHES. FROM 34 INCHES TO 42 INCHES ABOVE THE WALKING SURFACE, A 8 INCH DIAMETER SPHERE SHALL NOT PASS.
- 8. THE CONTRACTOR, AT ALL TIMES, MUST KEEP THE PREMISES FREE FROM ACCUMULATIONS OF WASTE MATERIALS OR RUBBISH CAUSED BY THE CONTRACTOR, THE CONTRACTOR'S EMPLOYEES OR THE CONTRACTOR'S SUBCONTRACTOR. ALL DEBRIS SHALL BE REMOVED FROM THE PROJECT SITE ON A DAILY BASIS.
- 9. IF DEPARTURES FROM THE DRAWINGS OR SPECIFICATIONS ARE DEEMED NECESSARY BY THE CONTRACTOR, DETAILS OF SUCH DEPARTURES FROM THE CONTRACT DOCUMENTS SHALL BE MADE WITH THE EXPRESS WRITTEN PERMISSION OF THE OWNER.
- 10. LANDSCAPE ARCHITECT AND/OR OWNER DISCLAIM ANY ROLE IN THE CONSTRUCTION MEANS AND/OR METHODS ASSOCIATED WITH THE PROJECT AS SET FORTH IN THESE PLANS.
- 11. EXISTING UTILITIES AND STRUCTURES SHOWN, BOTH UNDERGROUND AND ABOVE, ARE BASED ON A FIELD DATA PROVIDED TO LANDSCAPE ARCHITECT. THE CONTRACTOR SHALL LOCATE EXISTING UTILITIES, UNDERGROUND LINES, AND STRUCTURES AS NECESSARY TO AVOID DAMAGING OR DESTROYING EXISTING SERVICES.
- 12. THE CONTRACTOR IS RESPONSIBLE FOR FIELD VERIFYING THE ACTUAL AND EXACT LOCATION, SIZE, AND MATERIAL COMPOSITION OF ANY EXISTING WATER OR SEWER SERVICE PROPOSED FOR CONNECTION OR USE ON THIS PROJECT. THE RELOCATION OF ANY UTILITY SERVICES REQUIRED TO COMPLETE ANY PORTION OF THESE CONSTRUCTION PLANS.
- 13. CONTRACTOR SHALL MAINTAIN AN "AS BUILT" SET OF DRAWINGS TO RECORD ANY FIELD CHANGES, ALONG WITH ANY PIPING PRIOR TO CONCEALMENT. DRAWINGS SHALL BE GIVEN TO THE OWNER AT THE END OF THE PROJECT
- 14. THE CONTRACTOR IS RESPONSIBLE FOR OBTAINING ALL REQUIRED PERMITS. ALL CONSTRUCTION SHALL BE IN ACCORDANCE WITH PERMITS AS ISSUED, AND ANY AND ALL APPLICABLE STATE, COUNTY AND LOCAL CODES.
- 15. EXISTING IMPROVEMENTS DAMAGED OR DESTROYED DURING CONSTRUCTION SHALL BE REPLACED OR RESTORED TO THEIR ORIGINAL CONDITION, AND TO THE SATISFACTION OF THE OWNER OF THE IMPROVEMENTS.
- 16. THE CONTRACTOR SHALL OBTAIN AND PAY FOR ALL INSPECTIONS, CERTIFICATIONS AND/OR ANY OTHER REQUIREMENTS WHICH MUST BE MET UNDER CONTRACT
- 17. CONTRACTOR SHALL REFER TO ARCHITECTURAL PLANS FOR DETAILS OF BUILDINGS AND **BUILDING DIMENSIONS.**
- 18. CONTRACTOR SHALL COORDINATE CONSTRUCTION OF ALL UNDERGROUND UTILITIES FOR THIS PROJECT WITH THE OWNER'S REPRESENTATIVE PER ALL APPLICABLE REGULATIONS.
- 19. CONTRACTOR SHALL COORDINATE WITH OTHER CONTRACTOR'S ON SITE AND UTILITY PROVIDERS DURING CONSTRUCTION TO ENSURE SMOOTH TRANSITION BETWEEN DISCIPLINES.
- 20. ALL DEMOLITION, AND ANY SUBSEQUENT CONSTRUCTION, SHALL BE PERFORMED IN ACCORDANCE WITH THESE PLANS AND SPECIFICATIONS SET FORTH AND APPROVED BY THE CITY OF RALEIGH. THE CONTRACTOR IS RESPONSIBLE FOR OBTAINING ALL REQUIRED PERMITS. ALL TREE PROTECTION FENCING SHALL REMAIN IN PLACE DURING CONSTRUCTION.
- 21. TRAFFIC CONTROLS FOR ANY UTILITY WORK WITHIN THE PUBLIC RIGHT OF WAY SHALL BE PERFORMED IN COMPLIANCE WITH STANDARDS OF THE NORTH CAROLINA MANUAL ON UNIFORM TRAFFIC CONTROL DEVICES (MUTCD).
- 22. ALL CROSSWALK MARKINGS WITHIN RIGHT-OF-WAY SHALL BE CONSTRUCTED OF THERMOPLASTIC MATERIALS AND CONSTRUCTED IN ACCORDANCE WITH NCDOT SPECIFICATIONS. CONTRACTOR TO INSTALL CROSSWALKS IN SUCH A MANNER THAT CROSSWALKS ARE ALIGNED BETWEEN HANDICAP/WALKWAY ACCESS POINTS OR PERPENDICULAR TO THE ROADWAY / DRIVE LANE.
- 23. ALL SIGNS AND PAVEMENT MARKINGS ARE TO MEET MUTCD (MANUAL ON UNIFORM TRAFFIC CONTROL DEVICES) AND NCDOT STANDARDS.
- 24. ALL SIGNS SHALL USE PRISMATIC SHEETING THAT MEETS MINIMUM RETROREFLECTIVITY STANDARDS FOUND IN THE LATEST EDITION OF THE MUTCD.

PLANTING NOTES

- ROUGH GRADING TO BE COMPLETED PRIOR TO THE START OF PLANT INSTALLATION SUBSTANTIAL COMPLETION SIGN-OFF BY LANDSCAPE ARCHITECT CONTRACTOR TO ENSURE NO CHANNELIZED FLOWS AROUND THE SITE.
- 2. CONTRACTOR RESPONSIBLE FOR LOCATING ALL UTILITIES AND UNDERGROUND IMPEDIMENTS PRIOR TO BEGINNING PLANTING.
- 3. ALL WEEDS, NON-NATIVE INVASIVE SPECIES, AND EXOTIC SPECIES LOCATED WITHIN THE PROJECT CONTRACTOR LIMITS SHALL BE ELIMINATED PRIOR TO PLANTING BED CREATION, PLANTING, AND SEEDING/SODDING OPERATIONS.
- 4. PLANTING SHOULD OCCUR IMMEDIATELY AFTER CONSTRUCTION TO STABILIZE AREAS OF BARE SOIL.
- 5. IT SHALL BE NOTED THAT ALL SECTIONS OF THE SITE THAT ARE SLOPED 3:1 OR HIGHER WILL BE COVERED WITH EROSION CONTROL STABILIZATION COIR FABRIC (WITH 1" SQUARE OPENINGS) PRIOR TO PLANTING TO ENSURE IMMEDIATE STABILIZATION. LANDSCAPE CONTRACTOR SHALL CUT FABRIC AT EACH PLANT LOCATION AND PLACE PLANTS ACCORDING TO PLAN. ALL FABRIC SHALL BE RE-STAKED PER ENGINEERS ORIGINAL DRAWINGS IMMEDIATELY AFTER PLANTING.
- 6. PLANTS ARE TO BE PURCHASED BY BOTANICAL NAMES. THEY SHALL BE REPRESENTATIVE OF THEIR SPECIES, MEET ALL NOTED CONDITIONS OF SPECIFICATIONS, AND SHALL BE IN VIGOROUS GROWING CONDITION MEETING ANSI STANDARD Z60.
- LANDSCAPE ARCHITECT OR OWNER MAINTAINS RIGHT TO REJECT ANY PLANT DUE TO AESTHETICS OR STRUCTURAL DEFICIENCY AT ANY TIME.
- 8. CONTRACTOR RESPONSIBLE FOR FURNISHING AND INSTALLING ALL PLANTS SHOWN ON PLANS IN LOCATIONS SHOWN. QUANTITIES GIVEN ON THE PLANT LEGEND ARE FOR CONTRACTOR'S CONVENIENCE ONLY. IF DISCREPANCIES OCCUR. THE PLANS SHALL OVERRULE THE PLANT LEGEND. CONTRACTOR SHALL LOCATE ALL PLANTS AWAY FROM KNOWN PERMANENT FIXTURES. IF CONFLICT ARISES WITH PLAN, CONTRACTOR SHALL NOTIFY PROJECT MANAGER OR DESIGNEE PRIOR TO PROCEEDING.
- ALL PLANT MATERIAL SHALL CONFORM TO OR EXCEED THE AMERICAN STANDARD FOR NURSERY STOCK (LATEST EDITION) AS PUBLISHED BY THE AMERICAN ASSOCIATION OF NURSERYMEN.
- 10. ALL PLANT MATERIAL SHALL BE FREE OF ALL PESTS, DISEASES, AND CANKERS, IN HEALTHY CONDITION, AND FREE OF MECHANICAL DAMAGE AT THE TIME OF PLANTING.
- 11. IT IS THE RESPONSIBILITY OF THE CONTRACTOR TO ENSURE A HEALTHY AND VIABLE PLANT AND THE PLANT SHALL BE REJECTED IF DEEMED UNHEALTHY OR UNFIT AT ANY TIME DURING THE CONTRACT OR WARRANTY DURATION.
- 12. IF ANY PLANT/MATERIAL SUBSTITUTIONS ARE REQUESTED BY CONTRACTOR, THEN NOTICE SHALL BE GIVEN TO PROJECT MANAGER OR DESIGNEE AT MINIMUM SEVENTY-TWO (72) HOURS (NOT INCLUDING WEEKENDS) PRIOR TO DESIRED ORDERING DATE/TIME. WHEN SUBSTITUTIONS ARE REQUESTED BY CONTRACTOR, SUGGESTED ACCEPTABLE REPLACEMENTS SHALL ALSO BE PRESENTED AT TIME FOR FULL AND COMPLETE REVIEW BY LANDSCAPE ARCHITECT OR OWNER.
- 13. BALLED AND BURLAPPED PLANTS/TREES TO BE PLANTED PRIOR TO CONTAINER OR BEDDING PLANTS.
- 14. BALLED AND BURLAPPED MATERIAL SHALL COMPLY WITH THE FOLLOWING GUIDELINES: 14.1. TREES DESIGNATED B&B SHALL BE PROPERLY DUG WITH FIRM, NATURAL BALLS OF SOIL RETAINING AS MANY FIBROUS ROOTS AS POSSIBLE, IN SIZES AND SHAPES AS SPECIFIED IN THE AMERICAN STANDARD FOR NURSERY STOCK ANSI Z60.1.
- 14.2. ROOT BALLS SHALL BE FIRMLY WRAPPED WITH NONSYNTHETIC, ROTTABLE BURLAP AND SECURED WITH NAILS AND HEAVY, NONSYNTHETIC TWINE
- 14.3. ROOT COLLAR SHALL BE APPARENT AT SURFACE OF BALL, OR THE CONTRACTOR WILL BE RESPONSIBLE FOR REMOVING EXCESS SOIL FROM THE TOP OF THE ROOTBALL. 14.4. REMOVE ALL BURLAP, LACING, AND WIRE BASKET FROM AT LEAST THE TOP 1/2 OF THE
- ROOTBALL AND DISCARD FROM PLANTING HOLE. 14.5. DO NOT MANEUVER BY TRUNK. HANDLE BY ROOT BALL ONLY
- 15. CONTAINERIZED PLANTS SHALL COMPLY WITH THE FOLLOWING GUIDELINES: 15.1. MATERIAL SHALL HAVE FIRM, NATURAL BALLS OF SOIL RETAINING AS MANY FIBROUS ROOTS AS POSSIBLE. IN SIZES AND SHAPES AS SPECIFIED IN THE AMERICAN STANDARD
- FOR NURSERY STOCK ANSI Z60.1 15.2. ROOT COLLAR SHALL BE APPARENT AT SURFACE OF BALL, OR THE CONTRACTOR WILL BE RESPONSIBLE FOR REMOVING EXCESS SOIL FROM THE TOP OF THE ROOTBALL. 15.3. REMOVE CONTAINER PRIOR TO PLANTING.
- 16. TREES TO BE STAKED WILL BE DESIGNATED BY THE LANDSCAPE ARCHITECT. TREE STAKING FOR CANOPY AND LARGE EVERGREEN TREES SHALL NOT EXCEED 90 DAYS.
- 17. PLANT BED PREPARATION: 17.1. ALL PLANT BEDS ARE TO RECEIVE A MINIMUM OF 4" OF APPROVED TOPSOIL TILLED IN
- TO A DEPTH OF 8" TO ENSURE INTEGRATION WITH EXISTING SOIL. 17.2. APPROVED TOPSOIL IS TO BE PREFERABLY FROM ON-SITE STOCKPILE FROM STRIPPING
- OPERATIONS SEE EROSION AND SEDIMENT CONTROL PLANS. 17.3. IF ON-SITE TOPSOIL IS NOT AVAILABLE, CONTRACTOR SHALL PROVIDE TO SITE ACCORDINGLY.
- 18. ALL MULCH TO BE CERTIFIED TO BE FREE OF WEEDS, NON-NATIVE INVASIVE SPECIES AND THEIR LARVAE. MULCH SAMPLE SUBMITTAL SHALL BE PROVIDED TO LANDSCAPE ARCHITECT BEFORE SITE DELIVERY.

SEEDING/SODDING NOTES

- 1. ROUGH GRADING TO BE COMPLETED PRIOR TO THE START OF PLANT INSTALLATION. SUBSTANTIAL COMPLETION SIGN-OFF BY LANDSCAPE ARCHITECT CONTRACTOR TO ENSURE NO CHANNELIZED FLOWS AROUND THE SITE.
- 2. ALL SEEDED/SODDED AREAS SHALL BE FINISHED GRADE AT THE THICKNESS OF THE SOD.
- 3. NO SEEDED/SODDED AREAS SHALL BE SODDED UNTIL ALL OTHER CONSTRUCTION ACTIVITIES, INCLUDING PLANTING AND MULCHING HAVE OCCURRED AND LANDSCAPE ARCHITECT HAS REVIEWED THE FINAL GRADING.
- 4. SOD AREAS WILL BE ACCEPTED WHEN IN COMPLIANCE WITH ALL THE FOLLOWING CONDITIONS
- 4.1. ROOTS ARE THOROUGHLY KNIT TO THE SOIL
- 4.2. ABSENCE OF VISIBLE JOINTS 4.3. ALL AREAS SHOW A UNIFORM STAND OF SPECIFIED GRASS IN HEALTHY CONDITION
- 4.4. AT LEAST 30 DAYS HAVE ELAPSED SINCE THE COMPLETION OF WORK UNDER THIS SECTION.

5. QUALITY GUARANTEE:

- 5.1. SOD SHALL BE UNIFORM IN COLOR, LEAF TEXTURE, LEAF AND ROOD DENSITY, AND FREE FROM WEED, DISEASES, AND OTHER VISIBLE IMPERFECTIONS AT TIME OF FINAL ACCEPTANCE. GUARANTEE DOES NOT COVER DAMAGE AS A RESULT OF FERTILIZERS, PESTICIDES, OR OTHER APPLICATIONS NOT SUPERVISED BY THE CONTRACTOR OR AS A RESULT OF ACTS OF GOD OR VANDALISM.
- 5.2. SEED SHALL BE UNIFORM IN COLOR, LEAF TEXTURE, LEAF AND ROOT DENSITY, AND FREE FROM WEED, DISEASES, AND OTHER VISIBLE IMPERFECTIONS AT TIME OF FINAL ACCEPTANCE. GUARANTEE DOES NOT COVER DAMAGE AS A RESULT OF FERTILIZERS, PESTICIDES, OR OTHER APPLICATIONS NOT SUPERVISED BY THE CONTRACTOR OR AS A RESULT OF ACTS OF GOD OR VANDALISM.
- 6. CONTRACTOR SHALL BE RESPONSIBLE FOR ENSURING THAT THE SEED/SOD IS PROPERLY IRRIGATED DURING THE GROW-IN PERIOD AND SHALL BE RESPONSIBLE IF THE SOD SUFFERS IRREPARABLE HARM.
- 7. SEED/SOD IS SUBJECT TO INSPECTION AND ACCEPTANCE. LANDSCAPE ARCHITECT AND/OR CLIENT RESERVES THE RIGHT TO REJECT AT ANY TIME OR PLACE PRIOR TO ACCEPTANCE, ANY WORK AND SOD WHICH IN THE LANDSCAPE ARCHITECTS OPINION FAILS TO MEET THESE SPECIFICATIONS REQUIREMENTS.

8. SOD STANDARDS:

- 8.1. GENERAL: HEALTHY. THICK TURF HAVING UNDERGONE A PROGRAM OF REGULAR FERTILIZATION, MOWING AND WEED CONTROL; FREE OF OBJECTABLE WEEDS; UNIFORM IN GREEN COLOR, LEAF TEXTURE AND DENSITY; HEALTHY, VIGOROUS ROOT SYSTEM; INSPECTED AND FOUND FREE OF DISEASE, NEMATODES, PEST AND PEST LARVAE BY THE ENTOMOLOGIST OF THE STATE DEPARTMENT OF AGRICULTURE.
- 8.2. EACH PIECE OF SOD: SANDY-LOAM SOIL BASE THAT WILL NOT BREAK, CRUMBLE OR TEAR DURING SOD INSTALLATION.
- 8.3. THICKNESS: MINIMUM 3/4" THICK, EXCLUDING THE TOP GROWTH THATCH.
- 8.4. THATCH: NOT TO EXCEED 1/2" UNCOMPRESSED. 8.5. SIZE: CUT IN STRIPS 18" WIDE NO MORE THAN 24 HOURS PRIOR TO DELIVERY.

SOD DELIVERY, STORAGE AND HANDLING GUIDELINES ARE AS FOLLOWS:

- 9.1. SOD SHALL BE DELIVERED ON PALLETS PROPERLY LOADED ON VEHICLES AND WITH ROOT SYSTEM PROTECTED FROM EXPOSURE TO SUN, WIND, AND HEAT IN ACCORDANCE WITH STANDARD PRACTICE AND LABELED WITH BOTANICAL AND COMMON NAME OF EACH GRASS SPECIES IN ACCORDANCE WITH FEDERAL SEED ACT. SOD THAT HAS BEEN DAMAGED BY POOR HANDLING OR IMPROPER STORAGE IS SUBJECT TO REJECTION BY THE LANDSCAPE ARCHITECT OR OWNER.
- 9.2. PROTECT FROM DEHYDRATION, CONTAMINATION, FREEZING AND HEATING AT ALL TIMES. KEEP STORED SOD MOIST AND UNDER SHADE OR COVERED WITH MOISTENED
- 9.3. DO NOT DROP SOD ROLLS FROM CARTS, TRUCKS OR PALLETS.
- 9.4. DO NOT DELIVER MORE SOD THAN CAN BE INSTALLED WITHIN 36 HOURS. 9.5. DO NOT STACK SOD MORE THAN 2 FEET DEEP.
- 10. SEED/SODDED BED PREPARATION: 10.1. ALL DEBRIS, ROCKS, ETC. LARGER THAN .5" ARE TO BE REMOVED PRIOR TO
- SEEDING/SODDING OR PLANTING.
- 10.2. ALL AREAS TO BE SEEDED/SODDED ARE TO RECEIVE A MINIMUM OF 2" OF APPROVED TOPSOIL TILLED INTO A DEPTH OF 4" TO ENSURE INTEGRATION WITH EXISTING SOIL.
- 10.3. APPROVED TOPSOIL IS TO BE PREFERABLY FROM ON-SITE STOCKPILE FROM STRIPPING OPERATIONS - SEE EROSION AND SEDIMENT CONTROL PLANS. 10.4. IF ON-SITE TOPSOIL IS NOT AVAILABLE, CONTRACTOR SHALL PROVIDE TO SITE





REUSE OF DOCUMENT This document is the property of Site Collaborative Inc. The ideas and design incorporated on this document is an instrument of professional service and shall not be used for any other project without written authorization of Site Collaborative Inc.

 $\overline{\mathbf{B}}$ 00 \Box

ZCP-11-24


PROJECT NUMBER:

MASTER PLAN

DATE: 08.11.2025

SHEET TITLE:

STANDARD NOTES

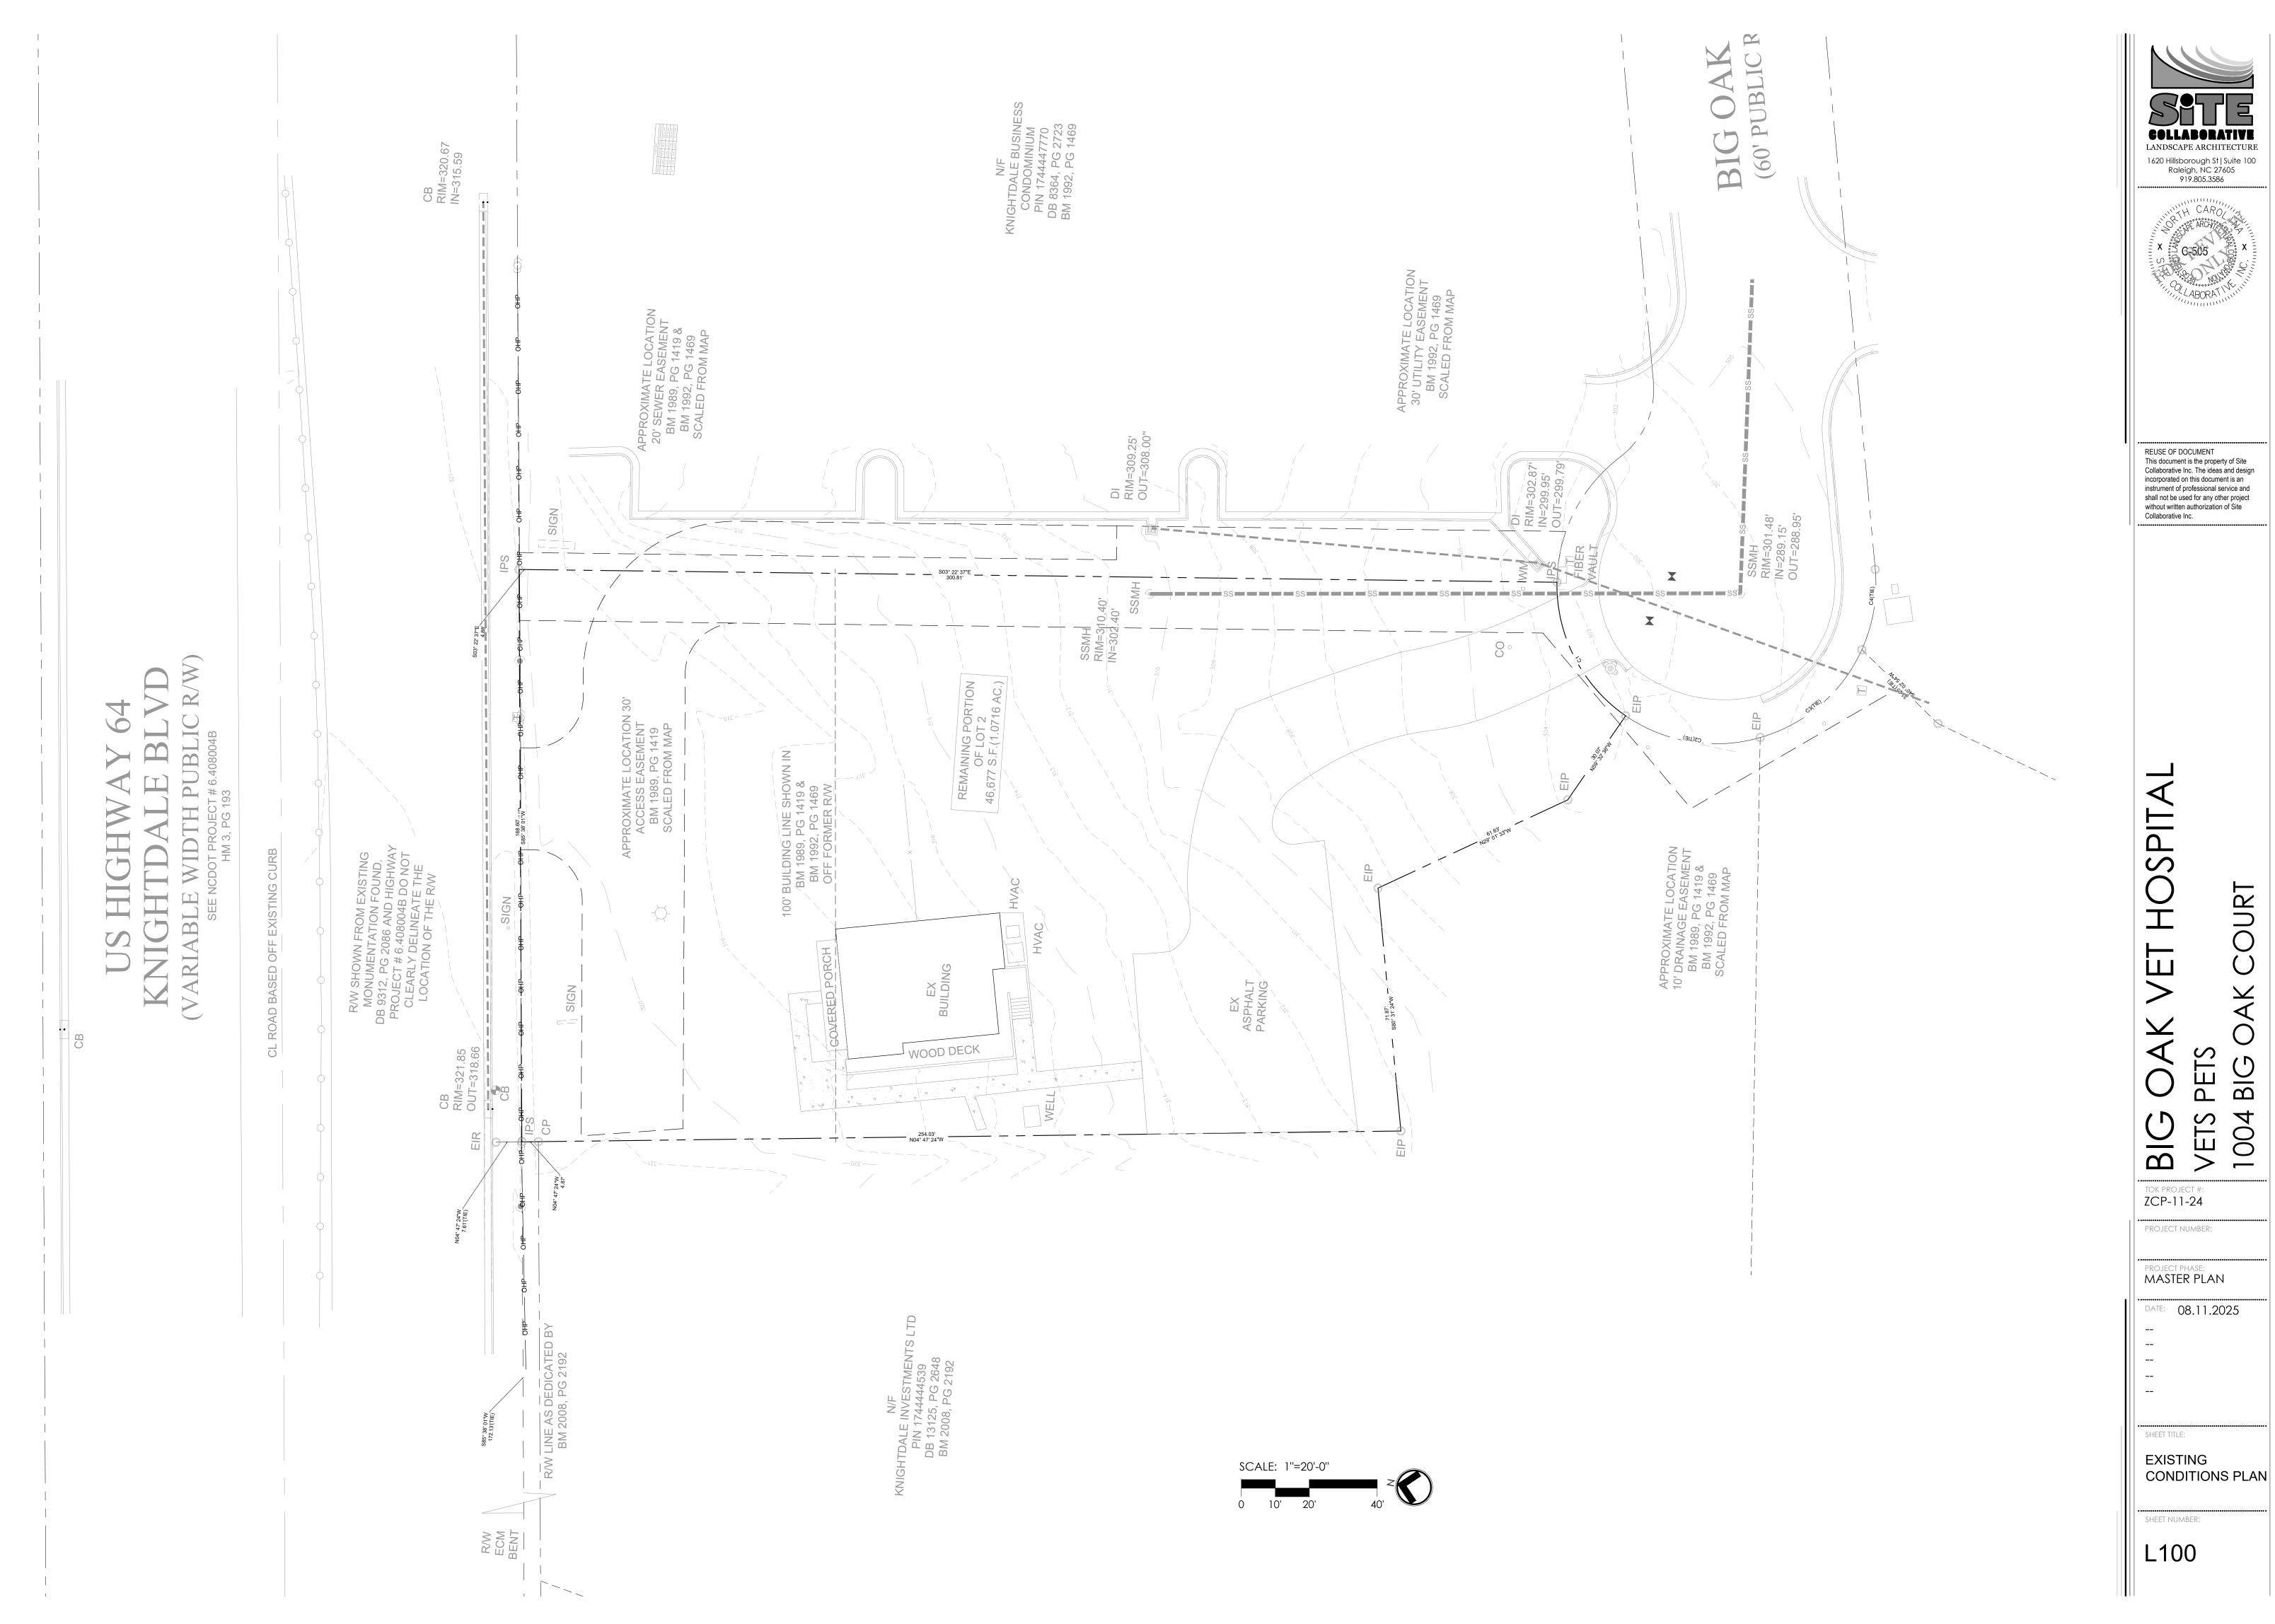


1620 Hillsborough St | Suite 100 Raleigh, NC 27605 919.805.3586

L100

PETS BIG (

1004

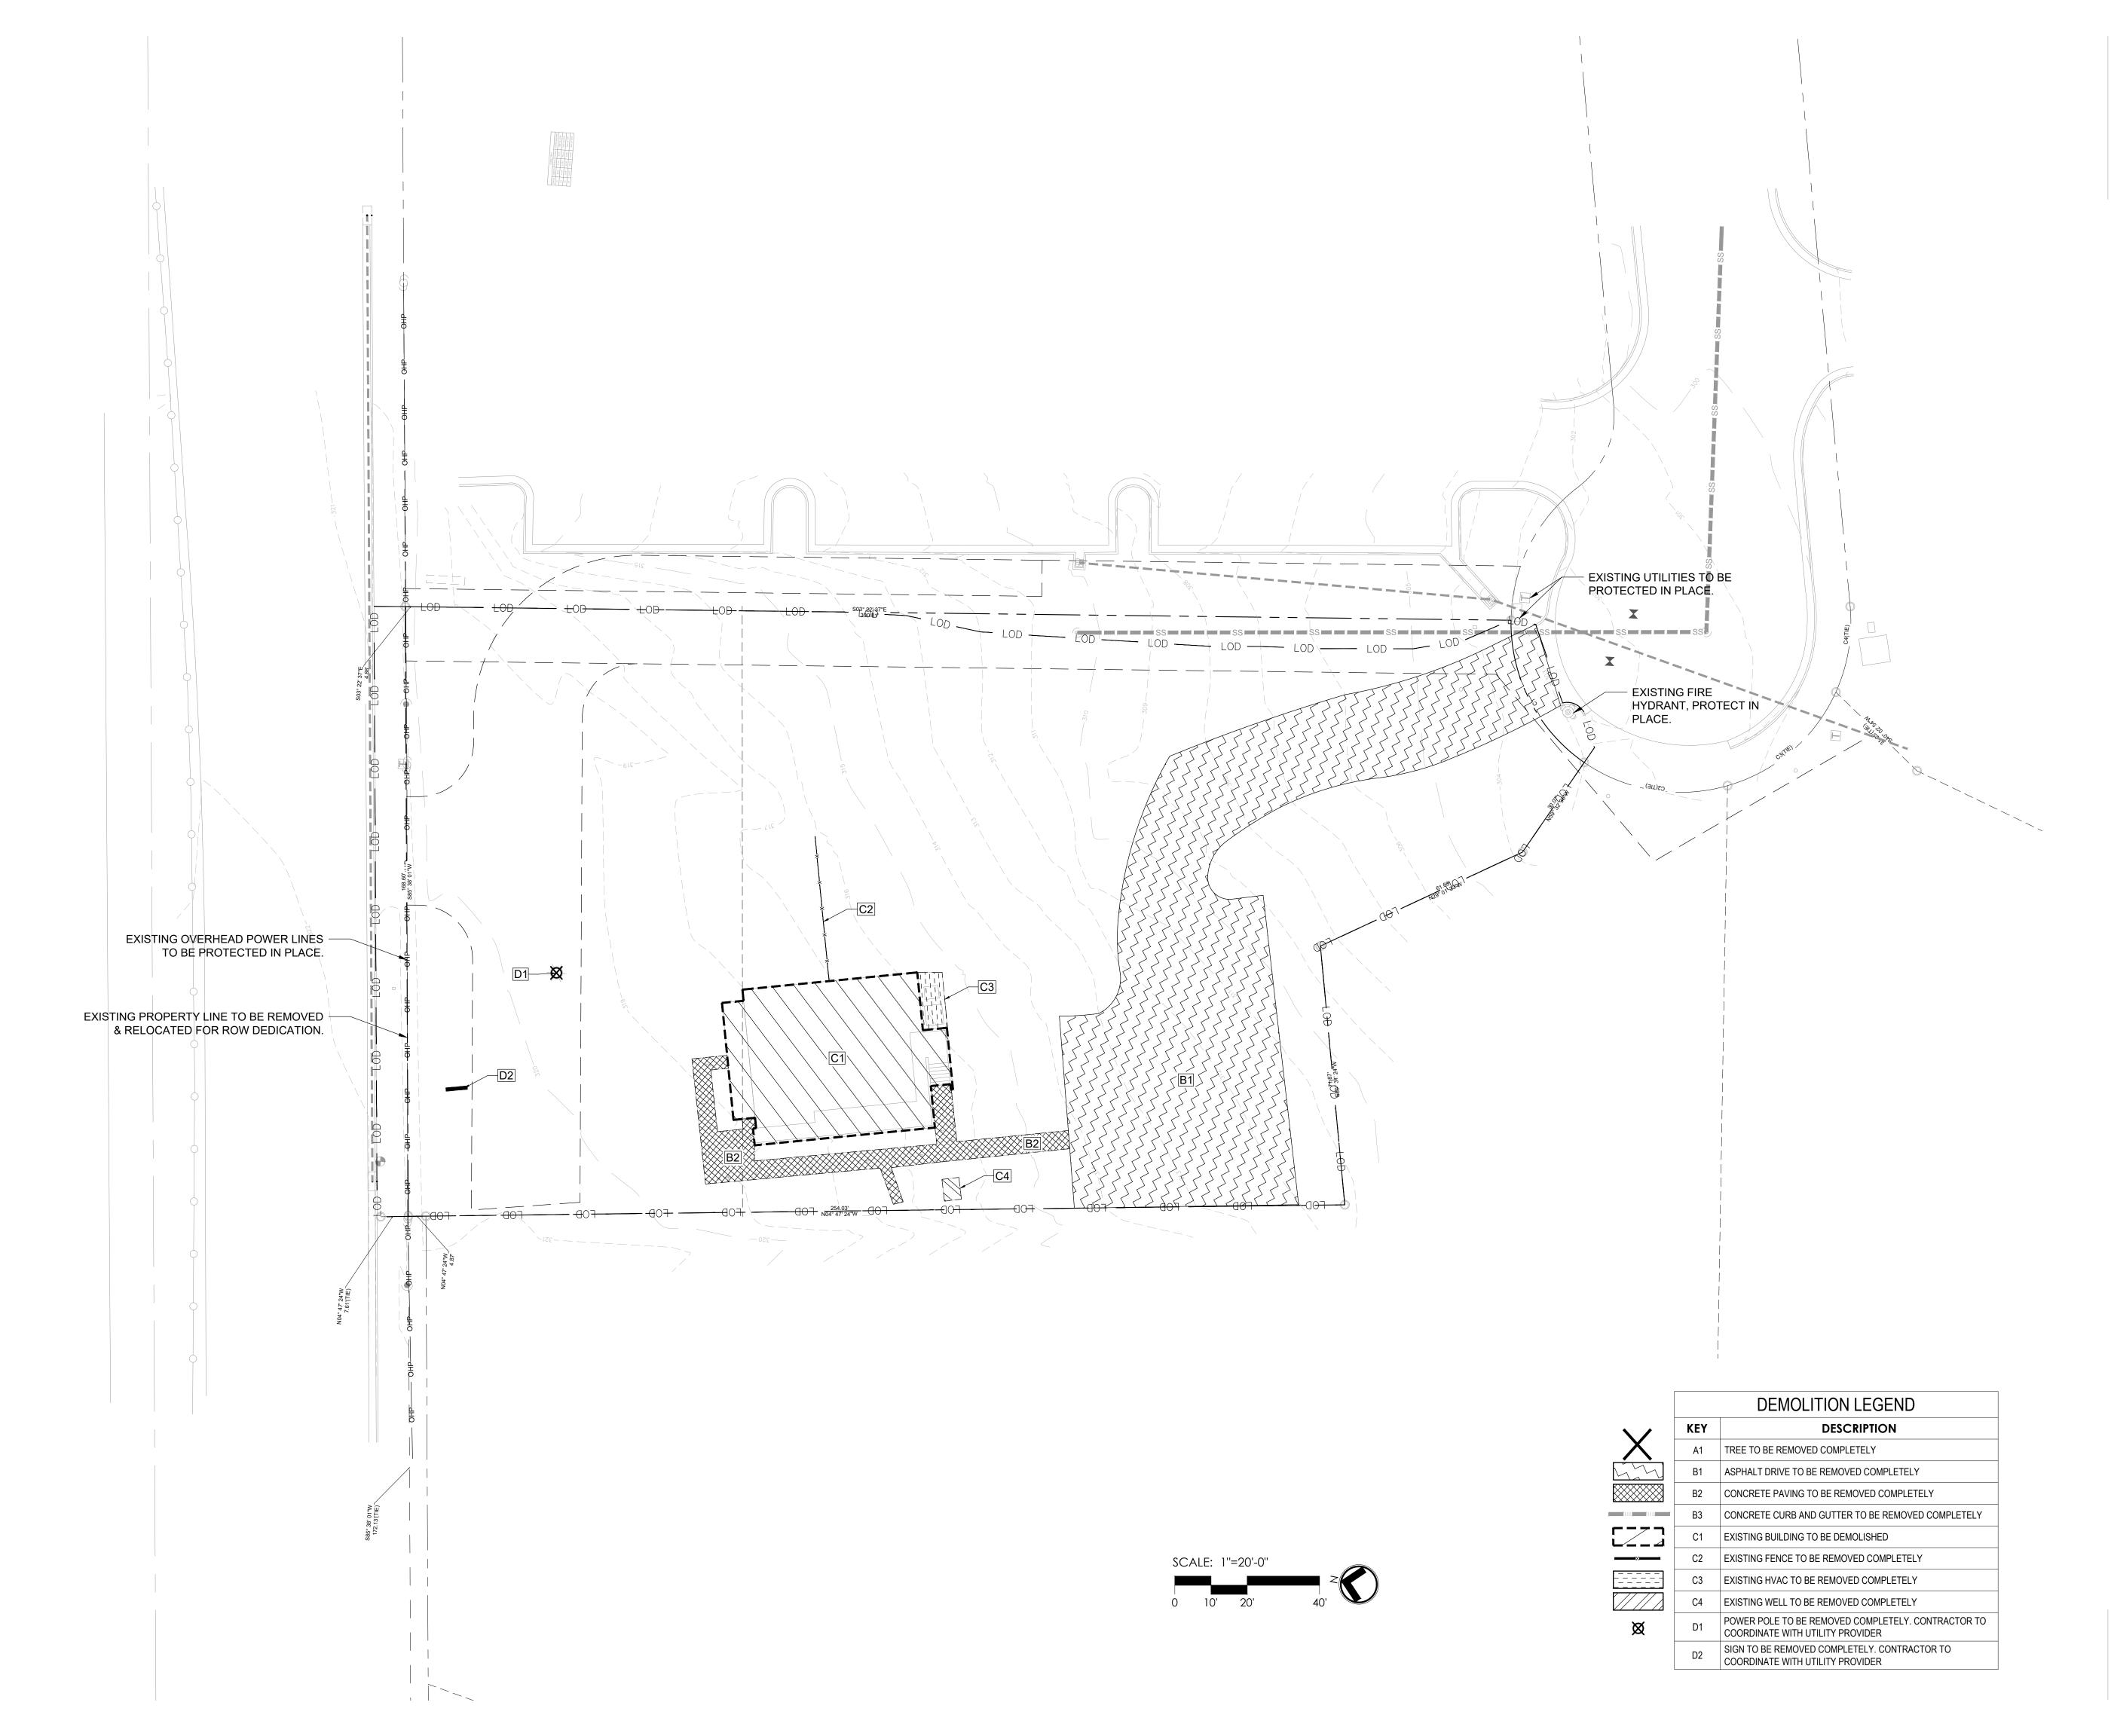





REUSE OF DOCUMENT This document is the property of Site
Collaborative Inc. The ideas and design
incorporated on this document is an
instrument of professional service and shall not be used for any other project without written authorization of Site

Collaborative Inc.


TOK PROJECT #: ZCP-11-24

PROJECT NUMBER:

MASTER PLAN

DATE: 08.11.2025

DEMOLITION PLAN

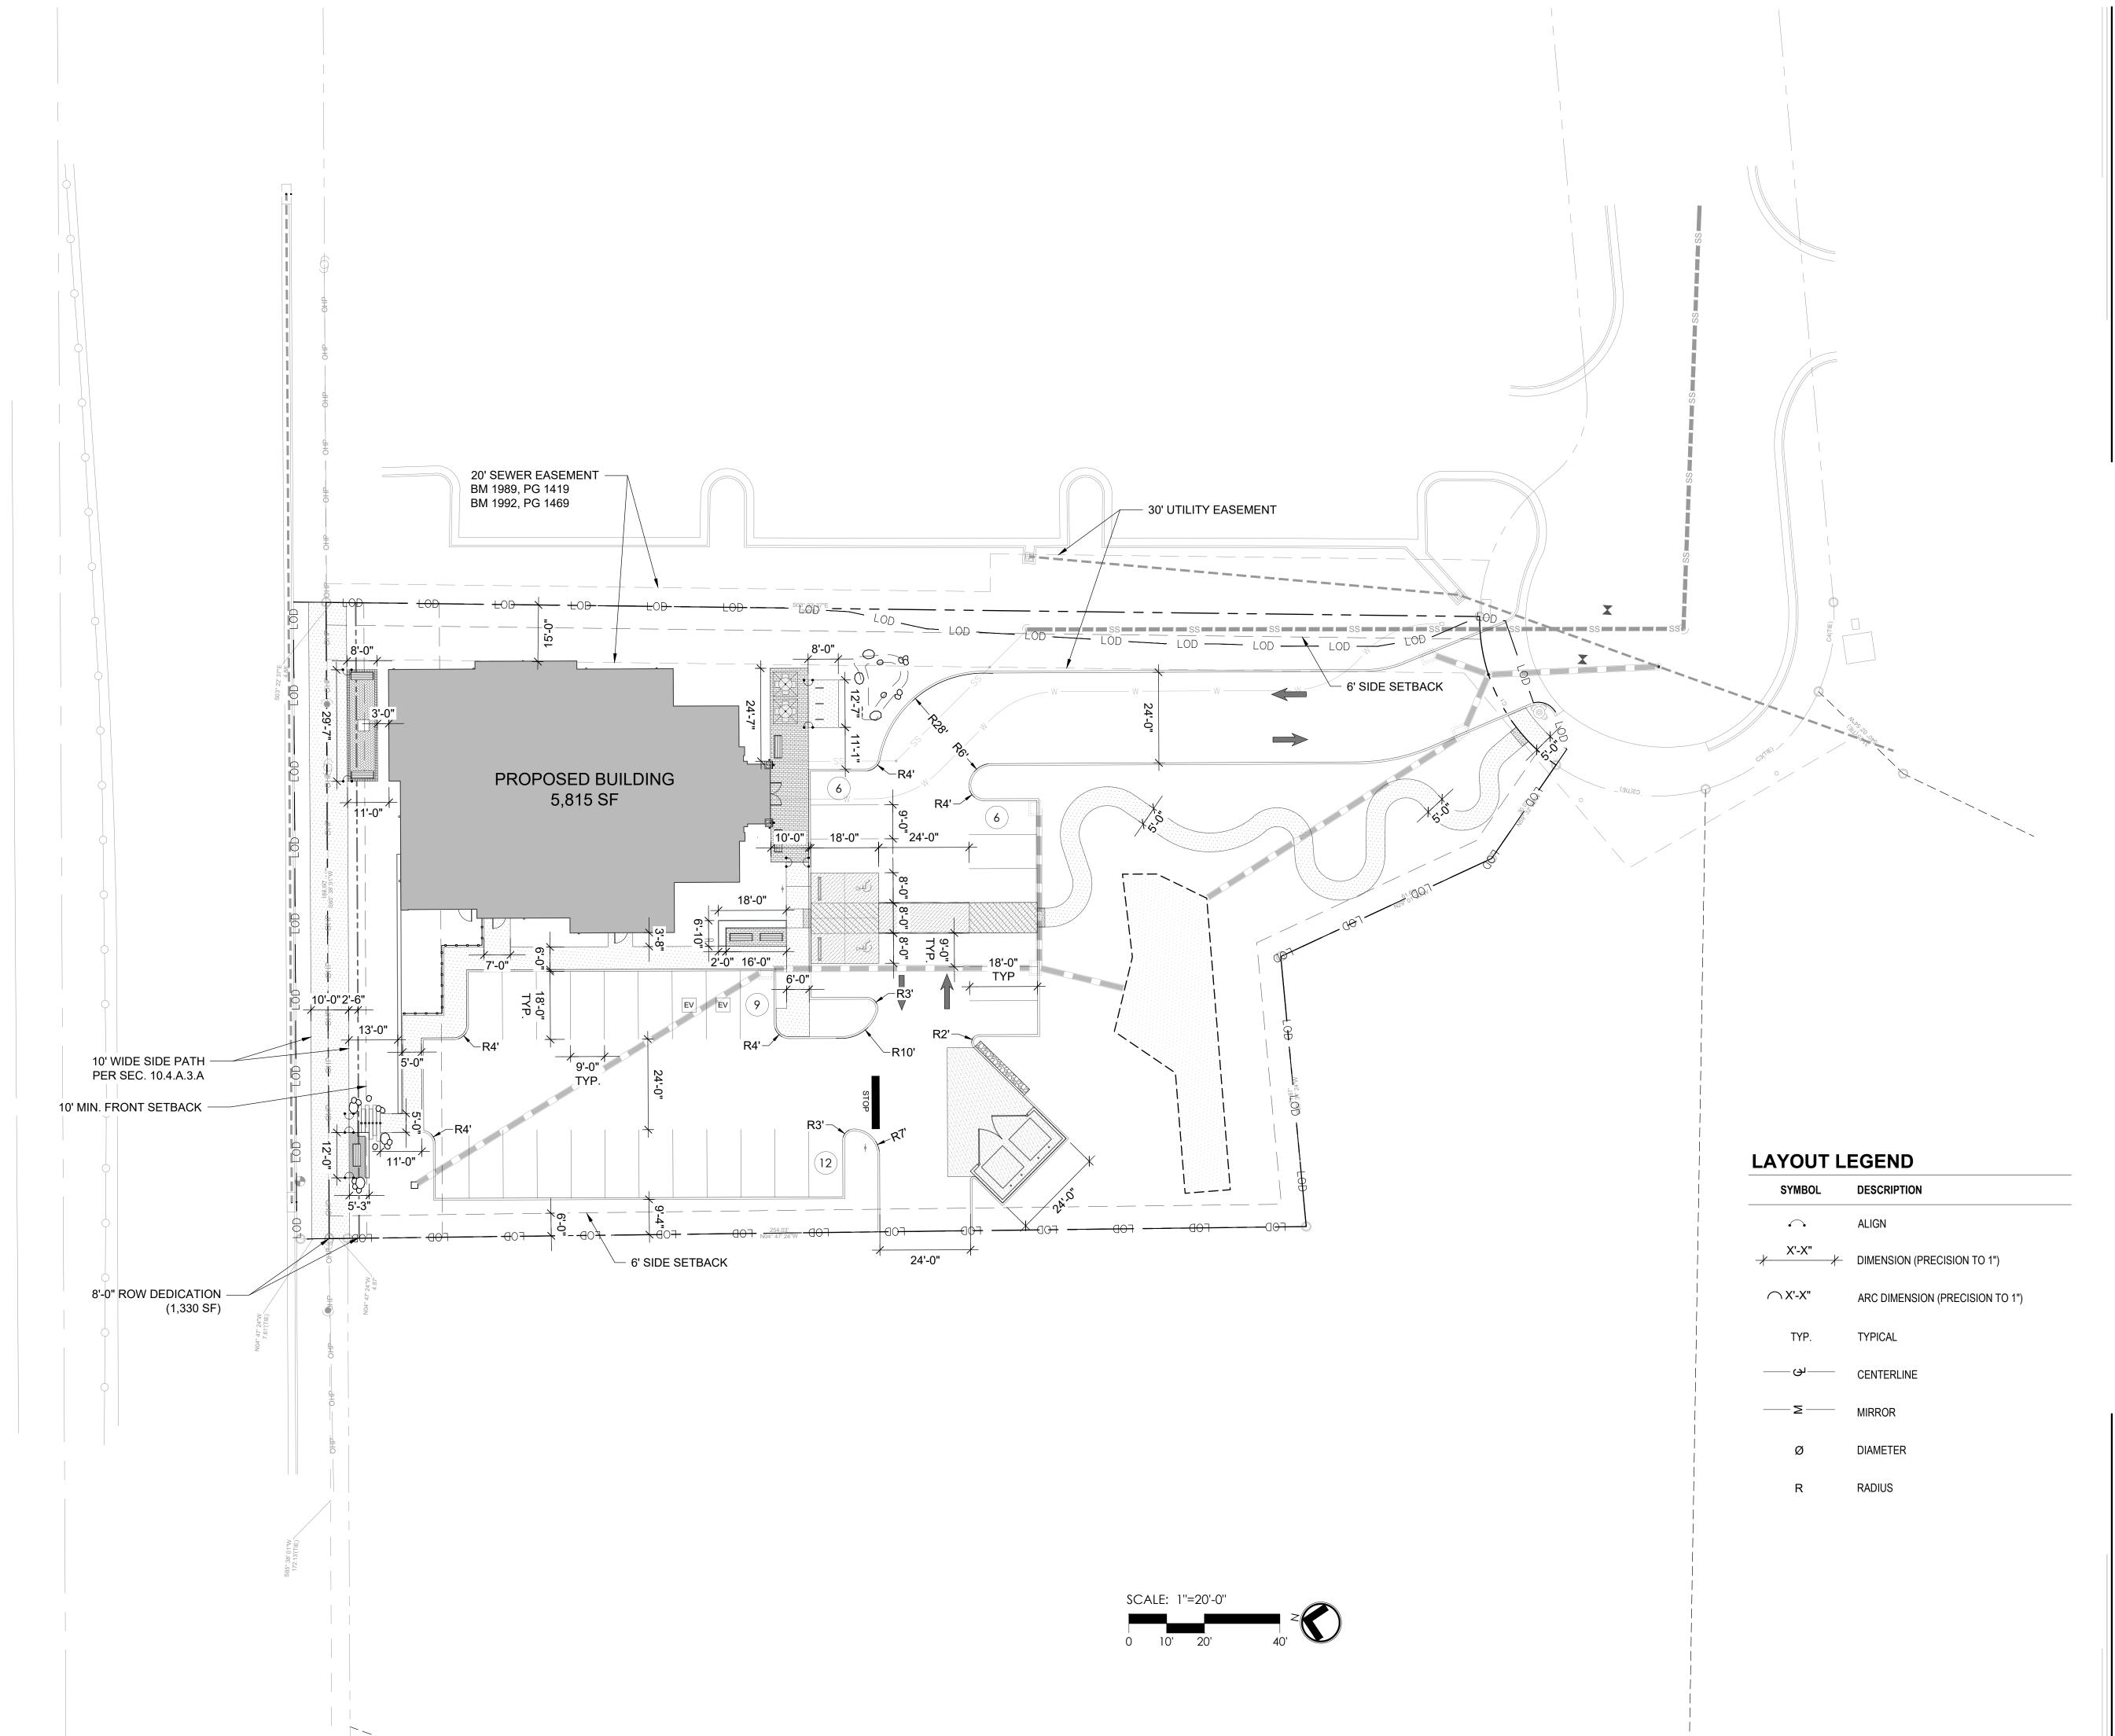





REUSE OF DOCUMENT
This document is the property of Site
Collaborative Inc. The ideas and design
incorporated on this document is an
instrument of professional service and shall not be used for any other project without written authorization of Site

Collaborative Inc.

PETS BIG (VETS | BIG TOK PROJECT #: ZCP-11-24

PROJECT NUMBER:


MASTER PLAN

DATE: 08.11.2025


LAYOUT PLAN

SHEET TITLE:

SHEET NUMBER:

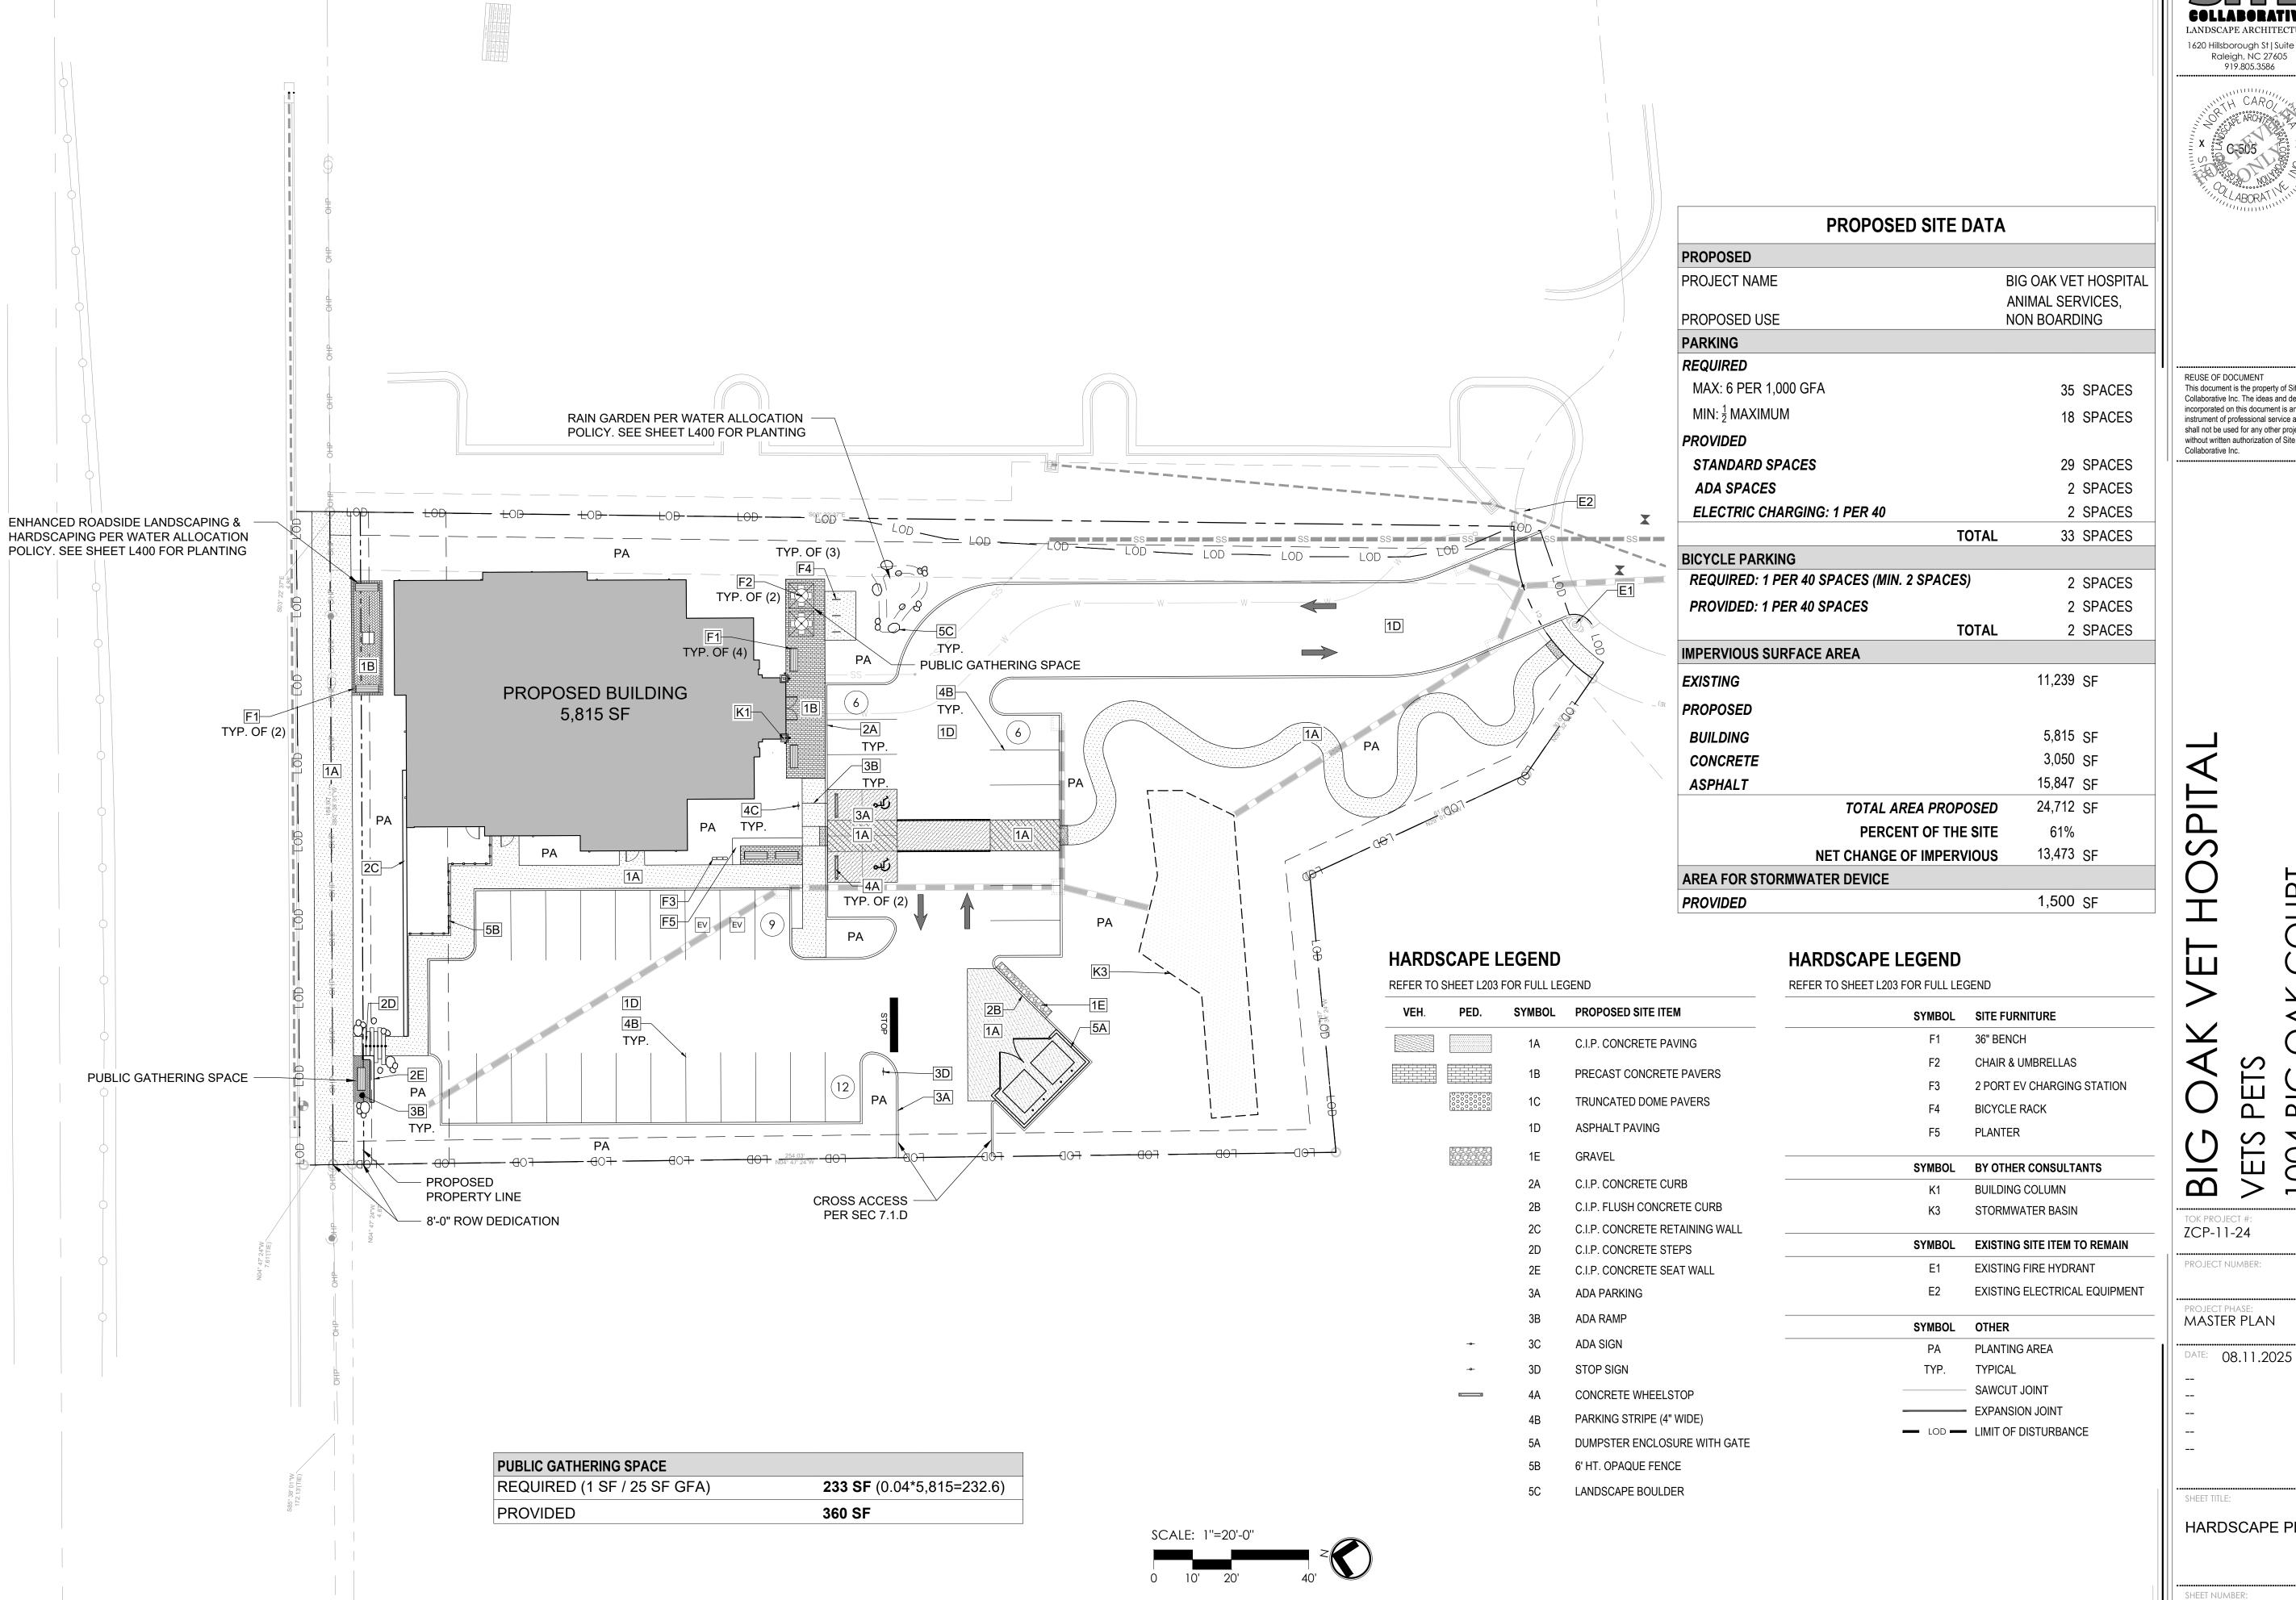



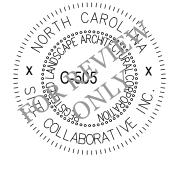

REUSE OF DOCUMENT
This document is the property of Site Collaborative Inc. The ideas and design incorporated on this document is an

instrument of professional service and shall not be used for any other project without written authorization of Site

> BIG 004 > =

HARDSCAPE PLAN





REUSE OF DOCUMENT
This document is the property of Site
Collaborative Inc. The ideas and design
incorporated on this document is an
instrument of professional service and
shall not be used for any other project
without written authorization of Site
Collaborative Inc.

VETS PETS 1004 BIG (BIG TOK PROJECT #: ZCP-11-24


PROJECT NUMBER:

project phase: MASTER PLAN


DATE: 08.11.2025

VICINITY MAP

SHEET NUMBER:

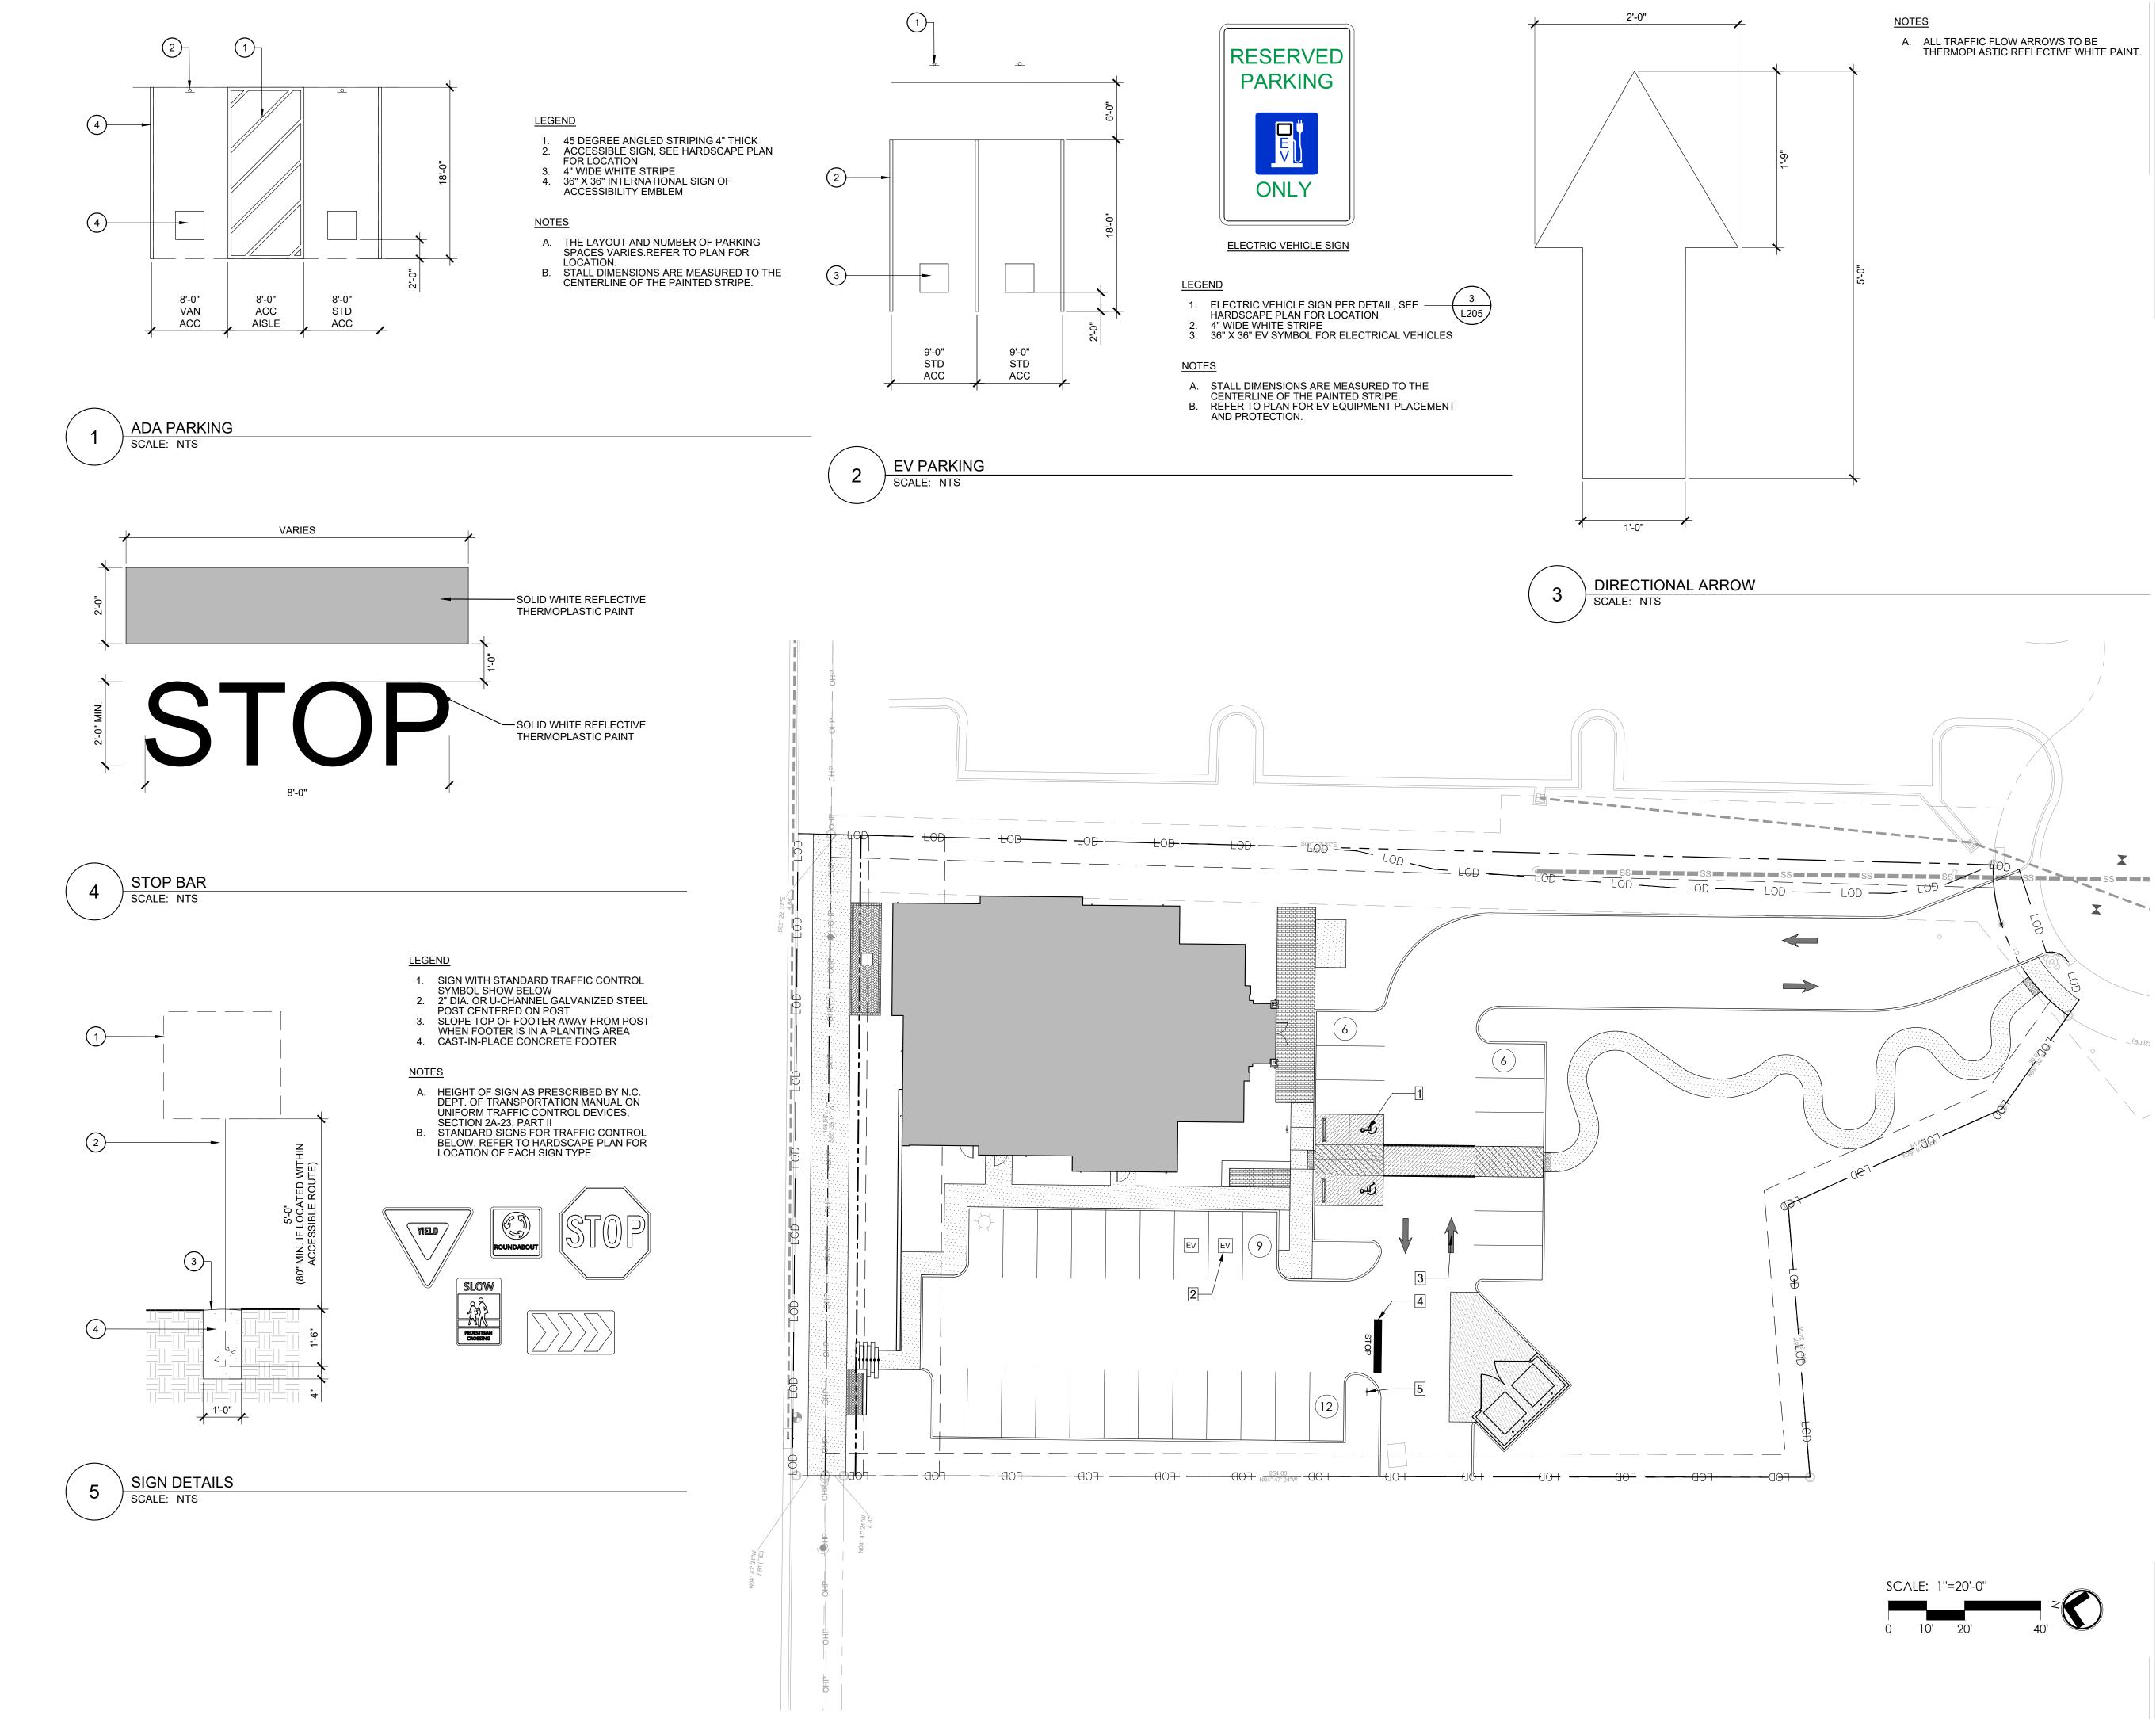

LANDSCAPE ARCHITECTURE 1620 Hillsborough St | Suite 100 Raleigh, NC 27605 919.805.3586

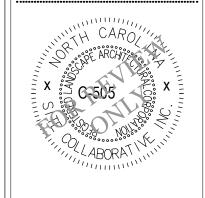

REUSE OF DOCUMENT This document is the property of Site Collaborative Inc. The ideas and design incorporated on this document is an instrument of professional service and shall not be used for any other project without written authorization of Site

Collaborative Inc.


BIG 004 $\frac{B}{C}$

PROJECT NUMBER: MASTER PLAN

TOK PROJECT #: ZCP-11-24

DATE: 08.11.2025

SHEET TITLE: SIGNS & PAVEMENT MARKINGS

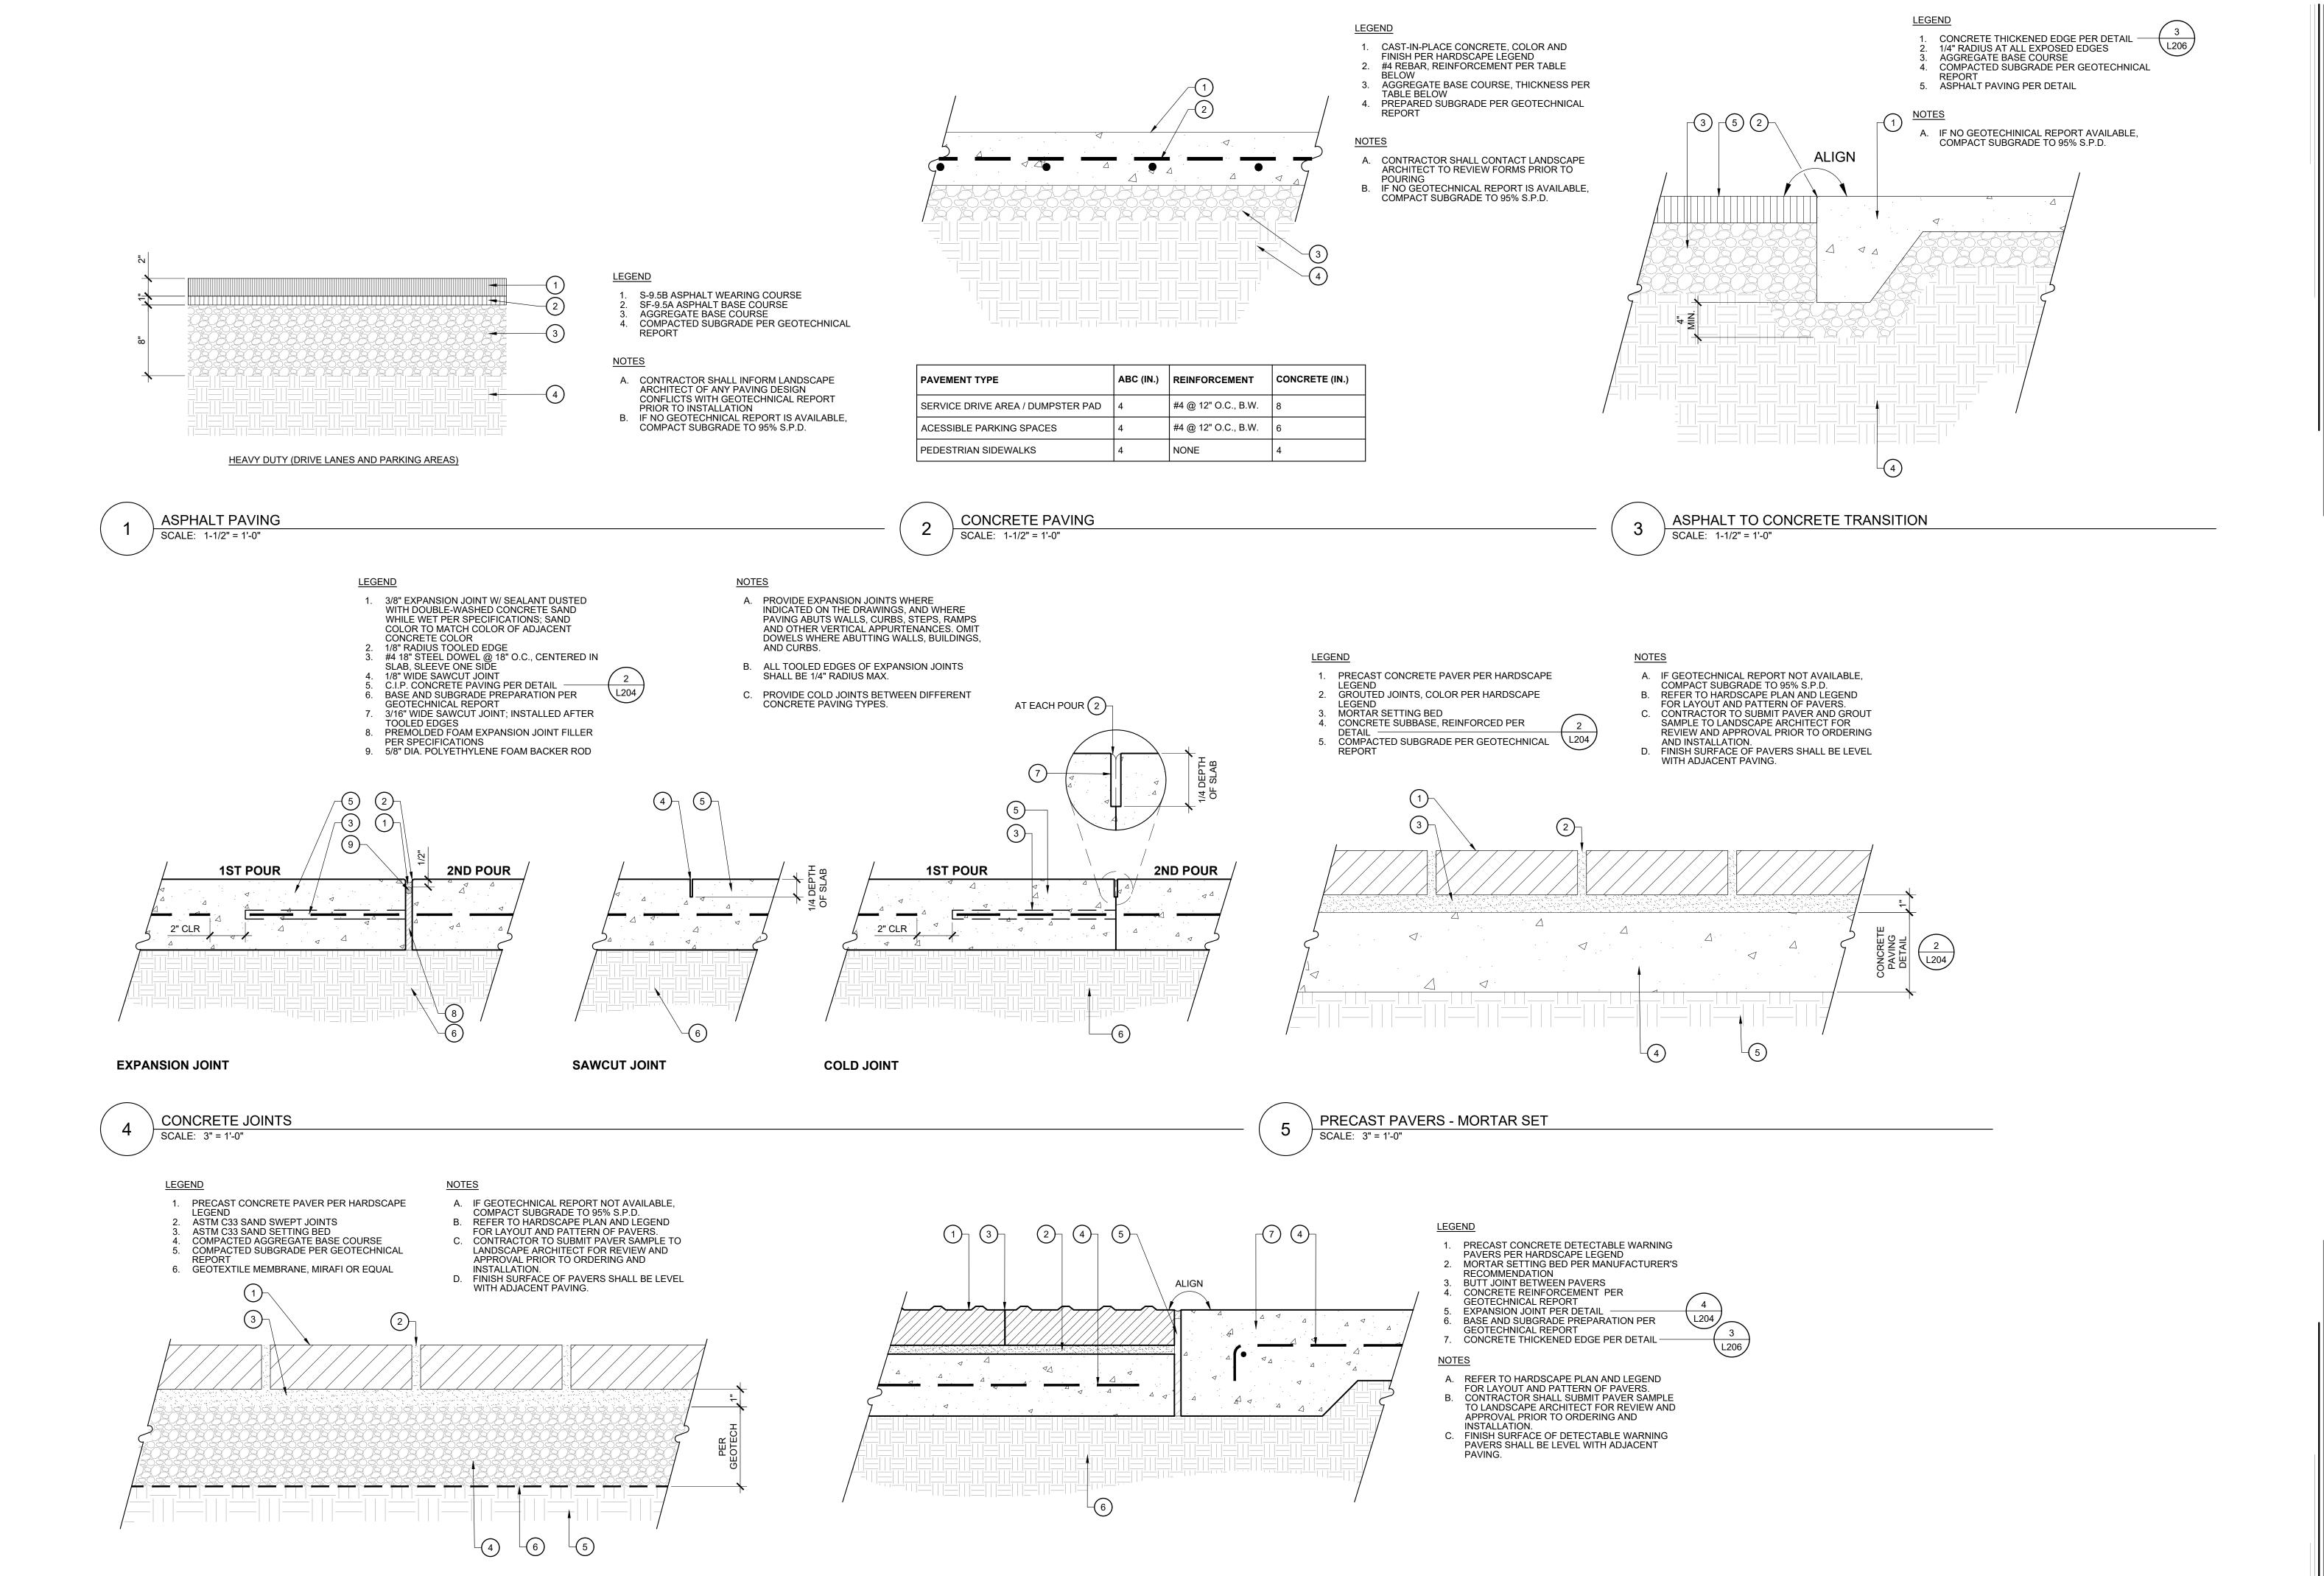


TRUNCATED DOME

SCALE: 3" = 1'-0"

PRECAST PAVERS - SAND SET

SCALE: 3" = 1'-0"

LANDSCAPE ARCHITECTURE 1620 Hillsborough St | Suite 100 Raleigh, NC 27605 919.805.3586

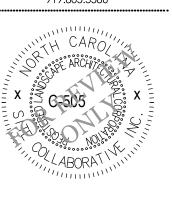

REUSE OF DOCUMENT This document is the property of Site Collaborative Inc. The ideas and design incorporated on this document is an instrument of professional service and

shall not be used for any other project without written authorization of Site Collaborative Inc.

BIG 00 $\overline{\underline{\mathbf{B}}}$

PROJECT NUMBER:


TOK PROJECT #:

ZCP-11-24


MASTER PLAN

DATE: 08.11.2025

SHEET TITLE: SITE DETAILS

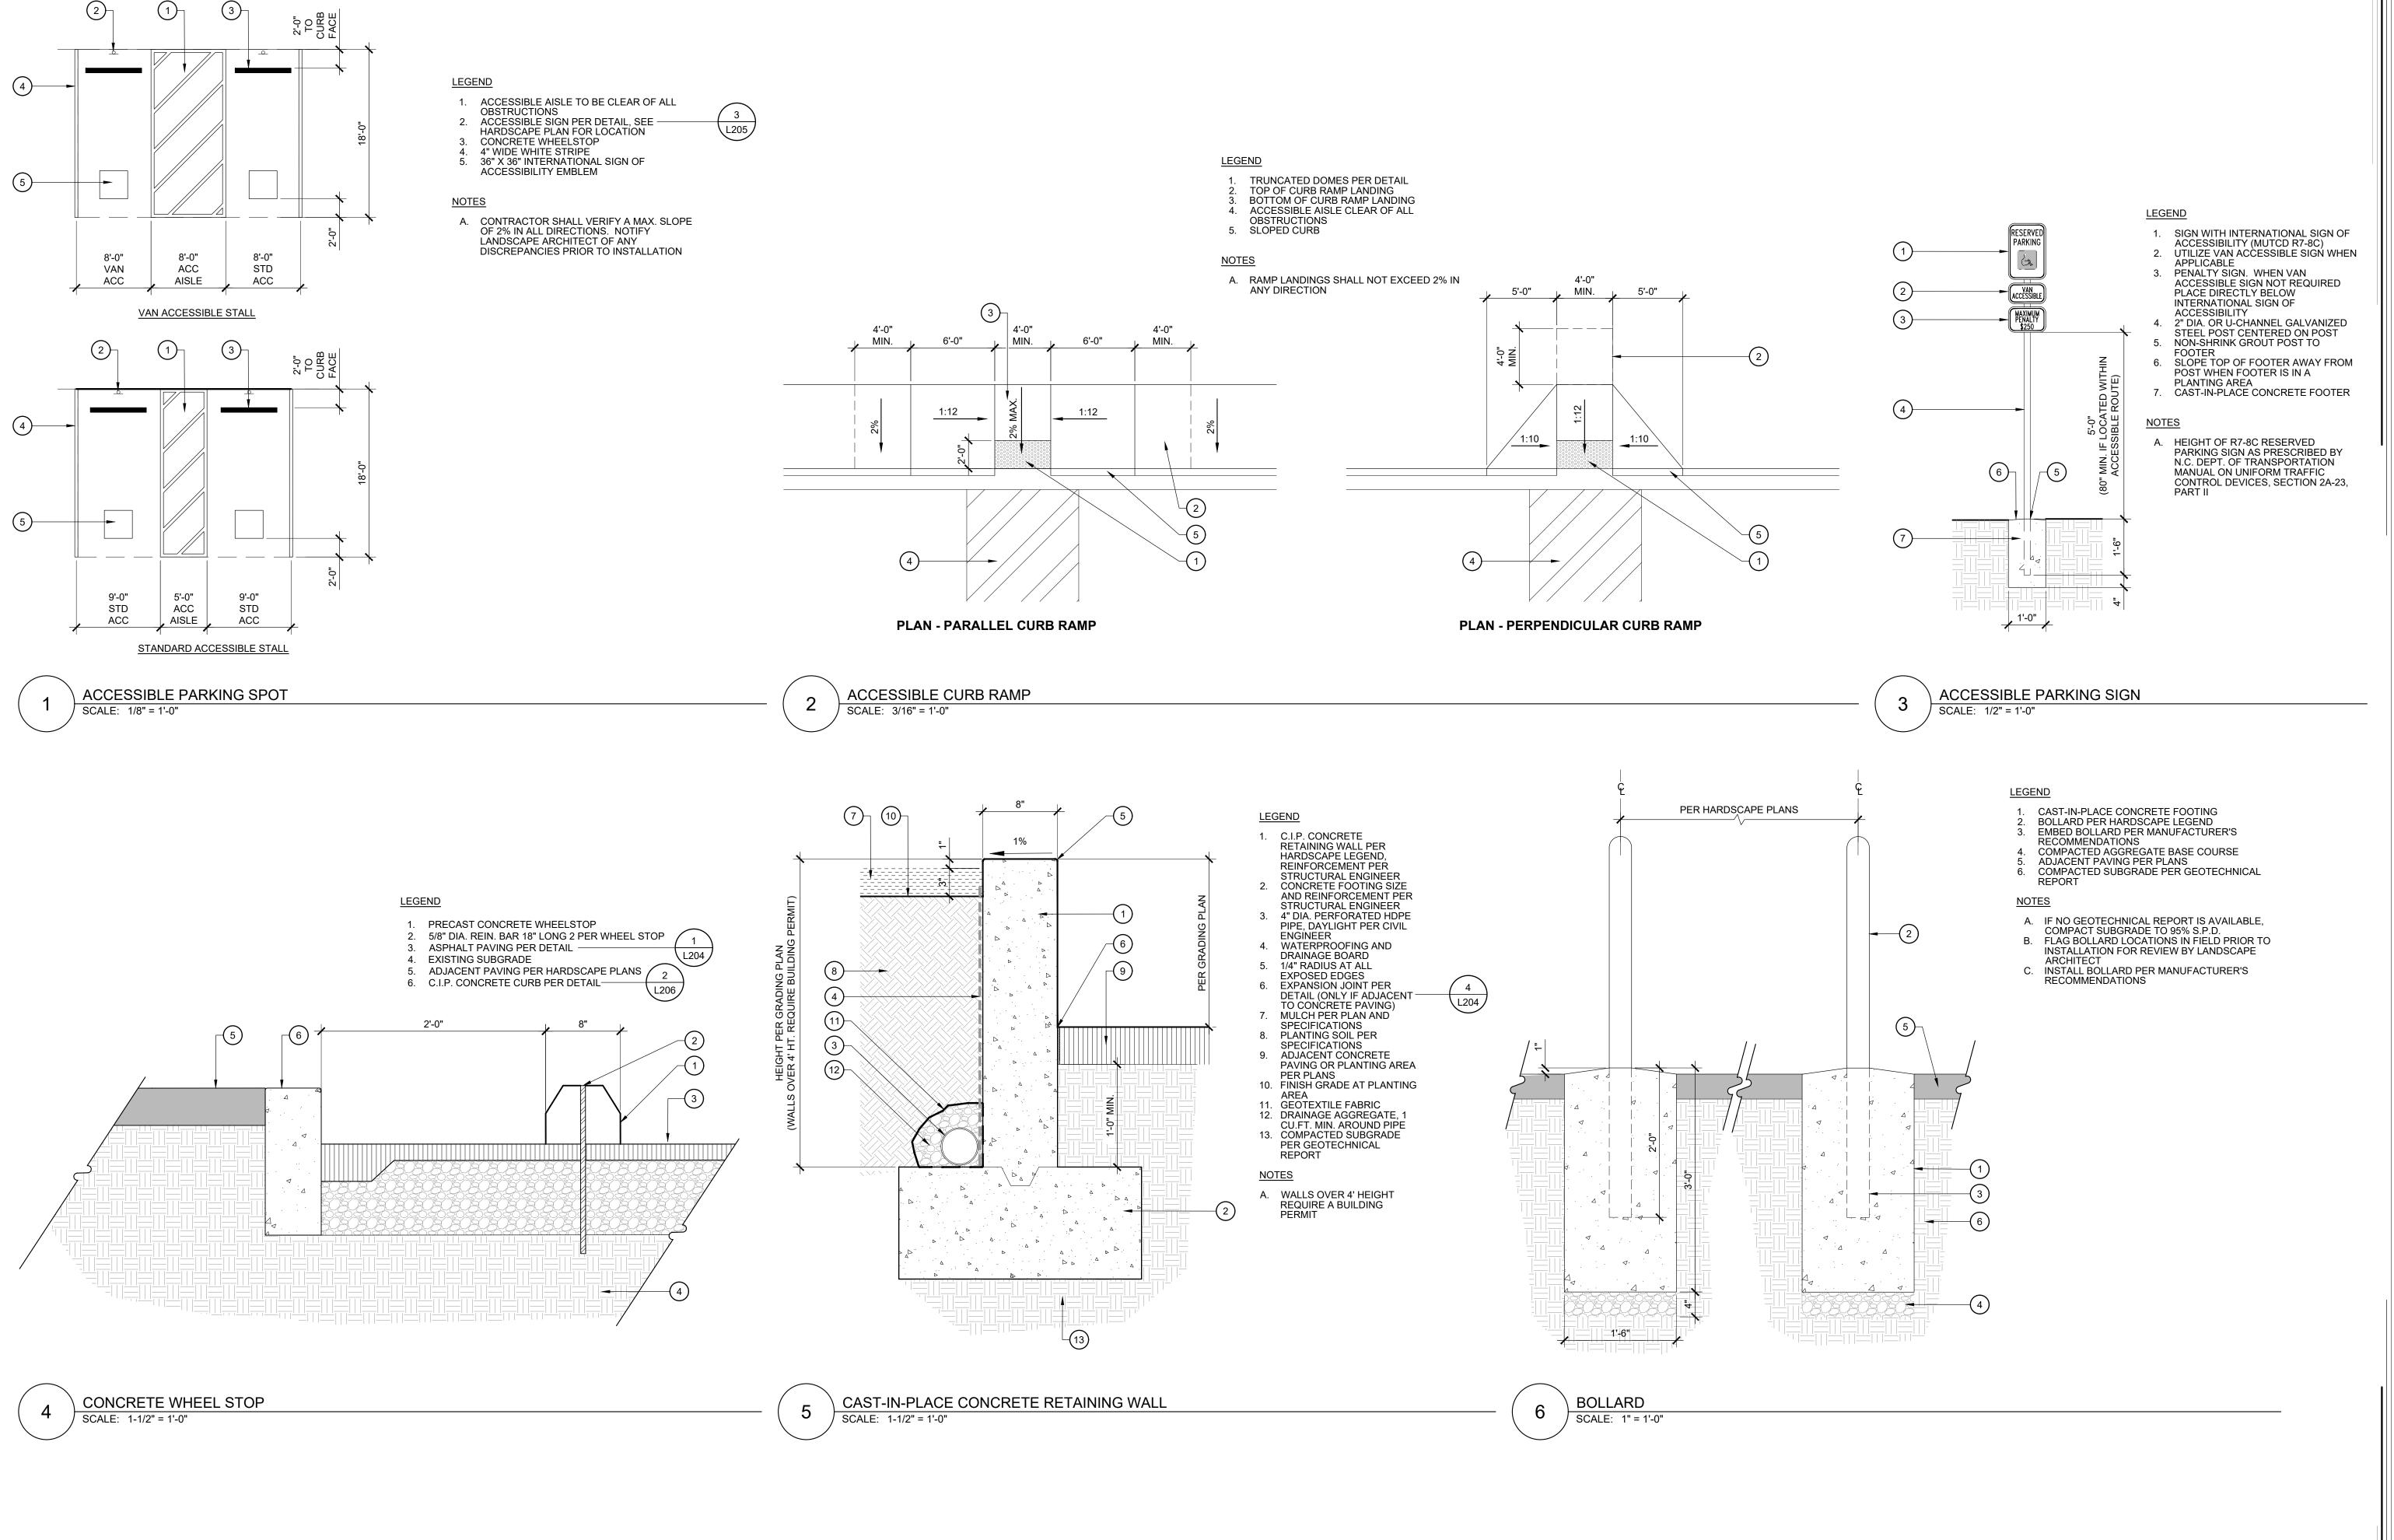



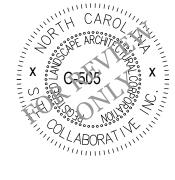

REUSE OF DOCUMENT This document is the property of Site Collaborative Inc. The ideas and design incorporated on this document is an instrument of professional service and

shall not be used for any other project without written authorization of Site Collaborative Inc.


 \cap BIG 00 $\overline{\overline{\mathbf{B}}}$

TOK PROJECT #: ZCP-11-24 PROJECT NUMBER:


MASTER PLAN

DATE: 08.11.2025

SHEET TITLE: SITE DETAILS

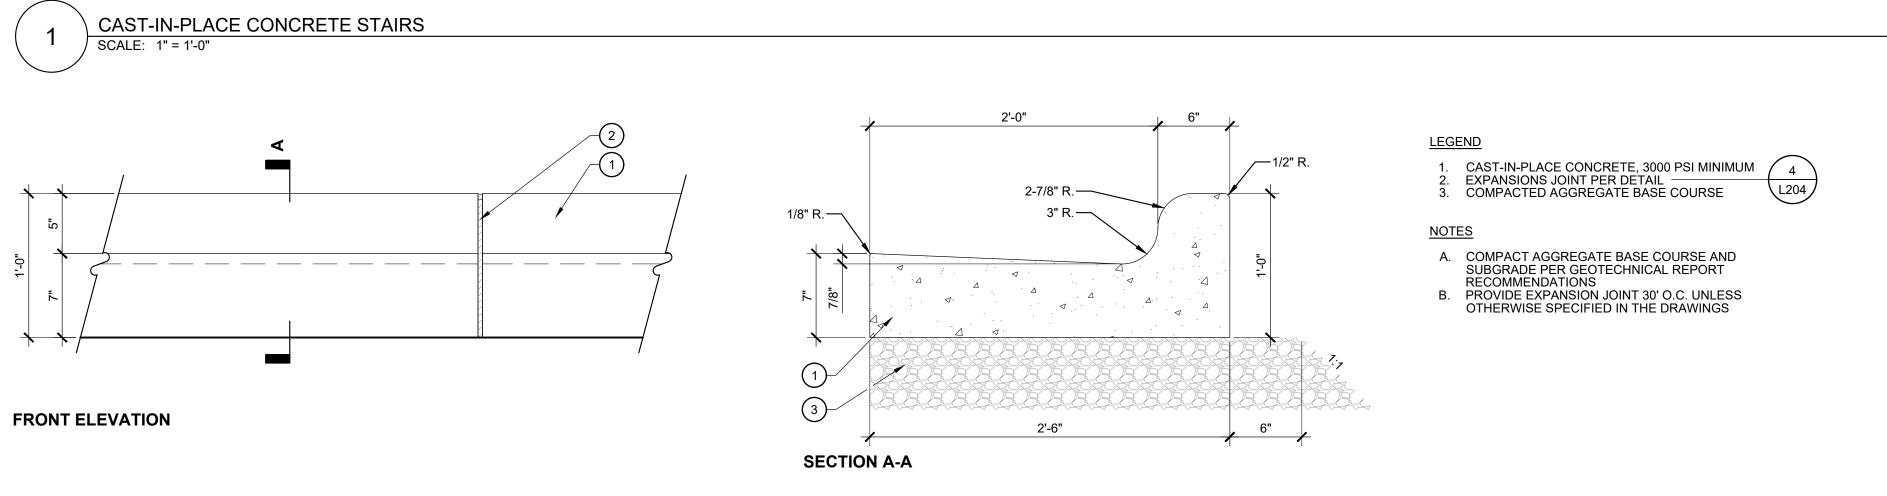


COMBINATION CURB AND GUTTER

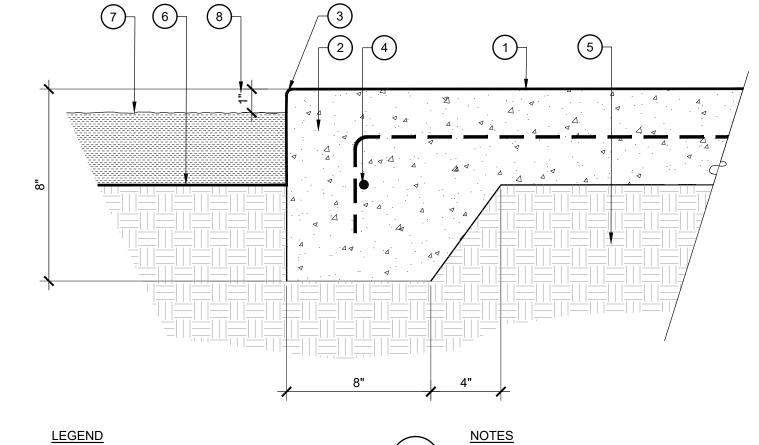

A. THICKENED EDGE REQUIRED WHEREVER CONCRETE PAVING IS ADJACENT TO ASPHALT, AREAS OF AT-GRADE PLANTING, LAWN, OR

DECOMPOSED GRANITE

B. IF NO GEOTECHNICAL REPORT AVAILABLE
COMPACT SUBGRADE TO 95% S.P.D.

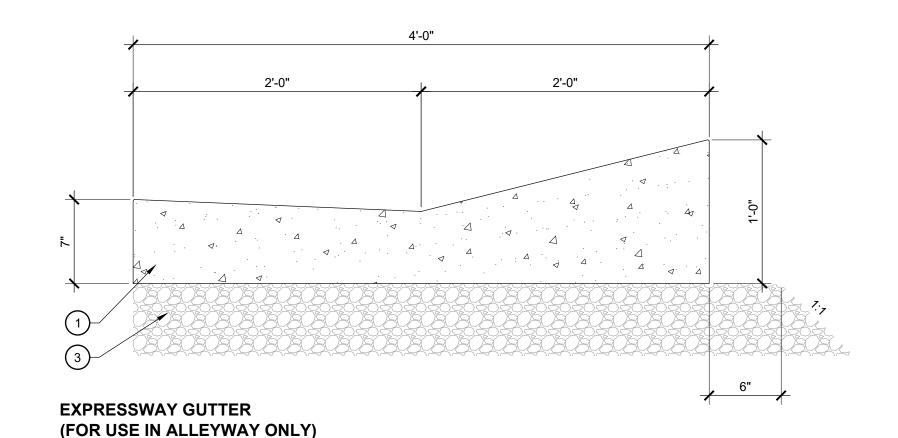

—1/8" R., TYP. 1-3/4" R.— 3/4" R.-1'-6"

MEDIAN CURB AND GUTTER

CAST-IN-PLACE CONCRETE CURB AND GUTTER SCALE: 1-1/2" = 1'-0"

CONCRETE THICKENED EDGE

CONCRETE PAVING PER DETAIL

THICKENED EDGE

1. 1/8" RADIUS TOOLED EDGE

4. #3 BAR CONTINUOUS, 48" LAPPED AND WIRED

COMPACTED SUBGRADE AND BASE
REQUIREMENTS PER GEOTECHNICAL REPORT

FINISH GRADE AT PLANTING

FINISH SURFACE FOR MULCH, PER PLANS AND

SPECIFICATIONS

8. 1" GAP NOT REQUIRED WHEN ADJACENT TO ASPHALT PAVING

1620 Hillsborough St | Suite 100 Raleigh, NC 27605 919.805.3586


> REUSE OF DOCUMENT This document is the property of Site Collaborative Inc. The ideas and design incorporated on this document is an instrument of professional service and shall not be used for any other project without written authorization of Site Collaborative Inc.

> BIG 004 $\frac{B}{C}$ TOK PROJECT #: ZCP-11-24

PROJECT NUMBER: MASTER PLAN

DATE: 08.11.2025

SHEET TITLE: SITE DETAILS

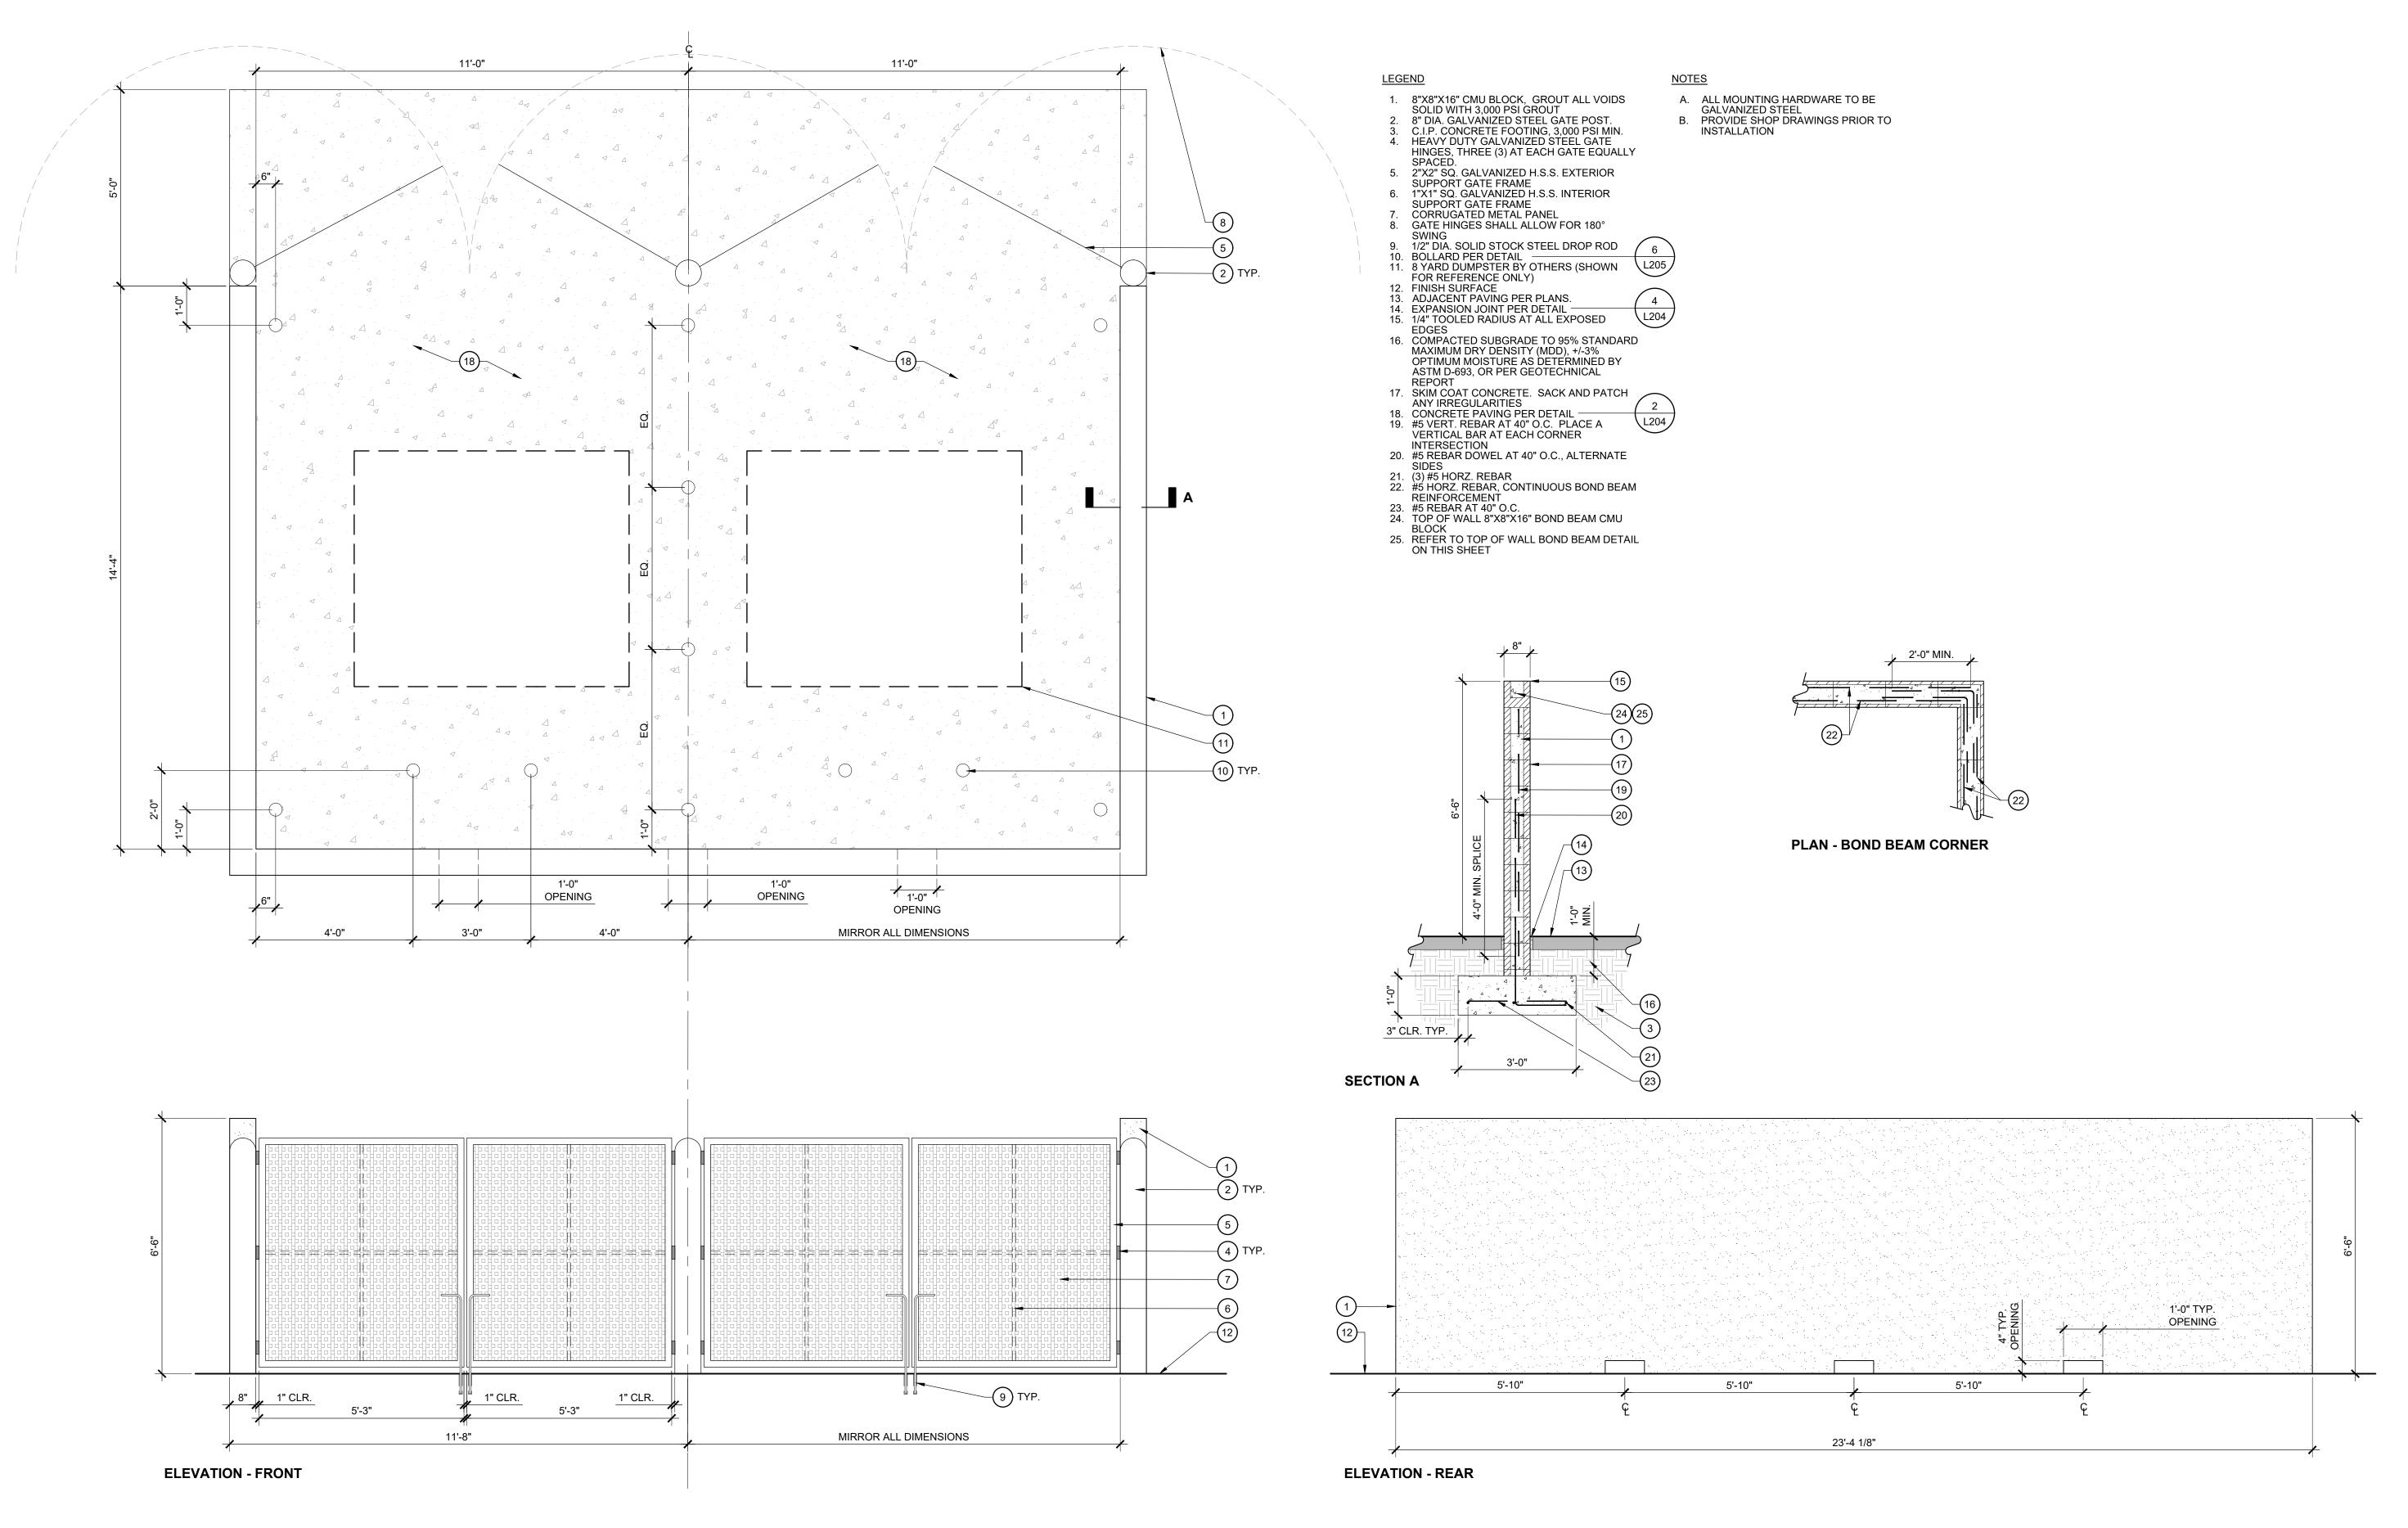







REUSE OF DOCUMENT
This document is the property of Site
Collaborative Inc. The ideas and design
incorporated on this document is an
instrument of professional service and
shall not be used for any other project
without written authorization of Site
Collaborative Inc.

BIG OAK VET HOSPITA
VETS PETS
1004 BIG OAK COURT


PROJECT NUMBER:


PROJECT PHASE:


MASTER PLAN


DATE: 08.11.2025


SITE DETAILS

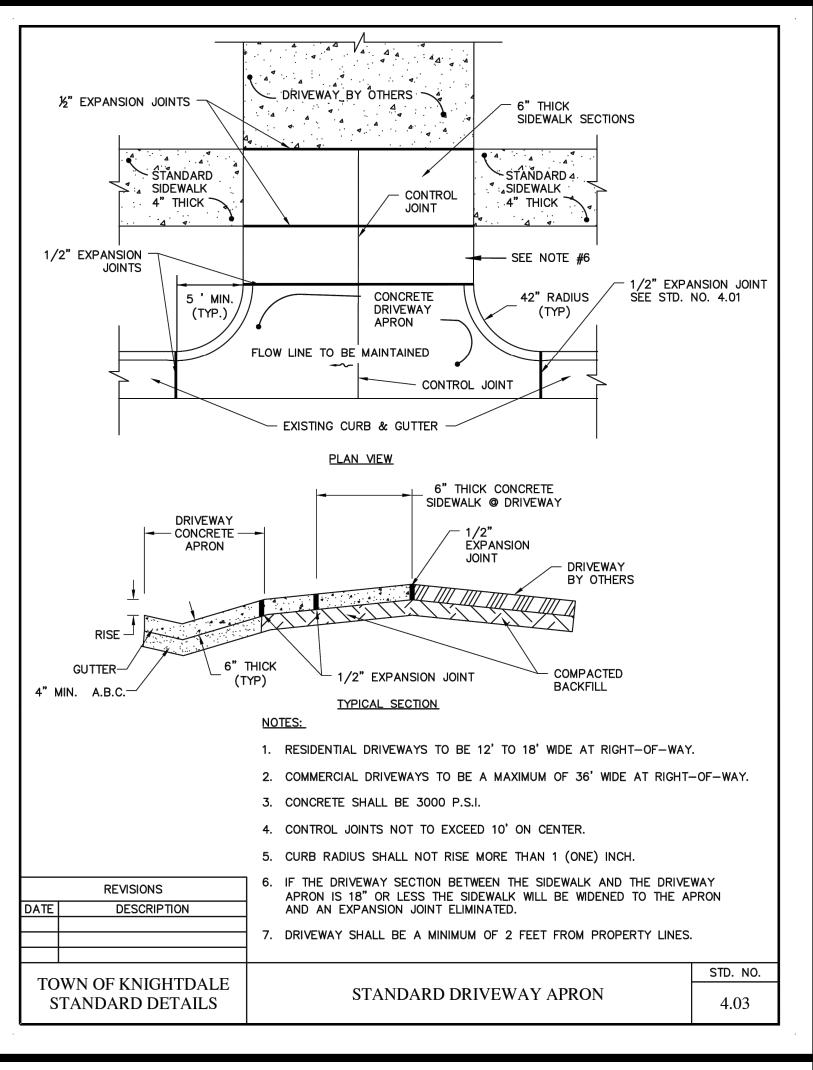


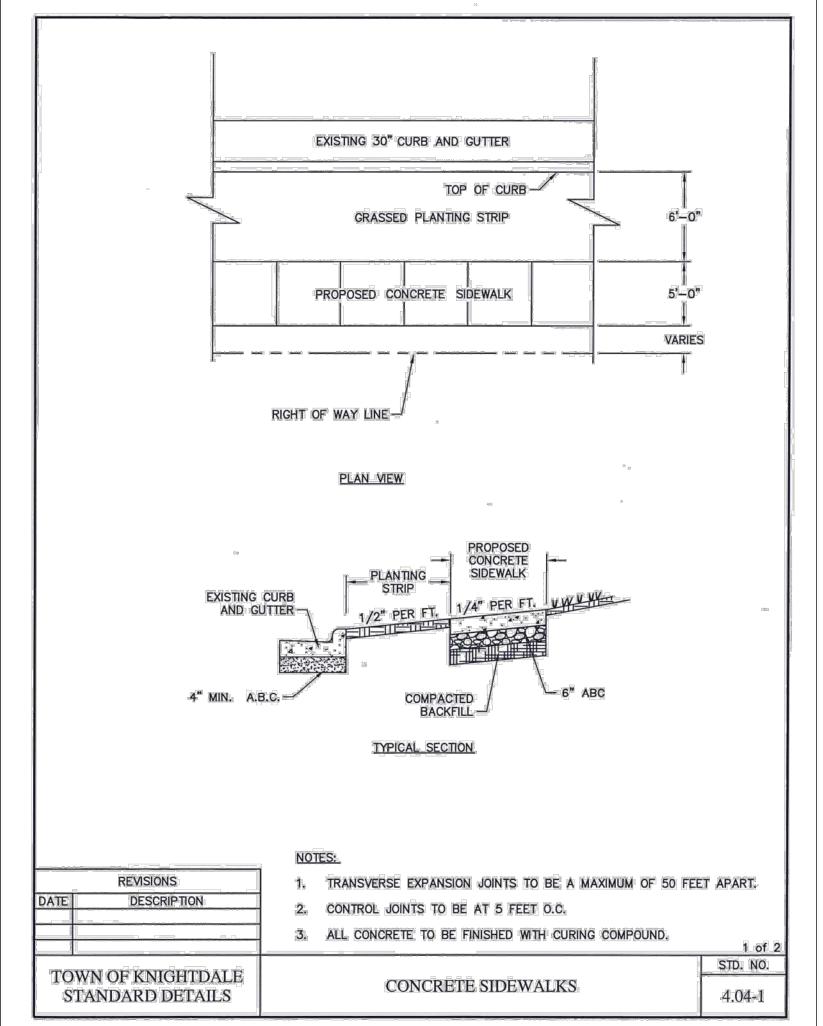


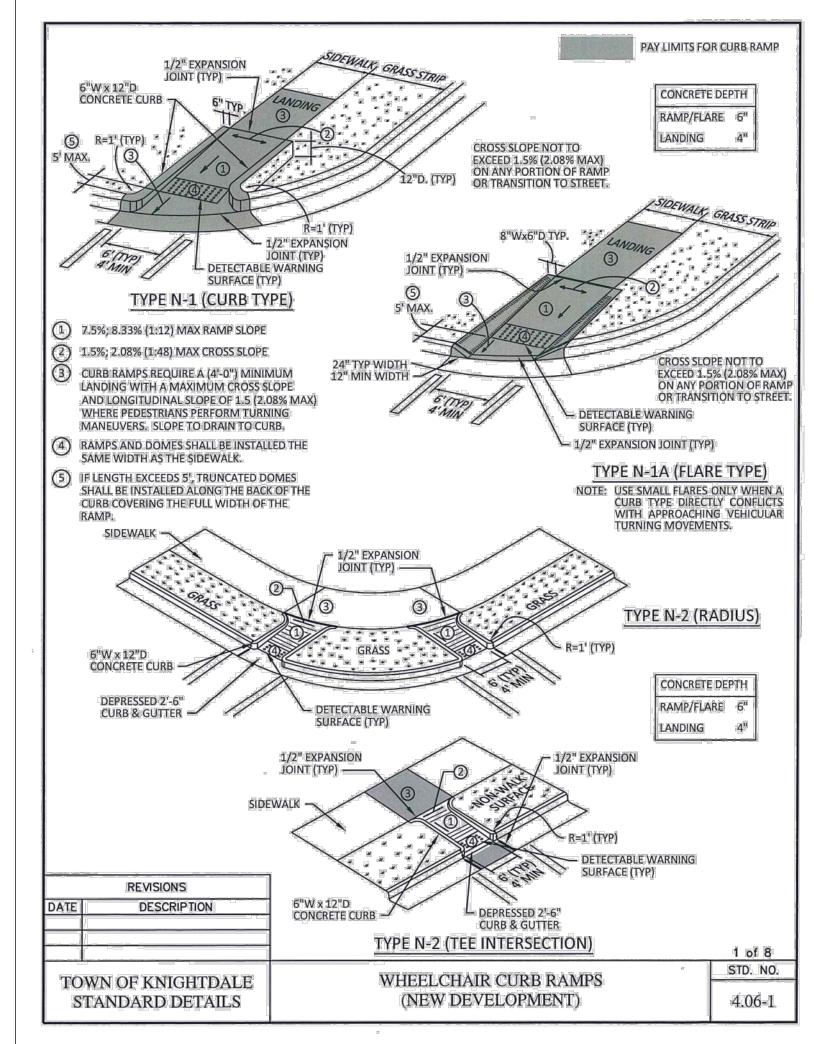

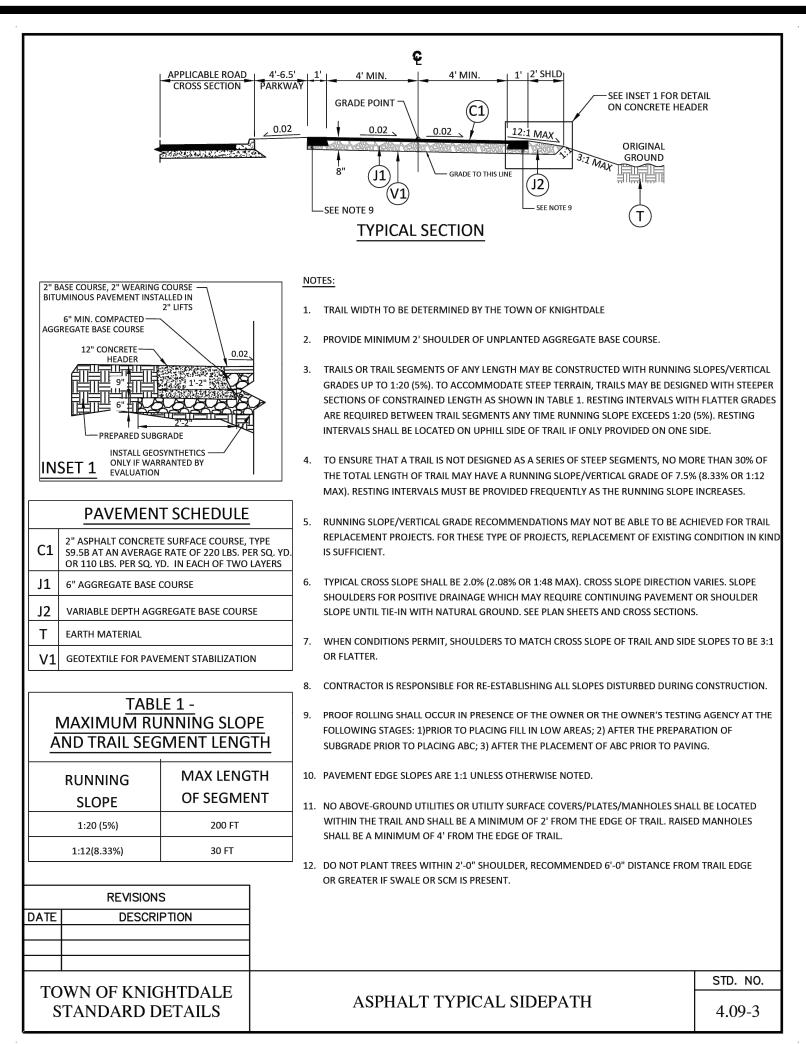

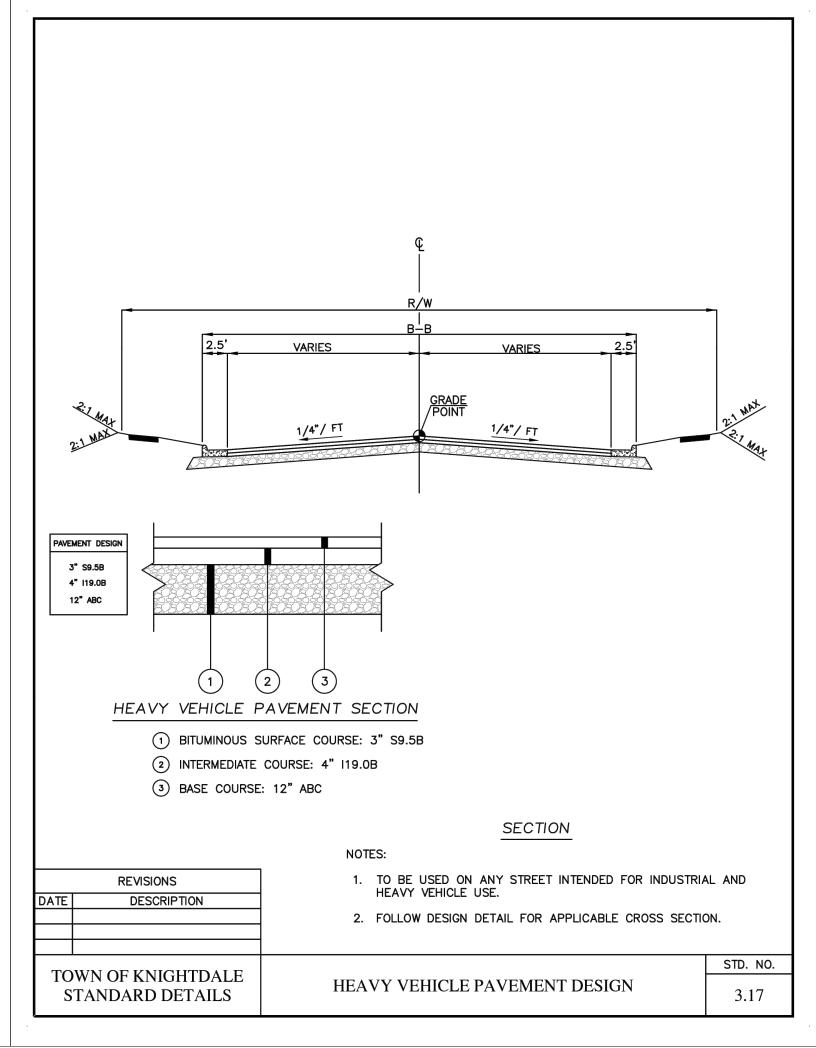

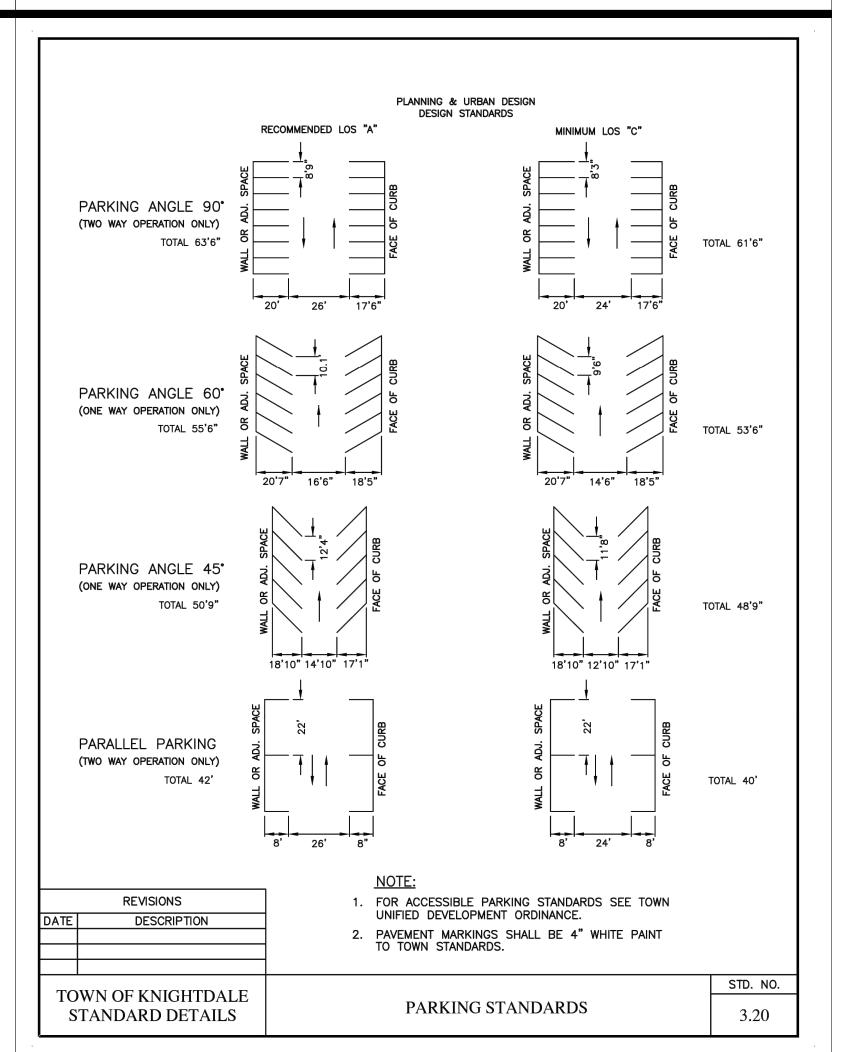

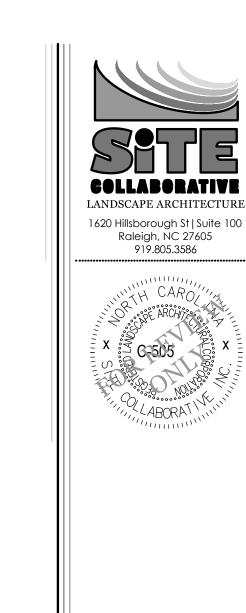

This document is the property of Site Collaborative Inc. The ideas and design incorporated on this document is an instrument of professional service and shall not be used for any other project without written authorization of Site Collaborative Inc.


REUSE OF DOCUMENT


PROJECT PHASE:
MASTER PLAN


DATE: 08.11.2025


----SHEET TITLE:


TOWN DETAILS

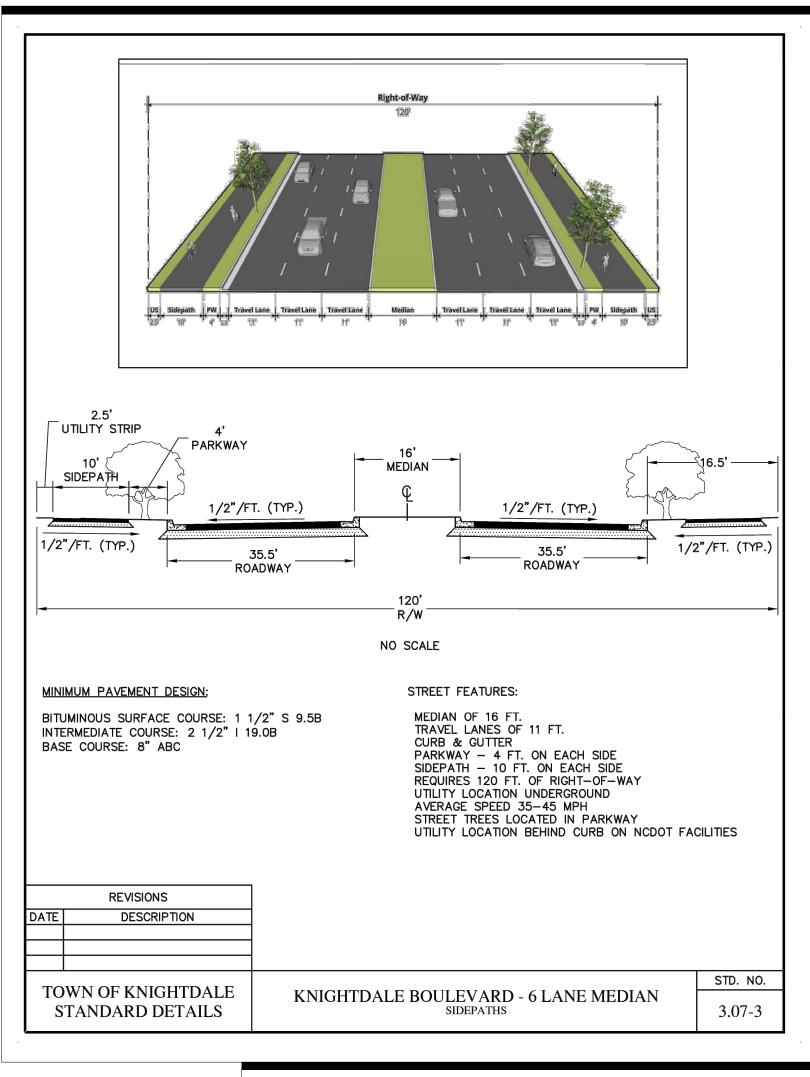


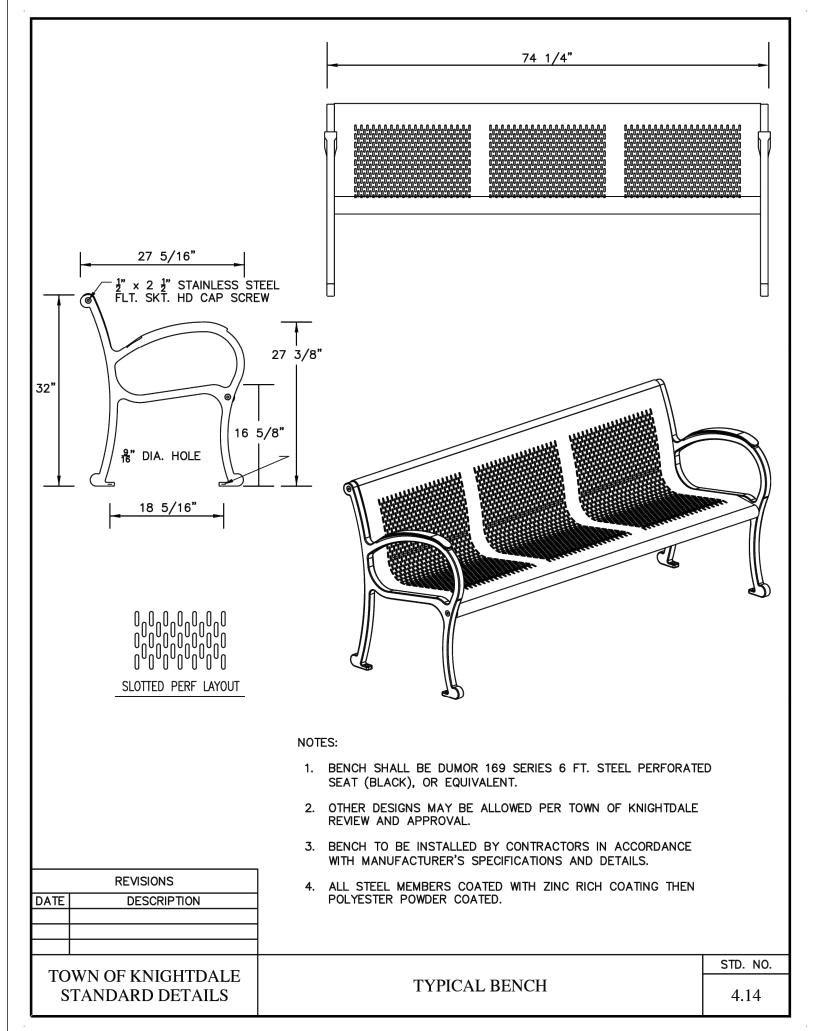

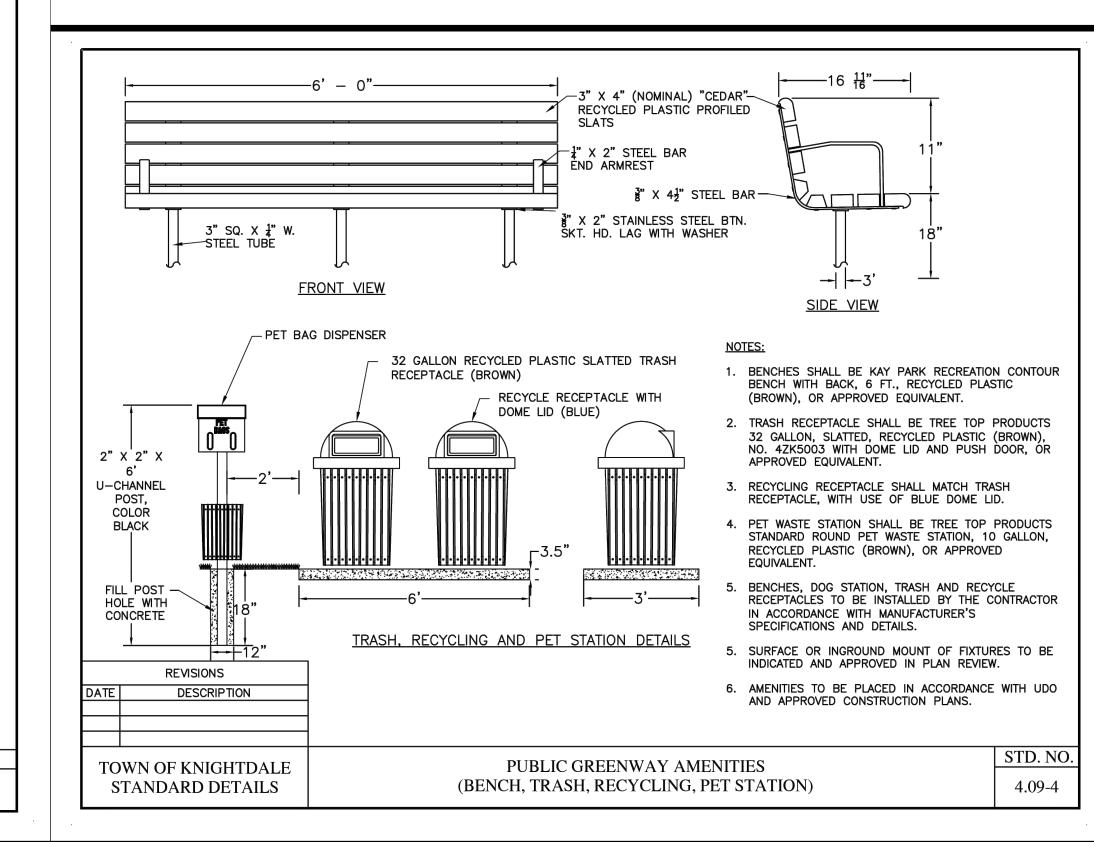

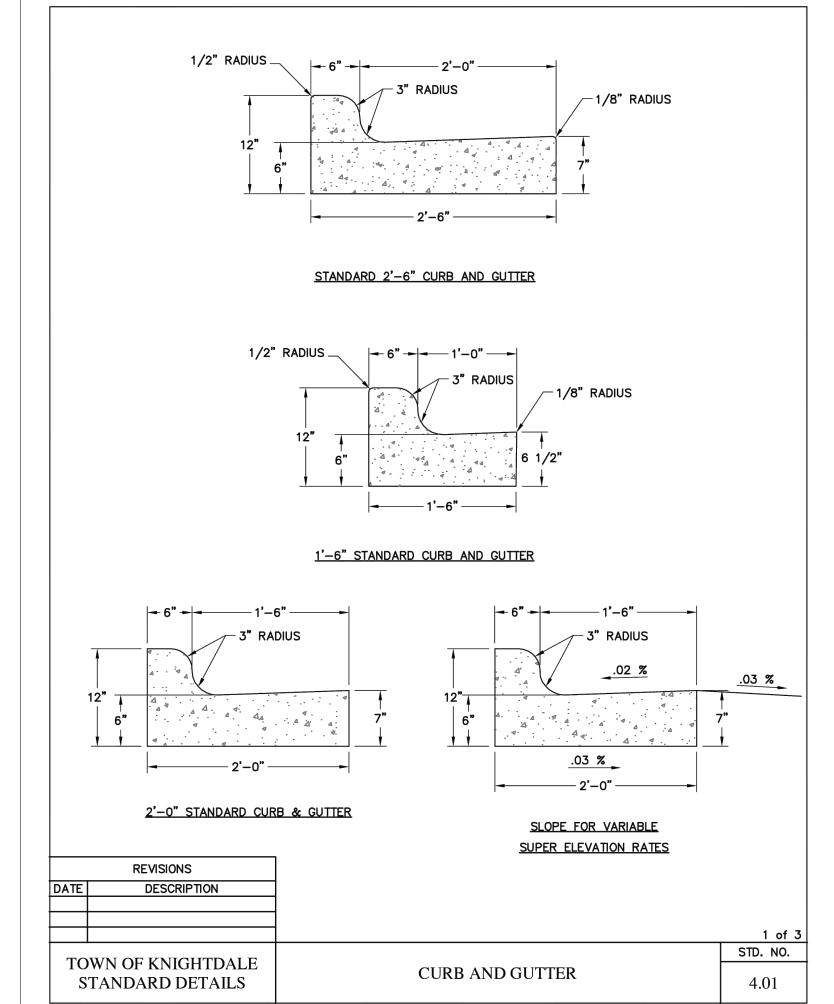

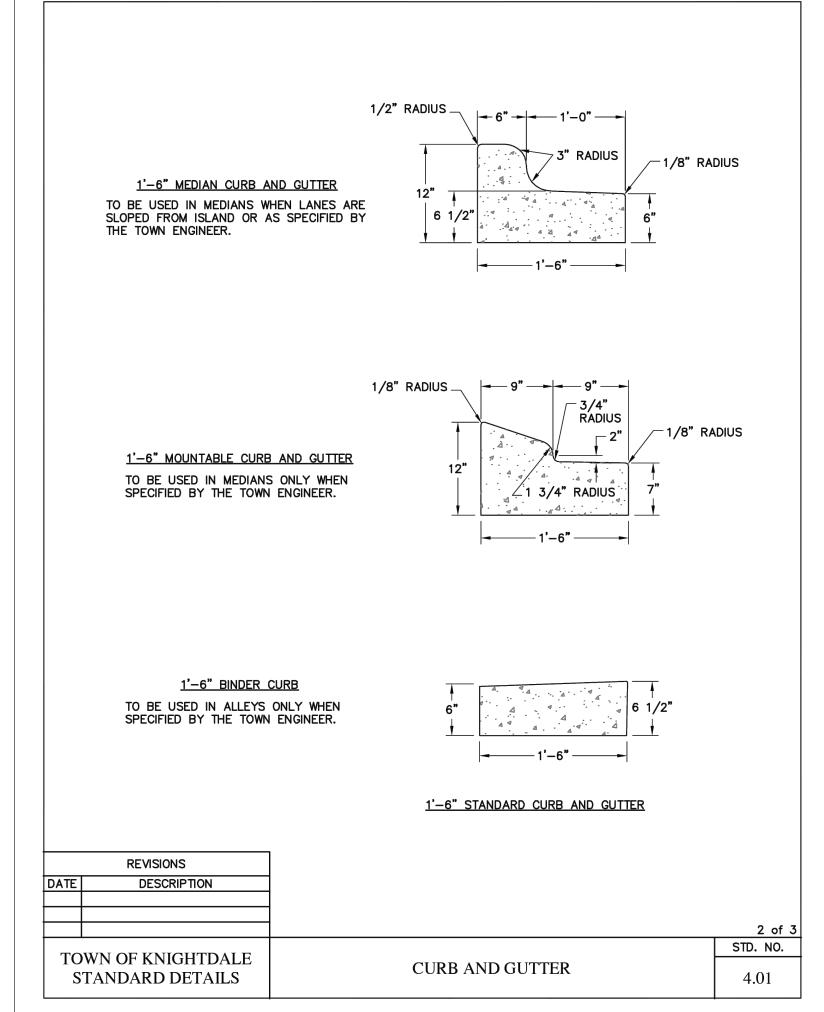

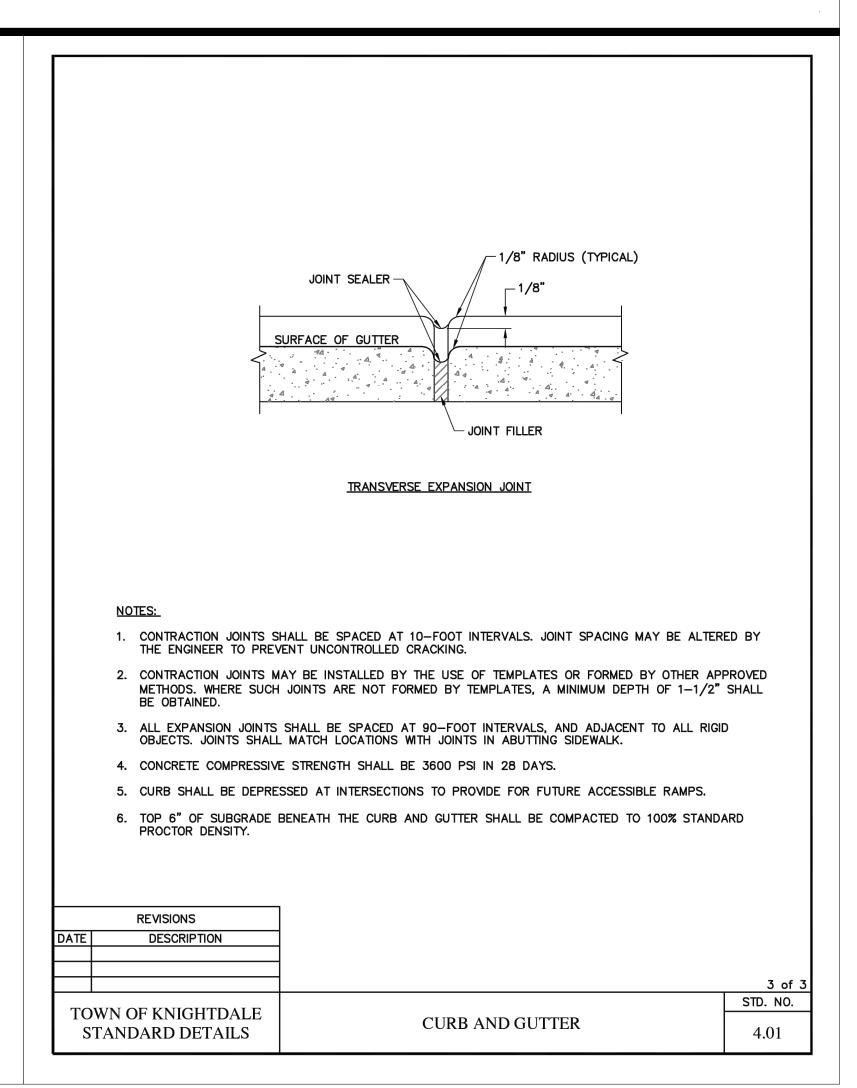





REUSE OF DOCUMENT
This document is the property of Site
Collaborative Inc. The ideas and design
incorporated on this document is an
instrument of professional service and
shall not be used for any other project
without written authorization of Site
Collaborative Inc.

BIG OAK VET HOSPIT,

VETS PETS

1004 BIG OAK COURT

PROJECT NUMBER:

PROJECT PHASE:


MASTER PLAN

DATE: 08.11.2025

SHEET TITLE:

TOWN DETAILS

1 200

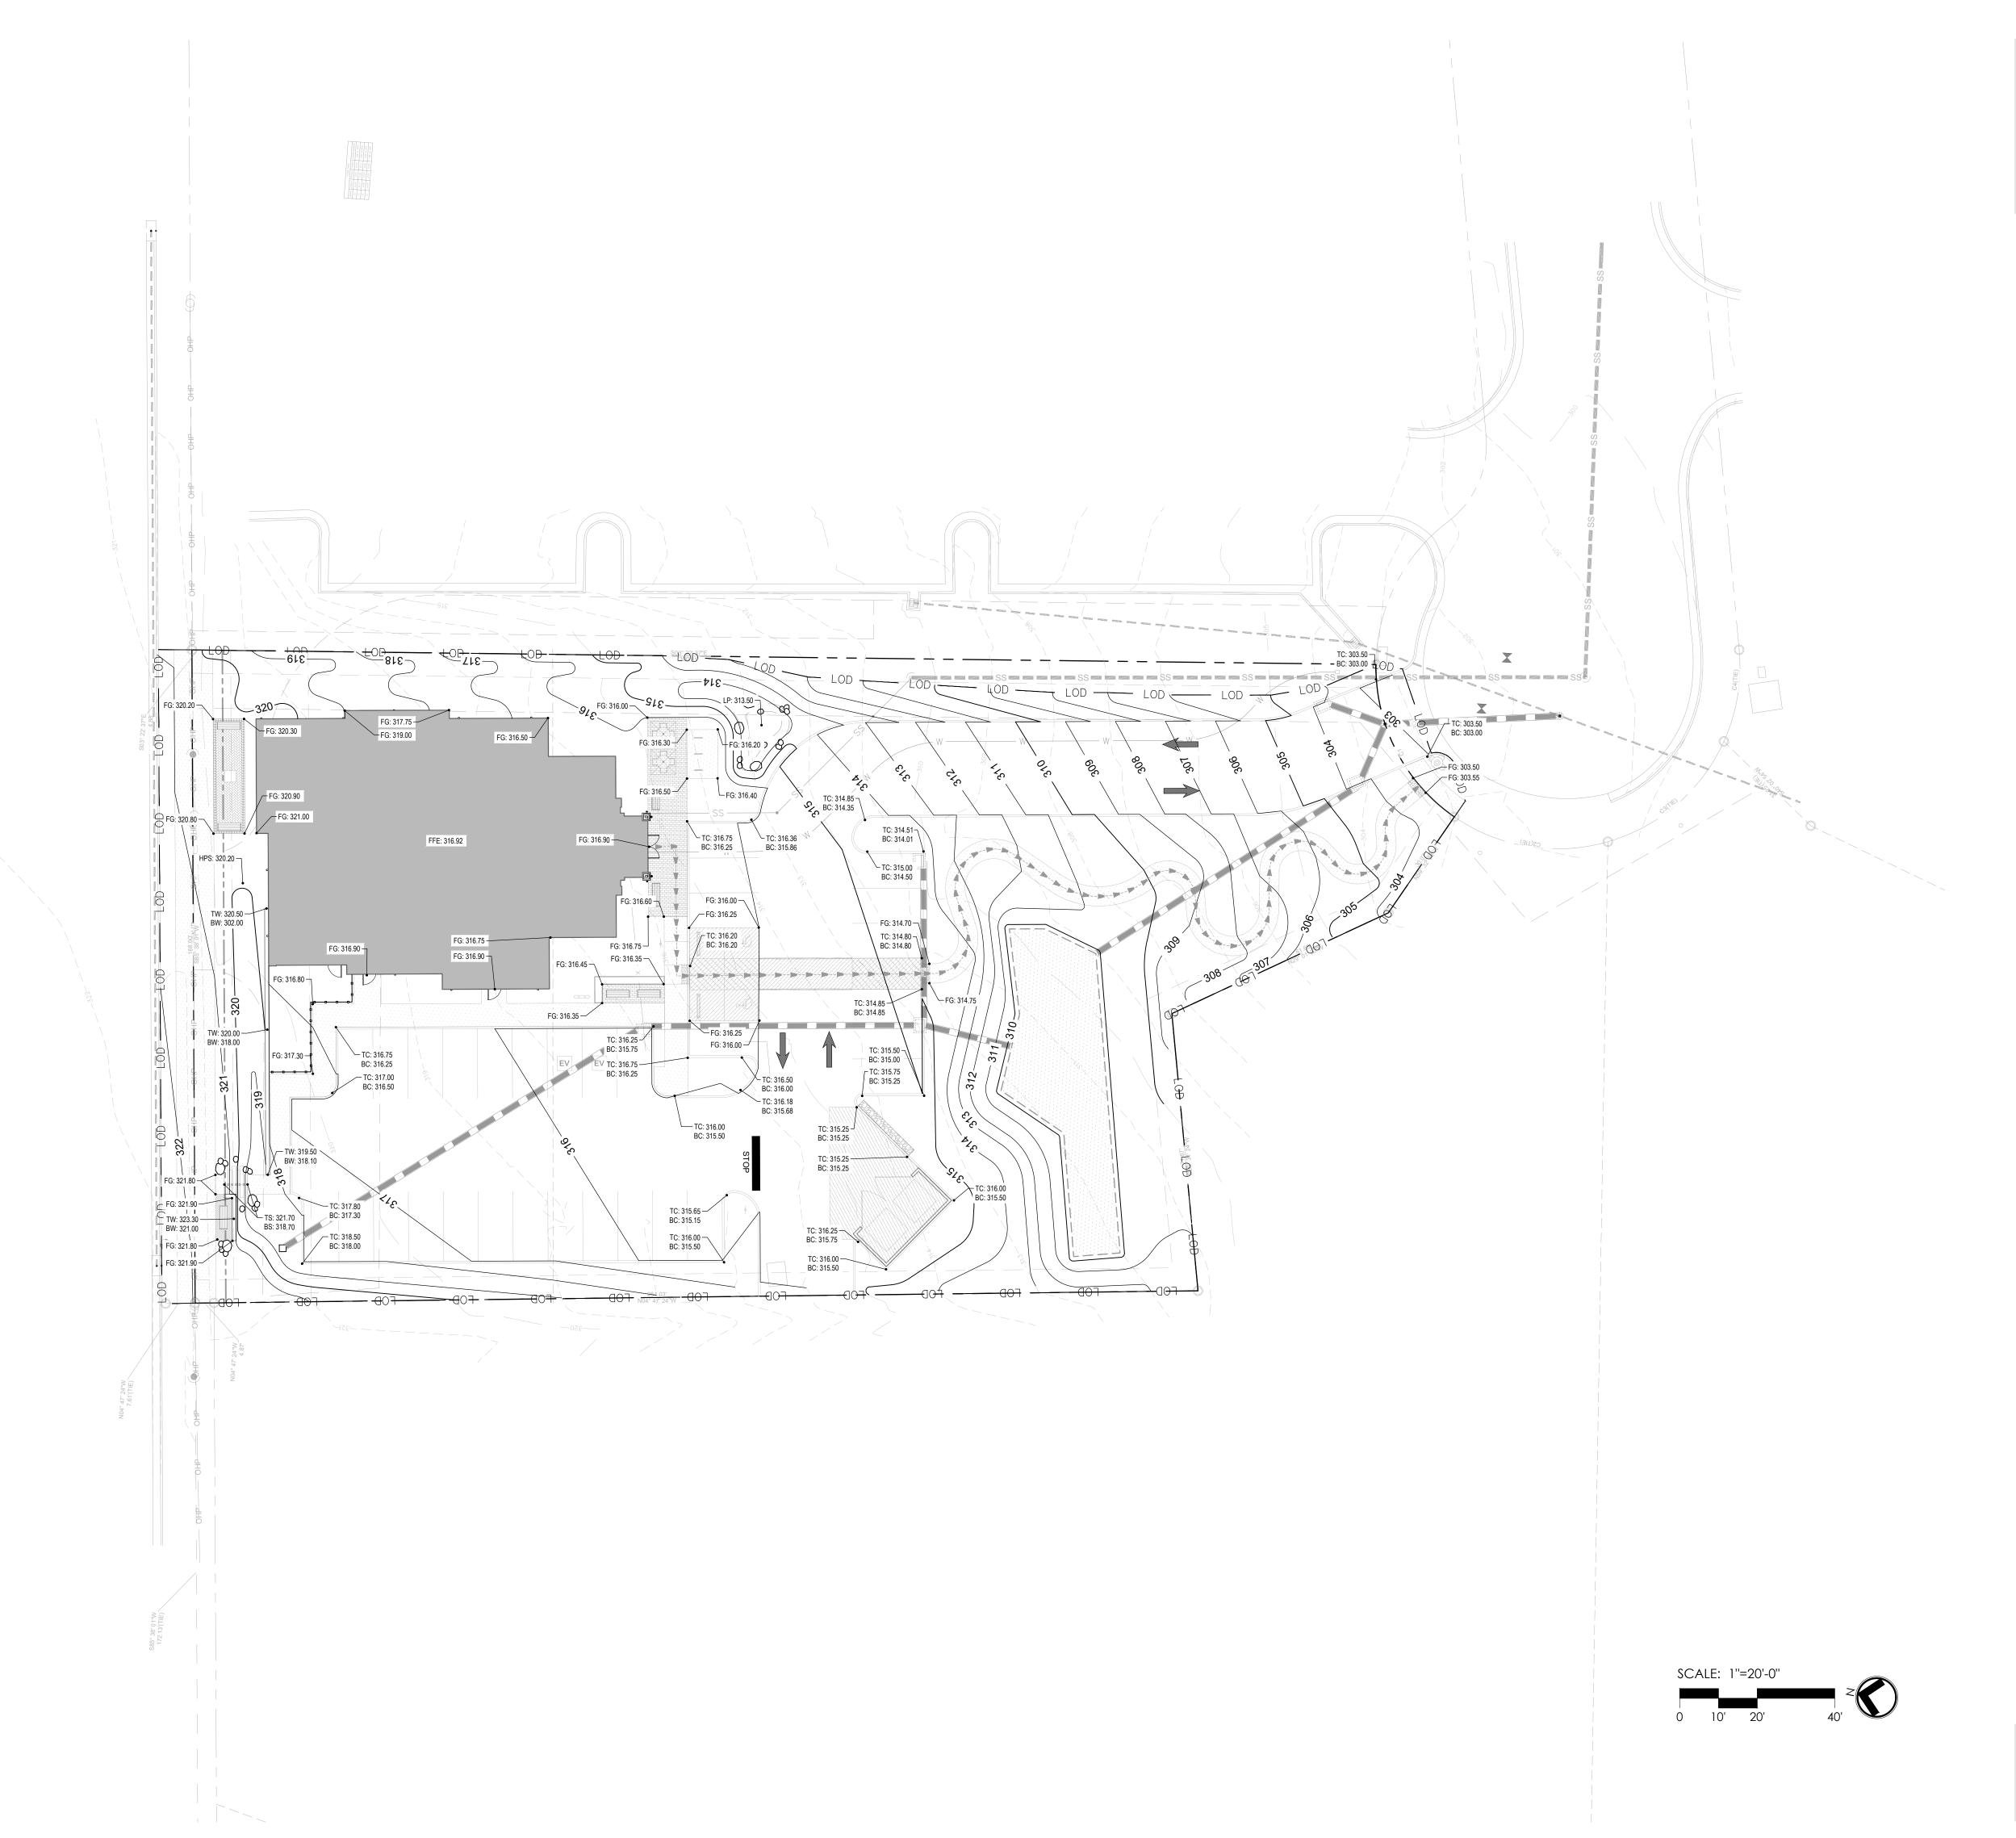





REUSE OF DOCUMENT
This document is the property of Site
Collaborative Inc. The ideas and design
incorporated on this document is an
instrument of professional service and shall not be used for any other project without written authorization of Site

Collaborative Inc.


PETS BIG (1004 BIG TOK PROJECT #: ZCP-11-24 PROJECT NUMBER:

project phase: MASTER PLAN


DATE: 08.11.2025


SHEET TITLE: GRADING PLAN


SHEET NUMBER:

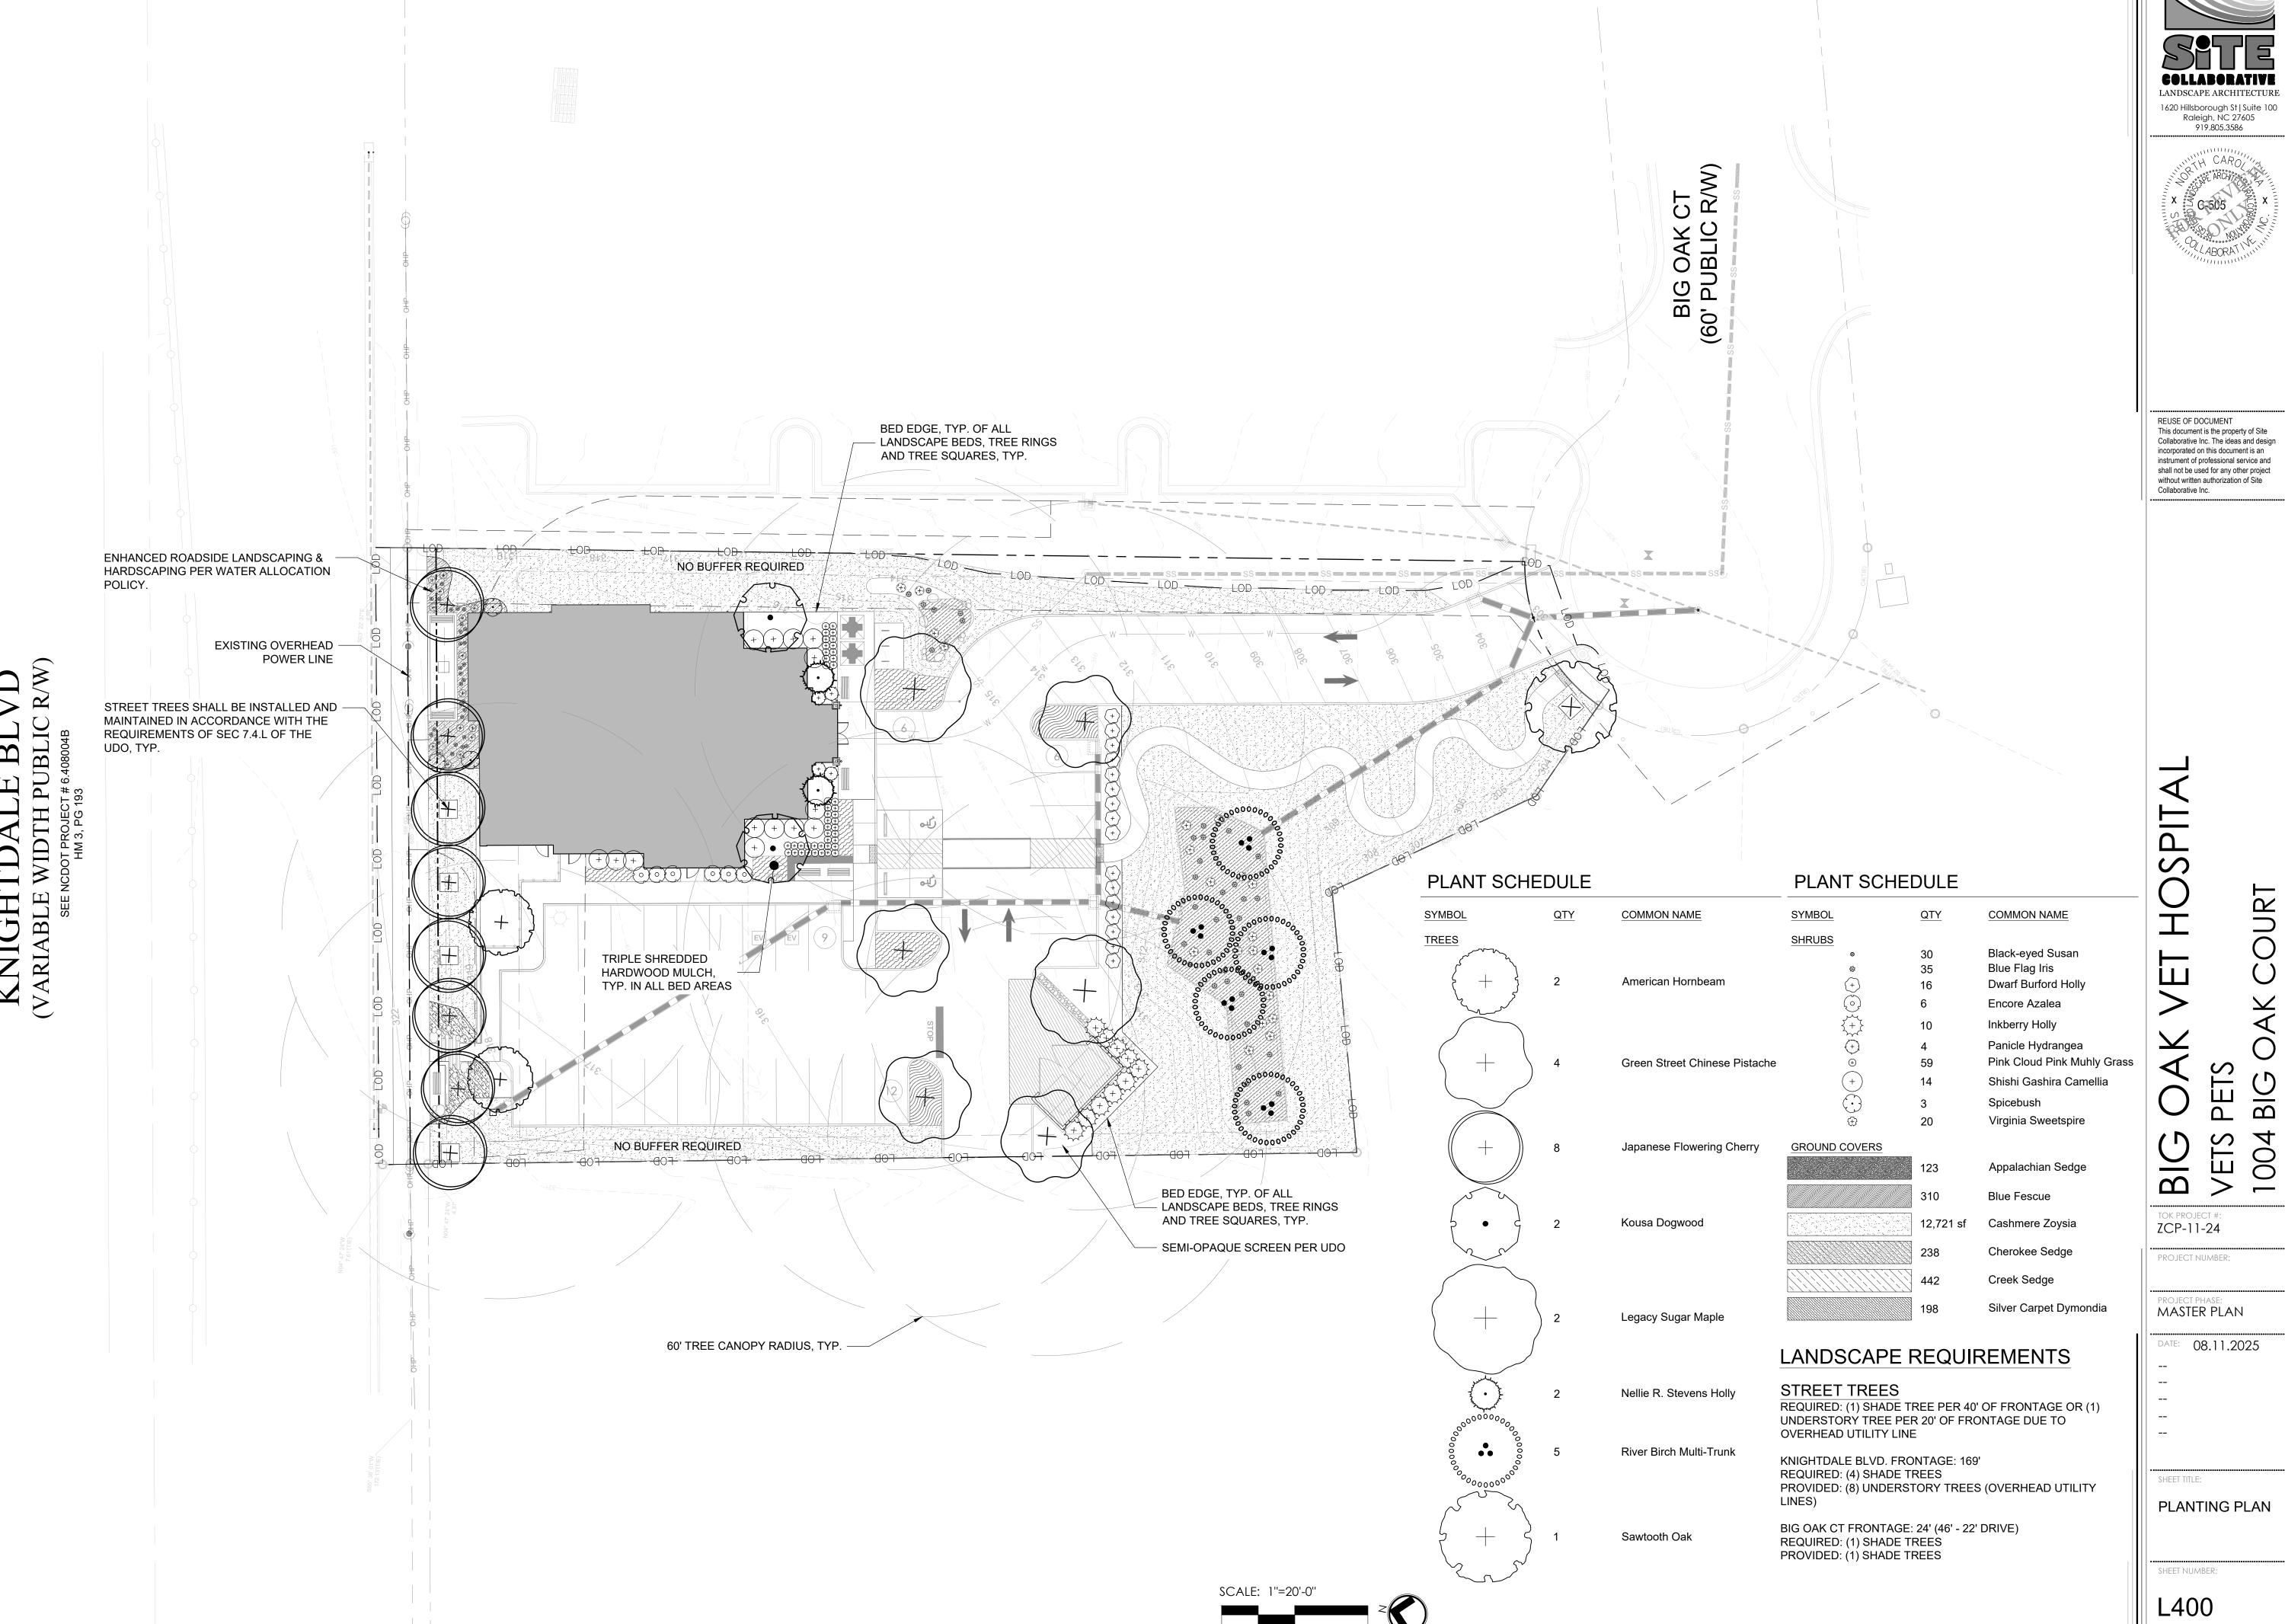

1620 Hillsborough St | Suite 100 Raleigh, NC 27605 919.805.3586

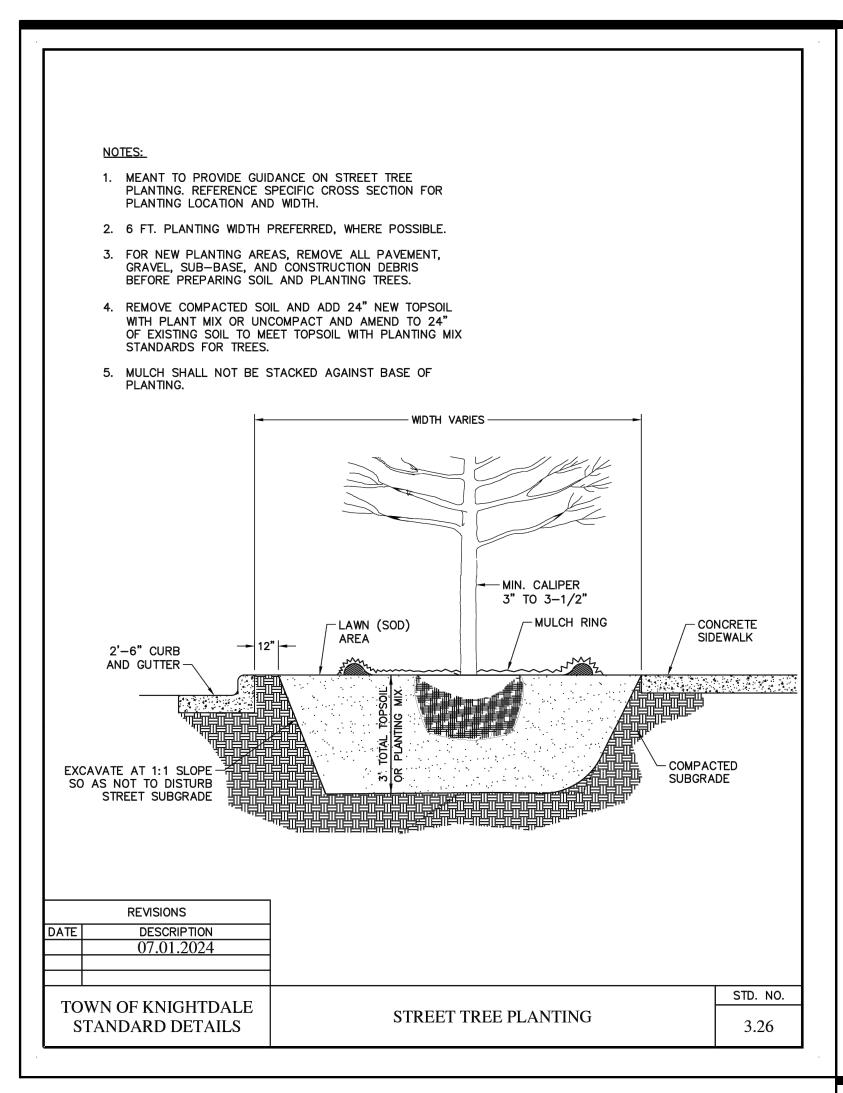

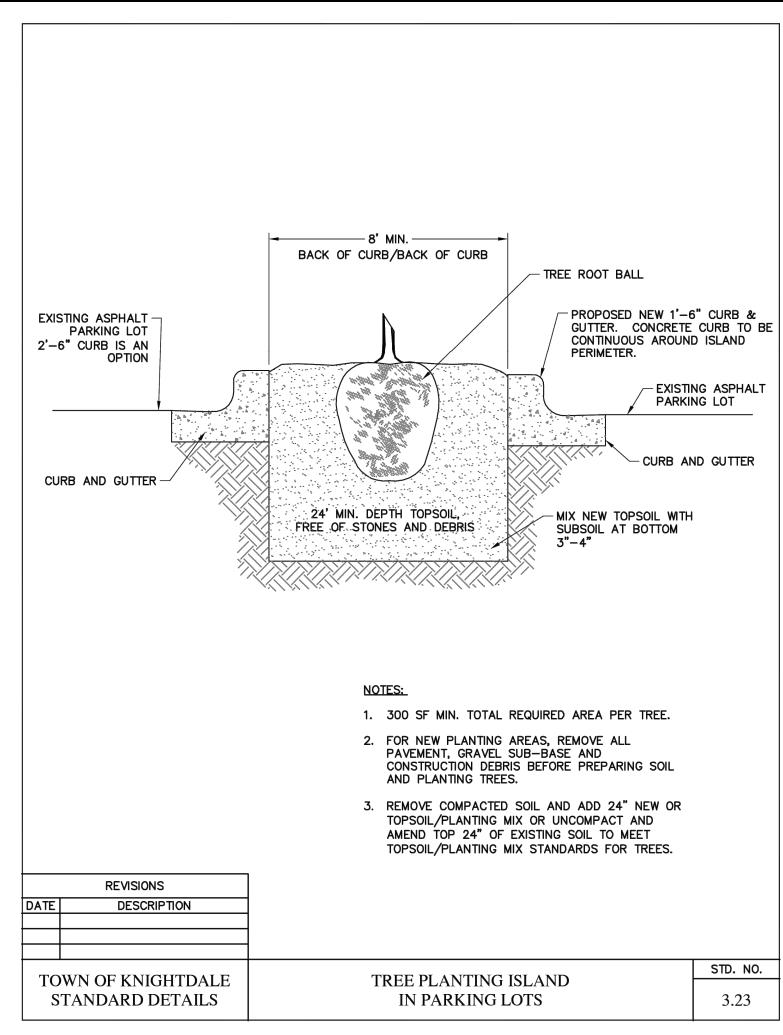

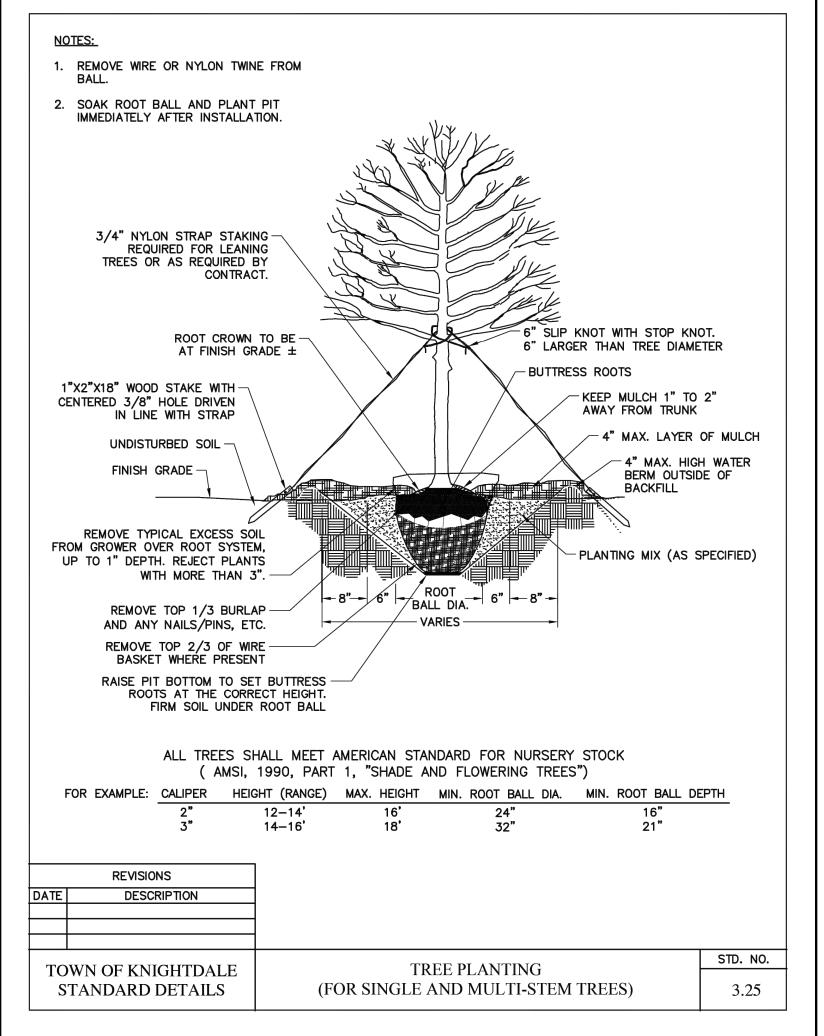

PLANT SCHEDULE

PLANT SCHE	DULE						
SYMBOL	QTY	COMMON NAME	BOTANICAL NAME	CALIPER	INSTALL HEIGHT	B&B OR CONT.	FORM
TREES							
+	2	American Hornbeam	Carpinus caroliniana	3 1/2"	14`	B&B	SINGLE LEADER
+	4	Green Street Chinese Pistache	Pistacia chinensis 'Green Street'	2 1/2"	12-14' MIN.	B&B	
	8	Japanese Flowering Cherry	Prunus serrulata `Snow Goose`	2 1/2"	10-12' MIN.	B&B	
	2	Kousa Dogwood	Cornus kousa	1 1/2"	10' MIN.	B&B	SINGLE STEM
+	2	Legacy Sugar Maple	Acer saccharum 'Legacy'	2 1/2"		B&B	
0000000	2	Nellie R. Stevens Holly	llex x 'Nellie R. Stevens'		8-10' MIN.	B&B	
	5	River Birch Multi-Trunk	Betula nigra	1 1/2"	8-10' MIN.	B&B	2-3 TRUNKS
£ + 5	1	Sawtooth Oak	Quercus acutissima `Gobbler`	10`-12`	3"-3 1/2"	B&B	
SYMBOL	QTY	COMMON NAME	BOTANICAL NAME	SPACING	INSTALL HEIGHT	INSTALL SPREAD	TYPE
SHRUBS	30 35 16 6	Black-eyed Susan Blue Flag Iris Dwarf Burford Holly Encore Azalea	Rudbeckia hirta Iris virginica Ilex cornuta `Burfordii Nana` Azalea encore 'Autumn Royalty' TM	AS SHOWN AS SHOWN 18" MIN.	12" MIN. 18" MIN. 18" MIN. 24" MIN.	12" MIN. 16" MIN. CONTAINER	
++	10	Inkberry Holly	llex glabra	48"	24" MIN.	24" MIN.	
(+) ⊕	4 59	Panicle Hydrangea Pink Cloud Pink Muhly Grass	Hydrangea paniculata 'Fire & Ice' Muhlenbergia capillaris 'Pink Cloud'	 24"	24" MIN. 18" MIN.	42" MIN. 18" MIN.	
+	14	Shishi Gashira Camellia	Camellia sasanqua 'Shishi Gashira'		24" MIN.		
⊕	3 20	Spicebush Virginia Sweetspire	Lindera benzoin Itea virginica	AS SHOWN AS SHOWN	32" MIN. 24" MIN.	30" MIN. 24" MIN.	
GROUND COVERS	123	Appalachian Sedge	Carex appalachica	16"	12" MIN.	16" MIN.	
	310	Blue Fescue	Festuca glauca	12"	6" MIN.	10" MIN.	
	12,721 sf	Cashmere Zoysia	Zoysia x 'Cashmere'	SOD			
	238	Cherokee Sedge	Carex cherokeensis	16"	12" MIN.	12" MIN.	
	442	Creek Sedge	Carex amphibola	16"	10" MIN.	10" MIN.	
	198	Silver Carpet Dymondia	Dymondia margaretae	20"	10" MIN.	10" MIN.	





REUSE OF DOCUMENT
This document is the property of Site
Collaborative Inc. The ideas and design
incorporated on this document is an
instrument of professional service and
shall not be used for any other project

incorporated on this document is an instrument of professional service and shall not be used for any other project without written authorization of Site Collaborative Inc.

BIG OAK VET HOSPIT, VETS PETS 1004 BIG OAK COURT

TOK PROJECT #:
ZCP-11-24

PROJECT NUMBER:

PROJECT PHASE:


MASTER PLAN

DATE: 08.11.2025

ME: 08.11.2025

FULL PLANTING
SCHEDULE

SHEET NUMBER:

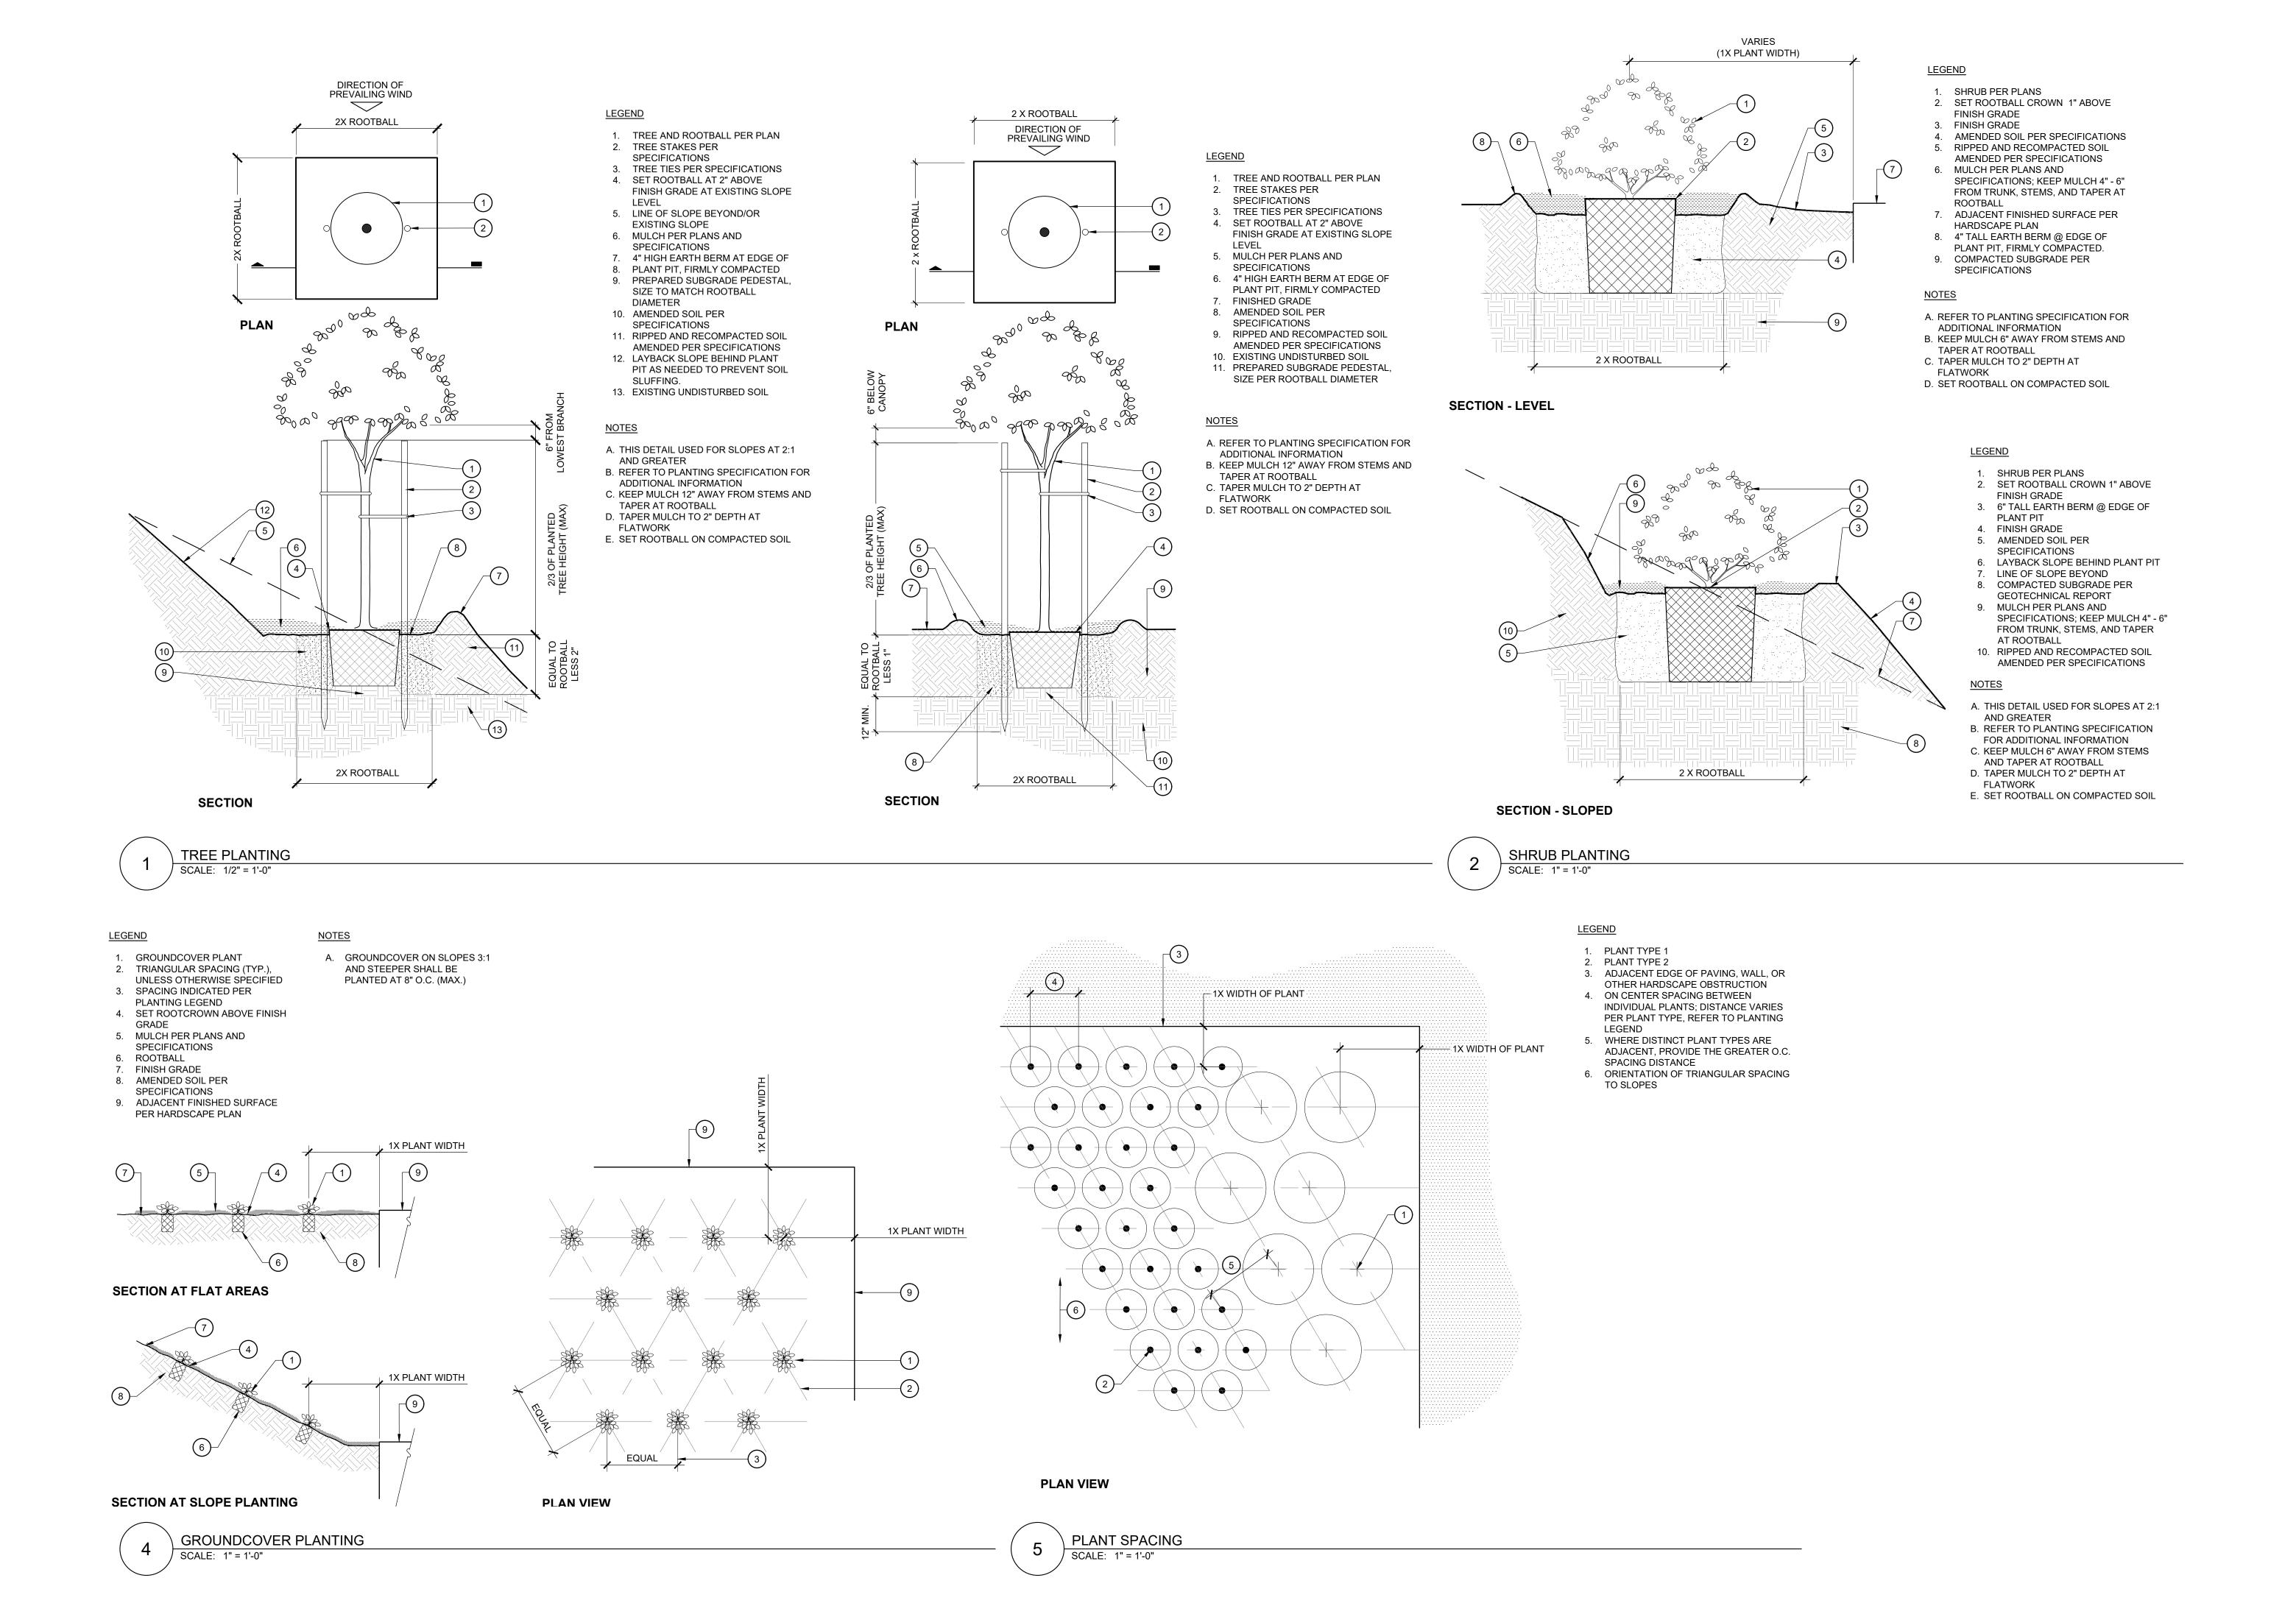

COLLABORATIVE LANDSCAPE ARCHITECTURE 1620 Hillsborough St | Suite 100 Raleigh, NC 27605 919.805.3586



REUSE OF DOCUMENT This document is the property of Site Collaborative Inc. The ideas and design incorporated on this document is an instrument of professional service and shall not be used for any other project without written authorization of Site

Collaborative Inc.

BIG 00 $\overline{\mathbf{B}}$

TOK PROJECT #: ZCP-11-24 PROJECT NUMBER:

MASTER PLAN

DATE: 08.11.2025

PLANTING DETAILS

SHEET NUMBER:

SHEET TITLE:

DUKE ENERGY LIGHTING PLANTOBE PROVIDED





REUSE OF DOCUMENT
This document is the property of Site
Collaborative Inc. The ideas and design
incorporated on this document is an
instrument of professional service and
shall not be used for any other project
without written authorization of Site

BIG OAK VEI HOSPIII/ VETS PETS 1004 BIG OAK COURT


PROJECT NUMBER:

ZCP-11-24

MASTER PLAN

DATE: 08.11.2025

LIGHTING PLAN

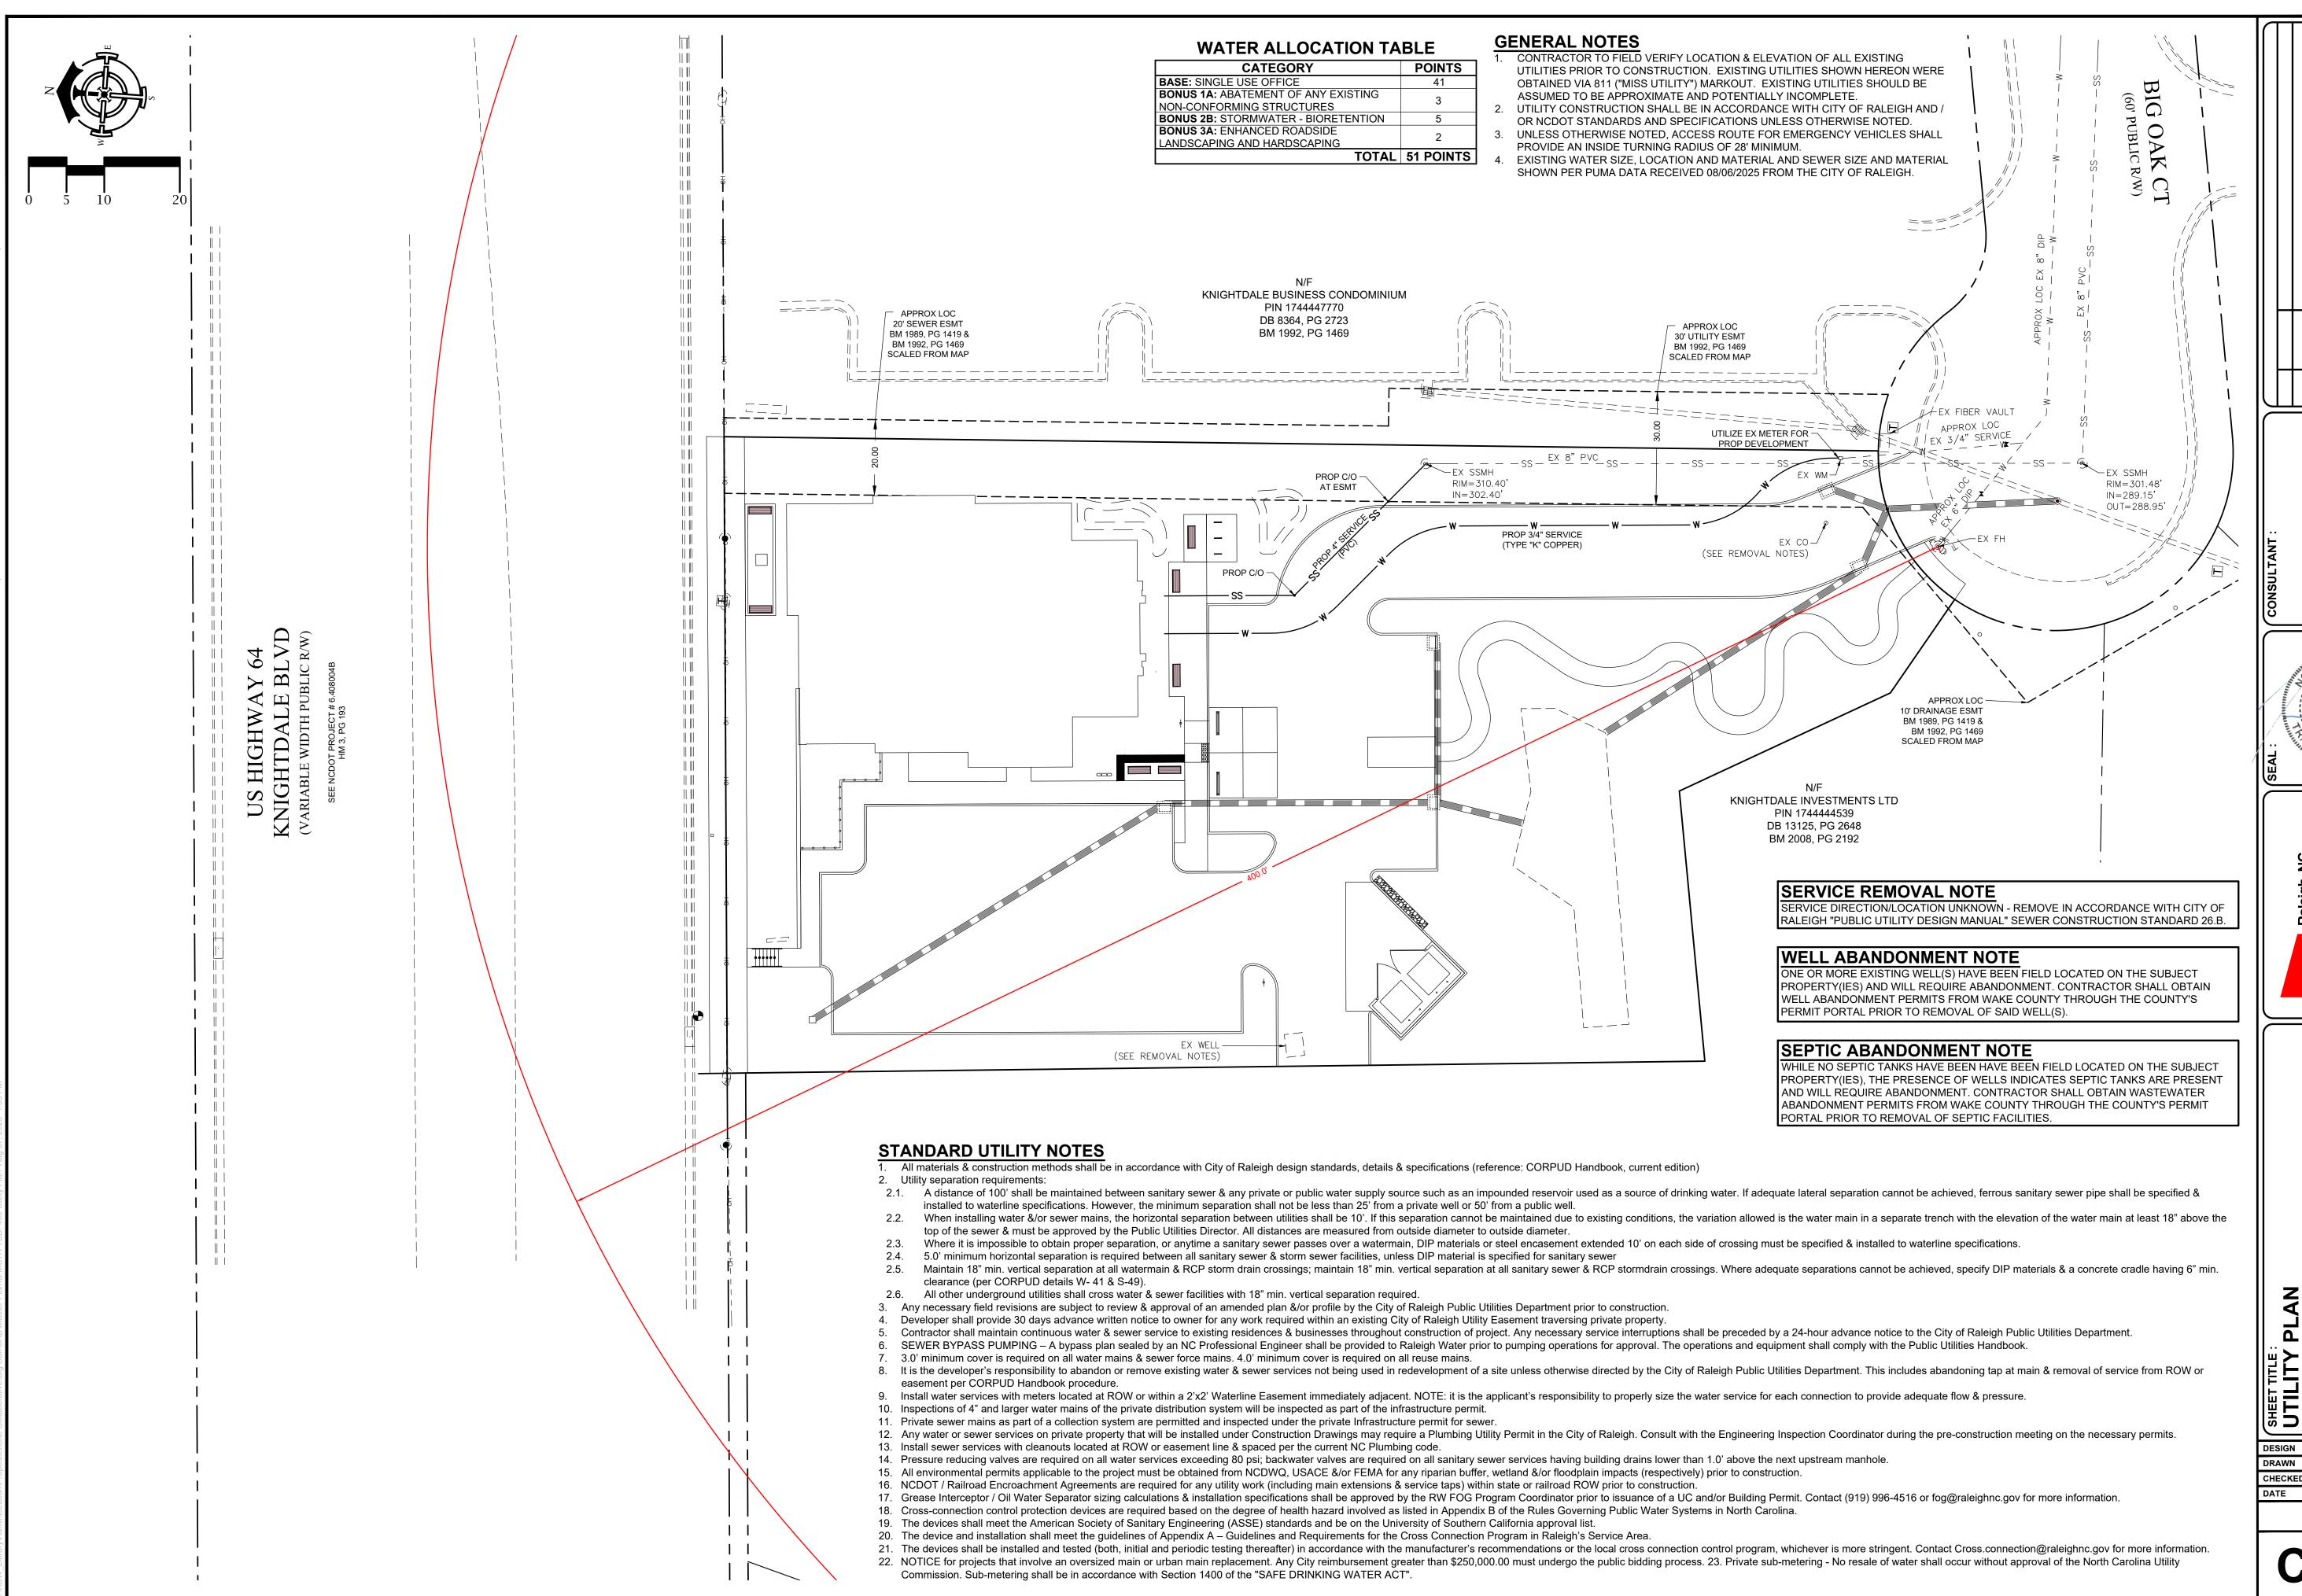


CHECKED

DATE 08/1

PROJECT No.

XXX


SHEET NUMBER

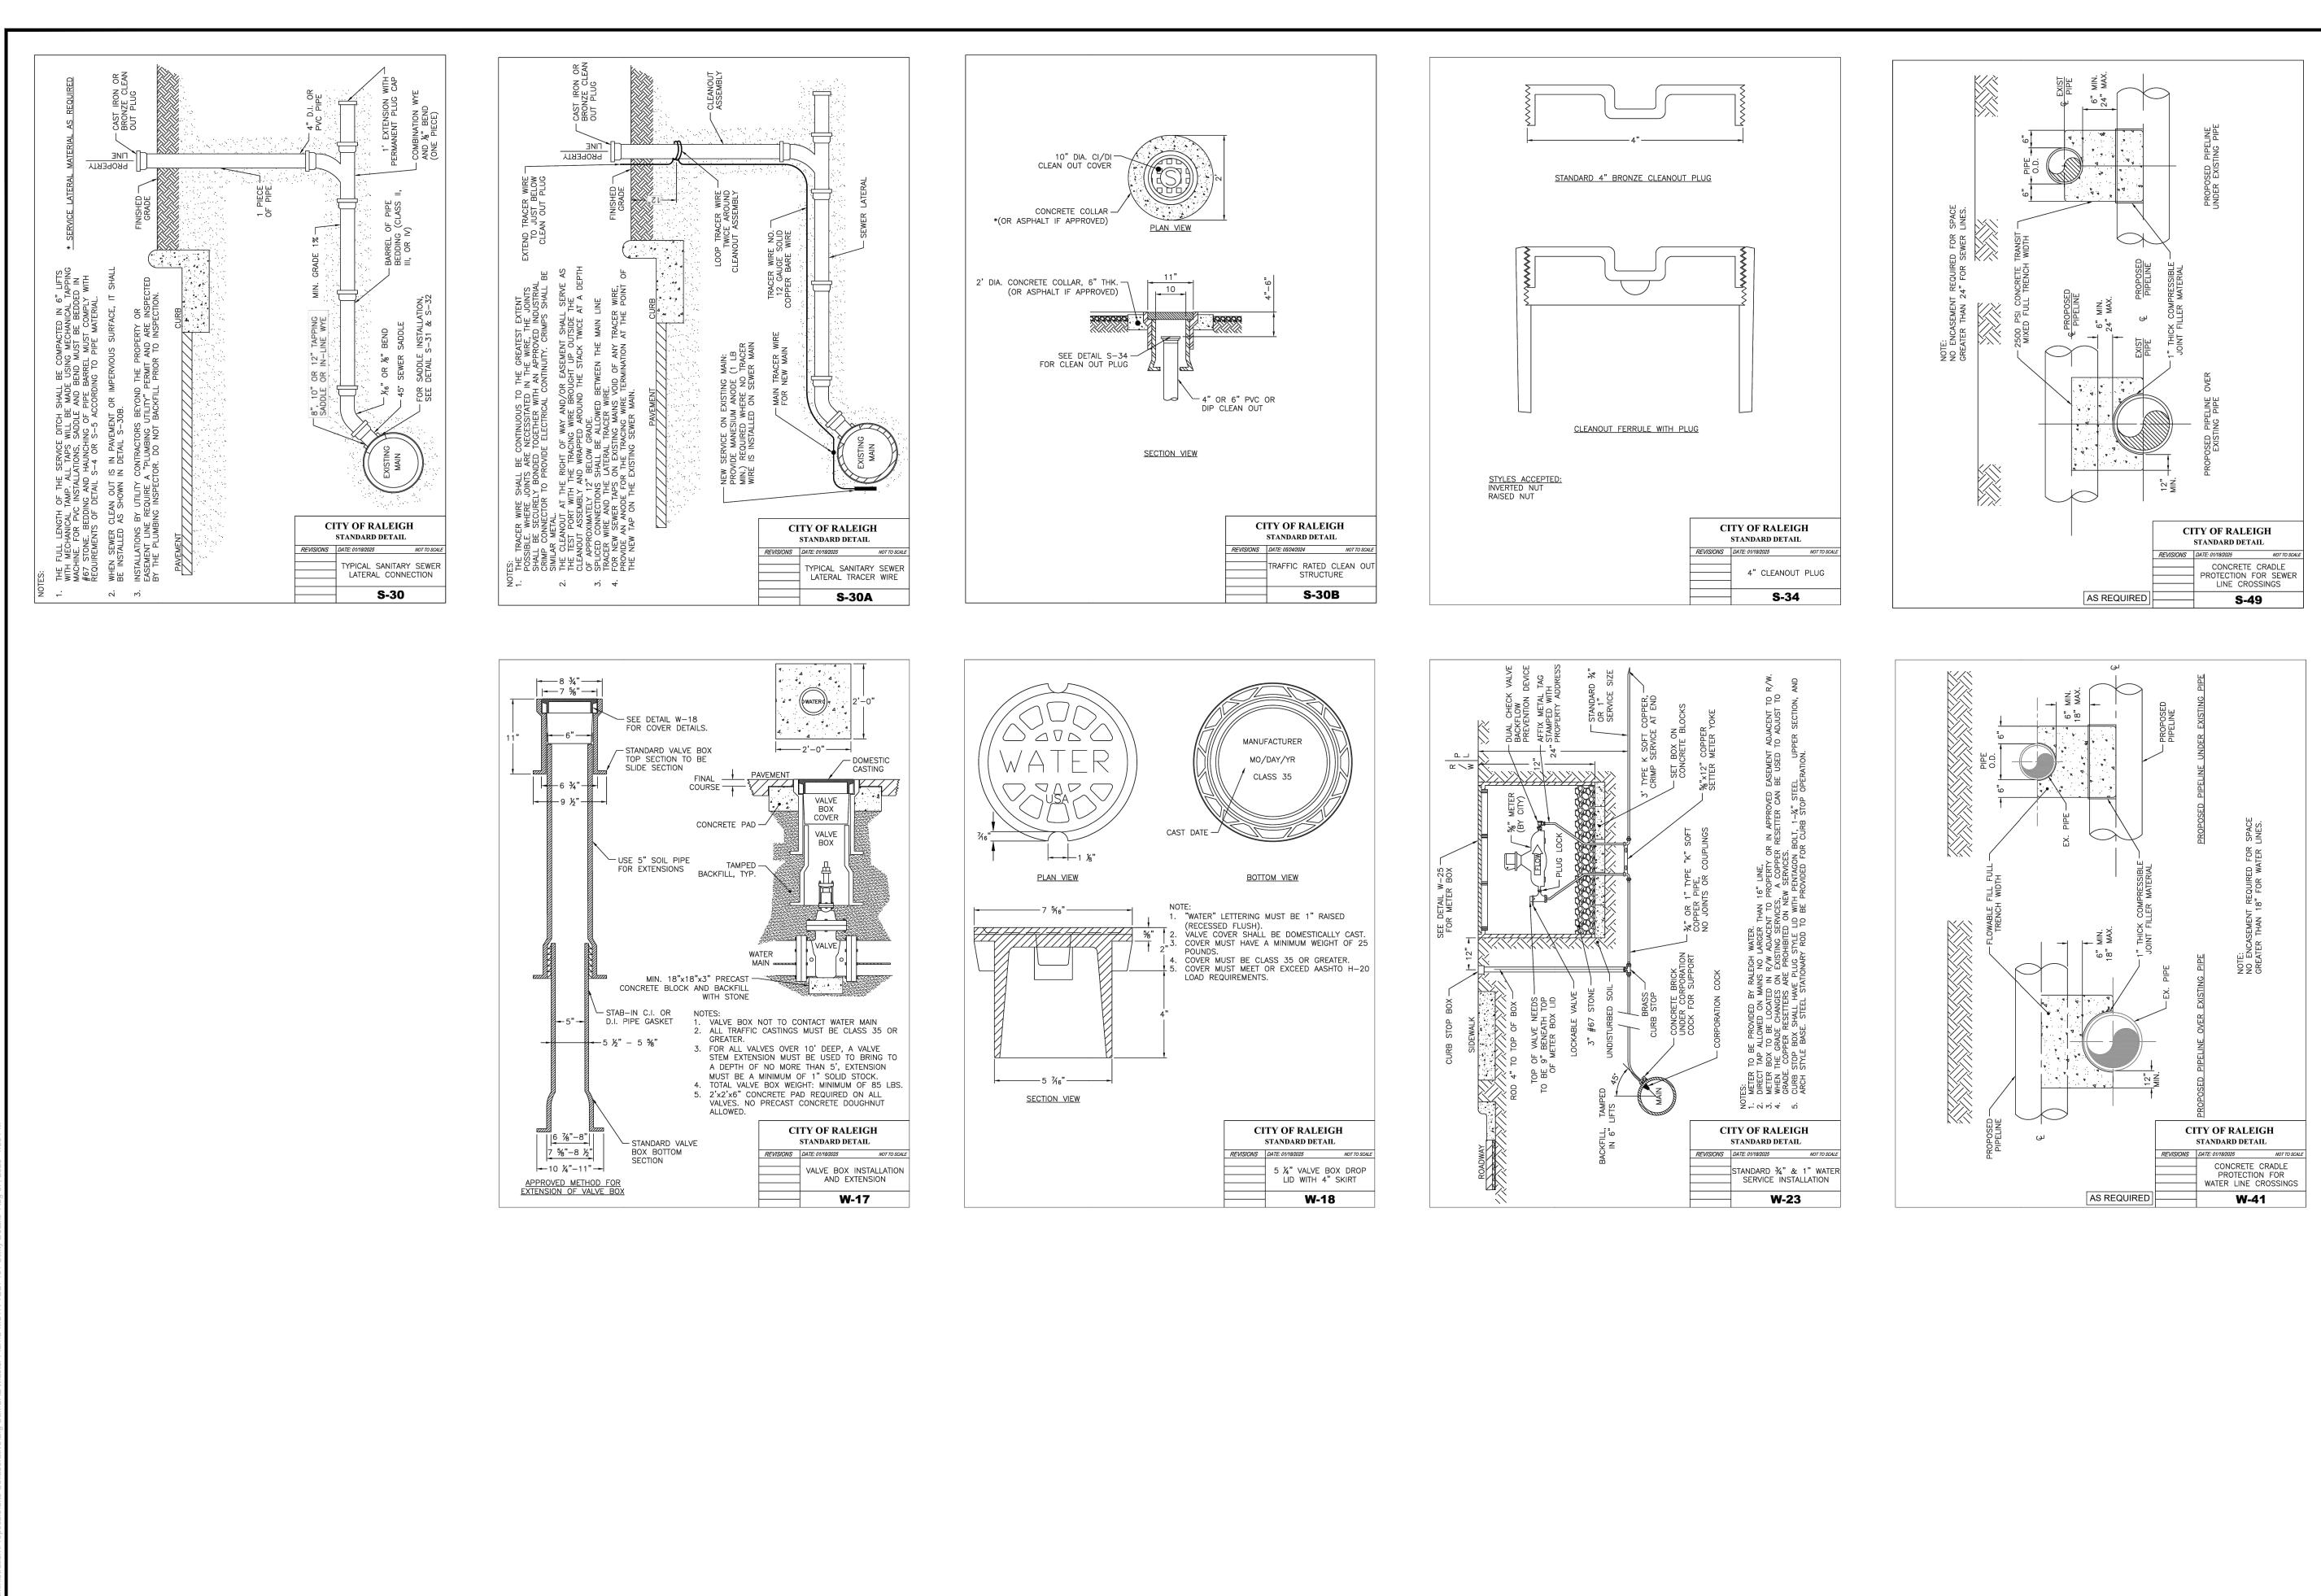


HOSPITA DETAIL 디

PROJECT:
BIG OAK
VETS PETS
1004 BIG OA DESIGN DRAWN CHECKED DATE 08/11/2025 PROJECT No.

XXX

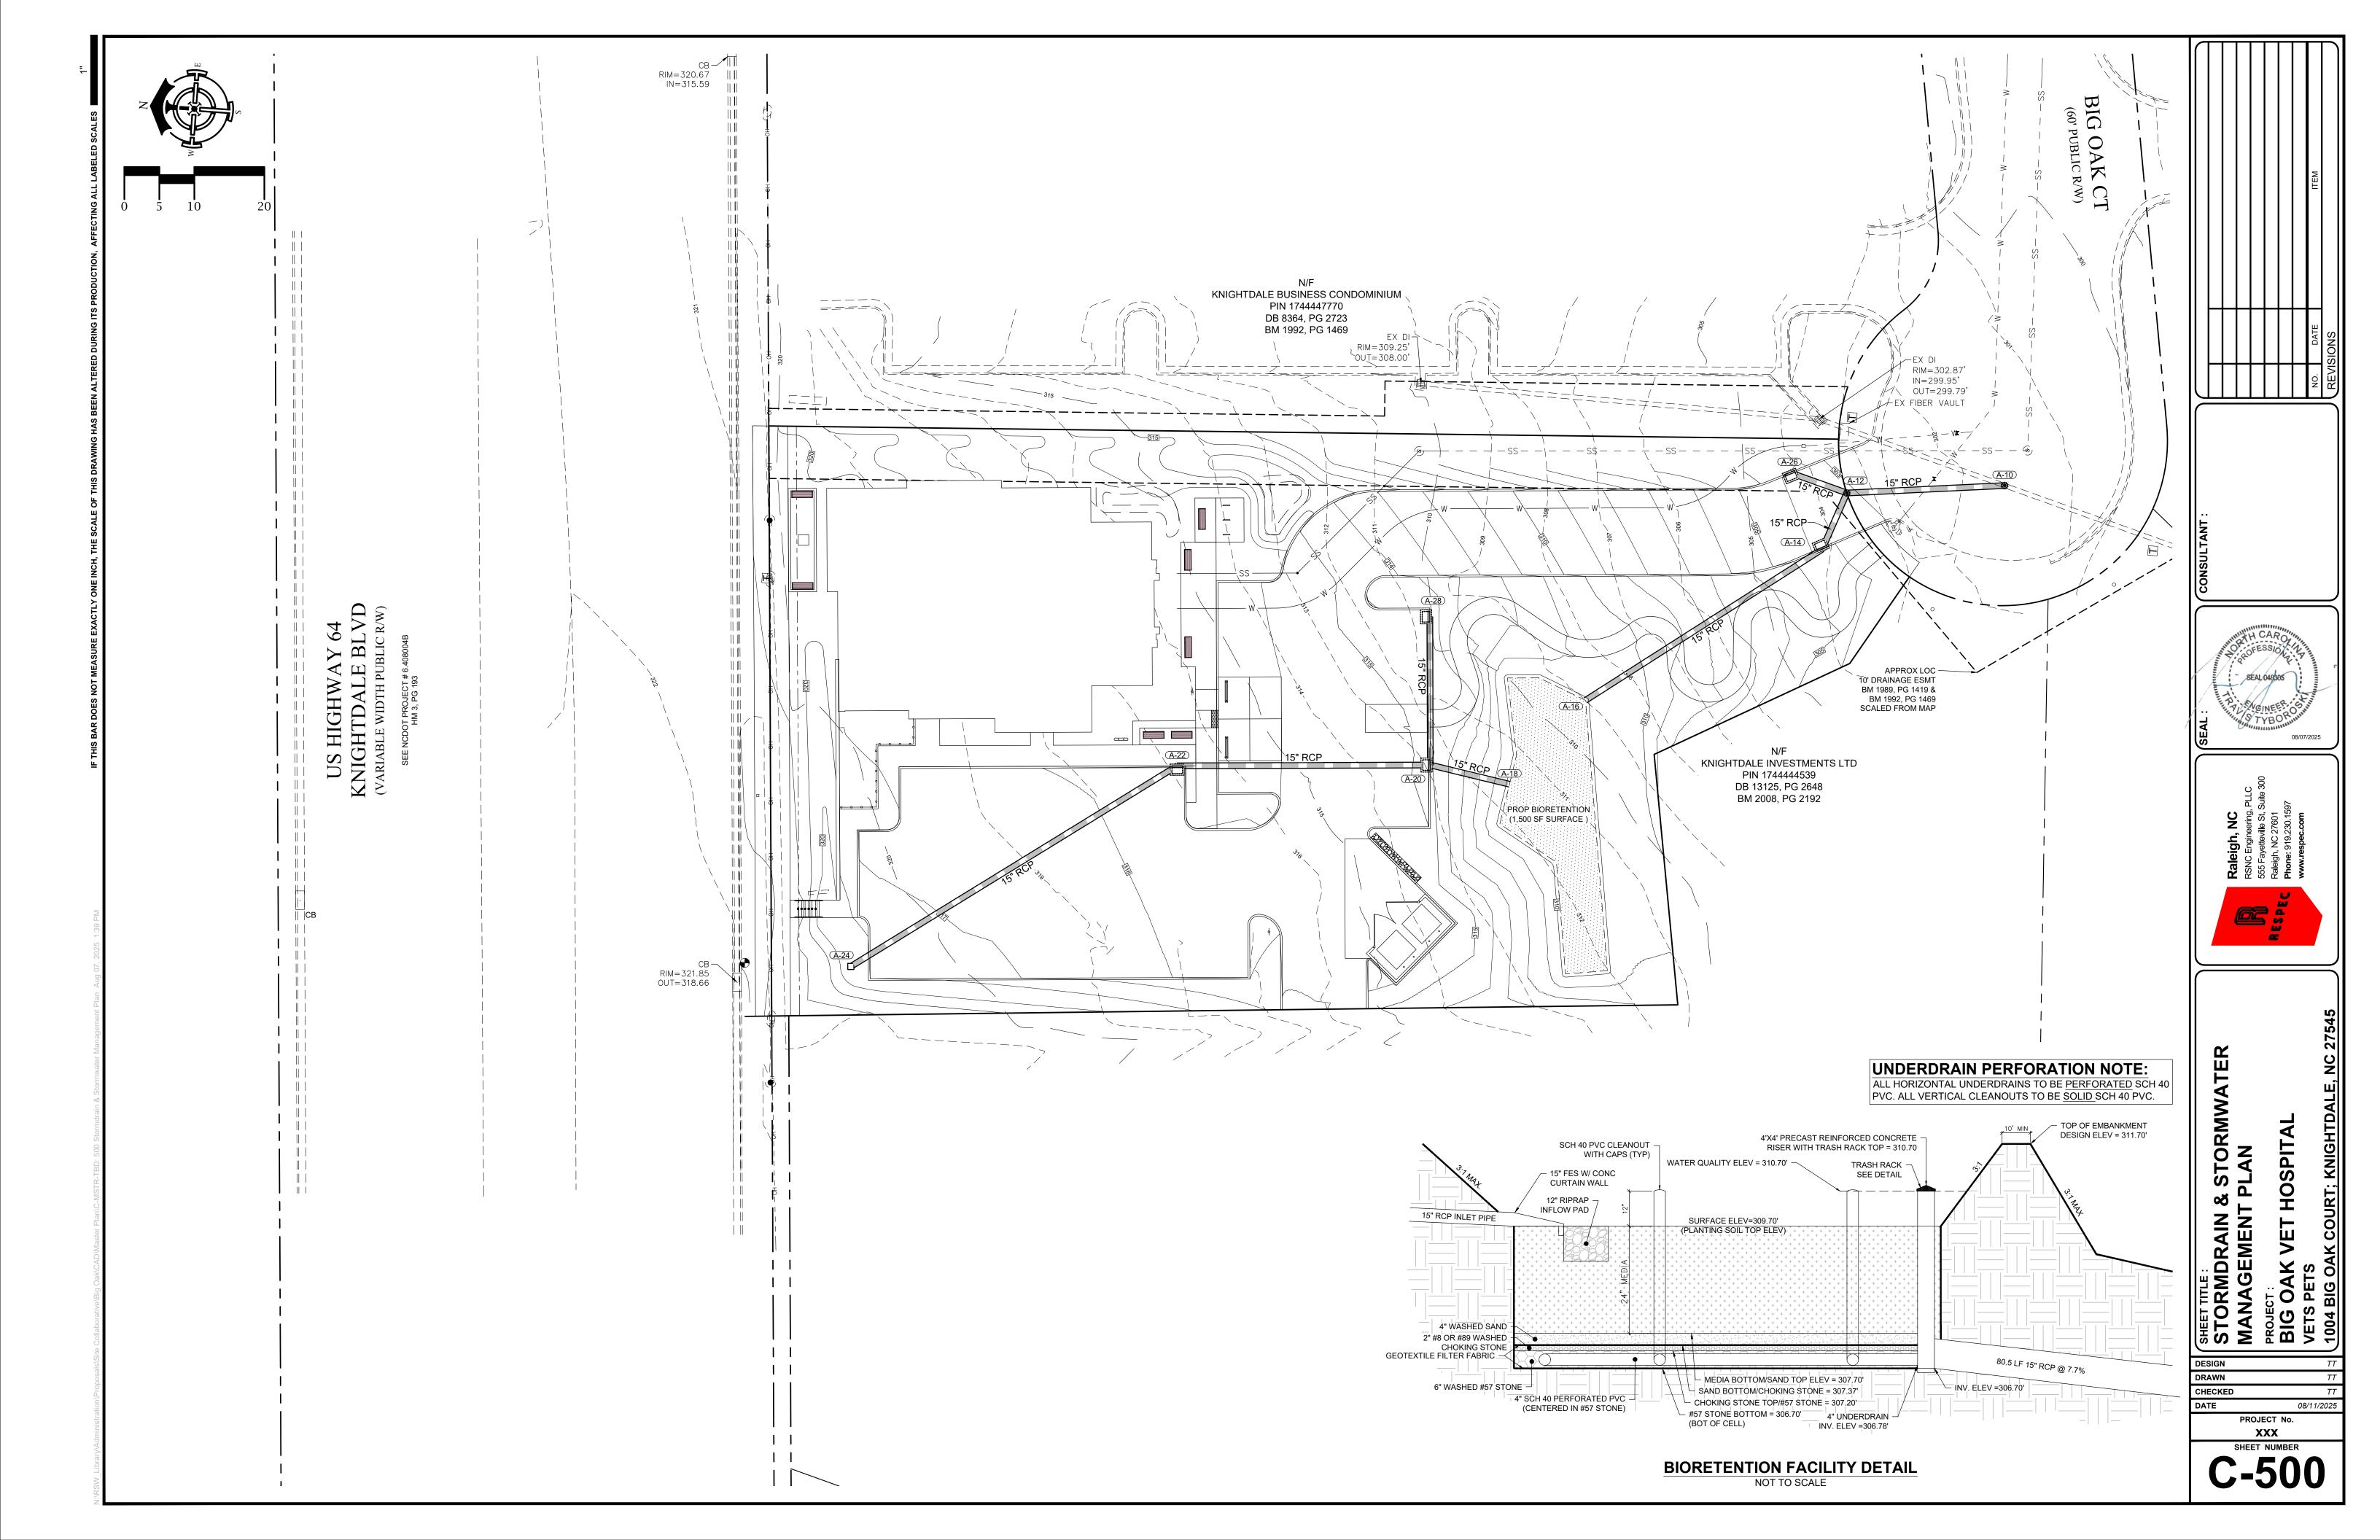

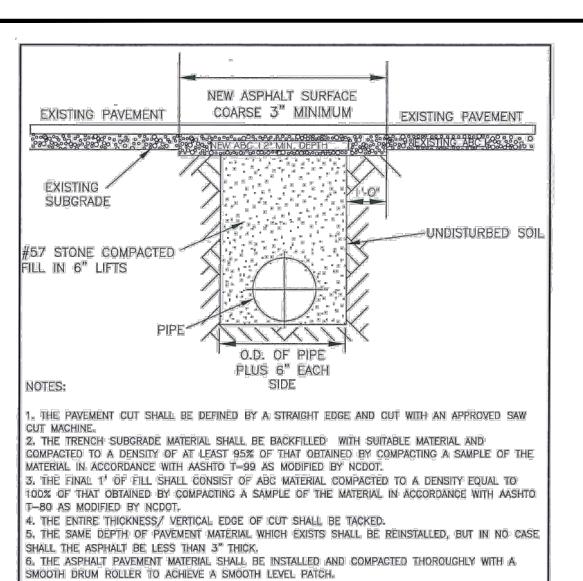

8, PAVEMENT CUTS WITHIN NODOT ROW SHALL CONFORM TO THE APPROVED ON SITE ENCROACHMENT

STANDARD ASPHALT

PAVEMENT PATCH DETAIL

3.14

0. ANY EXISTING PAVEMENT MARKINGS DISTURBED BY WORK SHALL BE REPLACED.

7. NO HAND PATCHING ALLOWED.


REVISIONS


TOWN OF KNIGHTDALE


STANDARD DETAILS

DESCRIPTION

9. MINIMUM PATCH WIDTH TO BE WIDTH OF THE ROADWAY.

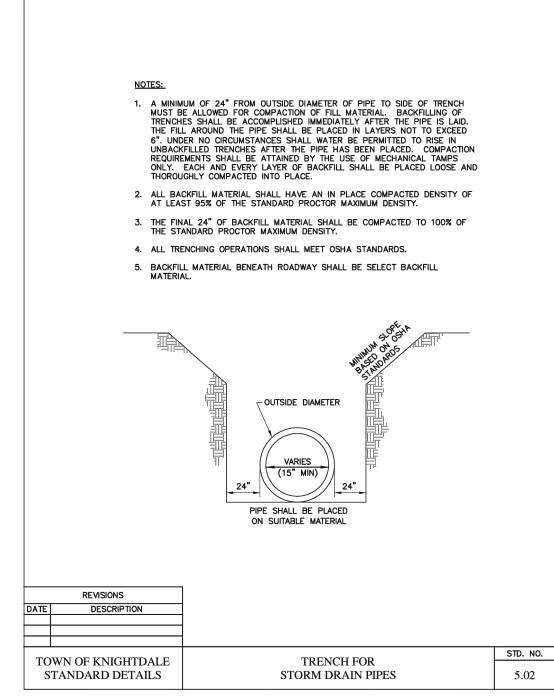

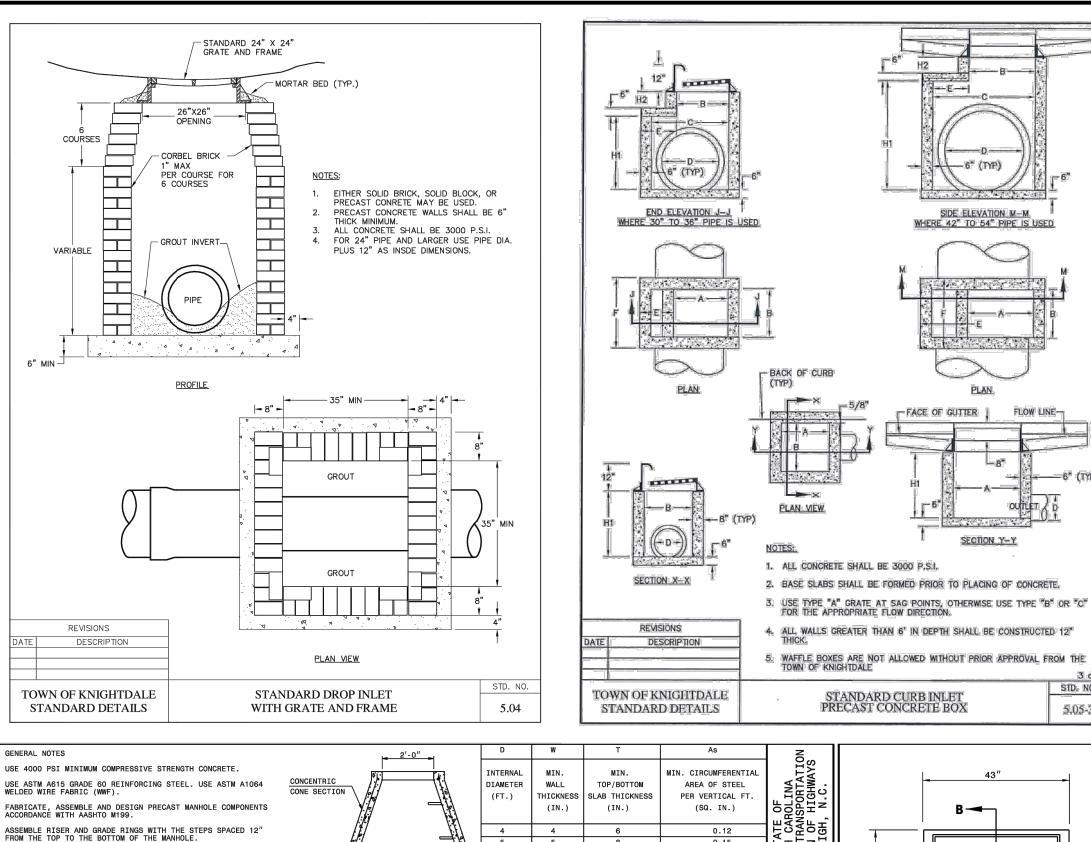

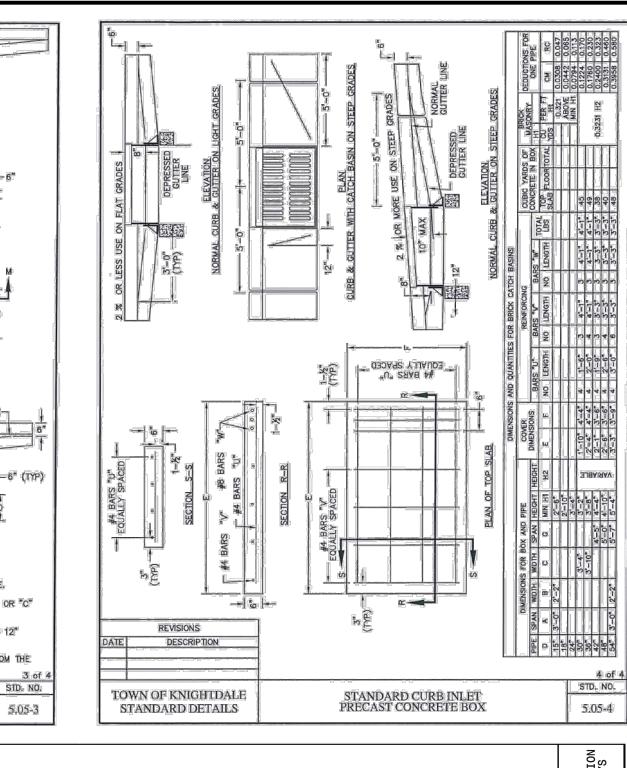

11/2"


TYPE G

SECTION A-A

Mandandunpum

SECTION A-A

<u>√8"</u>

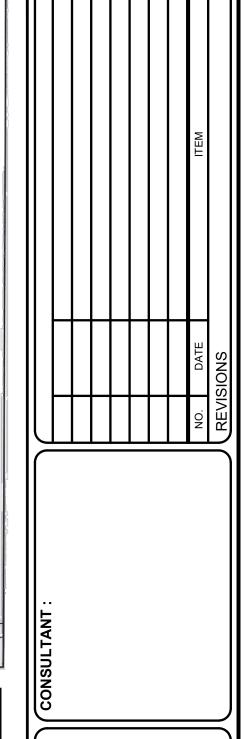

HOSPITAL

ET


08/11/2025


PROJECT No. XXX SHEET NUMBER


SHEET TITLE:
STORMDRAIN

DESIGN DRAWN CHECKED DATE

SHEET 2 OF 2 840.03

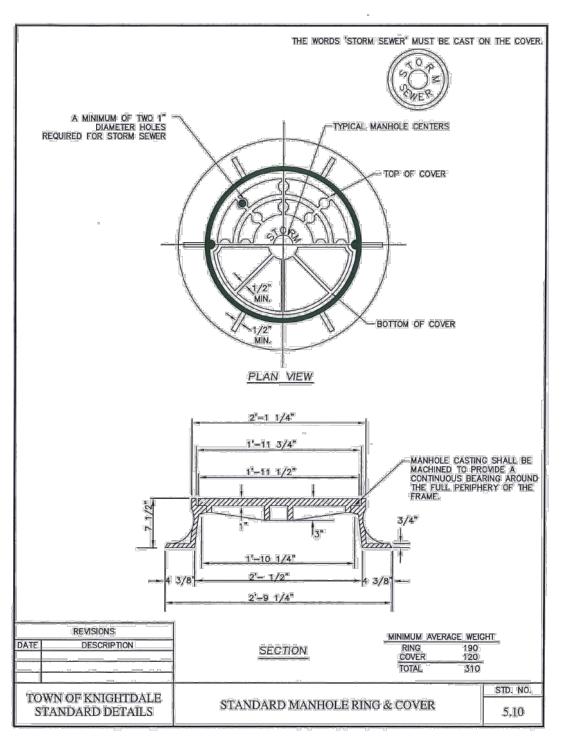

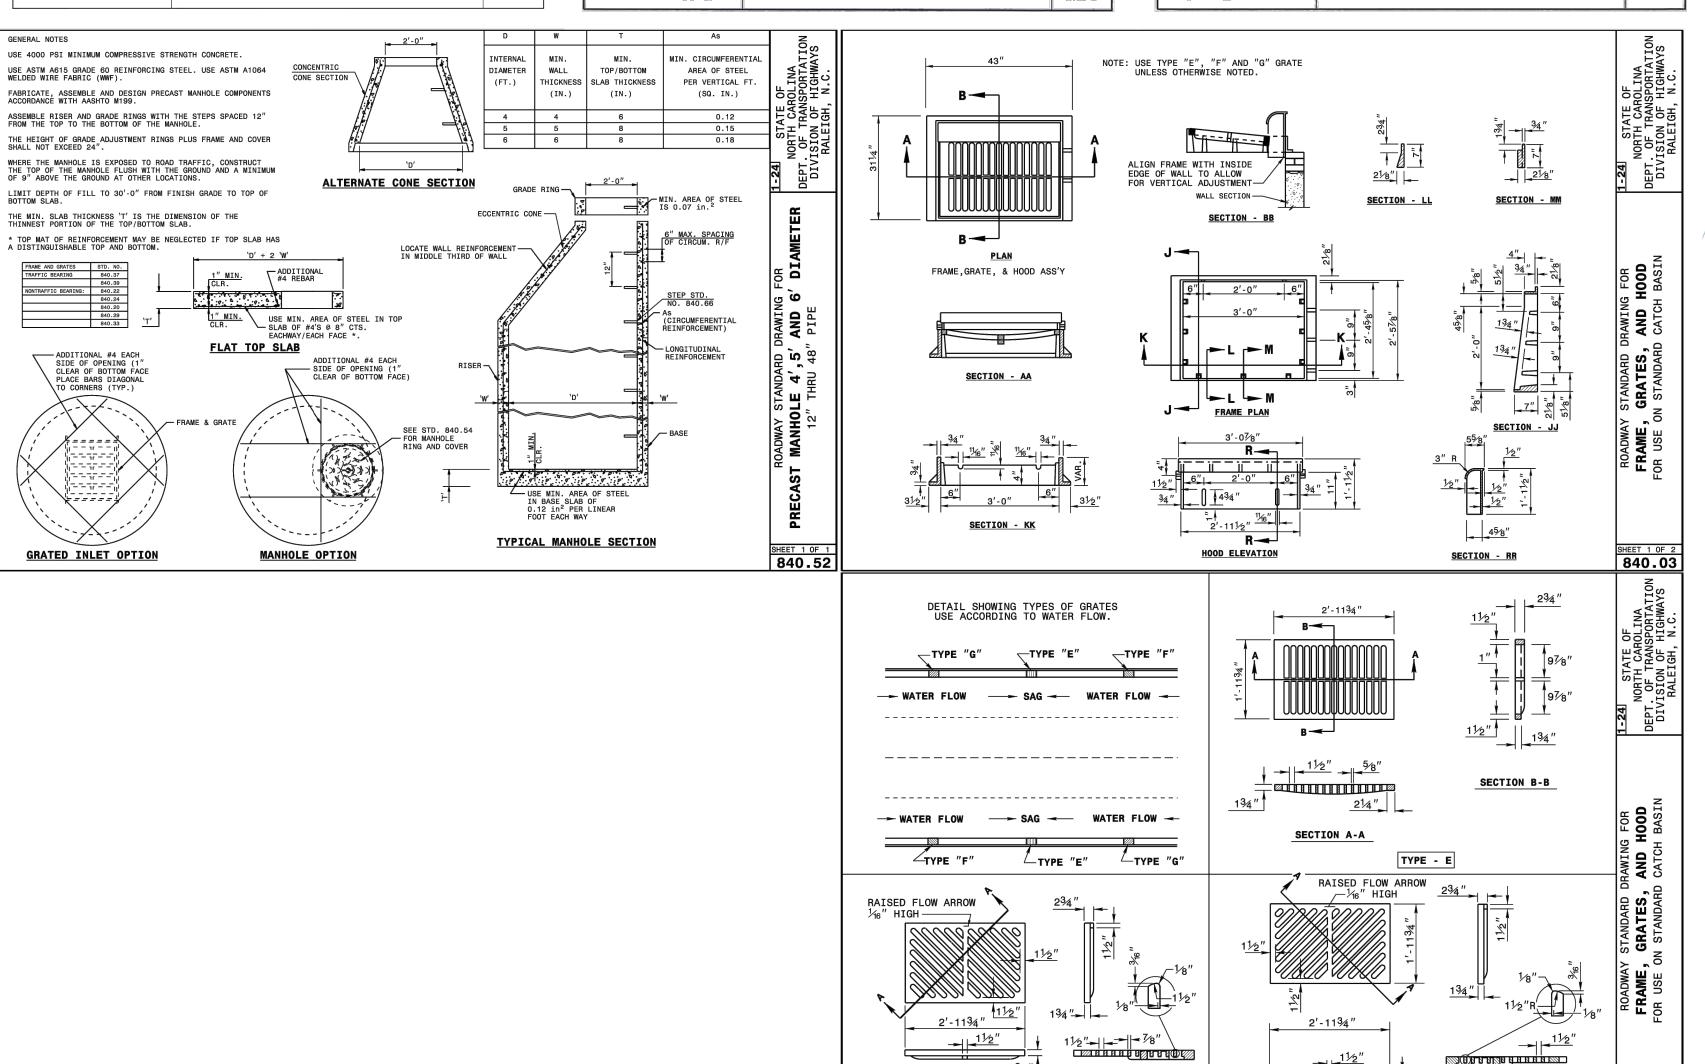


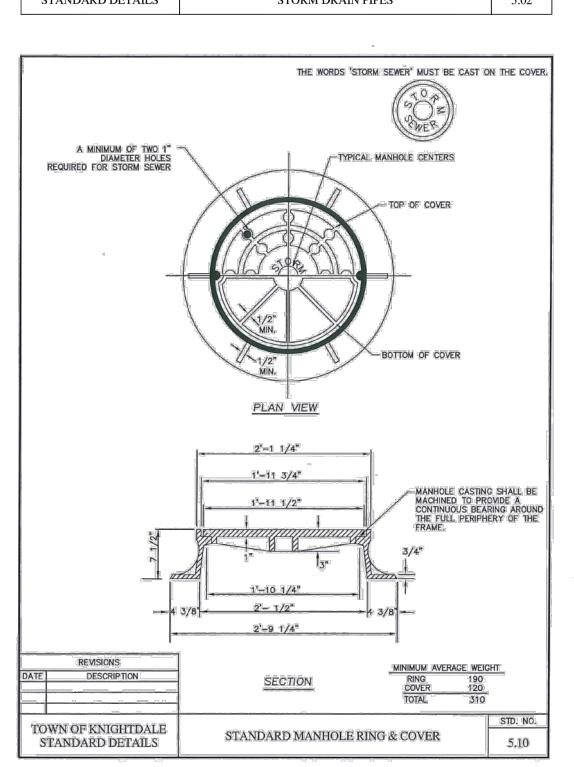

THE MIN. SLAB THICKNESS 'T' IS THE DIMENSION OF THE THINNEST PORTION OF THE TOP/BOTTOM SLAB.

NONTRAFFIC BEARING: 84

GRATED INLET OPTION

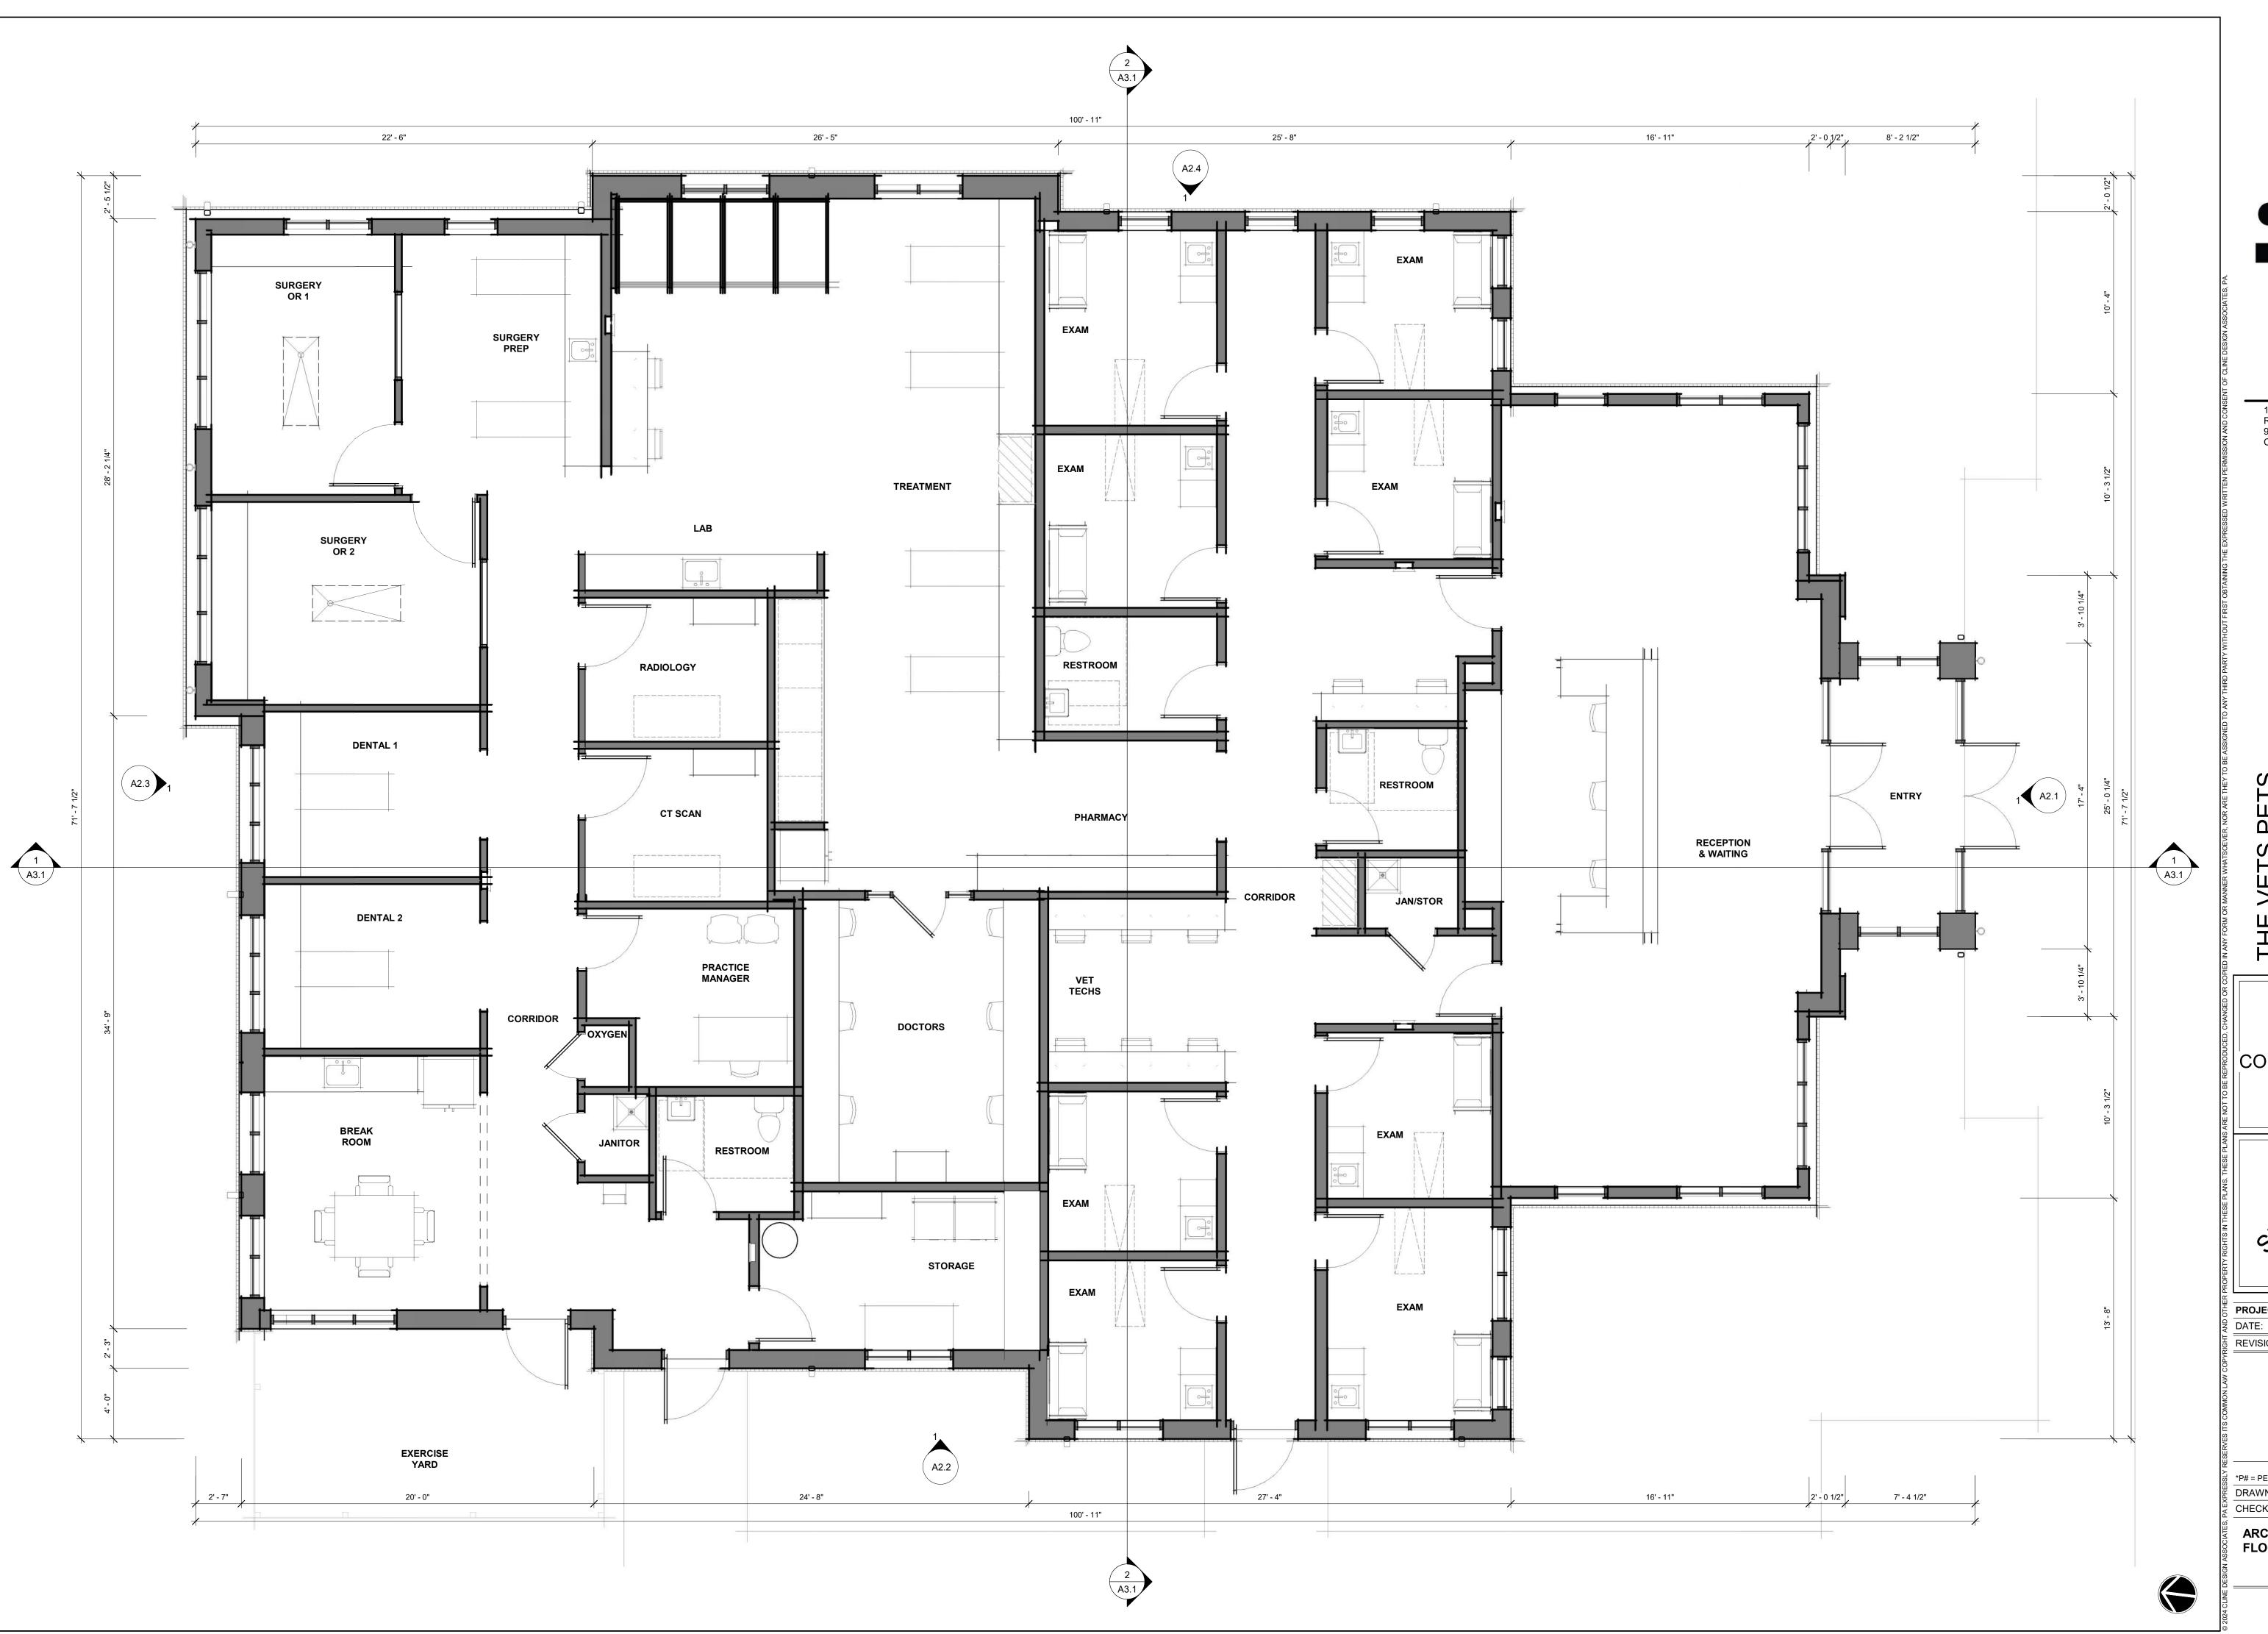

125 N. Harrington St. Raleigh, NC 27603 919 / 833-6413 ClineDesignAssoc.com

COUR

WAKE VET BIG OAK

NOT FOR CONSTRUCTION ON THESE PLANS. THESE PLANS ARE NOT TO BE REPRODUCED, CHANGED OR COPILITY OF THE PROPUCED CHANGED OR COPILITY OF THE PROPUCED. CHANGED OR CHANGED O

 PROJECT:
 024187

 DATE:
 08.11.2025

 REVISIONS:
 DATE

*P# = PERMIT, R# = RFI, # = REVISION

DRAWN BY: TG

CHECKED BY: KS, PK

ARCHITECTURAL FLOOR PLAN

A1.1

SOUTH ELEVATION GLAZING CALCULATIONS
TOTAL FACADE SF: 1,176 SF GLAZING SF: 471 SF (40%)

MATERIAL CALCULATIONS

BRICK SF (ALL FACADES): 2711 SF (73%) FIBER CEMENT PANEL SF (ALL FACADES): 1002 SF (27%)



SOUTH ELEVATION



125 N. Harrington St. Raleigh, NC 27603 919 / 833-6413 ClineDesignAssoc.com

NOT FOR CONSTRUCTION

PROJECT: DATE:	024187		
DATE:	08.11.2025		
REVISIONS:	DATE		
EVISIONS:	, Di		


*P# = PERMIT, R# = RFI, # = REVISION DRAWN BY: TG CHECKED BY: KS, PK

SOUTH ELEVATION

MATERIAL CALCULATIONS
BRICK SF (ALL FACADES): 2711 SF (73%) FIBER CEMENT PANEL SF (ALL FACADES): 1002 SF (27%)



WEST ELEVATION
1/4" = 1'-0"

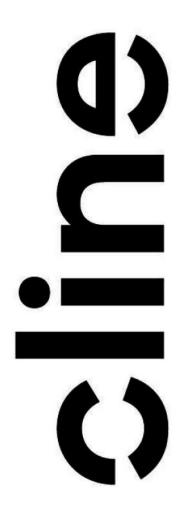

125 N. Harrington St. Raleigh, NC 27603 919 / 833-6413 ClineDesignAssoc.com

NOT FOR CONSTRUCTION



PROJECT:	024187	
DATE:	08.11.2025	
REVISIONS:	DATE	

*P# = PERMIT, R# = RFI, # = REVISION DRAWN BY: TG CHECKED BY: KS, PK


WEST ELEVATION

A2.2


NORTH ELEVATION (KNIGHTDALE BLVD. ELEVATION) GLAZING CALCULATIONS
TOTAL FACADE SF: 892 SF GLAZING SF: 364 SF (41%)

MATERIAL CALCULATIONS

BRICK SF (ALL FACADES): 2711 SF (73%) FIBER CEMENT PANEL SF (ALL FACADES): 1002 SF (27%)

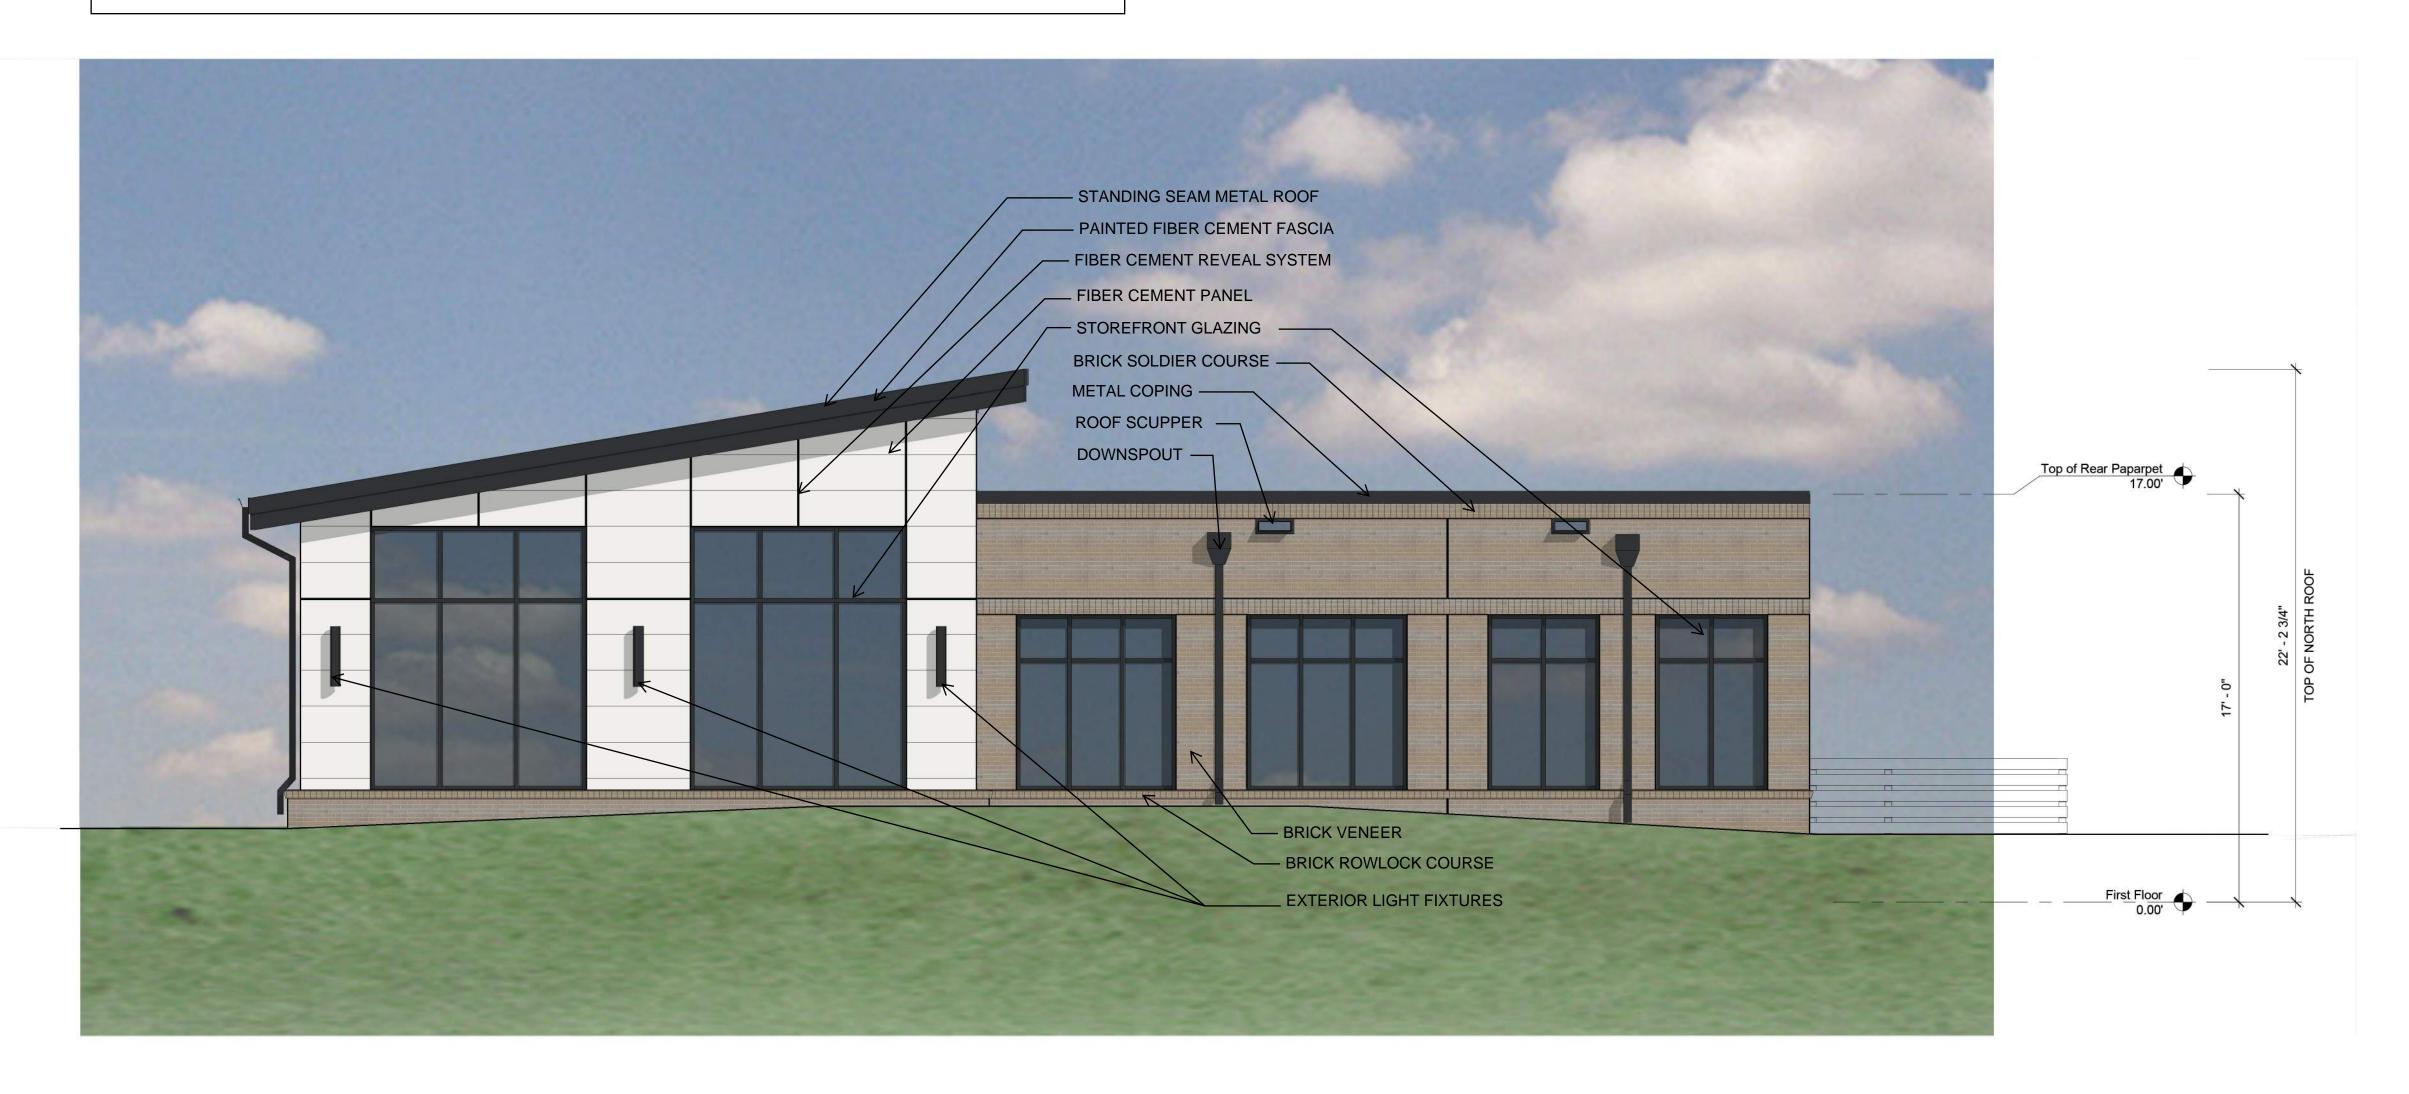

NORTH ELEVATION
1/4" = 1'-0"

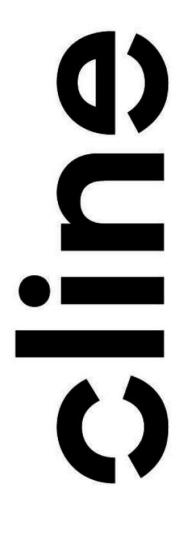

125 N. Harrington St. Raleigh, NC 27603 919 / 833-6413 ClineDesignAssoc.com

WAKE VET BIG OAK COU

NOT FOR CONSTRUCTION




RP			
AND OTHER	PROJECT:	0	24187
AND	DATE:	08.1	1.2025
RIGHT	REVISIONS:		DATE


*P# = PERMIT, R# = RFI, # = REVISION
DRAWN BY: TG
CHECKED BY: KS, PK

NORTH ELEVATION

MATERIAL CALCULATIONS
BRICK SF (ALL FACADES): 2711 SF (73%) FIBER CEMENT PANEL SF (ALL FACADES): 1002 SF (27%)

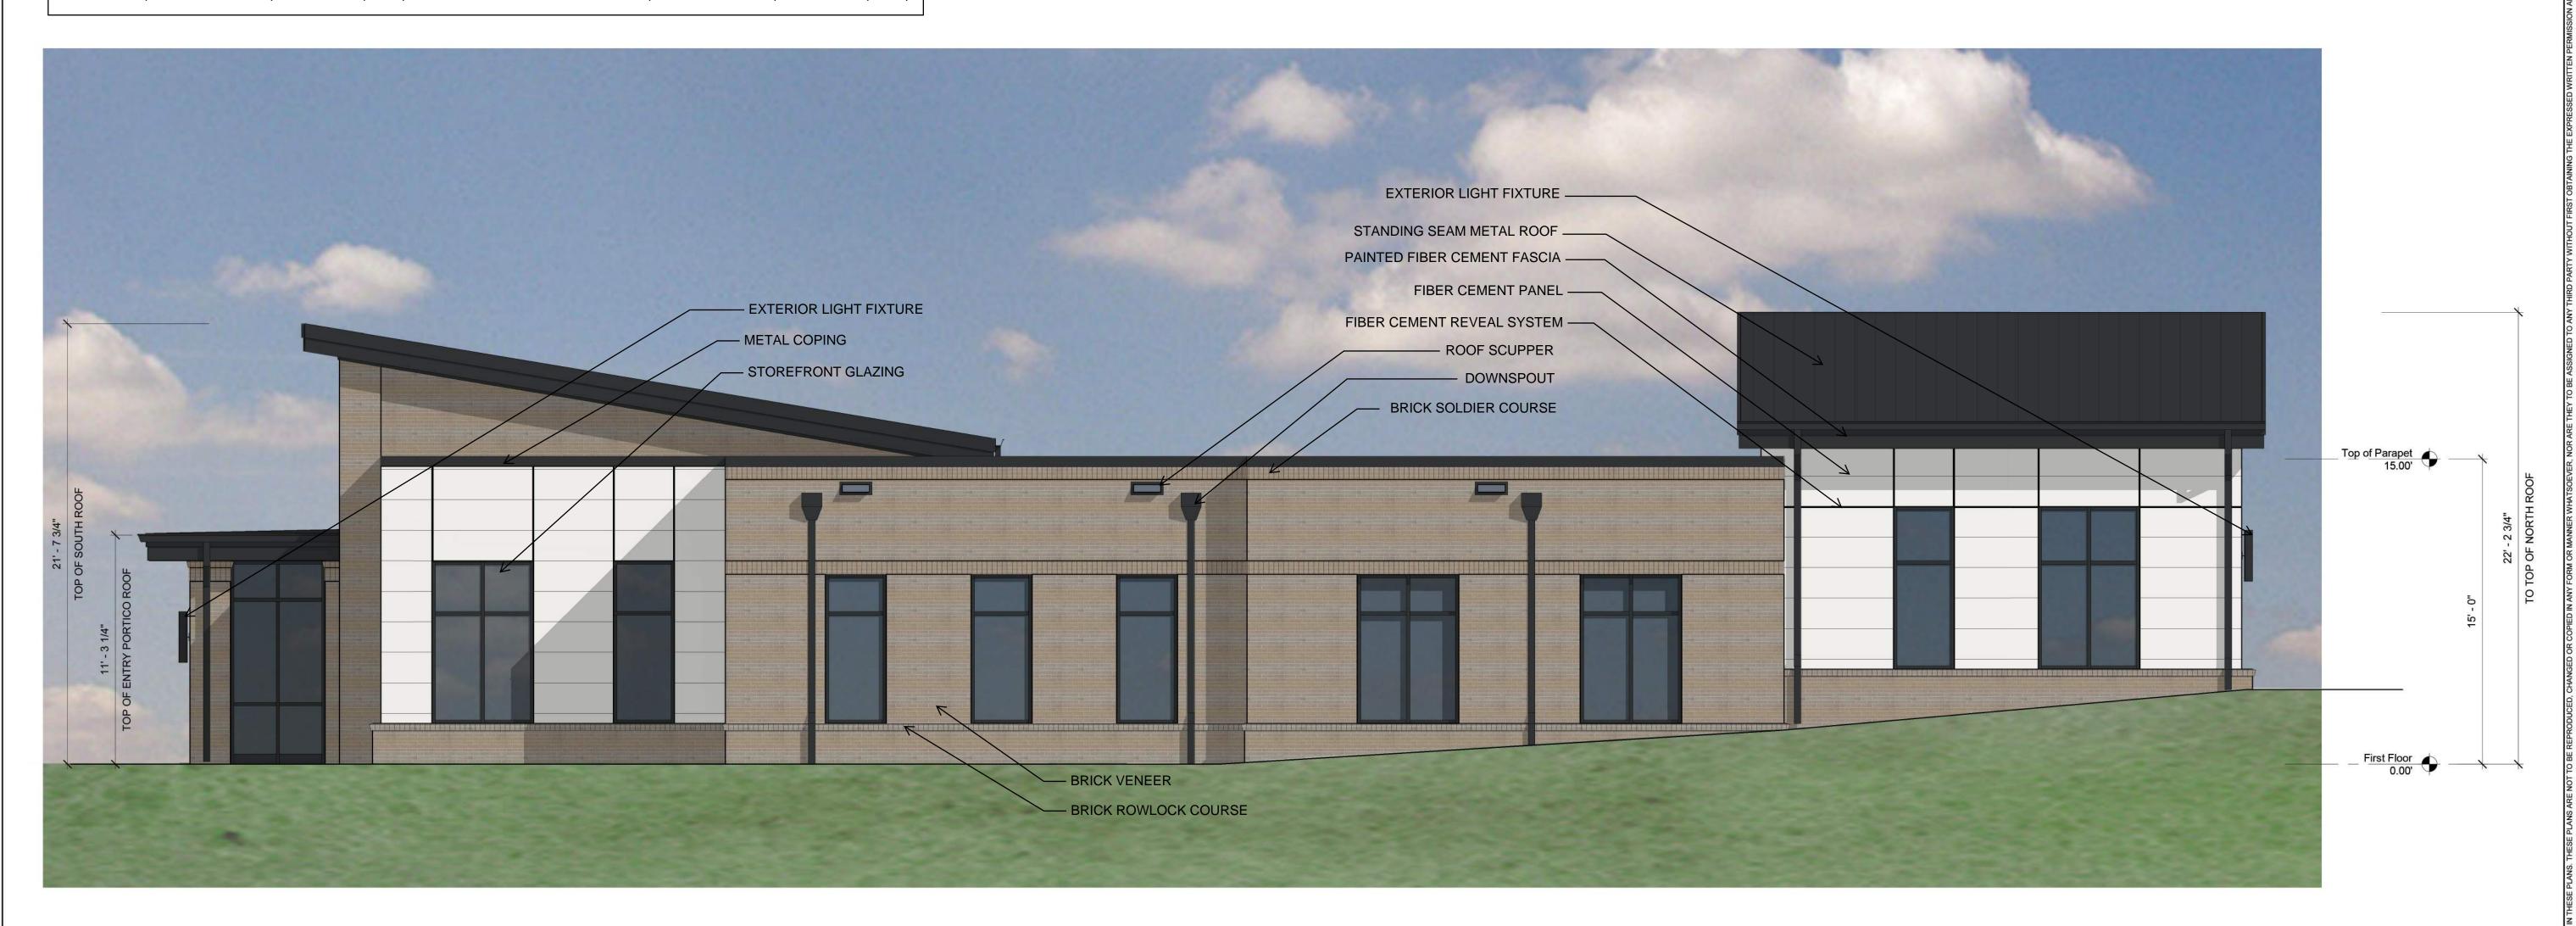

EAST ELEVATION
1/4" = 1'-0"

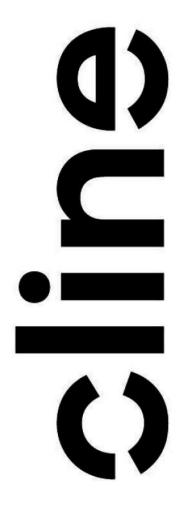

125 N. Harrington St. Raleigh, NC 27603 919 / 833-6413 ClineDesignAssoc.com

NOT FOR CONSTRUCTION




PROJECT:	024187	
DATE:	08.11.202	
REVISIONS:	DATE	


*P# = PERMIT, R# = RFI, # = REVISION DRAWN BY: TG CHECKED BY: KS, PK

EAST ELEVATION

A2.4

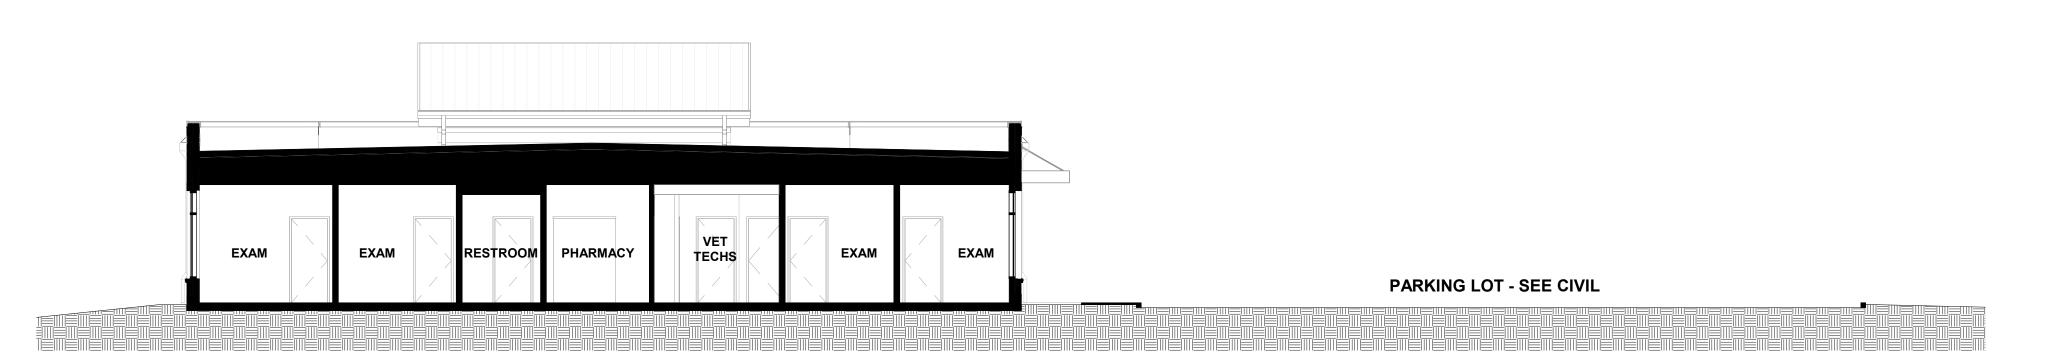

TRANSVERSE SECTION
1/8" = 1'-0"
2

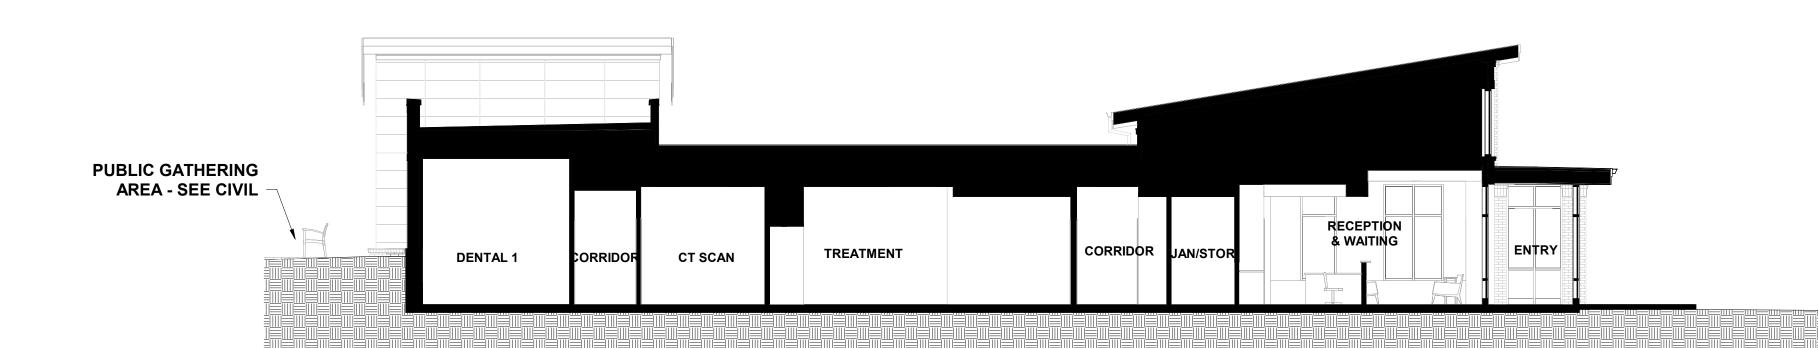

PARKING LOT - SEE CIVIL

LONGITUDINAL SECTION
1/8" = 1'-0"



125 N. Harrington St. Raleigh, NC 27603 919 / 833-6413 ClineDesignAssoc.com

S PETS

VET BIG OAK COURT

NOT FOR CONSTRUCTION



PROJECT:	024187
DATE:	08.11.2025
REVISIONS:	DATE

*P# = PERMIT, R# = RFI, # = REVISION

DRAWN BY: TG

CHECKED BY: KS, PK

CROSS SECTIONS

A3.1



PALMETTO BRICK VENEER 2.0 GREYSTONE WIRECUT





STOREFRONT, GUTTERS, FASCIA, DOWNSPOUTS DARK BRONZE - PANTONE 7518V



125 N. Harrington St. Raleigh, NC 27603 919 / 833-6413

PETS
/ET BIG OAK COURT

NOT FOR CONSTRUCTION



PROJECT: 024187

DATE: 08.11.2025

REVISIONS: DATE

*P# = PERMIT, R# = RFI, # = REVISION
DRAWN BY: TG
CHECKED BY: KS, PK

MATERIAL BOARD

A4.0