

Sketch Plan

1st Submittal: 12.04.2019 2nd Submittal: 01.21.2020 3rd Submittal: 02.12.2020

7630 Knightdale Boulevard

Knightdale, North Carolina 27545



SKETCH PLAN EXHIBIT FOR DUKE ENERGY RIGHT OF WAY RESTRICTIONS OPEN SPACE DIAGRAM SCM PLAN Project Team

Sheet Index

BOUNDARY & TOPOGRAPHIC SURVEY

COVER _

O W N E R G&F Properties LLC, Edward J Gehrke II P.O. Box 767 Wendell, NC 27591 919.632.0607 gehrkee@nationwide.com

DEVELOPER Brown Investment Properties 440 West Market Street Greensboro, NC 27401 336.379.8771 336.274.9305 (fax) chetbrown@bipinc.com

L2.0 L3.0

C-401

BUILDING ELEVATIONS

LANDSCAPE ARCHITECT
JDavis Architects, PLLC
510 S. Wilmington Street
Raleigh, North Carolina 27601
919.835.1500 919.835.1510 (fax) kent@jdavisarchitects.com

ARCHITECT
JDavis Architects, PLLC 510 S. Wilmington Street Raleigh, North Carolina 27601 919.835.1500 919.835.1510 (fax) matta@jdavisarchitects.com

ENGINEER/SURVEYOR BOHLER Engineering NC, PLLC 4130 Parklake Ave- Suite 130 Raleigh, NC 27612 919.578.9000 wboné@bohlereng.com

Brown In 7630 Knight

FOR REVIEW ONLY NOT FOR CONSTRUCTION

SKETCH PLAN


PROJECT: BIP-19048

SKETCH


PLAN

ISSUE: Sketch Plan 12.04.2019 REVISIONS: 1st Review Comments 2nd Review Comments DRAWN BY: SB CHECKED BY: CONTENT: COVER

— <i>— 123</i> — —	EXISTING CONTOUR				
	LINE SURVEYED				
	LINE NOT SURVEYED				
₩V	WATER VALVE				
——— ОН ———	OVERHEAD WIRES				
	GRATE TOP INLET				
	UTILITY POLE				
IPS	IRON PIPE SET				
IPF	IRON PIPE FOUND				
IRF	IRON REBAR FOUND				
ECM	EXISTING CONCRETE MONUM				
	SIGN				
——X——	FENCE				
	AREA LIGHT				
	OLIV AMIDE				

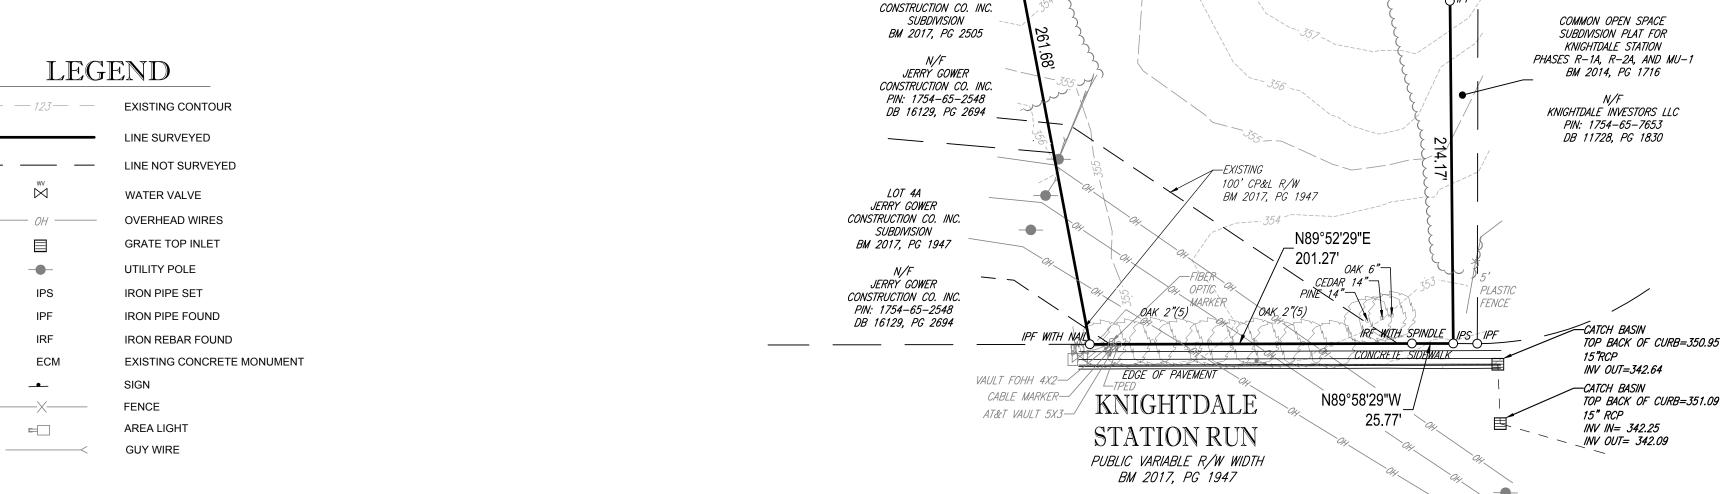

JERRY GOWER

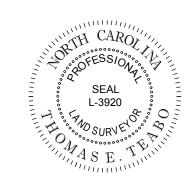

SALES OR CONVEYANCES


NC L-3920

BOUNDARY & TOPOGRAPHIC SURVEY PROPERTYOF

G & F PROPERTIES, LLC

PIN: 1754-65-5899 DB 8139, PG 672 TOWN OF KNIGHTDALE ST. MATTEW'S TOWNSHIP WAKE COUNTY, NORTH CAROLINA

FILE NO. NSR192091		BO	HI NEERING N	ER	SUIT RALEIGH, NORT 919.578.9000 -	LAKE AVENUE TE 130 TH CAROLINA 27612 919.703.2665 FAX		
DATE			engineering.com LS: P-1132					
10/23/19	■ UPSTATE NEW YORK ■ BOSTON, MA ■ NEW YORK METRO ■ WARREN, NJ ■ PHILADELPHIA/SOUTHERN NJ ■ LEHIGH VALLEY, PA ■ SOUTHEASTERN PA ■ BALTIMORE, MD ■ SOUTHERN MARYLAND ■ NORTHERN VIRGINIA ■ WASHINGTON, DC ■ CENTRAL VIRGINIA ■ CHARLOTTE, NC ■ RALEIGH, NC							
FIELD DATE	CREW CHIEF	DRAWN	REVIEWED	APPROVED	SCALE	DWG. NO.		

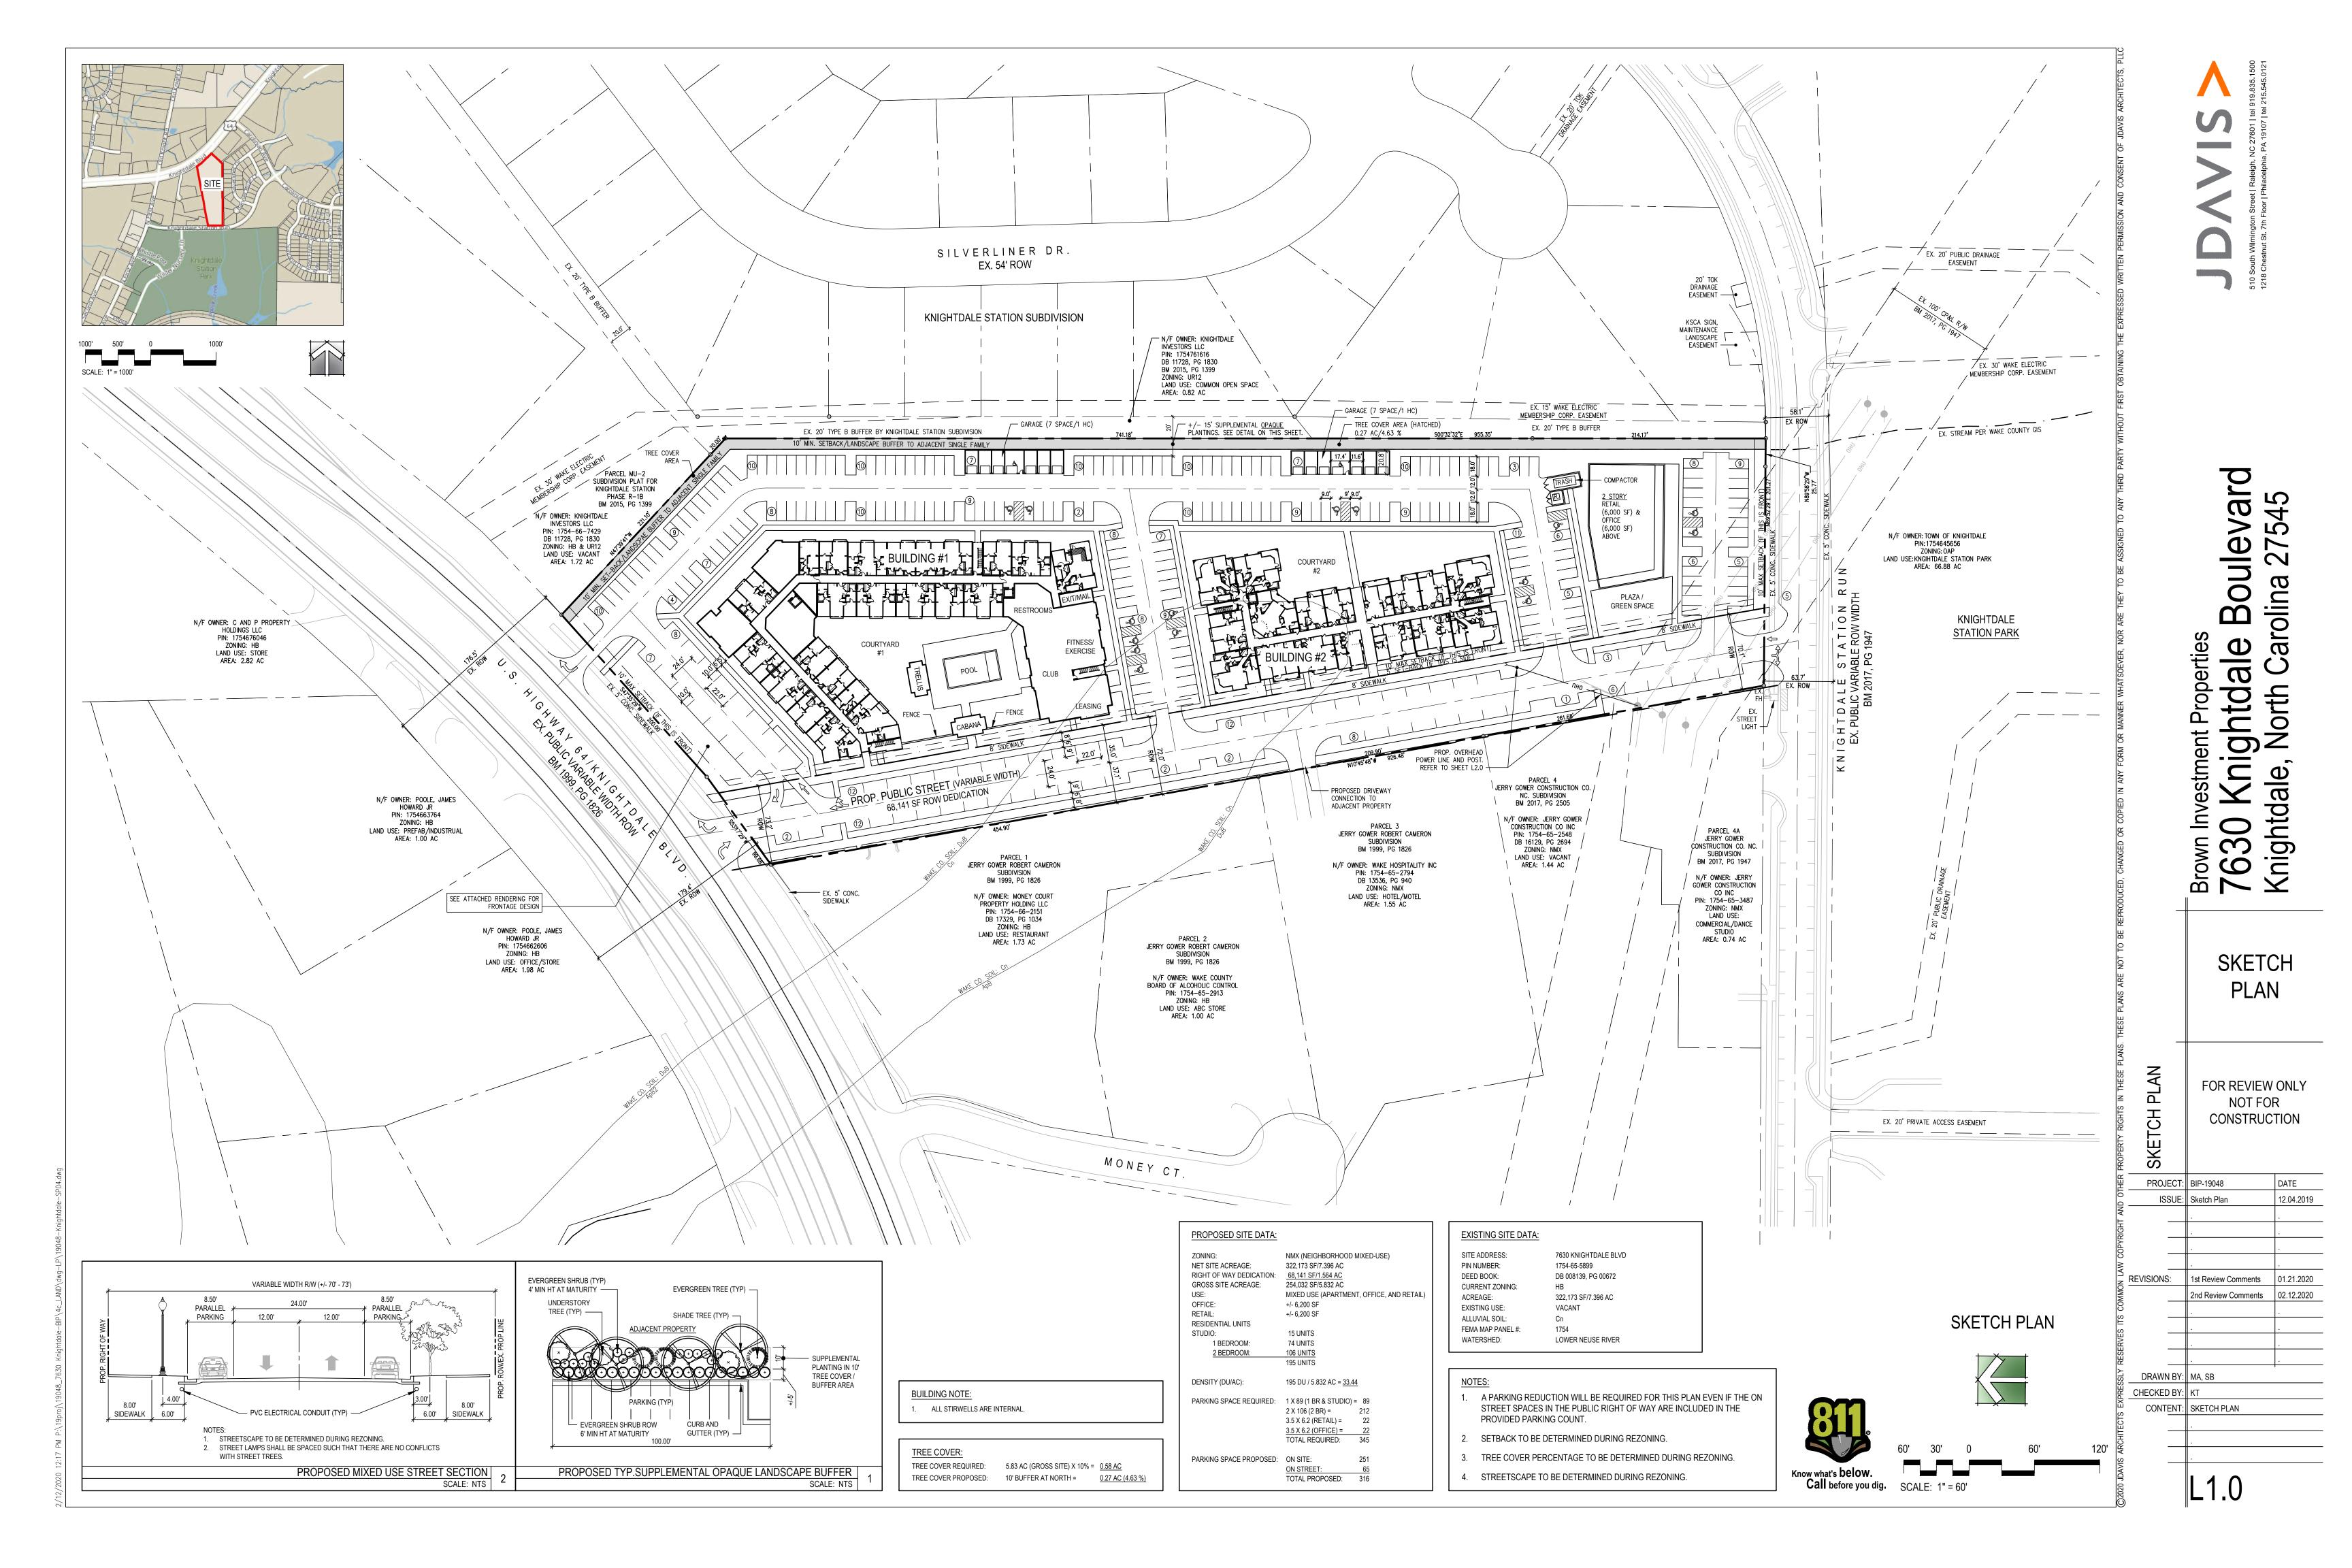



BUILDING A SMARTER ENERGY FUTURESM

DUKE ENERGY ELECTRIC TRANSMISSION RIGHT-OF-WAY GUIDELINES/RESTRICTIONS VALID FOR NORTH CAROLINA AND SOUTH CAROLINA (Revised 11/20/2014)

This list of right-of-way restrictions has been developed to answer the most frequently asked questions about property owner use of Duke Energy's electric transmission rights of way. This list does not cover all restrictions or all possible situations. You should contact the Asset Protection right-of-way specialist if you have additional concerns about the rights of way. This list of restrictions is subject to change at any time and without notice. Duke Energy reserves all rights conveyed to it by the right-of-way agreement applicable to the subject property. All activity within the rights of way shall be reviewed by an Asset Protection right-of-way specialist to obtain prior written approval. Engineering plans may be required. Compliance with the Duke Energy Right-of-Way Guidelines/Restrictions or approval of any plans by Duke Energy does not mean that the requirements of any local, county, state or federal government or other applicable agency with governing authority have been

- 1. Structures, buildings, manufactured/mobile homes, satellite systems, swimming pools (any associated equipment and decking), graves, billboards, dumpsters, signs, wells, deer stands, retaining walls, septic systems or tanks (whether above or below ground), debris of any type, flammable material, building material, wrecked or disabled vehicles and all other objects (whether above or below ground) which in Duke Energy's opinion interfere with the electric transmission right of way are not allowed within the right-of-way limits. Transformers, telephone/cable pedestals (and associated equipment) and fire hydrants are not allowed. Manholes, water valves, water meters, backflow preventers and irrigation heads are not permitted. Attachments to Duke Energy structures are prohibited.
- 2. Fences and gates shall not exceed 10 feet in height and shall be installed greater than 25 feet from poles, towers and guy anchors. Fences shall not parallel the centerline within the rights of way but may cross from one side to the other at any angle not less than 30 degrees with the centerline. If a fence crosses the right of way, a gate (16 feet wide at each crossing) shall be installed by the property owner, per Duke Energy's specifications. The property owner is required to install a Duke Energy lock on the gate to ensure access. Duke Energy will supply a lock.
- 3. Grading (cuts or fill) shall be no closer than 25 feet from poles, towers, guys and anchors (except for parking areas; see paragraph 7) and the slope shall not exceed 4:1. Grading or filling near Duke Energy facilities which will prevent free equipment access or create ground-to-conductor clearance violations will not be permitted. Storage or stockpiling of dirt or any other material is prohibited. Sedimentation control, including re-vegetation, is required per state
- 4. Streets, roads, driveways, sewer/water lines, other utility lines or any underground facilities shall not parallel the centerline within the right of way but may cross, from one side to the other, at any angle not less than 30 degrees with the centerline. No portion of such facility or corresponding easement shall be located within 25 feet of Duke Energy's facilities.
- Roundabouts, cul-de-sacs and intersections (such as roads, driveways and alleyways) are not permitted. 5. Any drainage feature that allows water to pond, causes erosion, directs stormwater toward the right of way or limits access to
- or around Duke Energy facilities is prohibited. 6. Contact Duke Energy prior to the construction of lakes, ponds, retention or detention facilities, etc.
- 7. Parking may be permitted within the right of way, provided that:
 - a. Prior to grading, concrete barriers shall be installed at a minimum of 9 feet from the Duke Energy facilities. During construction, grading shall be no closer than 10 feet to any Duke Energy facility.
 - b. After grading/paving activity is complete, a Duke Energy-approved barrier sufficient to withstand a 15mph vehicular impact shall be erected 9 feet from any Duke Energy facility. c. Any access areas, entrances or exits shall cross (from one side to the other) the right of way at any angle not
- less than 30 degrees with the centerline and shall not pass within 25 feet of any structure. Parking lot entrances/exits cannot create an intersection within the right of way.
- d. Lighting within the right-of-way limits must be approved by Duke Energy before installing. Due to engineering design standards, lighting is not allowed in the "Wire Zone." Where lighting is approved ("Border Zone"), the total height may not exceed 15 feet in Area A and 12 feet in Area B. See map on back of this page for Areas. Contact
- your Asset Protection right-of-way specialist as the "Wire Zone" varies for the different voltage lines. 8. Duke Energy will not object to certain vegetation plantings as long as:
- a. They do not interfere with the access to or the safe, reliable operation and maintenance of Duke Energy facilities. b. Duke Energy does not object to low-growing shrubs and grasses within the "Wire Zone." Tree species are not allowed within the "Wire Zone." Trees that are approved in the "Border Zone" may
- not exceed, at maturity, 15 feet in Area A and 12 feet in Area B. See map on back of page for areas. Contact the Asset Protection right-of-way specialist for "Wire Zone"/"Border Zone" definitions.
- c. For compliant mature height species, refer to <u>plants.ces.ncsu.edu/</u> for reference. d. Engineering drawings must indicate the <u>outermost</u> conductor.
- e. Vegetation that is not in compliance is subject to removal without notice.
- f. Duke Energy may exercise the right to cut "danger trees" outside the right-of-way limits as required to properly maintain and operate the transmission line.

We hope this is useful information. If you have additional questions or plan any activity not mentioned above, please contact the Asset Protection right-of-way specialist for your area (see map).

AUTHORIZED COPY Duke Energy Proprietary Business Information

PROJECT BOUNDARY RETAIL (6,000 SF) & OFFICE (6,000 SF) **ABOVE** PLAZA / **GREEN SPACE** NO STREET INTERSECTION (PRIVATE), RETAINING WALLS, TRAFFIC SINGS, OR SIGNALS ARE PERMITTED WITHIN THE DUKE ENERGY EASEMENT. - PROP. RIGHT OF WAY PROP. 8' SIDEWALK PROPOSED PUBLIC STREET — APPOX. LOCATION OF PROPOSED UTILITY POST WITH GUY WIRE. 0 I SHALL NOT EXCEED 4:1 FOR PARKING AREA. EXISTING GUY WIRE TO BE REMOVED. — G

> **EXHIBIT FOR DUKE ENERGY RIGHT** OF WAY RESTRICTIONS



Know what's **below**.


Call before you dig.


SCALE: 1" = 20'


onl arolina **Properties** orth htd 0 Knight Brown In 7630 SKETCH PLAN FOR REVIEW ONLY NOT FOR CONSTRUCTION PROJECT: BIP-19048 ISSUE: Sketch Plan 12.04.2019 1st Review Comments 2nd Review Comments DRAWN BY: CHECKED BY: CONTENT: EXIHIBIT FOR DUKE ENERGY RIGHT OF WAY RESTRICTIONS

SKETCH PLAN

REVISIONS:

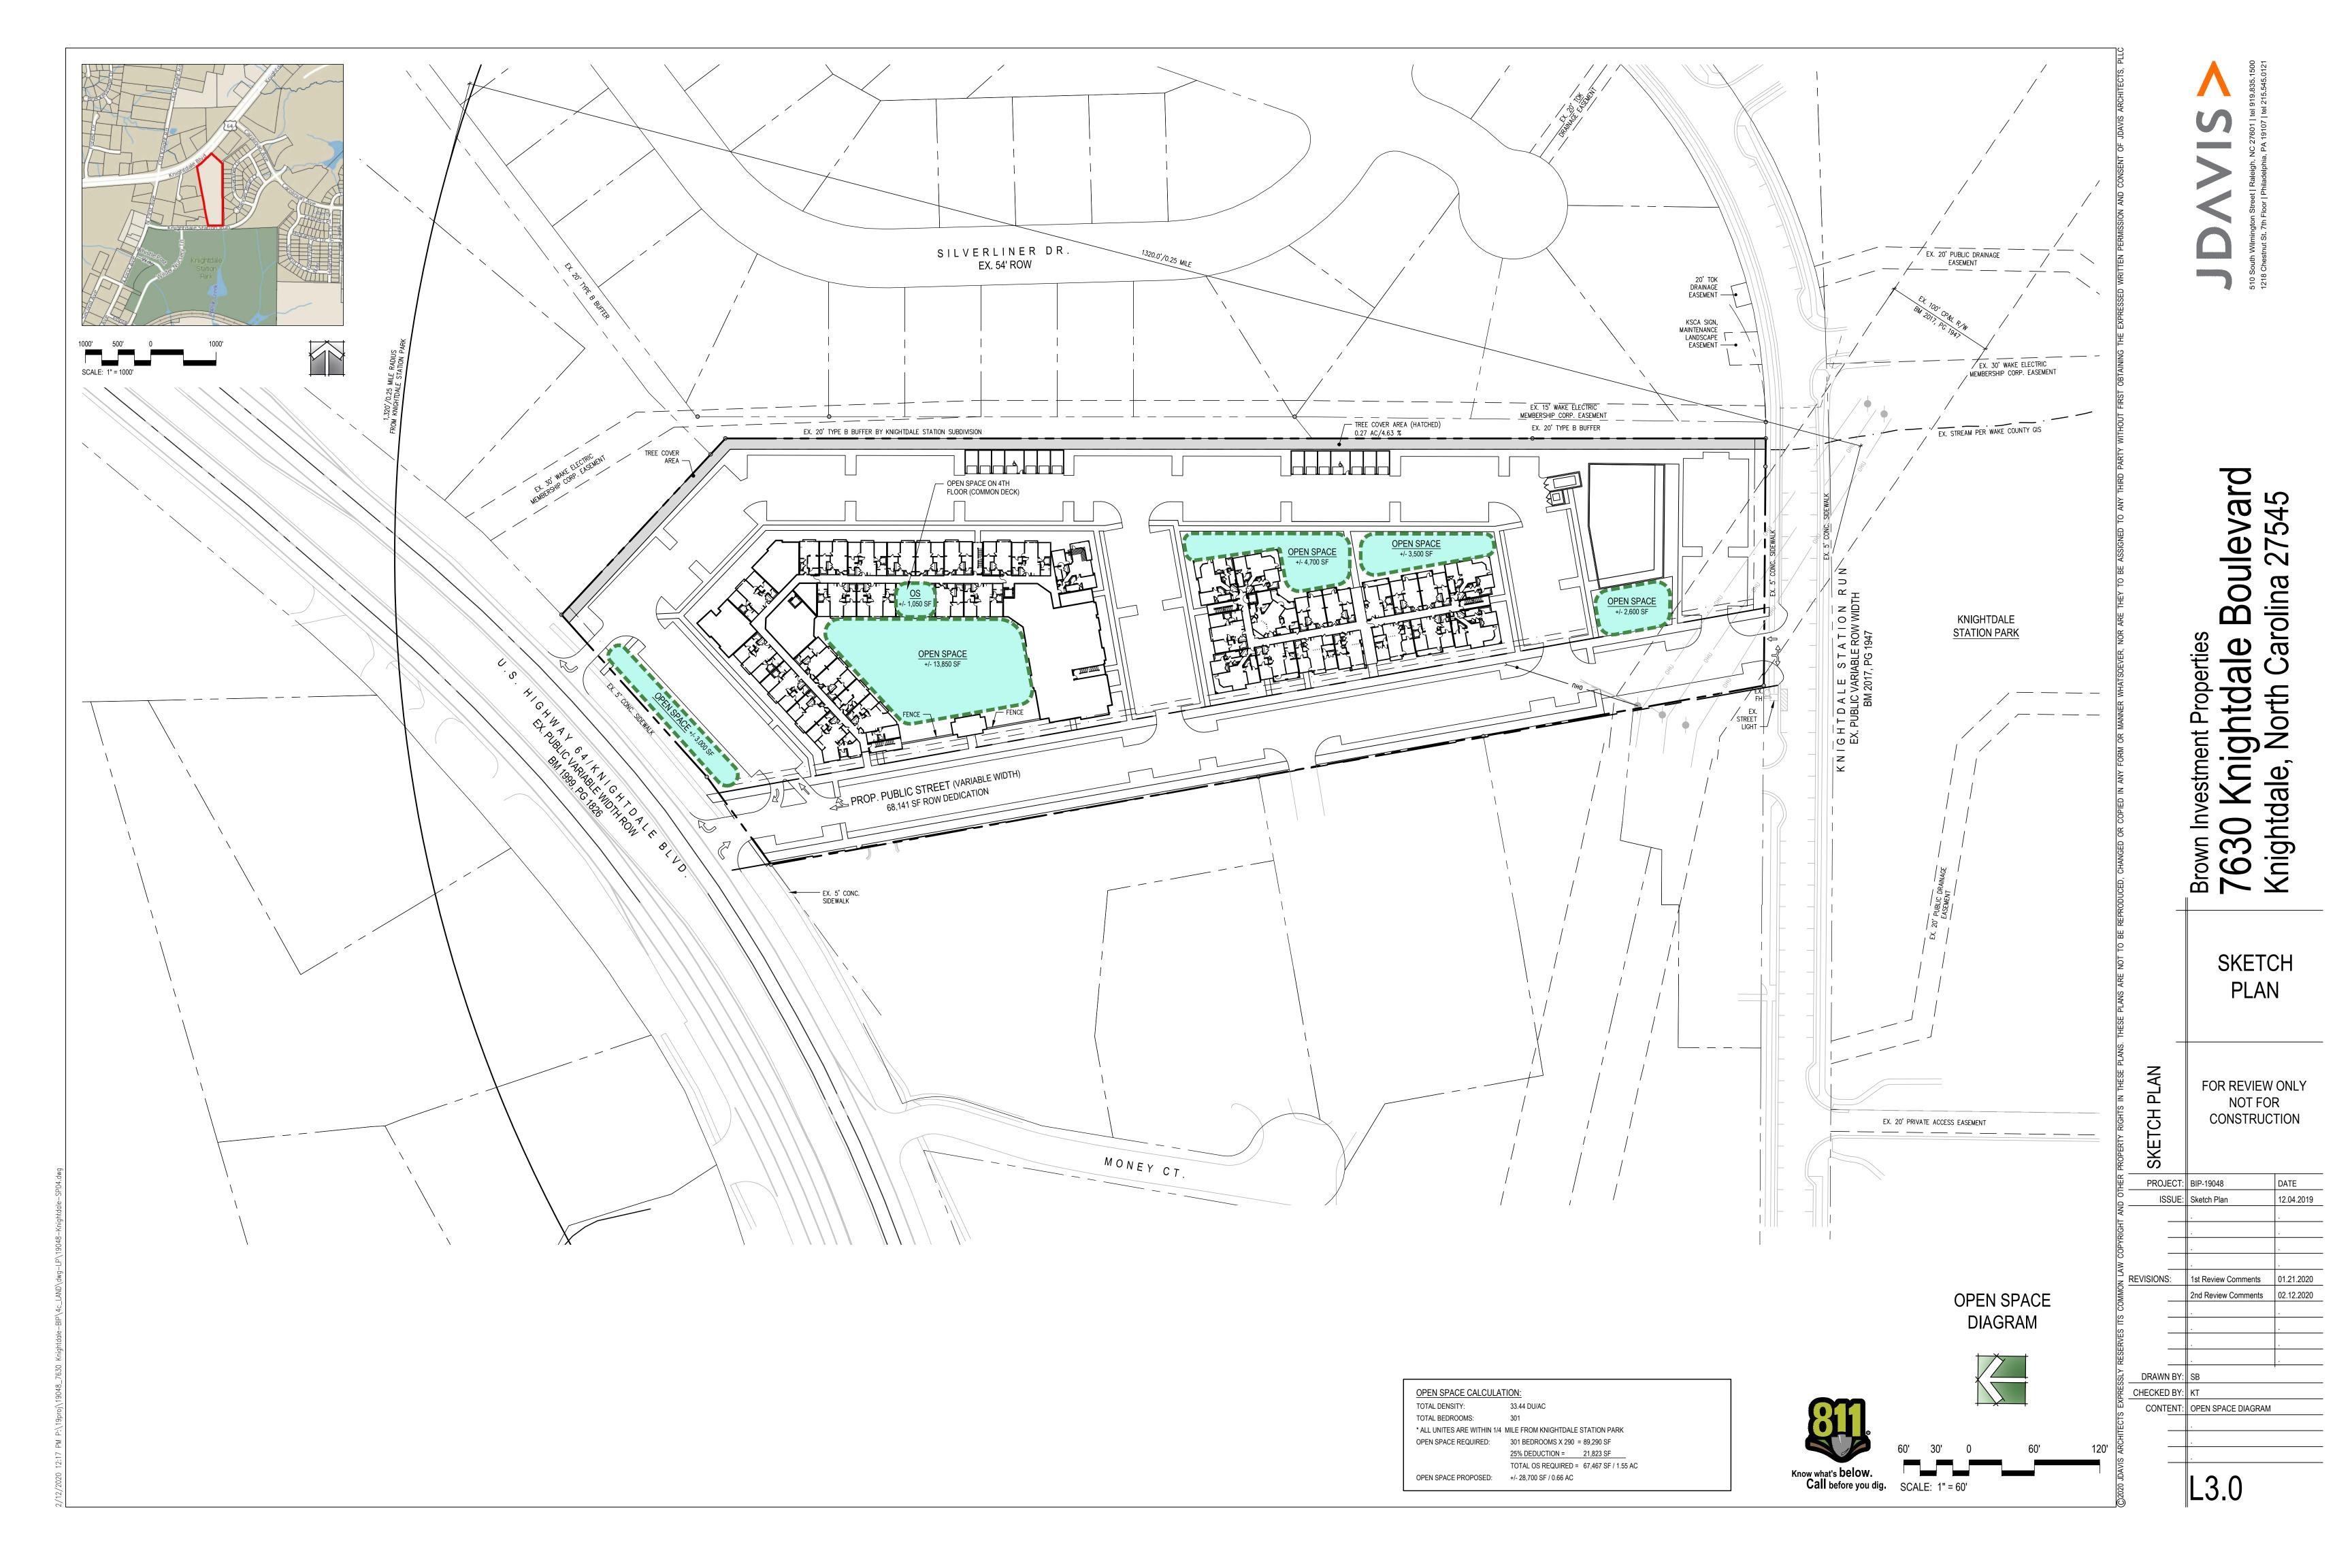

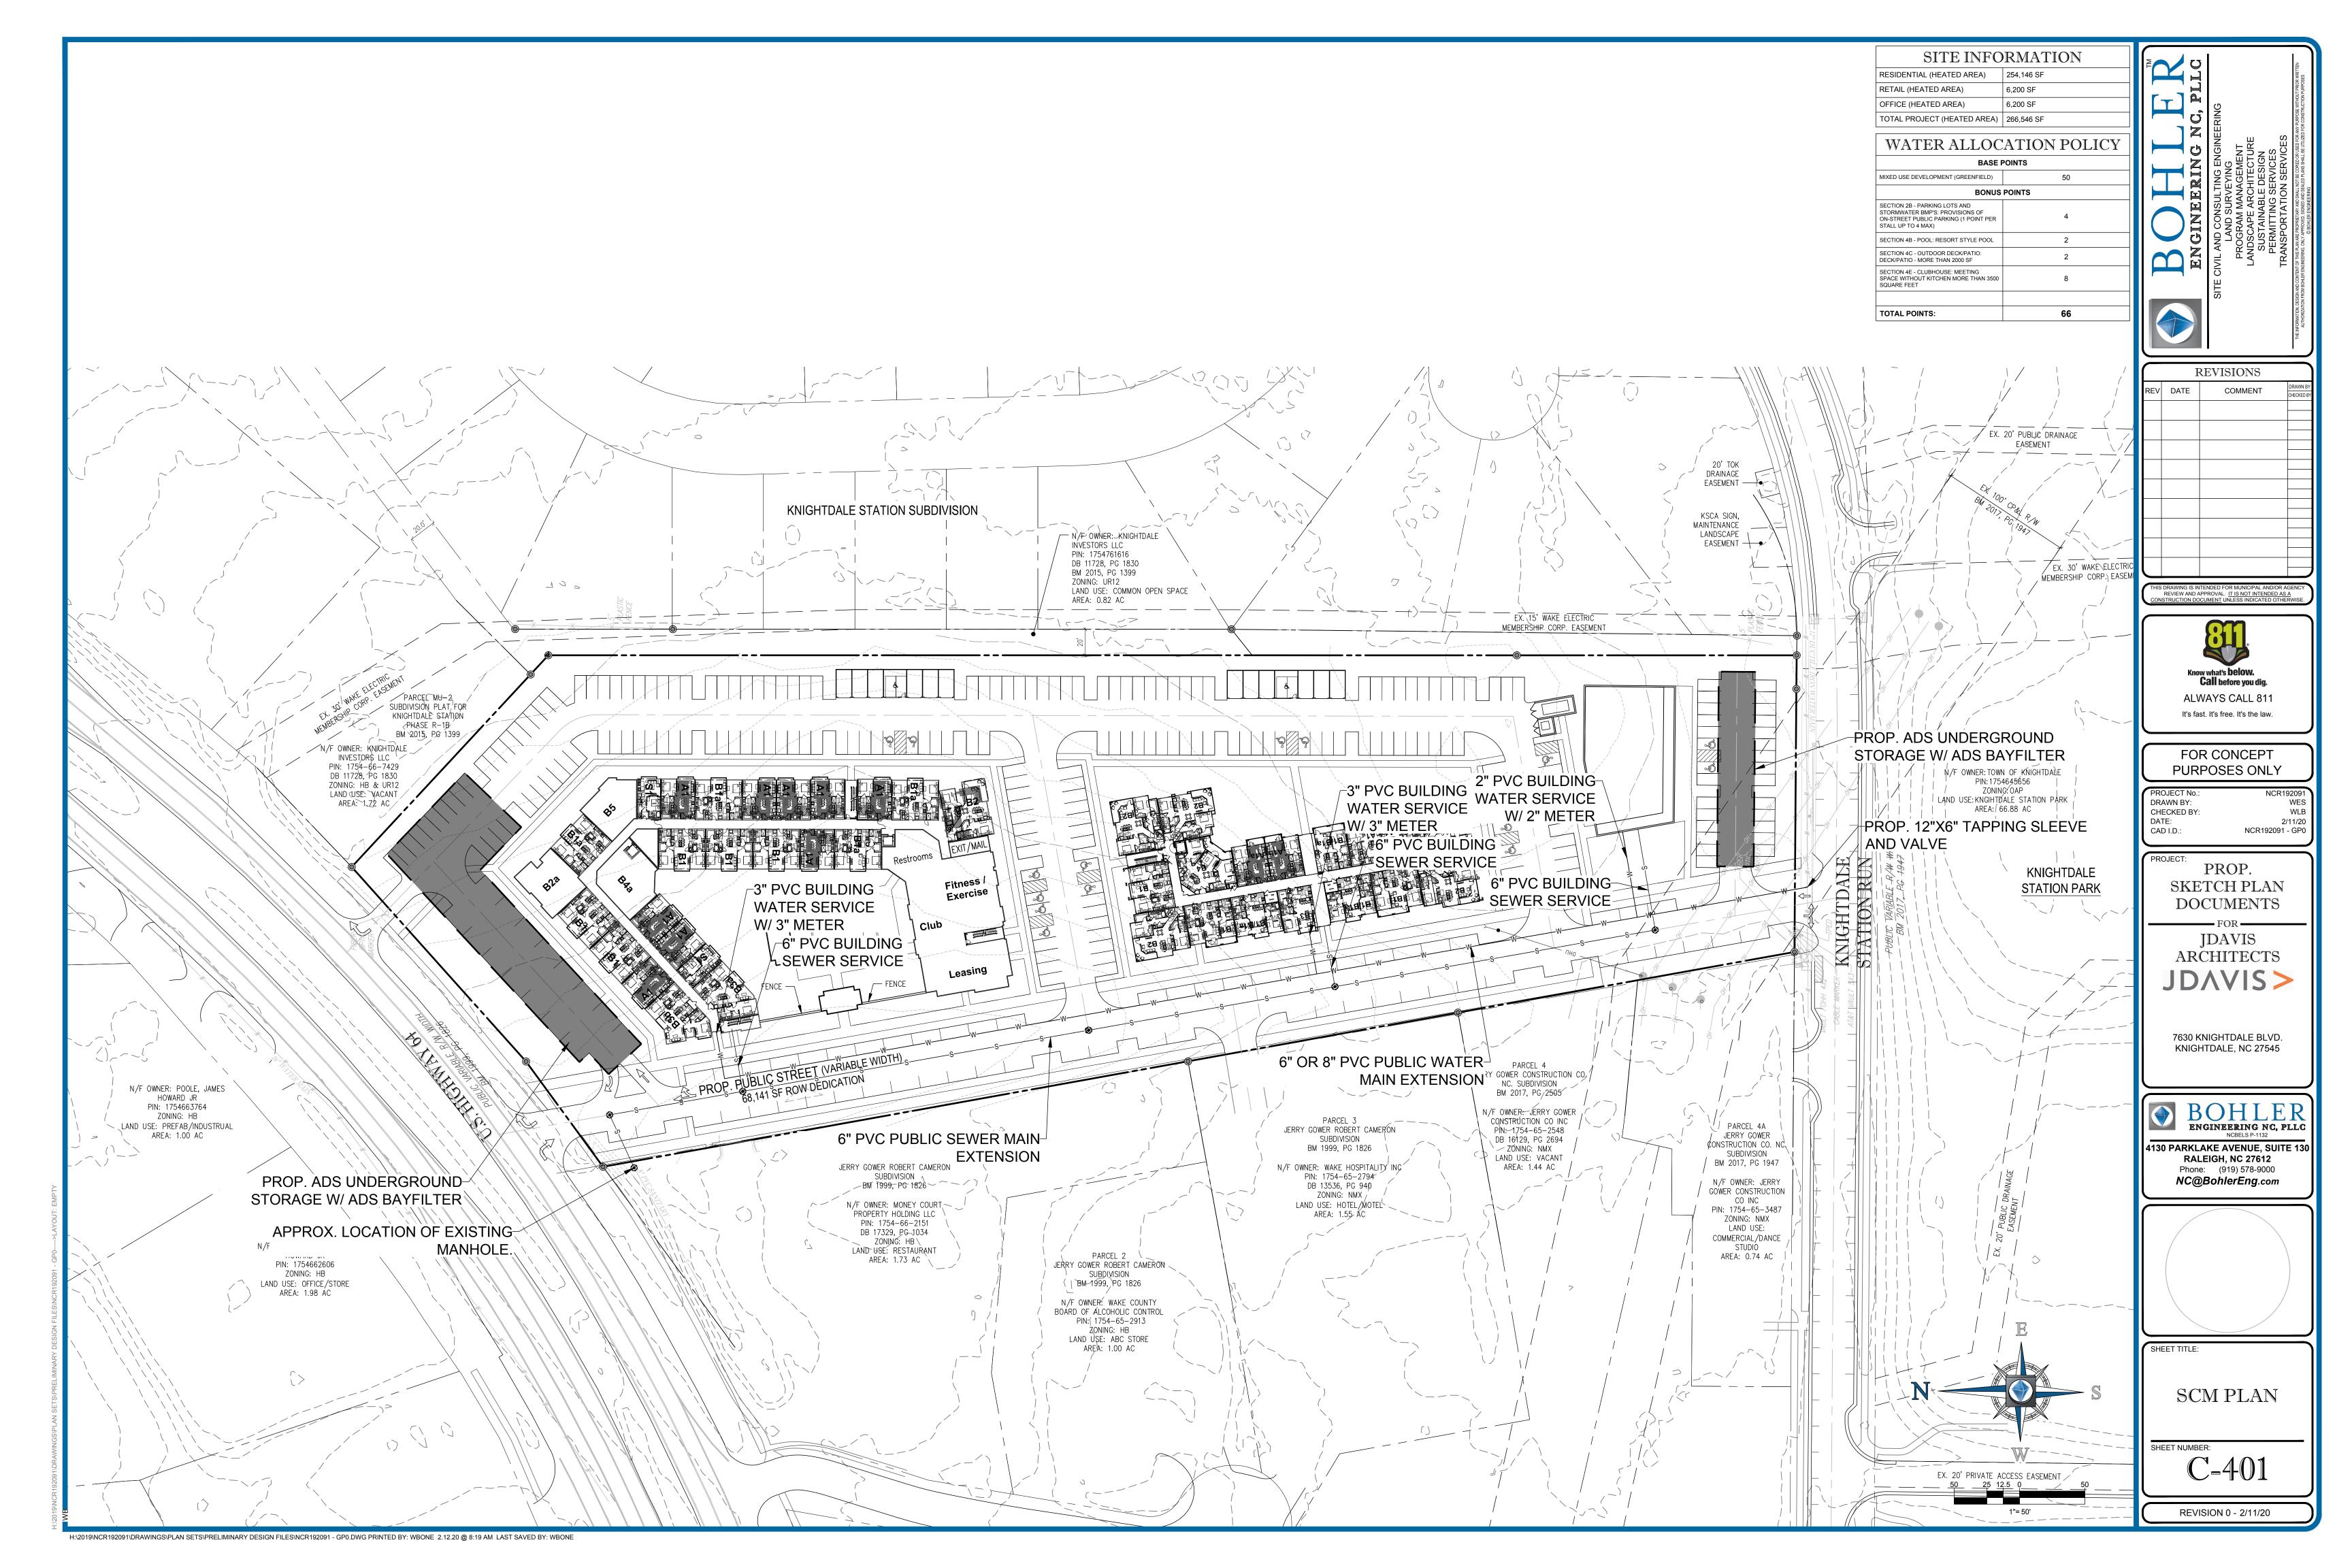

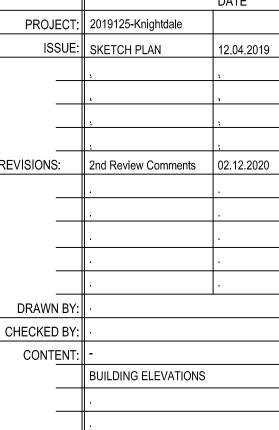

A3.01



STREETSCAPE ELEVATION

SCALE: 1/30" = 1'-0"

CEMT. PANEL & BATTEN- ----PAINT COLOR #5 - METAL COPING (WHITE) CEMT. LAP SIDING- -CEMT. PANEL & BATTEN- ----PAINT COLOR #4 PAINT COLOR #3 — CEMT. CORNICE PAINT COLOR #1 — CEMT. TRIM
PAINT COLOR #1 - CEMT. PANEL & BATTEN- PAINT COLOR (BROWN/TAN) GUARDRAIL (BROWN/TAN) --- BRICK COLOR #1 - BRICK COLOR #3 - BRICK COLOR #2 TYPICAL FRONT ELEVATION

> > BUILDING #2 ELEVATION SCALE: 1/16" = 1'-0"

SCALE: N.T.S.

> BUILDING # 1 ELEVATION SCALE: 1/16" = 1'-0"



