
WAKE VETERINARY HOSPITAL

CONSTRUCTION DRAWINGS SUBMITTAL

KNIGHTDALE TRANSACTION #: ZMA-14-21 ORDINANCE 22-08-17-004

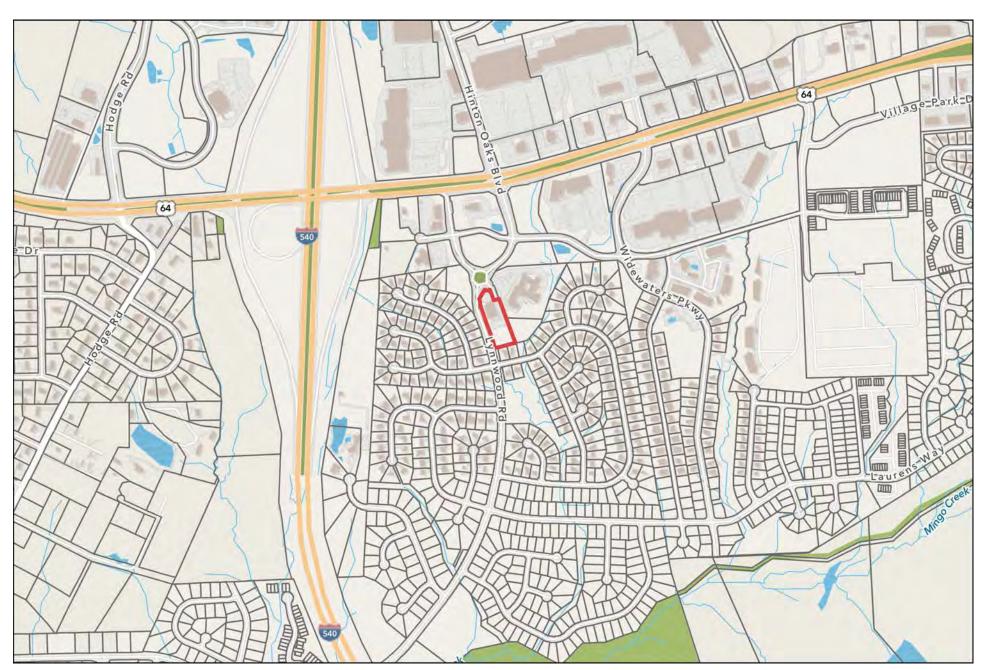

VICINITY MAP



SCALE: 1" =800'

	VI	EHICLE PARKING	
		MAXIMUM SPACES PERMITTED	MINIMUM SPACES REQUIRED
	AREA (SF)	6 per 1000 GFA	¹ ⁄ ₂ OF MAX
EXISTING BUILDING (VET HOSPITAL)	8,354	50	25
PROPOSED ADDITION	6,197	37	19
TOTAL	14,551	87	44
TOTAL EXISTING SPACES	37		
TOTAL PROPOSED SPACES	60		
DIFFERENCE	23		

ACCESSIBLE PARKING				
TOTAL # OF SPACES	THE REQUIRED PROVIDE			
60	4	4		

BICYCLE PARKING			
REQUIRED	REQUIRED PROVIDED		
5	6		

	SHEET INDEX
COV	COVER
L100	EXISTING CONDITIONS
L101	DEMOLITION PLAN
L200	LAYOUT PLAN & MATERIALS PLAN
L201	SITE DETAILS
L202	SITE DETAILS
L203	SITE DETAILS
L204	SIGNS & MARKINGS PLAN
L300	GRADING PLAN
L400	LANDSCAPE PLAN
L401	PLANTING NOTES & DETAILS
C100	STORMWATER PLAN
C101	SUBGRADE PLAN
C102	SEDIMENTATION AND EROSION CONTROL PLAN
C200	STORMWATER DETAILS
C201	STORMWATER DETAILS
C202	SEDIMENTATION AND EROSION CONTROL DETAILS
C203	SEDIMENTATION AND EROSION CONTROL DETAILS
C204	SEDIMENTATION AND EROSION CONTROL DETAILS
U100	WATER + SEWER PLAN
U200	WATER + SEWER DETAILS
22-0228A	DUKE ENERGY LIGHTING PLAN
A2.01	BUILDING ELEVATIONS
A2.02	BUILDING ELEVATIONS
A3.01	BUILDING SECTIONS

ZMA-14-21 WAKE VETERINARY HOSPITAL EXPANSION PLANNED UNIT DEVELOPMENT CONDITION:

APPROVED MASTER PLAN SHALL SERVE AS A SITE-SPECIFIC CONDITION TO THE PARCEL OF LAND IDENTIFIED AS PIN 1744-53-2798. HOWEVER, THE APPLICANT MUST SUBMIT CONSTRUCTION DRAWINGS TO THE TOWN FOR APPROVAL THAT ARE IN CONFORMANCE WITH THE APPROVED CONDITIONS OF THE NMX-CD ZONING DISTRICT, MASTER PLAN COMMENTS, UNIFIED DEVELOPMENT ORDINANCE, AND COMMENTS FROM THE MAY 12, 2022 DRC MEETING.

SITE D	ATA SUMMARY
PROJECT NAME	WAKE VET HOSPITAL
EXISTING STREET ADDRESS	1007 TANDAL PLACE, KNIGHTDALE, NC
LOT AREA (CURRENT)	74,488 SF (1.71 AC)
ZONING	NMX - CD
OVERLAY DISTRICT(S)	N/A
PARCEL NUMBER	1744532798
REAL ID NUMBER	0164389
DEED BOOK / DEED PAGE	BM 017298 / PG 02413
EXISTING BUILDING USE	VETERINARY HOSPITAL
PROPOSED BUILDINGS USES	VETERINARY HOSPITAL
EXISTING IMPERVIOUS AREA	28,718 SF
PROPOSED IMPERVIOUS AREA	41,632 SF
NET CHANGE IN IMPERVIOUS AREA	12,914 SF
WATER ALLOCATION POLICY	N/A

CONTACT INFORMATION

PROPERTY OWNER ROWDY RIDGEBACKS HOLDING LLC 4935 RALEIGH ROAD PKWY W **WILSON, NC 27896** PHONE: 919.266.9852

EMAIL: GEORGEHNEIMDVM@THEVETSPETS.COM

LANDSCAPE ARCHITECT SITE COLLABORATIVE, INC. 821 WAKE FOREST RD RALEIGH, NC 27604 CONTACT: GRAHAM H. SMITH

PHONE: 919.805.3586

EMAIL: GRAHAM@SITECOLLABORATIVE.COM

CIVIL ENGINEER FINCH & ASSOCIATES 309 N BOYLAN AVE RALEIGH, NC CONTACT: JAY WATSON

PHONE: 919.933.1212 EMAIL: JWATSON@FINCH-ASSOCIATES.COM

ARCHITECT CLINE DESIGN ASSOCIATES 125 N. HARRINGTON ST. RALEIGH, NC 27601

PHONE: 919.833.6413 EXT. 4146 EMAIL: CARLW@CLINEDESIGNASSOC.COM

CITY OF RALEIGH - PLANS AUTHORIZED FOR CONSTRUCTION

CITY OF RALEIGH DEVELOPMENT APPROVAL

PLANS FOR THE PROPOSED USE HAVE BEEN REVIEWED FOR GENERAL COMPLIANCE WITH APPLICABLE CODES. THIS LIMITED REVIEW, AND AUTHORIZATION FOR CONSTRUCTION IS NOT TO

DEVELOPMENT AND CONSTRUCTION. THE PROPERTY OWNER, DESIGN CONSULTANTS, AND CONTRACTORS ARE EACH RESPONSIBLE FOR COMPLIANCE WITH ALL APPLICABLE CITY, STATE AND FEDERAL LAWS. THIS SPECIFIC AUTHORIZATION BELOW IS NOT A PERMIT, NOR SHALL IT BE

CONSTRUED TO PERMIT ANY VIOLATION OF CITY, STATE OR FEDERAL LAW. ALL CONSTRUCTION

APPROVAL OF THIS ELECTRONIC DOCUMENT IS ONLY VALID IF THE DOCUMENT HAS NOT BEEN MODIFIED AND THE DIGITAL SIGNATURE BELOW IS VALID:

MUST BE IN ACCORDANCE WITH ALL LOCAL, STATE, AND FEDERAL RULES AND REGULATIONS. THIS

BE CONSIDERED TO REPRESENT TOTAL COMPLIANCE WITH ALL LEGAL REQUIREMENTS FOR

oldi Q

Ride(Indal

Raleigh, NC 27604 | 919.805.3586

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shall not be used for any other project

12.14.2022 SIGNATURE SET

PROJECT NUMBER:

DRAWINGS

CONSTRUCTION

20063

COVER SHEET

SHEET NUMBER: COV

a. Town Certification. This design has been reviewed by the Engineer for the Town of Knightdale, and to the best of my knowledge and belief, it conforms to the requirements established in the Standard Specifications of the Town of Knightdale.

Town Engineer


These plans are approved by the Town of Knightdale and serve as construction plans for this project.

Land Use Administrator

Town Approved Standards Shall Control. In the event of a conflict or inconsistency between these construction drawings and the Town of Knightdale's Approved Standards for this project, the Approved Standards shall control. Town of Knightdale Approved Standards shall mean all development documents necessary for approval for the Property including, but not limited to, any special use permit, subdivision plan, site plan, subdivision plat(s), phasing schedule, Development Agreement, Utility Allocation Agreement, Annexation Agreement, the Town of Knightdale Standard Specification and Details Manual and applicable provisions of the North Carolina State Building Code.

Professional Design Engineer Certification. These improvements shall be constructed in accordance with the following drawings and with the Standard Specifications of the Town of of Knightdale have been thoroughly checked and found to be applicable to this project. All Knightdale and said exceptions are shown on Sheet(s)

_, PE, certify that the Standard Specifications of the Town exceptions to the applicable Town standards have been previously approved by the Town of

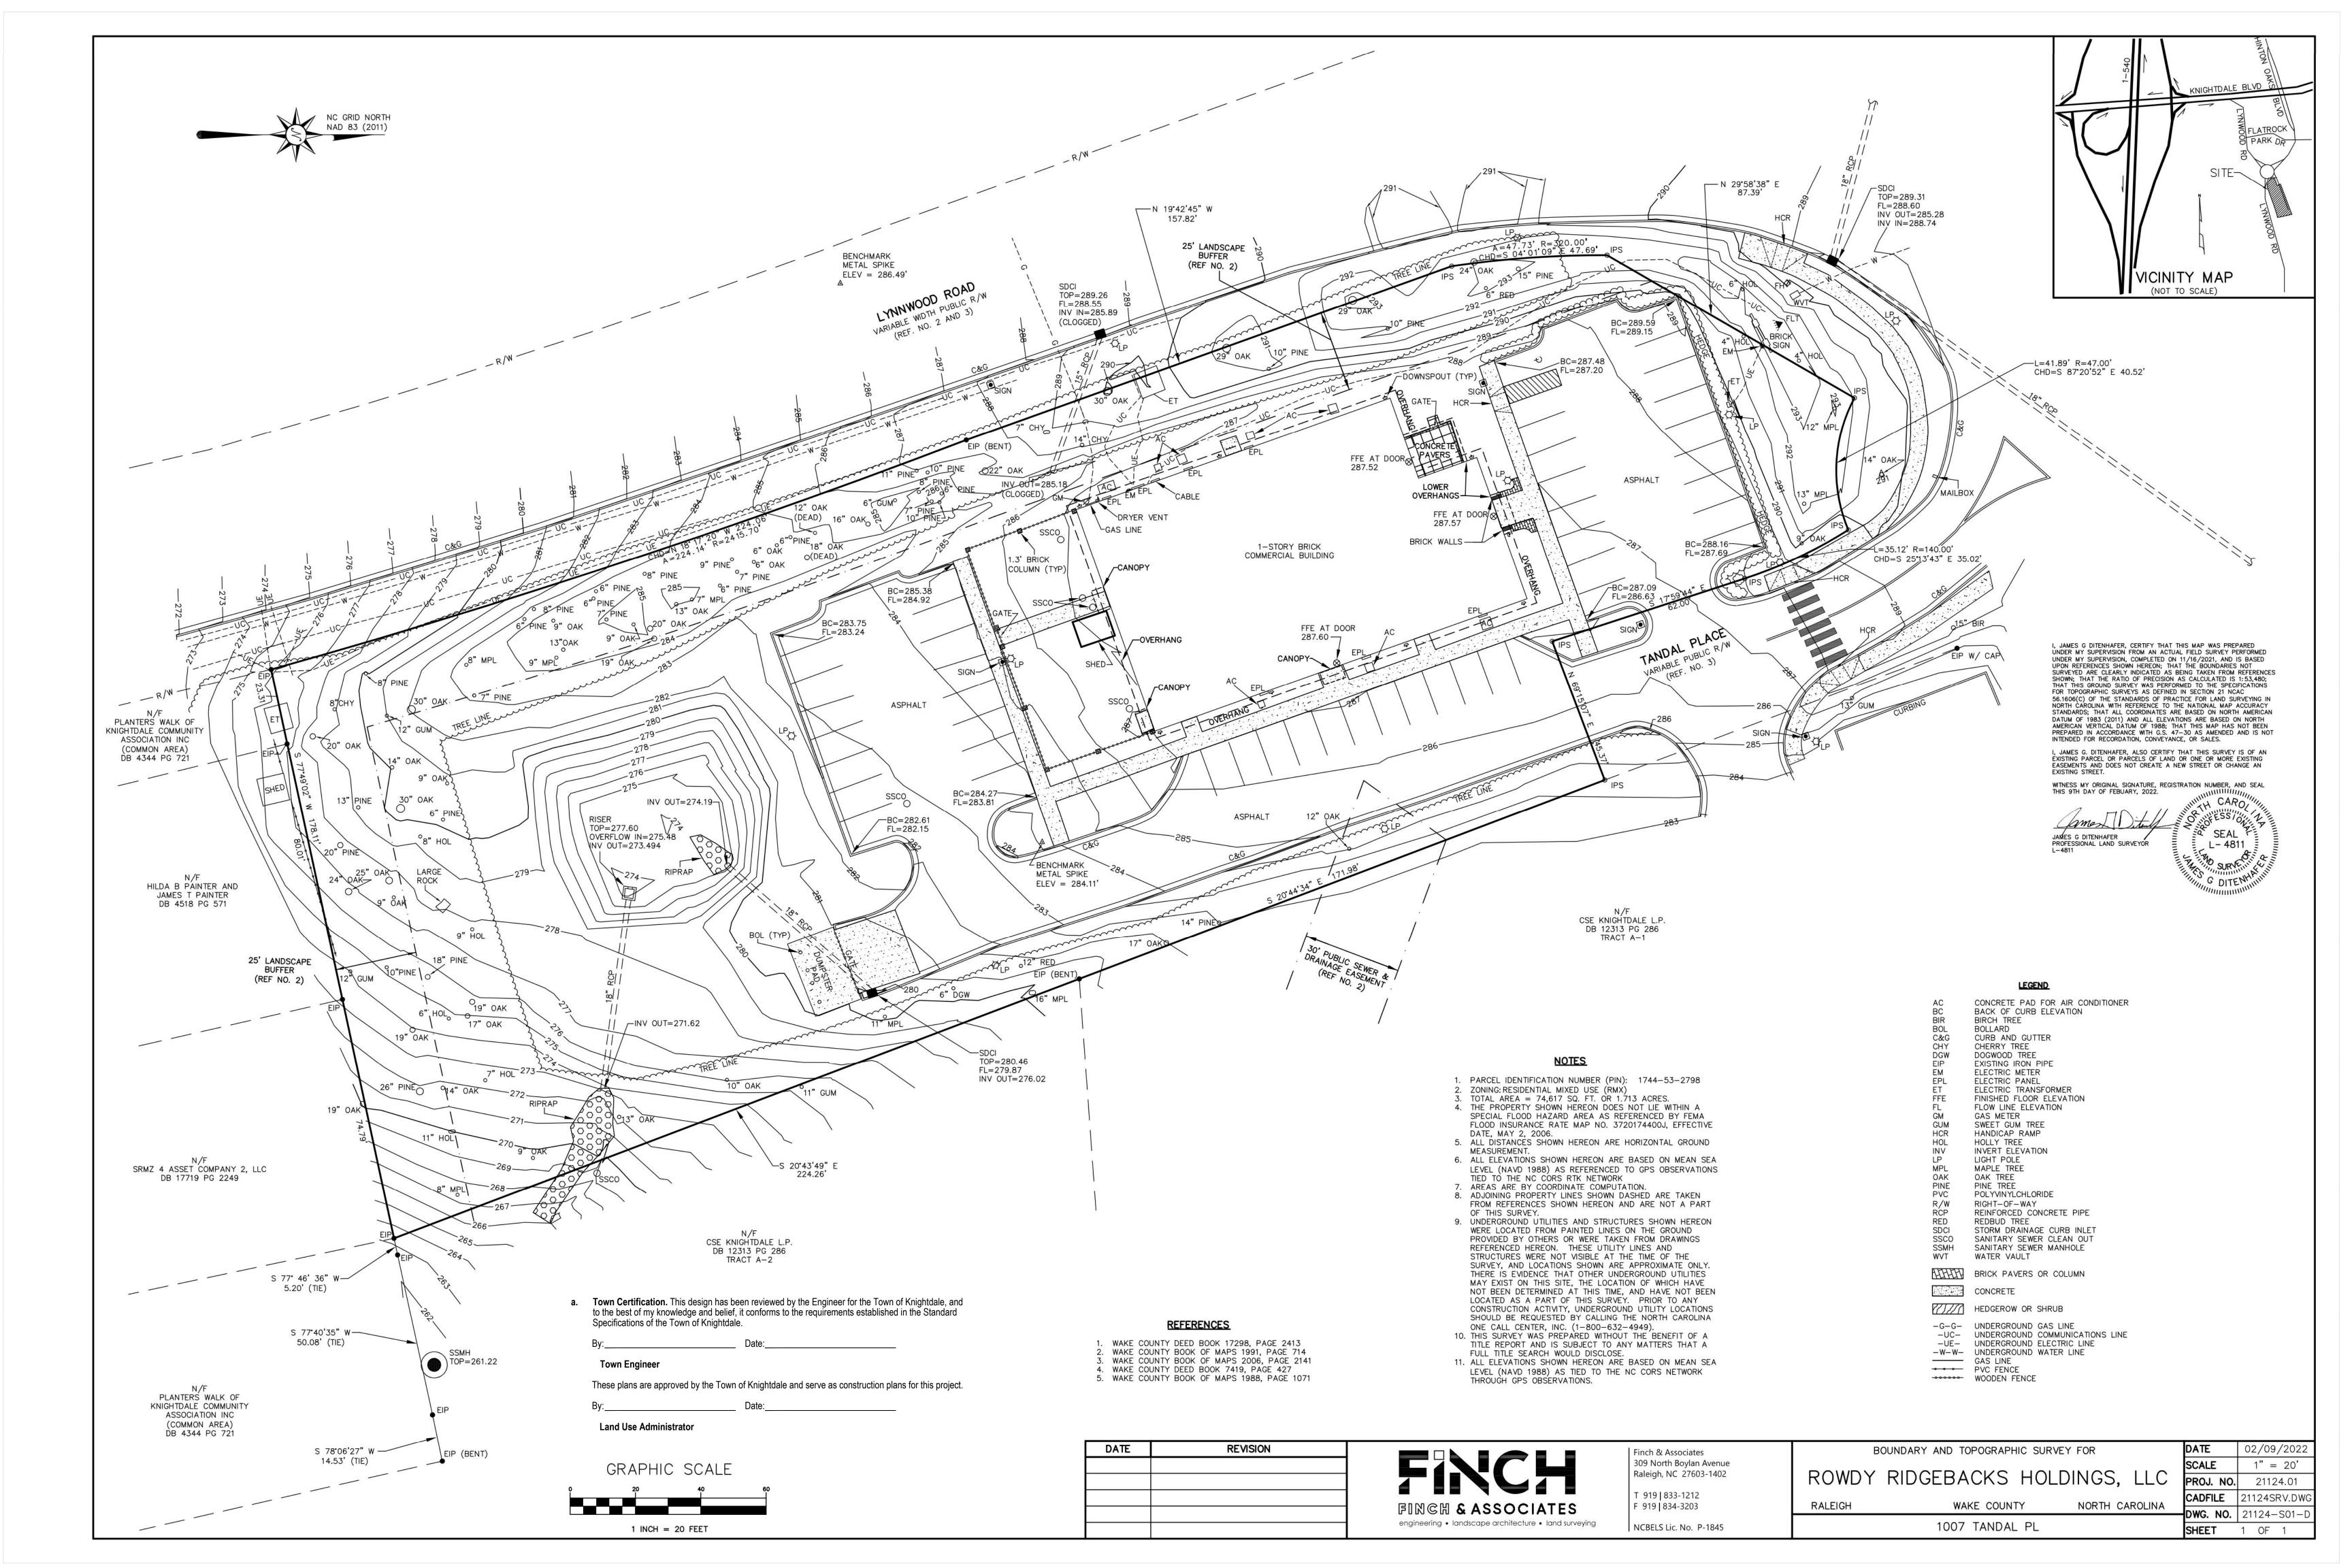

DEMOLITION NOTES

PLANTERS WALK OF KNIGHTDALE COMMUNITY ASSOCIATION INC (COMMON AREA) DB 4344 PG 721

HILDA B PAINTER AND

JAMES T PAINTER DB 4518 PG 571

N/F SRMZ 4 ASSET COMPANY 2, LLC

DB 17719 PG 2249

a. Town Certification. This design has been reviewed by the Engineer for the Town of Knightdale, and

to the best of my knowledge and belief, it conforms to the requirements established in the Standard

These plans are approved by the Town of Knightdale and serve as construction plans for this project.

25' LANDSCAPE BUFFER

(REF NO. 2)

5.20' (TIE)

S 77°40'35" W —

TOP=261.22

50.08' (TIE)

- 1. THE CONTRACTOR SHALL NOTIFY THE N.C. ONE CALL CENTER AT 811 OR 1-800-632-4949 PRIOR TO STARTING WORK.
- 2. THE CONTRACTOR SHALL NOTIFY THE LOCAL GOVERNING PUBLIC UTILITIES DEPARTMENT PRIOR TO STARTING WORK.
- ALL DEMOLITION, AND ANY SUBSEQUENT CONSTRUCTION, SHALL BE PERFORMED IN ACCORDANCE WITH THESE PLANS AND SPECIFICATIONS SET FORTH AND APPROVED BY THE LOCAL GOVERNING MUNICIPALITY OR THE STATE. THE CONTRACTOR IS RESPONSIBLE FOR OBTAINING ALL REQUIRED PERMITS.
- 4. THE CONTRACTOR SHALL NOT MAKE ANY LANE CLOSURES OR CHANGES TO THE EXISTING TRAVEL PATTERNS ON ANY PUBLIC STREET WITHOUT PRIOR APPROVAL FROM THE LOCAL GOVERNING MUNICIPALITY TRANSPORTATION DEPARTMENT AND/OR STATE TRANSPORTATION
- LANE CLOSURE, TRAFFIC CONTROL PLAN, OR PEDESTRIAN CONTROL PLAN TO BE COORDINATED WITH APPROPRIATE STAFF OF THE LOCAL
- 6. THE CONTRACTOR IS RESPONSIBLE FOR CONFORMING TO ALL LOCAL, STATE AND FEDERAL REQUIREMENTS REGARDING REMOVAL AND DISPOSAL OF MATERIALS AND DEBRIS.
- 7. CONTRACTOR SHALL REFER TO CIVIL SHEETS FOR SANITARY SEWER AND WATER REMOVALS AND RELOCATIONS.
- 8. RELOCATION OF EXISTING UTILITIES TO BE COORDINATED WITH THE LOCAL UTILITY PROVIDER(S).
- 9. WHERE UTILITIES (TO BE REMOVED) IMPACT THE FOOTPRINT OF THE NEW BUILDING, CONTRACTOR SHALL EXCAVATE AND REMOVE AN ADDITIONAL 2 FEET OF SOILS TO EITHER SIDE OF PIPE, AND 1 FOOT BELOW TO REMOVE UNSUITABLE SOILS, IF UNSUITABLE SOILS EXIST.
- 10. CLEANOUTS LOCATED IN AREAS OF DEMOLITION OR SUBSEQUENT CONSTRUCTION THAT ARE TO REMAIN, SHALL BE PROTECTED FROM DAMAGE AND RAISED TO FLUSH WITH NEW GRADE.
- 11. ELECTRICAL OR GAS UTILITY SERVICES TO BE REMOVED SHALL BE REMOVED AND RELOCATED (AS INDICATED) BY THE UTILITY PROVIDER. CONTRACTOR SHALL SCHEDULE AND COORDINATE THIS WORK WITH THE APPROPRIATE SERVICE PROVIDER. ALL SERVICES SHOULD BE

RE-INSTALLED PRIOR TO THE INSTALLATION OF PAVEMENT, SIDEWALKS, CURB AND GUTTER, OR OTHER PERMANENT FEATURES.

- 12. REMOVE EXISTING CONCRETE (WHERE REQUESTED) TO FIRST COLD JOINT OR SAWCUT JOINT TO OBTAIN A CLEAN EDGE FOR NEW CONSTRUCTION. SAWCUT EXISTING ASPHALT DRIVE AT LIMITS OF NEW CURBING TO OBTAIN A CLEAN EDGE.
- 13. CONTRACTOR SHALL RETAIN AND STOCKPILE CONCRETE WHEELSTOPS WHICH ARE IN USEABLE CONDITION FOR RE-INSTALLATION AT THE END OF THE PROJECT.
- 14. CONTRACTOR SHALL RESTORE THE LAYDOWN AND STAGING AREA TO ORIGINAL CONDITIONS AND TO THE SATISFACTION OF THE OWNER, PRIOR TO DEMOBILIZATION AT THE CONCLUSION OF THE PROJECT.

- 15. CLEAN SOILS SHALL BE UTILIZED FOR BACKFILL. COMPACTION OF THESE SOILS PERFORMED IN ACCORDANCE WITH SPECIFICATIONS, GEOTECHNICAL REPORT, AND SITE PLAN.
- 16. ALL FENCING TO BE REMOVED SHALL BE REMOVED AT NEXT NEAREST POLE.
- 17. ALL GRAVEL TO BE REMOVED (SURFACE OR SUBSURFACE) SHALL BE STOCKPILED AND REUSED ON SITE WHERE POSSIBLE.
- 18. ALL ITEMS DESIGNATED TO BE REMOVED SHALL BE REMOVED COMPLETELY, INCLUDING ALL SUBGRADE MATERIALS DIRECTLY ASSOCIATED WITH ITEMS TO BE REMOVED.
- 19. ALL ITEMS DESIGNATED TO BE REMOVED SHALL BE DISPOSED OF LEGALLY OFFSITE UNLESS OTHERWISE NOTED ON THIS PLAN.
- 21. ALL TREE PROTECTION FENCING SHALL REMAIN IN PLACE DURING DEMOLITION AND CONSTRUCTION.
- 22. NO CONSTRUCTION MATERIAL PLACED WITHIN THE CRZ OF EXISTING TREES.

TOP=277.60

TREE SAVE AREA BEHIND

TREE PROTECTION

INV OUT=273.494

OVERFLOW IN=275.48

- EX. STORM PIPE TO BE REMOVED

_INV OUT=271.62


REMOVED

TYP.

TRACT A-2

CRITICAL ROOT ZONE (CRZ)

SCALE: N.T.S

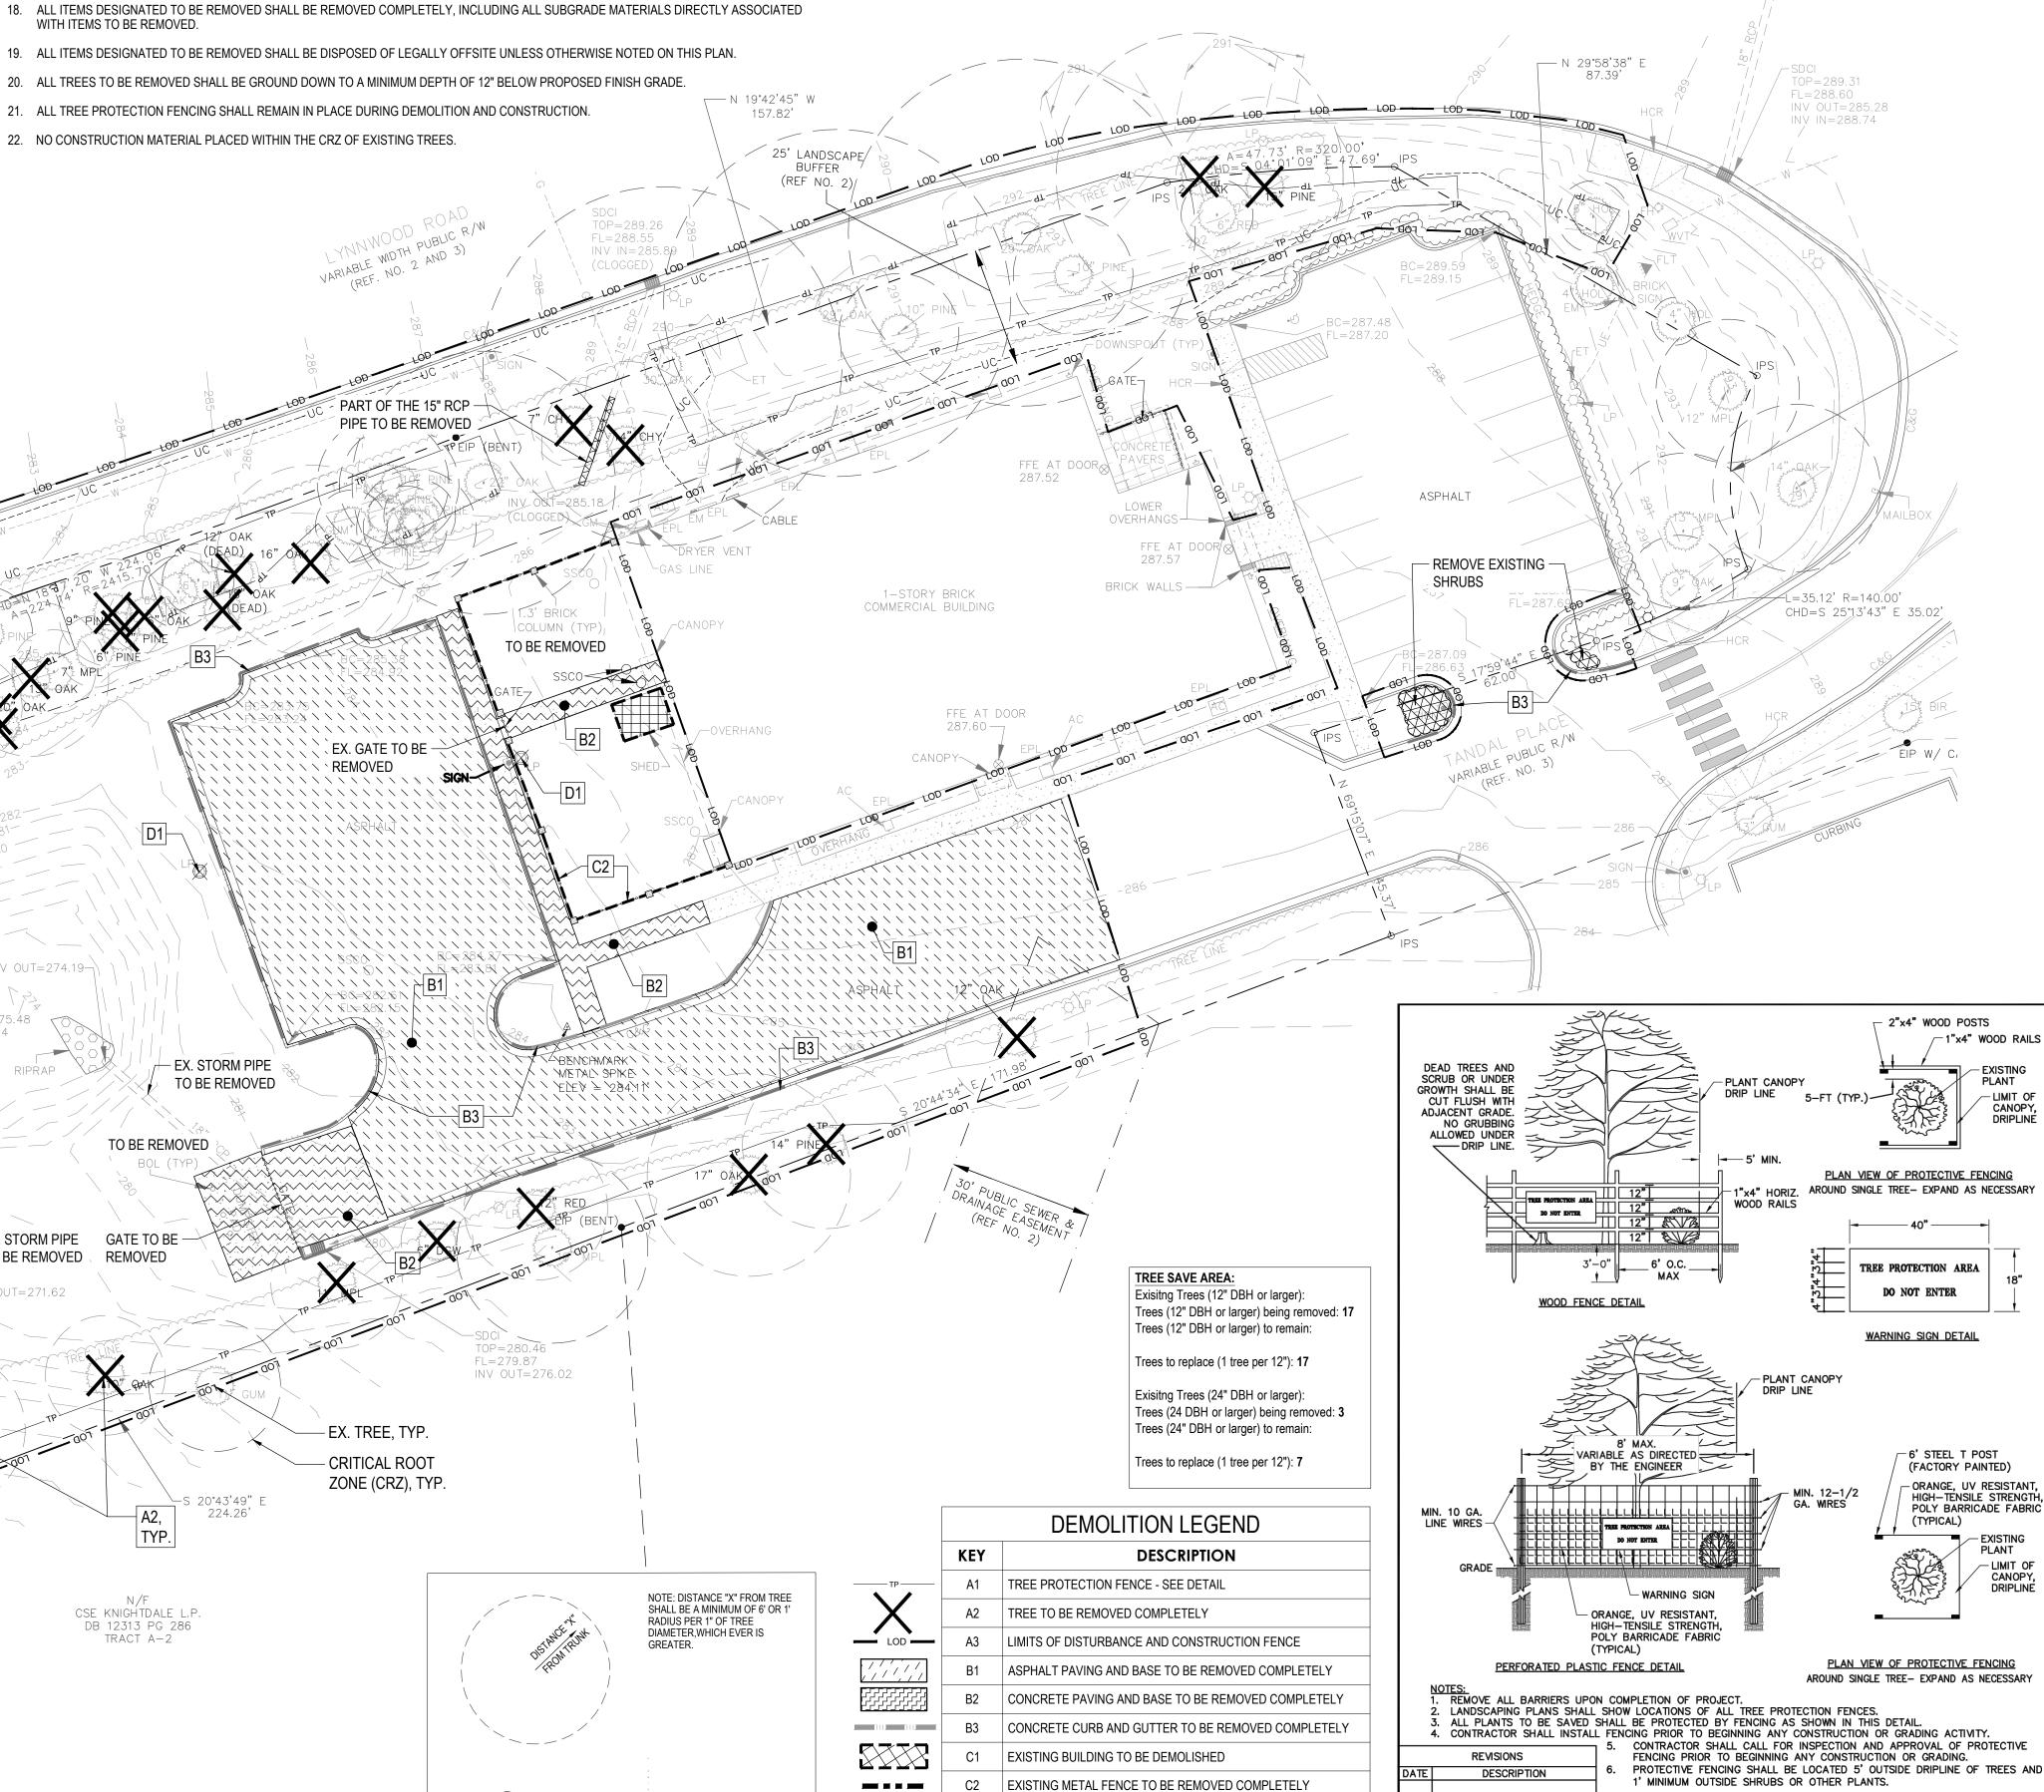

POWER POLE TO BE REMOVED COMPLETELY. CONTRACTOR TO

DRY UTILITY BOX/DEVICE TO BE REMOVED COMPLETELY -


CONTRACTOR TO COORDINATE WITH UTILITY PROVIDER

TOWN OF KNIGHTDALE


STANDARD DETAILS


COORDINATE WITH UTILITY PROVIDER

PLANT PROTECTIVE FENCING

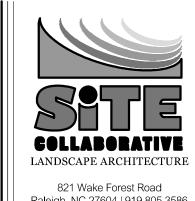

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QC 00 PROJECT NUMBER:

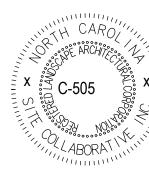20063 CONSTRUCTION DRAWINGS 12.14.2022 SIGNATURE SET

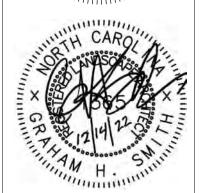DEMOLITION PLAN


SHEET TITLE:

STD. NO.

2.10

Town Engineer

Specifications of the Town of Knightdale.

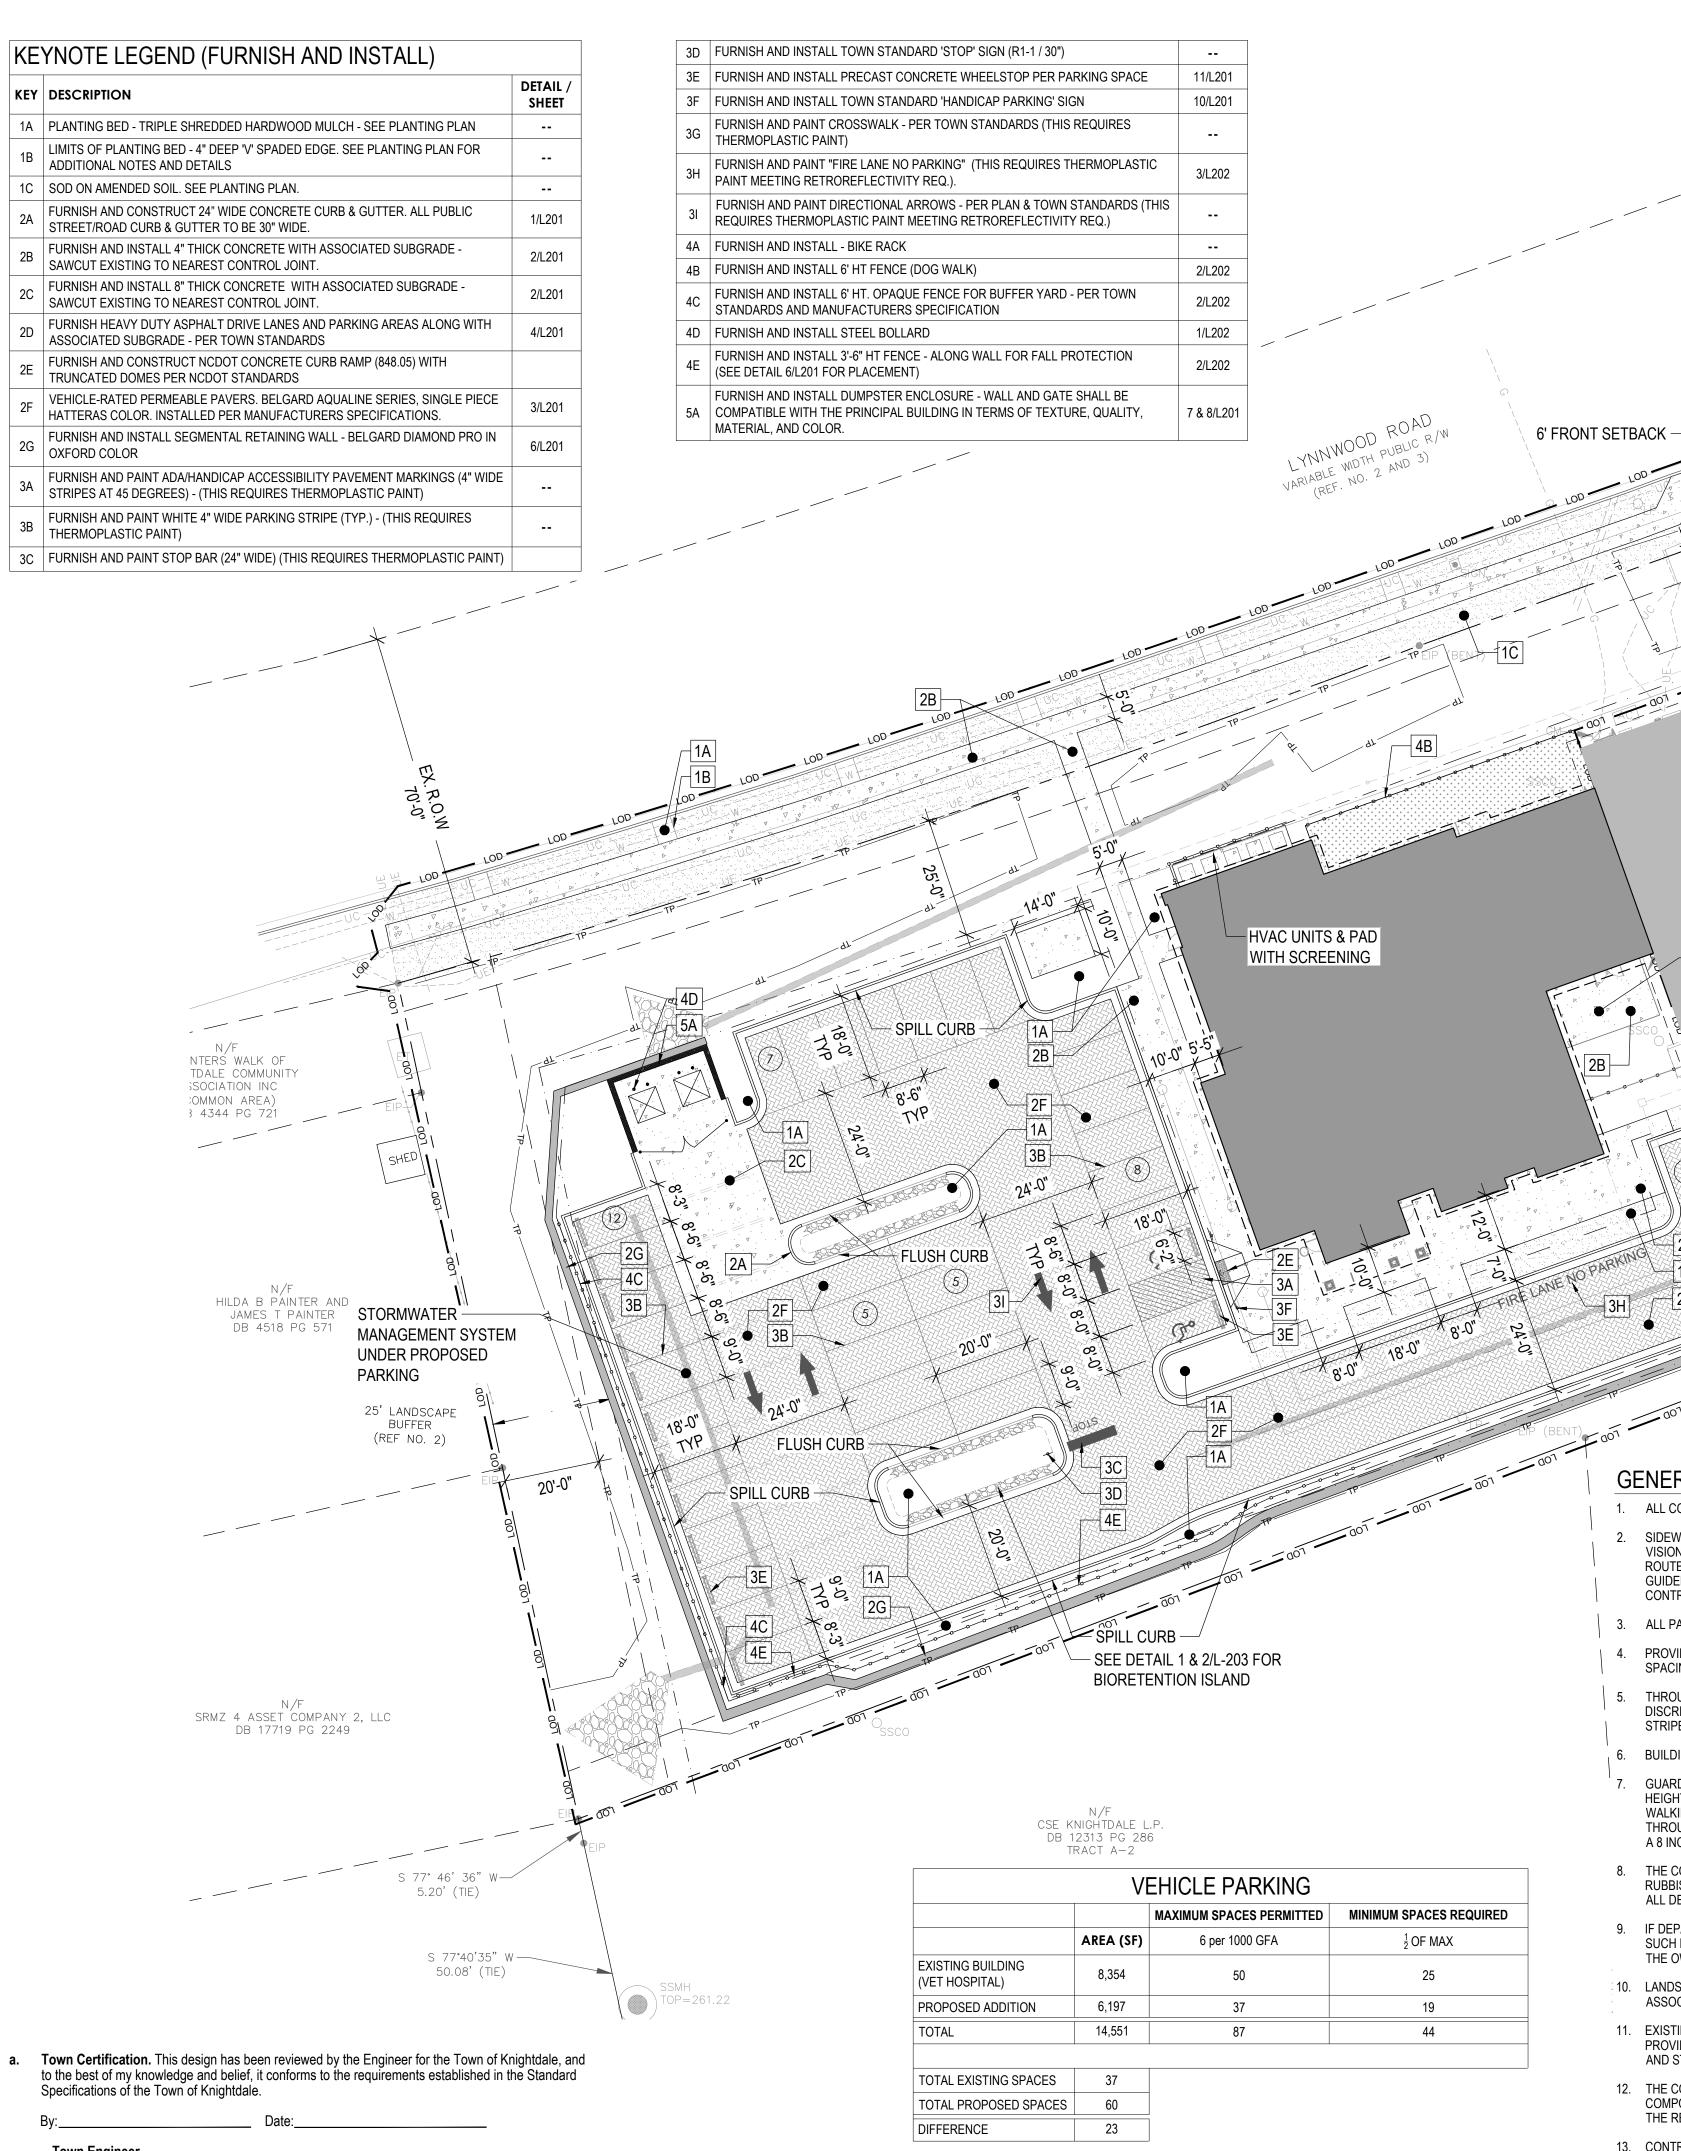

ACCESSIBLE PARKING

SPACES

REQUIRED

PROVIDED

These plans are approved by the Town of Knightdale and serve as construction plans for this project.

Land Use Administrator

BICYCLE PARKING

PROVIDED

GENERAL SITE NOTES ALL CONSTRUCTION IN RIGHT-OF-WAY PER TOWN OF KNIGHTDALE STANDARD. SIDEWALKS ALONG RIGHT-OF-WAY ARE PUBLIC AND MUST BE ACCESSIBLE TO PERSONS WHO ARE BLIND, HAVE LOW

REPAIR DAMAGED ASPHALT FOR POSITIVE DRAINAGE

10' REAR SETBACK

CSE KNIGHTDALE L.P. DB 12313 PG 286

TRACT A-1

VISION AND PEOPLE WITH MOBILITY DISABILITIES. EXISTING PEDESTRIAN ROUTES AND ALTERNATE PEDESTRIAN ROUTES DURING CONSTRUCTION ARE REQUIRED TO BE COMPLIANT WITH THE PUBLIC RIGHTS OF WAY ACCESSIBILITY GUIDELINES (PROWAG), 2010 ADA STANDARDS FOR ACCESSIBLE DESIGN AND THE MANUAL ON UNIFORM TRAFFIC CONTROL DEVICES (MUTCD).

3. ALL PAVEMENTS TO SLOPE POSITIVELY AWAY FROM ALL BUILDINGS.PONDING OF WATER IS PROHIBITED.

25' LANDSCAPE

BUFFER

(REF NO. 2

STAFF

COURTYARD

PROVIDE CONSTRUCTION JOINTS IN CONCRETE WALKWAYS AS SHOWN IN PLANS. IF NOT SHOWN ON PLANS - MAX SPACING @ 10'

THROUGHOUT PROJECT SITE, ALL DIMENSIONS TO BE FIELD VERIFIED. NOTIFY THE LANDSCAPE ARCHITECT OF ANY DISCREPANCY. ALL DIMENSIONS ARE TO OUTSIDE FACE OF BUILDING, TO CENTERLINE, CENTER TO CENTER ON STRIPES, AND/OR FACE OF CURB, UNLESS OTHERWISE NOTED.

BUILDING AND PUBLIC ROADWAY STAKE OUT SHALL BE PERFORMED BY A REGISTERED LAND SURVEYOR.

GUARDRAILS MUST BE INSTALLED ON THE OPEN SIDES OF ELEVATED WALKING SURFACES THAT EXCEED 30 INCHES IN HEIGHT. ALL GUARDRAILS MUST BE A MINIMUM HEIGHT OF 42 INCHES ABOVE THE LEADING EDGE OF THE TREAD OR WALKING SURFACE. GUARDRAILS SHALL HAVE BALUSTERS SUCH THAT A 4 INCH DIAMETER SPHERE CANNOT PASS THROUGH ANY OPENING UP TO A HEIGHT OF 34 INCHES. FROM 34 INCHES TO 42 INCHES ABOVE THE WALKING SURFACE, A 8 INCH DIAMETER SPHERE SHALL NOT PASS.

8. THE CONTRACTOR, AT ALL TIMES, MUST KEEP THE PREMISES FREE FROM ACCUMULATIONS OF WASTE MATERIALS OR RUBBISH CAUSED BY THE CONTRACTOR, THE CONTRACTOR'S EMPLOYEES OR THE CONTRACTOR'S SUBCONTRACTOR. ALL DEBRIS SHALL BE REMOVED FROM THE PROJECT SITE ON A DAILY BASIS.

9. IF DEPARTURES FROM THE DRAWINGS OR SPECIFICATIONS ARE DEEMED NECESSARY BY THE CONTRACTOR, DETAILS OF SUCH DEPARTURES FROM THE CONTRACT DOCUMENTS SHALL BE MADE WITH THE EXPRESS WRITTEN PERMISSION OF

10. LANDSCAPE ARCHITECT AND/OR OWNER DISCLAIM ANY ROLE IN THE CONSTRUCTION MEANS AND/OR METHODS ASSOCIATED WITH THE PROJECT AS SET FORTH IN THESE PLANS.

11. EXISTING UTILITIES AND STRUCTURES SHOWN, BOTH UNDERGROUND AND ABOVE, ARE BASED ON A FIELD DATA PROVIDED TO LANDSCAPE ARCHITECT. THE CONTRACTOR SHALL LOCATE EXISTING UTILITIES, UNDERGROUND LINES, AND STRUCTURES AS NECESSARY TO AVOID DAMAGING OR DESTROYING EXISTING SERVICES.

12. THE CONTRACTOR IS RESPONSIBLE FOR FIELD VERIFYING THE ACTUAL AND EXACT LOCATION, SIZE, AND MATERIAL COMPOSITION OF ANY EXISTING WATER OR SEWER SERVICE PROPOSED FOR CONNECTION OR USE ON THIS PROJECT THE RELOCATION OF ANY UTILITY SERVICES REQUIRED TO COMPLETE ANY PORTION OF THESE CONSTRUCTION PLANS.

13. CONTRACTOR SHALL MAINTAIN AN "AS BUILT" SET OF DRAWINGS TO RECORD ANY FIELD CHANGES, ALONG WITH ANY PIPING PRIOR TO CONCEALMENT. DRAWINGS SHALL BE GIVEN TO THE OWNER AT THE END OF THE PROJECT.

- 14. THE CONTRACTOR IS RESPONSIBLE FOR OBTAINING ALL REQUIRED PERMITS. ALL CONSTRUCTION SHALL BE IN ACCORDANCE WITH PERMITS AS ISSUED, AND ANY AND ALL APPLICABLE STATE, COUNTY AND LOCAL CODES.
- 15. EXISTING IMPROVEMENTS DAMAGED OR DESTROYED DURING CONSTRUCTION SHALL BE REPLACED OR RESTORED TO THEIR ORIGINAL CONDITION, AND TO THE SATISFACTION OF THE OWNER OF THE IMPROVEMENTS.
- 16. THE CONTRACTOR SHALL OBTAIN AND PAY FOR ALL INSPECTIONS, CERTIFICATIONS, AND/OR ANY OTHER REQUIREMENTS WHICH MUST BE MET UNDER CONTRACT.

1. WHERE CURB AND GUTTER SURROUNDS THE PAVERS, INSTALL

2. TOWN OF KNIGHTDALE STANDARD 30" CURB & GUTTER REQUIRED

THAN INTO INLETS. SEE DETAIL 1A/201

EVERYWHERE ELSE ON SITE. SEE DETAIL 1/L201

SPILL CURB TO DIRECT STORMWATER INTO THE PAVERS, RATHER

EXISTING FIRE

HYDRANT

12' SIDE SETBACK

PUBLIC GATHERING AREA

(500 SF) THAT INCLUDES

CHAIRS (SEE SHEET L202)


EXISTING

PARKING AREA

TO REMAIN


MOVABLE TABLES AND

- 17. CONTRACTOR SHALL REFER TO ARCHITECTURAL PLANS FOR DETAILS OF BUILDINGS AND BUILDING DIMENSIONS.
- 18. CONTRACTOR SHALL COORDINATE CONSTRUCTION OF ALL UNDERGROUND UTILITIES FOR THIS PROJECT WITH THE OWNER'S REPRESENTATIVE PER ALL APPLICABLE REGULATIONS.
- 19. CONTRACTOR SHALL COORDINATE WITH OTHER CONTRACTOR'S ON SITE AND UTILITY PROVIDERS DURING CONSTRUCTION TO ENSURE SMOOTH TRANSITION BETWEEN DISCIPLINES.
- 20. ALL DEMOLITION, AND ANY SUBSEQUENT CONSTRUCTION, SHALL BE PERFORMED IN ACCORDANCE WITH THESE PLANS AND SPECIFICATIONS SET FORTH AND APPROVED BY THE TOWN OF KNIGHTDALE. THE CONTRACTOR IS RESPONSIBLE FOR OBTAINING ALL REQUIRED PERMITS. ALL TREE PROTECTION FENCING SHALL REMAIN IN PLACE DURING
- 21. TRAFFIC CONTROLS FOR ANY UTILITY WORK WITHIN THE PUBLIC RIGHT OF WAY SHALL BE PERFORMED IN COMPLIANCE WITH STANDARDS OF THE NORTH CAROLINA MANUAL ON UNIFORM TRAFFIC CONTROL DEVICES (MUTCD).
- 22. ALL CROSSWALK MARKINGS WITHIN RIGHT-OF-WAY SHALL BE CONSTRUCTED OF THERMOPLASTIC MATERIALS AND CONSTRUCTED IN ACCORDANCE WITH NCDOT SPECIFICATIONS. CONTRACTOR TO INSTALL CROSSWALKS IN SUCH A MANNER THAT CROSSWALKS ARE ALIGNED BETWEEN HANDICAP/WALKWAY ACCESS POINTS OR PERPENDICULAR TO THE ROADWAY / DRIVE LANE.
- 23. ALL SIGNS AND PAVEMENT MARKINGS ARE TO MEET MUTCD (MANUAL ON UNIFORM TRAFFIC CONTROL DEVICES) AND NCDOT STANDARDS.
- 24. ALL SIGNS SHALL USE PRISMATIC SHEETING THAT MEETS MINIMUM RETROREFLECTIVITY STANDARDS FOUND IN THE LATEST EDITION OF THE MUTCD.

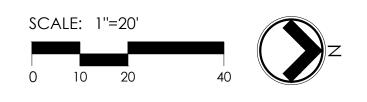



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20063

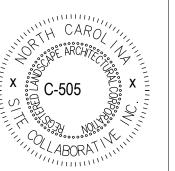
CONSTRUCTION DRAWINGS

12.14.2022


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SHEET TITLE:

LAYOUT & MATERIALS

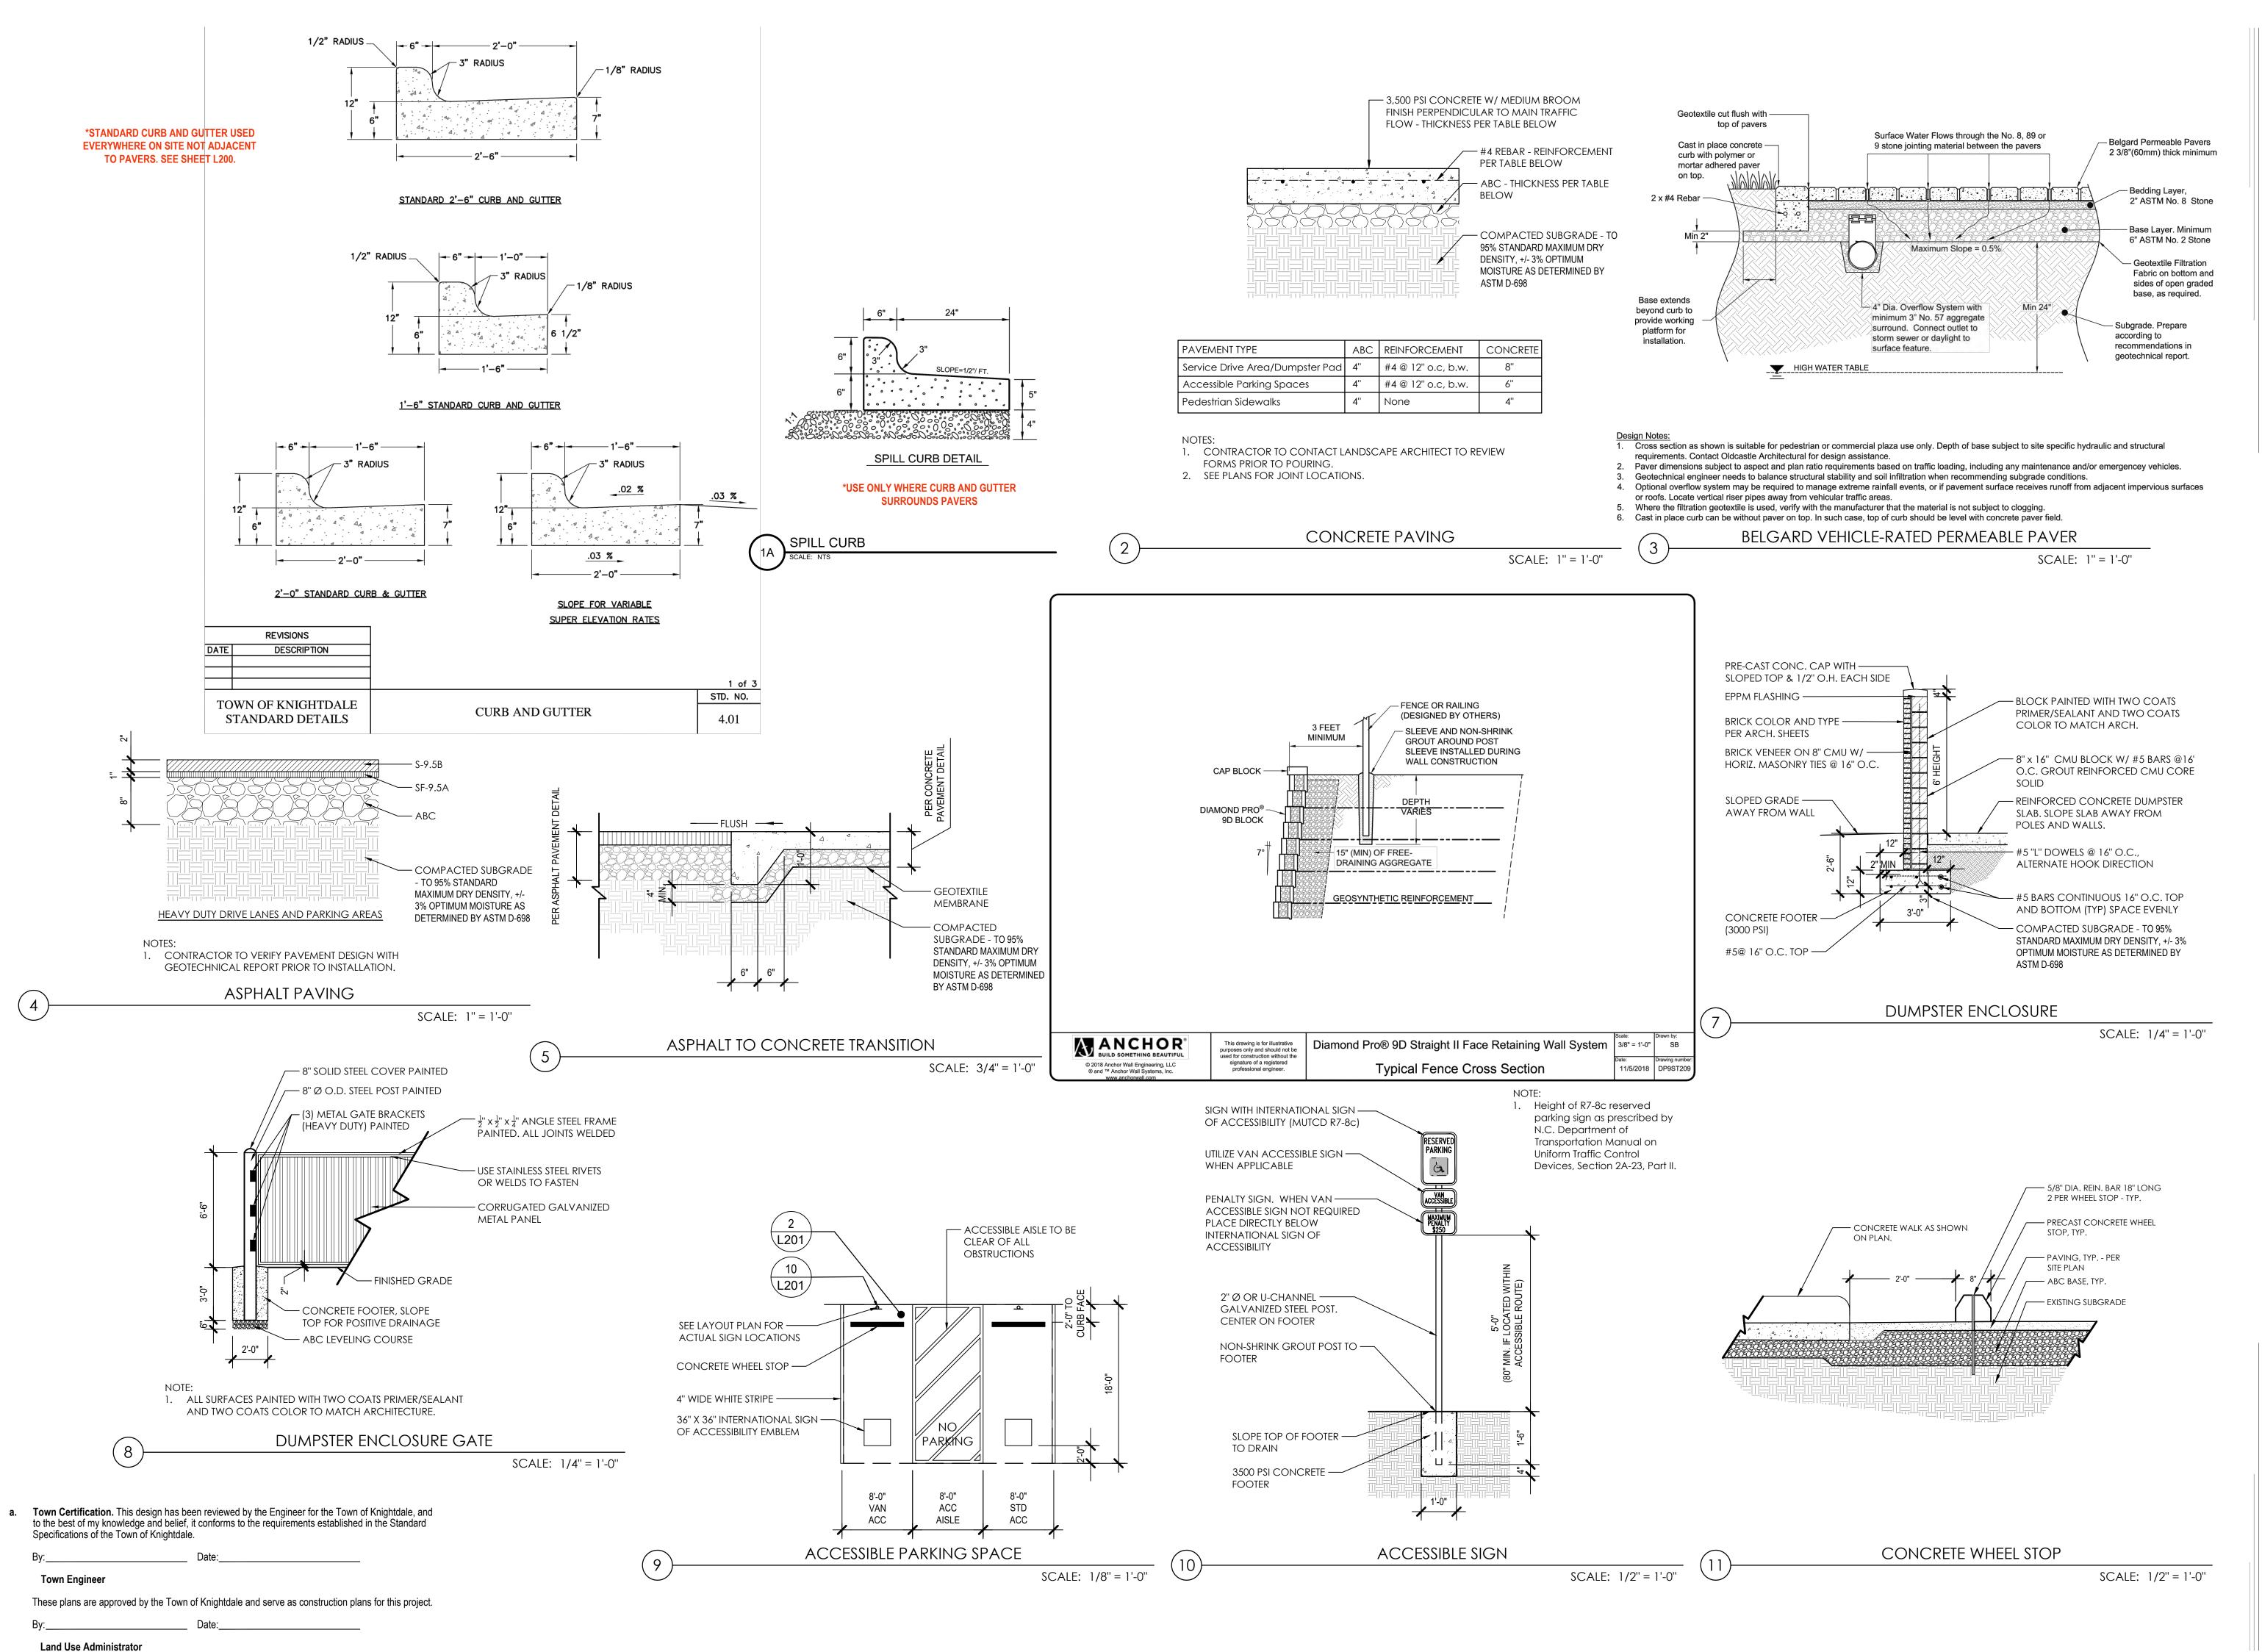

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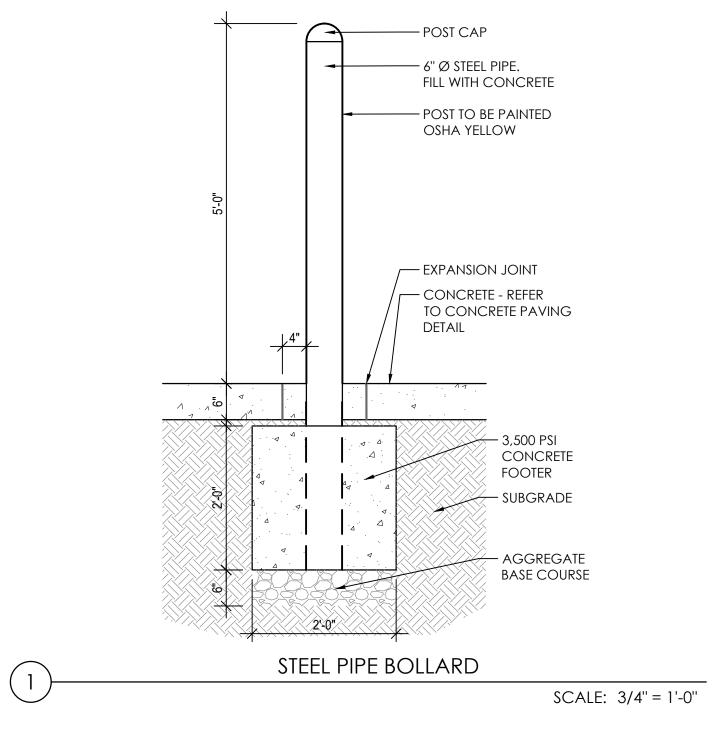
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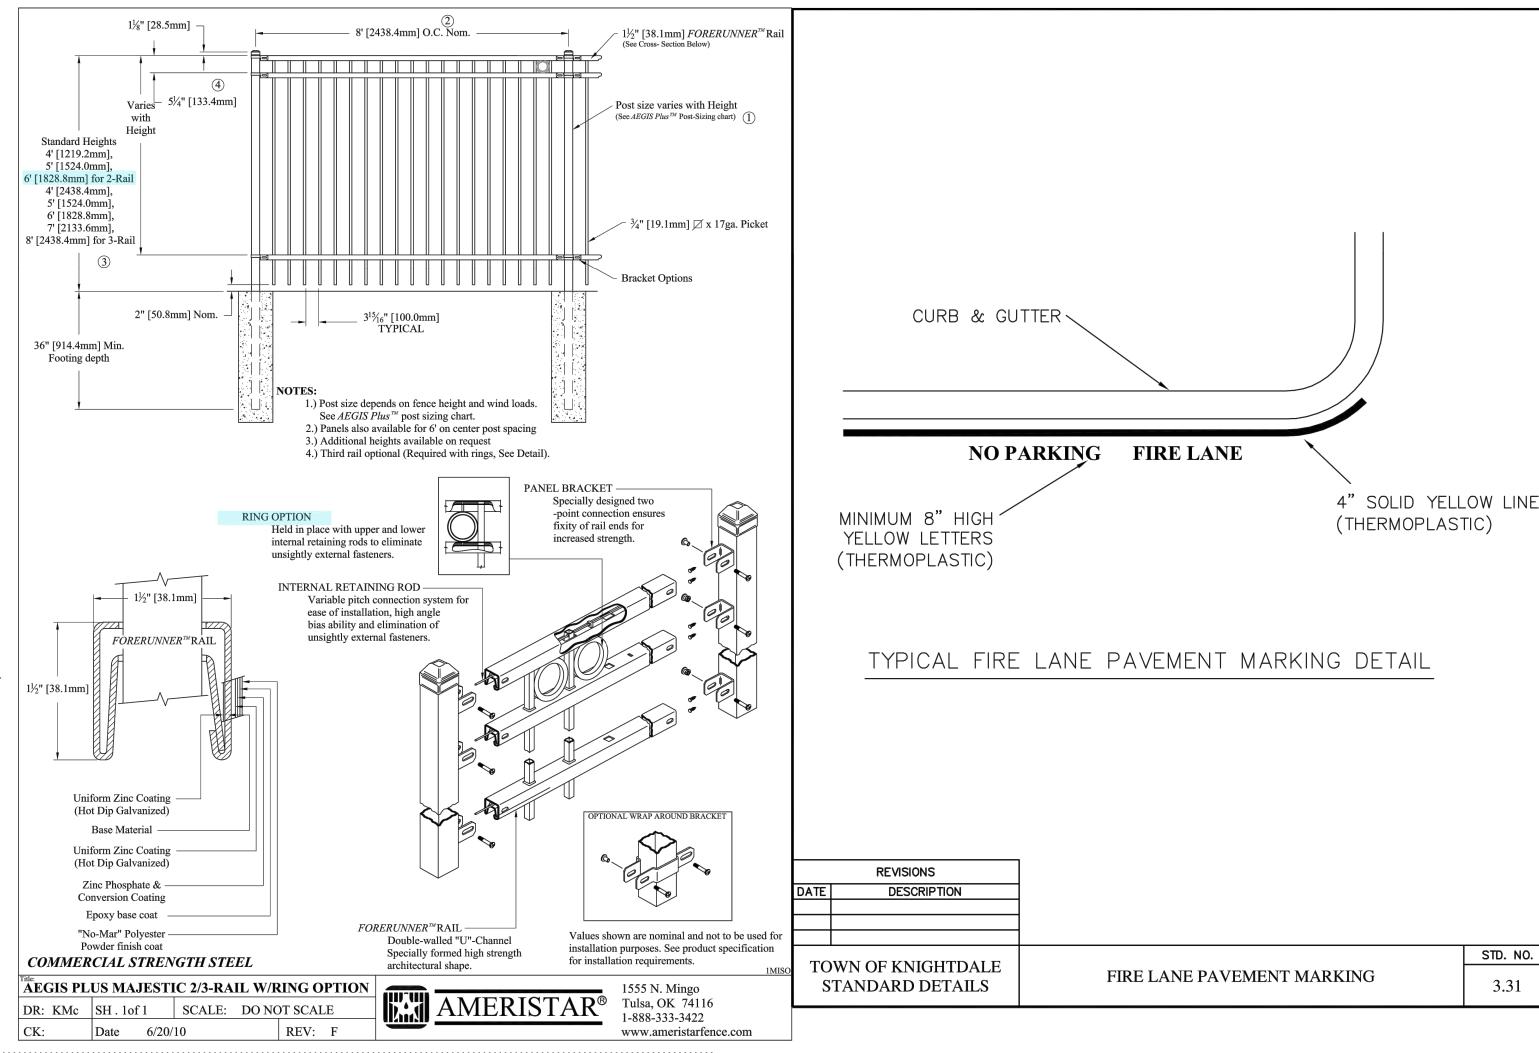
CONSTRUCTION DRAWINGS


12.14.2022

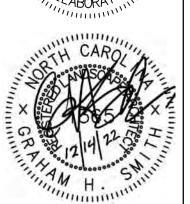
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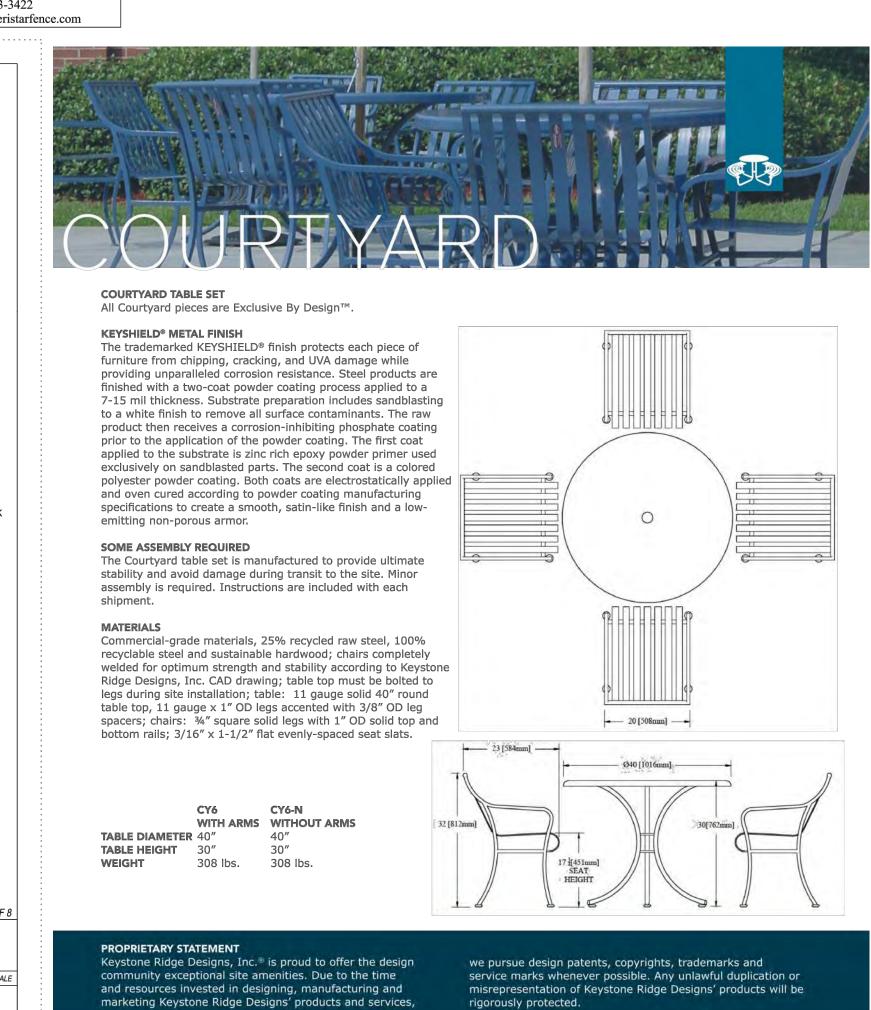
SITE DETAILS







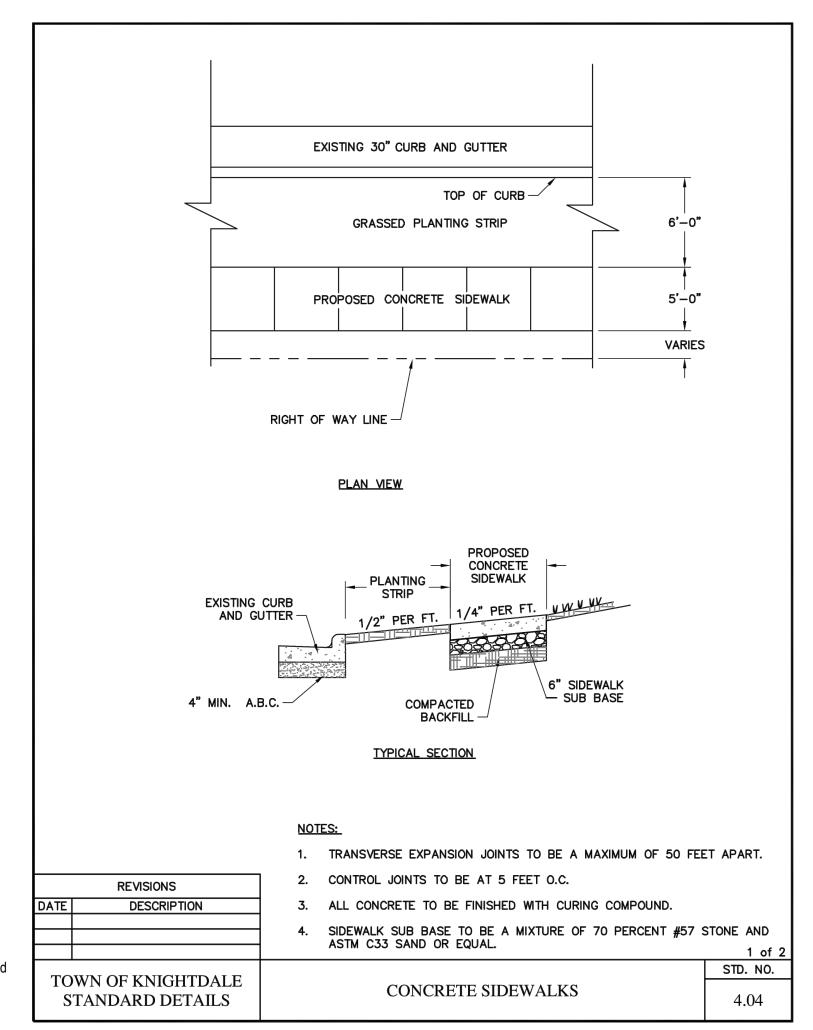

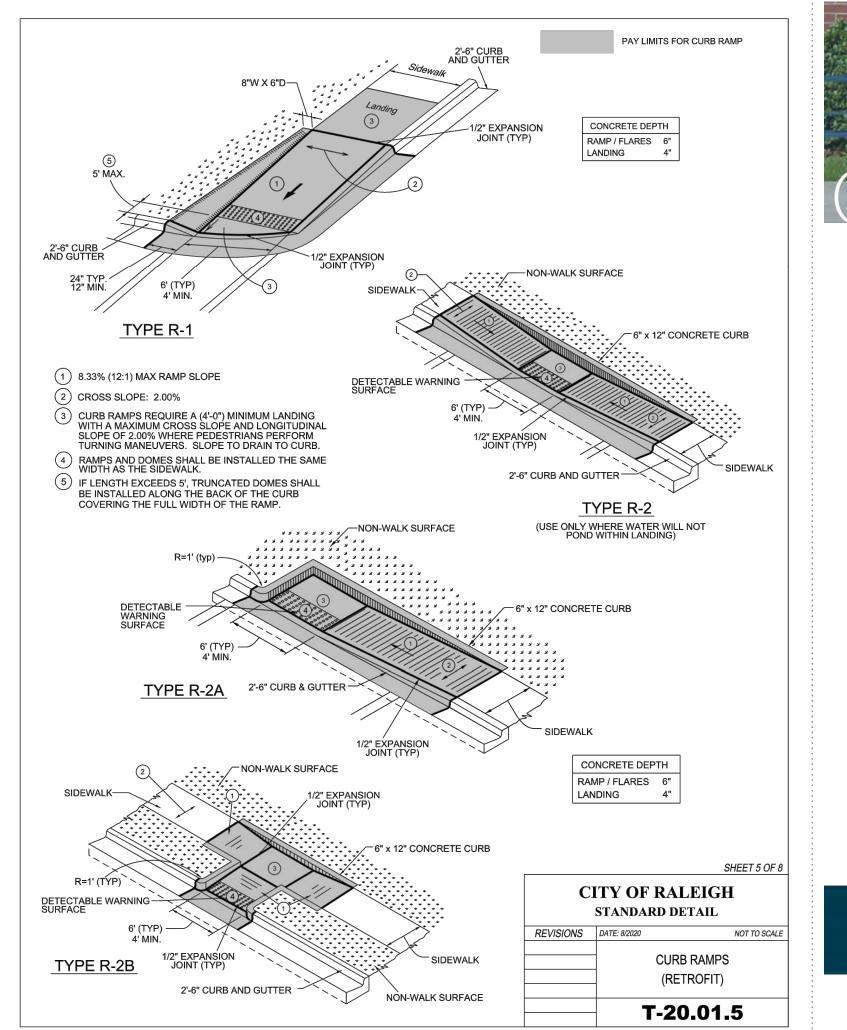


rigorously protected.

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KEYSTONE RIDG

670 Mercer Road | Butler, PA 16001-1840

www.keystoneridgedesigns.com

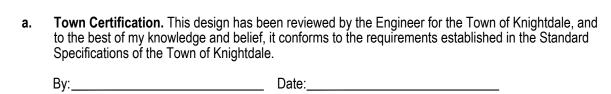


Town Engineer These plans are approved by the Town of Knightdale and serve as construction plans for this project.

Land Use Administrator

COLLABORATIVE LANDSCAPE ARCHITECTURE 821 Wake Forest Road Raleigh, NC 27604 | 919.805.3586



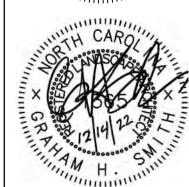

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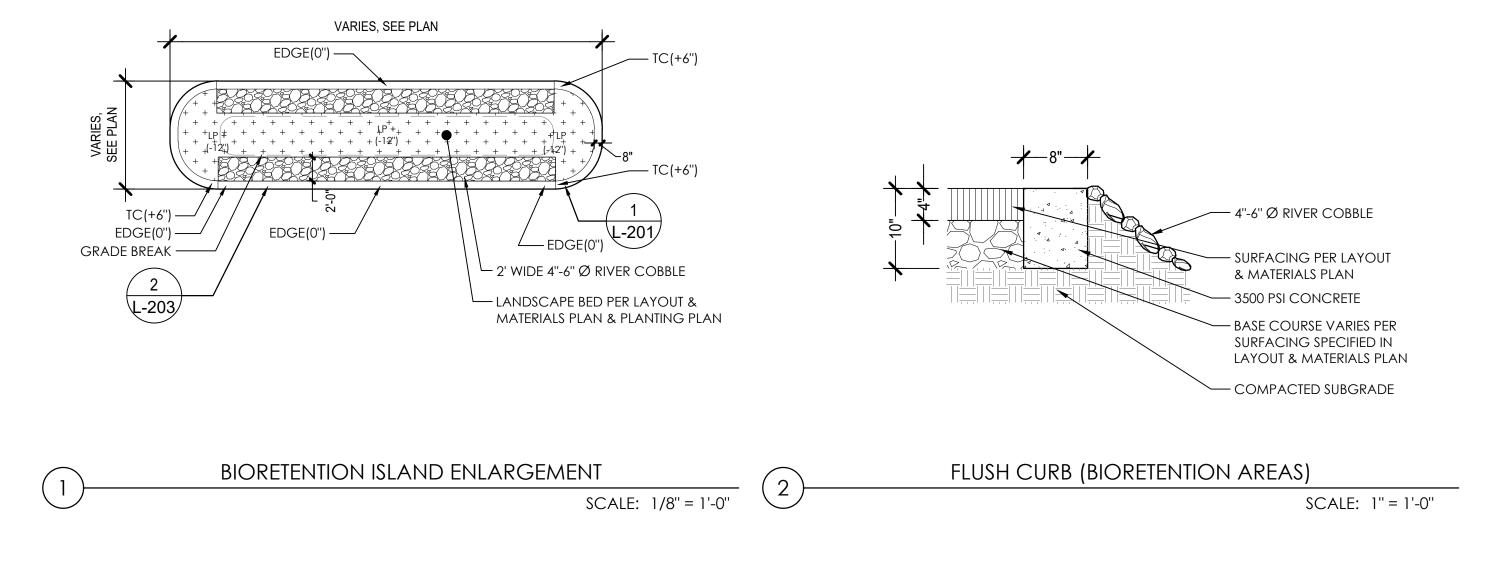
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PROJECT NUMBER: 20063 PROJECT PHASE: CONSTRUCTION DRAWINGS

12.14.2022

SIGNATURE SET

SITE DETAILS




a. Town Certification. This design has been reviewed by the Engineer for the Town of Knightdale, and to the best of my knowledge and belief, it conforms to the requirements established in the Standard Specifications of the Town of Knightdale.

These plans are approved by the Town of Knightdale and serve as construction plans for this project.

Date:____

Town Engineer

Land Use Administrator

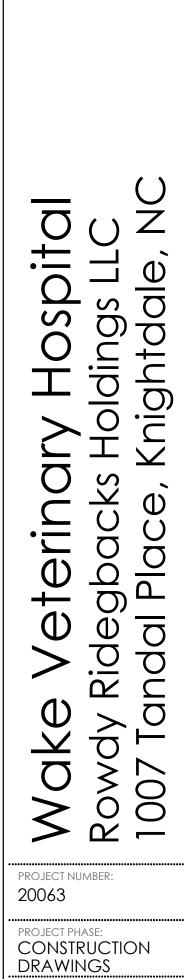

12.14.2022

SIGNATURE SET

SITE DETAILS


SHEET NUMBER:

COLLABORATIVE LANDSCAPE ARCHITECTURE

821 Wake Forest Road Raleigh, NC 27604 | 919.805.3586


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Holding Knightda erinal y Rideg Tandal Rowdy 1007 T


20063 CONSTRUCTION

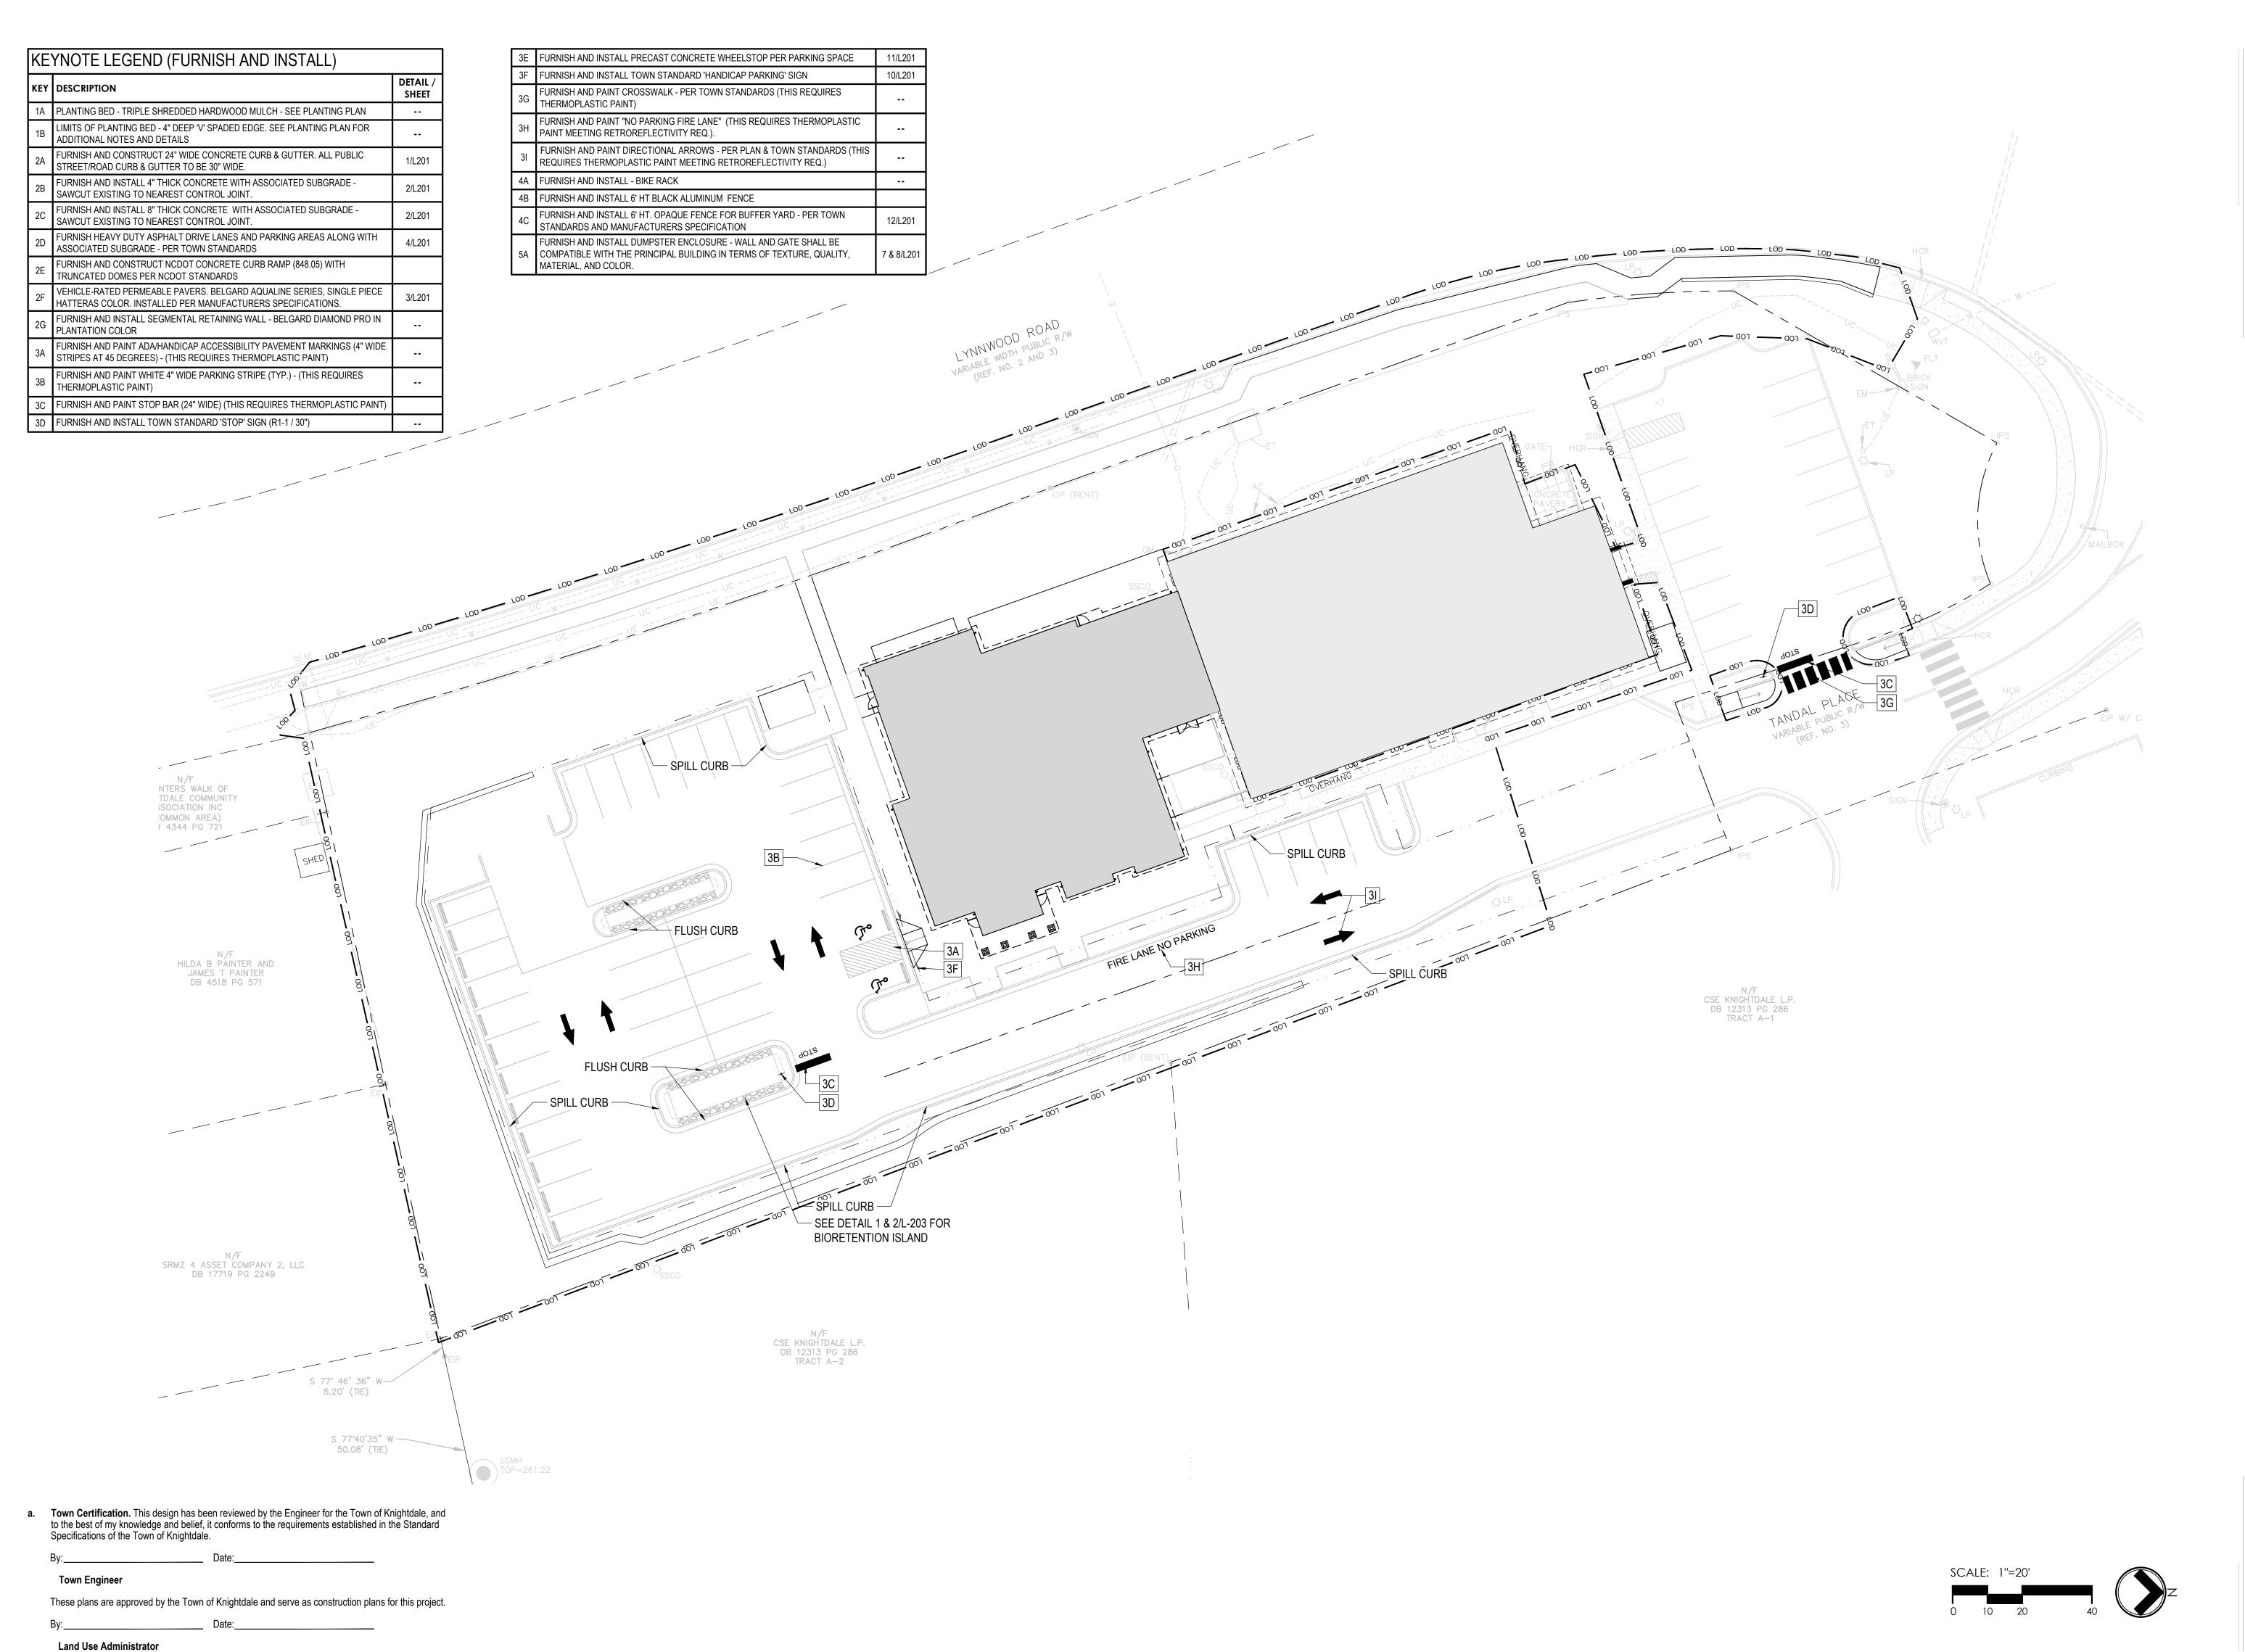DRAWINGS

12.14.2022 SIGNATURE SET

TRAFFIC SIGNS & MARKINGS

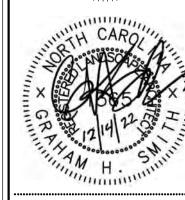PLAN

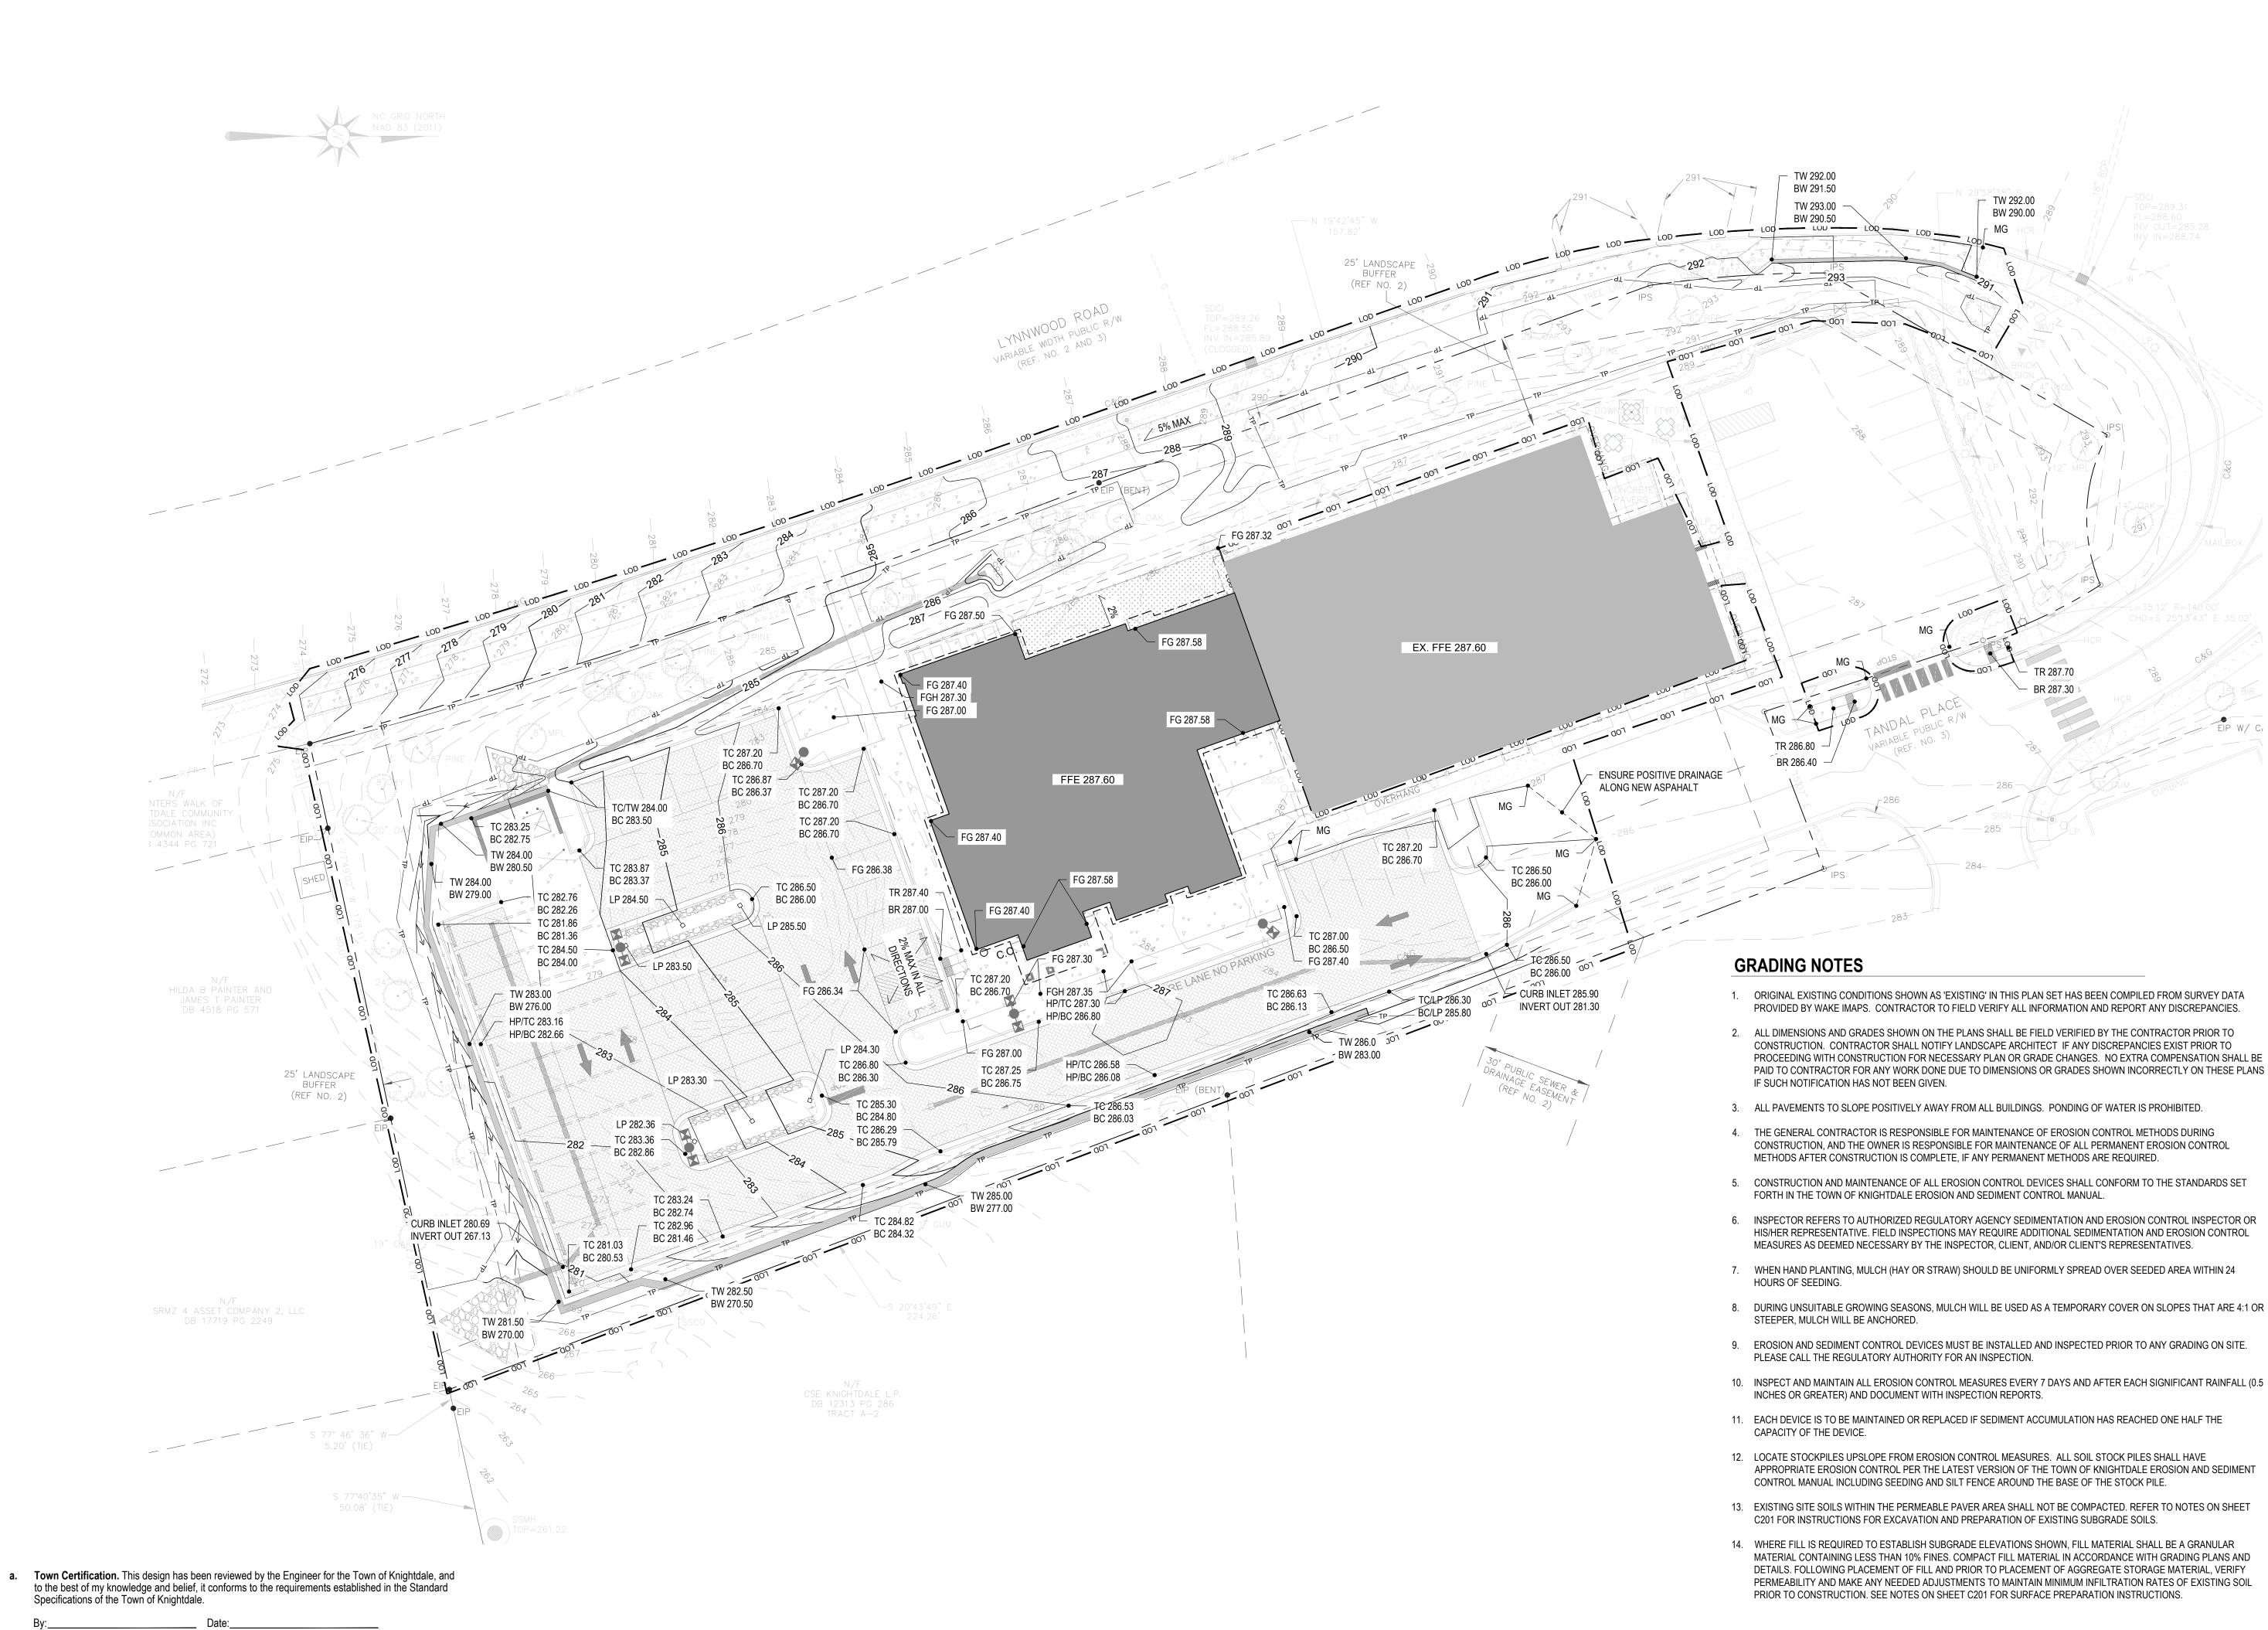

Town Engineer

Land Use Administrator

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PROJECT NUMBER:

CONSTRUCTION


DRAWINGS

12.14.2022

SIGNATURE SET

SHEET TITLE:

GRADING PLAN

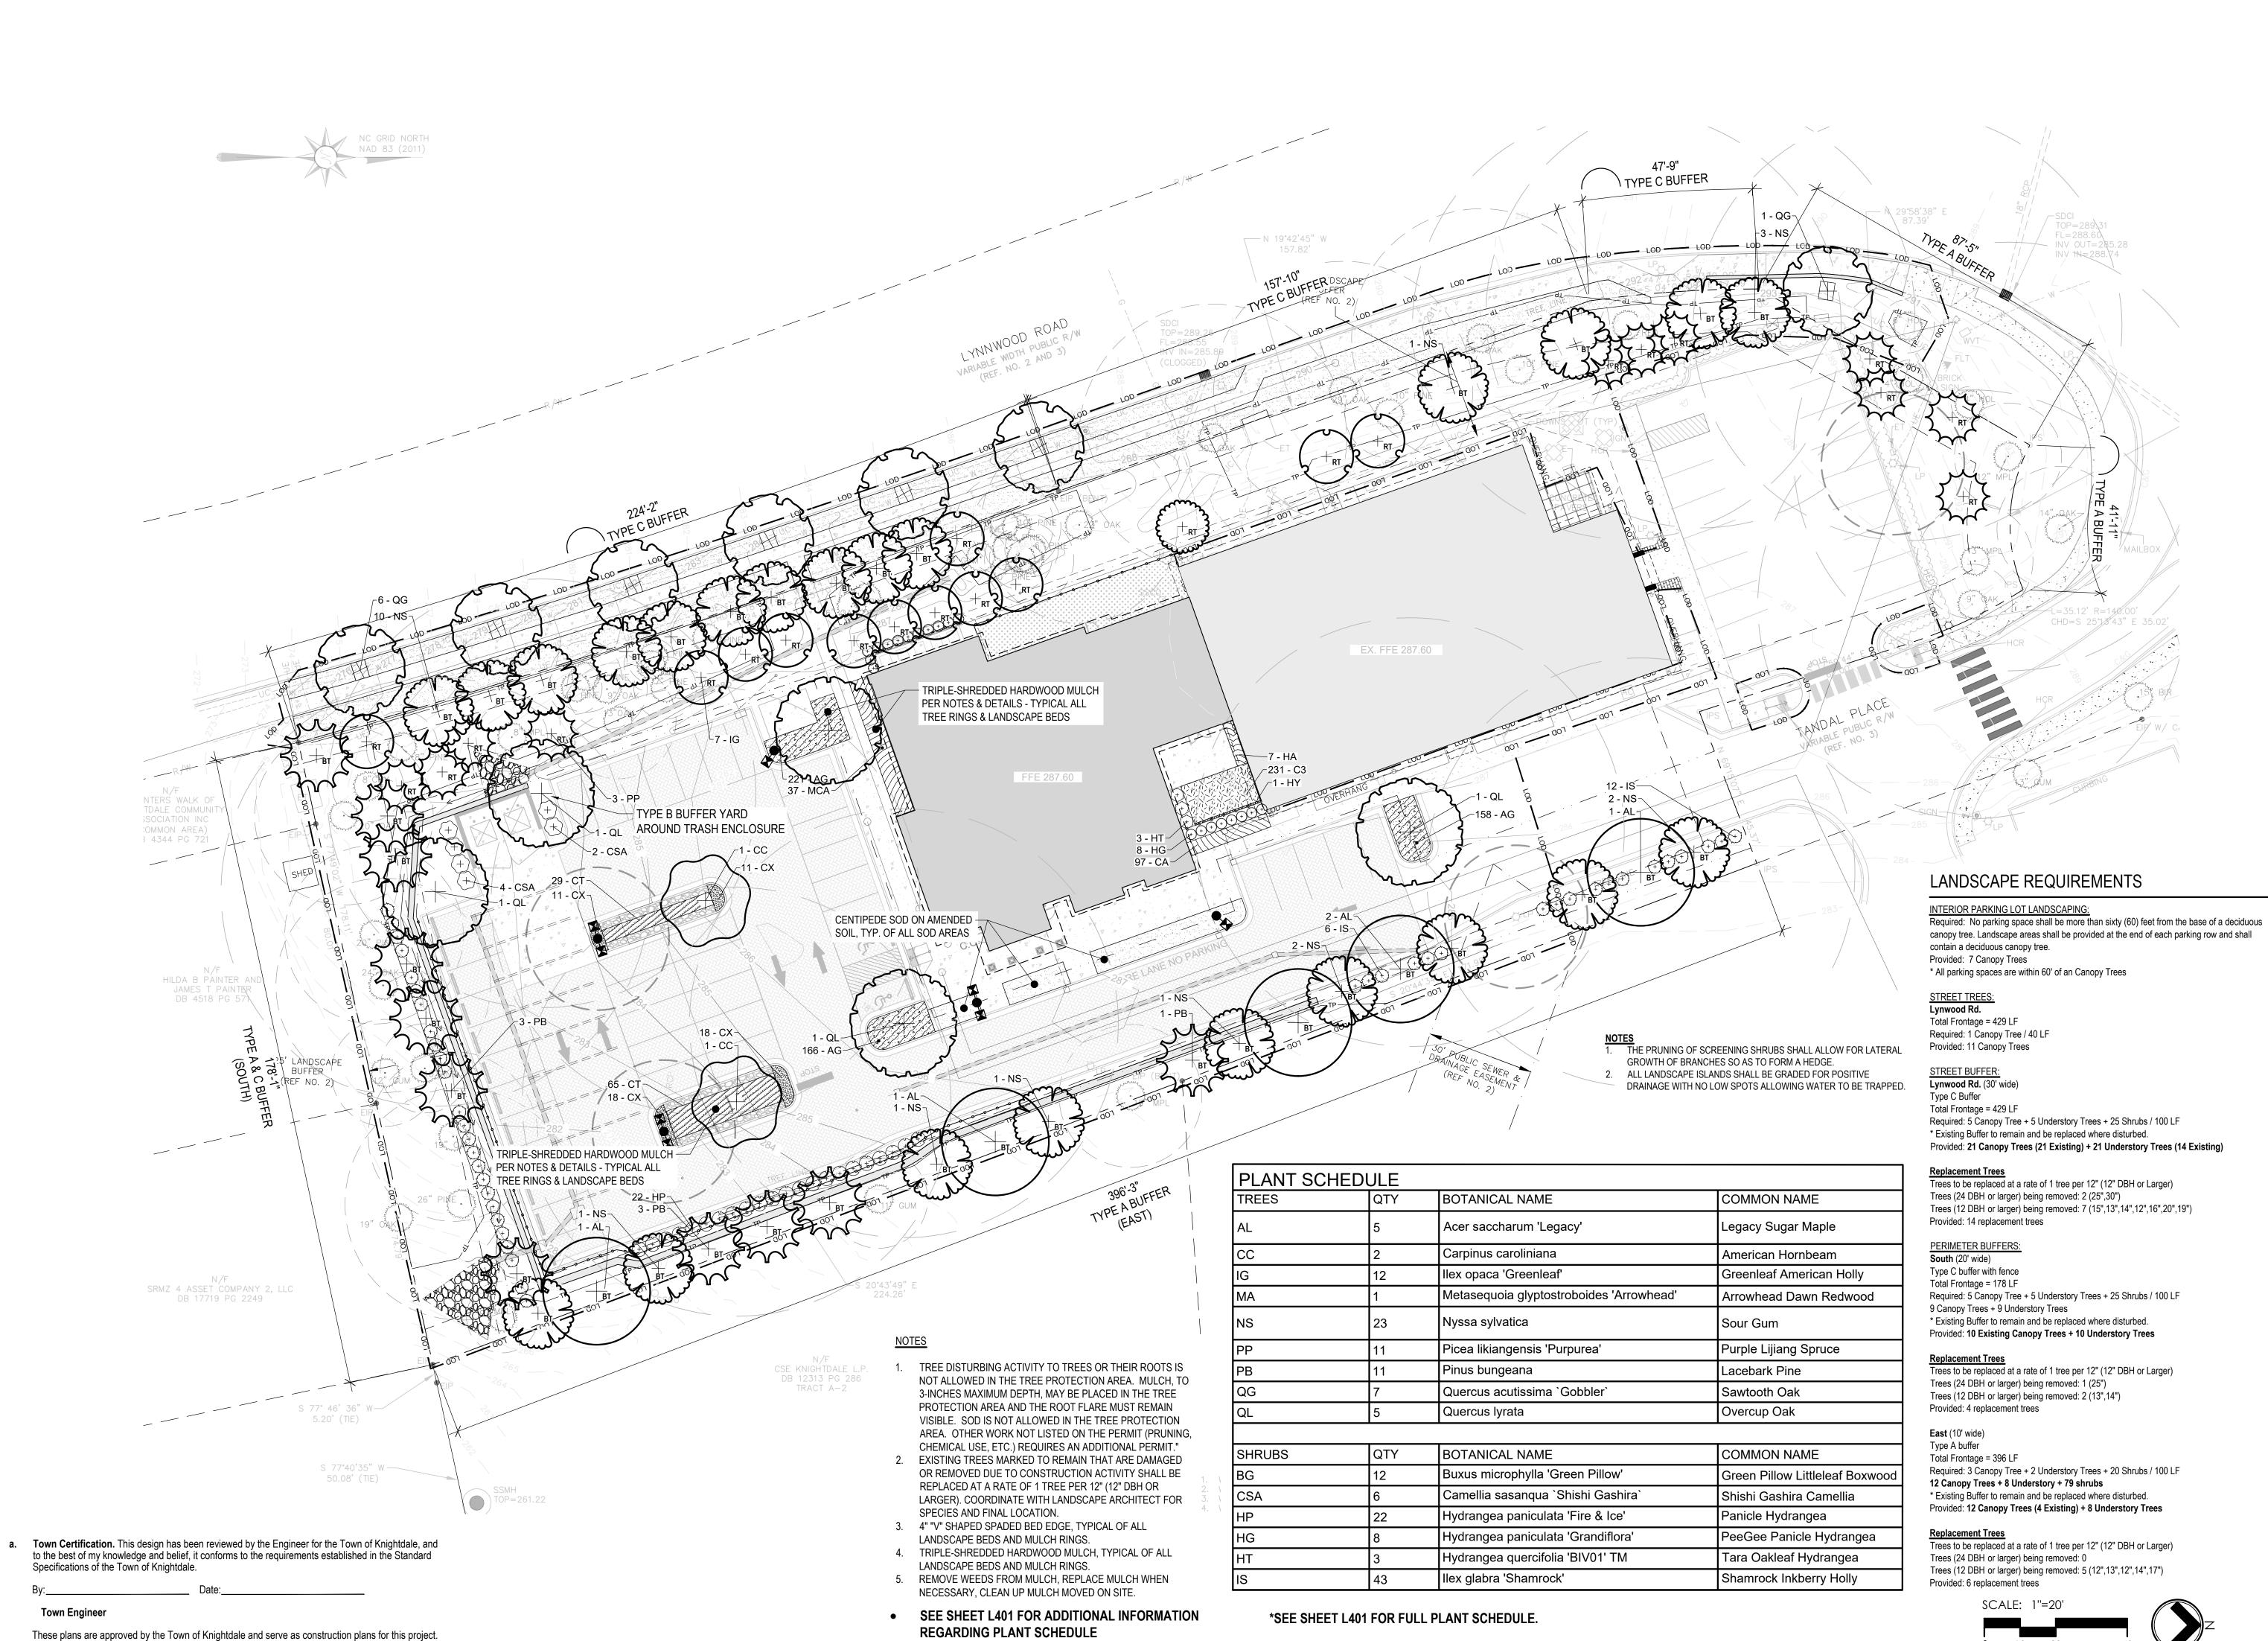


• RT = REPLACEMENT TREES (SEE PLAN)


• BT = BUFFER TREES (SEE PLAN)

Land Use Administrator

COLLABORATIVE LANDSCAPE ARCHITECTURE

821 Wake Forest Road Raleigh, NC 27604 | 919.805.3586

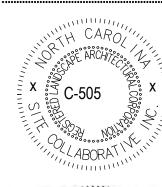

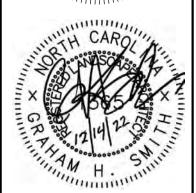

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egbacks Holdings LLC

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PROJECT NUM
20063

PROJECT PHASE: CONSTRUCTION

DRAWINGS

12.14.2022 SIGNATURE SET

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LANDSCAPE PLAN

L400

PLANTING NOTES

- 1. ROUGH GRADING TO BE COMPLETED PRIOR TO THE START OF PLANT INSTALLATION. SUBSTANTIAL COMPLETION SIGN-OFF BY LANDSCAPE ARCHITECT CONTRACTOR TO ENSURE NO CHANNELIZED FLOWS AROUND THE SITE.
- 2. CONTRACTOR RESPONSIBLE FOR LOCATING ALL UTILITIES AND UNDERGROUND IMPEDIMENTS PRIOR TO BEGINNING PLANTING.
- 3. ALL WEEDS, NON-NATIVE INVASIVE SPECIES, AND EXOTIC SPECIES LOCATED WITHIN THE PROJECT CONTRACTOR LIMITS SHALL BE ELIMINATED PRIOR TO PLANTING BED CREATION, PLANTING, AND SEEDING/SODDING OPERATIONS.
- 4. PLANTING SHOULD OCCUR IMMEDIATELY AFTER CONSTRUCTION TO STABILIZE AREAS OF BARE SOIL.
- 5. IT SHALL BE NOTED THAT ALL SECTIONS OF THE SITE THAT ARE SLOPED 3:1 OR HIGHER WILL BE COVERED WITH EROSION CONTROL STABILIZATION COIR FABRIC (WITH 1" SQUARE OPENINGS) PRIOR TO PLANTING TO ENSURE IMMEDIATE STABILIZATION. LANDSCAPE CONTRACTOR SHALL CUT FABRIC AT EACH PLANT LOCATION AND PLACE PLANTS ACCORDING TO PLAN. ALL FABRIC SHALL BE RE-STAKED PER ENGINEERS ORIGINAL DRAWINGS IMMEDIATELY AFTER PLANTING.
- 6. PLANTS ARE TO BE PURCHASED BY SCIENTIFIC NAMES. THEY SHALL BE REPRESENTATIVE OF THEIR SPECIES, MEET ALL NOTED CONDITIONS OF SPECIFICATIONS, AND SHALL BE IN VIGOROUS GROWING CONDITION MEETING ANSI STANDARD Z60.
- 7. LANDSCAPE ARCHITECT OR OWNER MAINTAINS RIGHT TO REJECT ANY PLANT DUE TO AESTHETICS OR STRUCTURAL DEFICIENCY AT ANY TIME.
- 8. CONTRACTOR RESPONSIBLE FOR FURNISHING AND INSTALLING ALL PLANTS SHOWN ON PLANS IN LOCATIONS SHOWN.
 QUANTITIES GIVEN ON THE PLANT LEGEND ARE FOR CONTRACTOR'S CONVENIENCE ONLY. IF DISCREPANCIES OCCUR,
 THE PLANS SHALL OVERRULE THE PLANT LEGEND. CONTRACTOR SHALL LOCATE ALL PLANTS AWAY FROM KNOWN
 PERMANENT FIXTURES. IF CONFLICT ARISES WITH PLAN, CONTRACTOR SHALL NOTIFY PROJECT MANAGER OR DESIGNEE
 PRIOR TO PROCEEDING.
- 9. ALL PLANT MATERIAL SHALL CONFORM TO OR EXCEED THE AMERICAN STANDARD FOR NURSERY STOCK (LATEST EDITION) AS PUBLISHED BY THE AMERICAN ASSOCIATION OF NURSERYMEN.
- 10. ALL PLANT MATERIAL SHALL BE FREE OF ALL PESTS, DISEASES, AND CANKERS, IN HEALTHY CONDITION, AND FREE OF MECHANICAL DAMAGE AT THE TIME OF PLANTING.
- 11. IT IS THE RESPONSIBILITY OF THE CONTRACTOR TO ENSURE A HEALTHY AND VIABLE PLANT AND THE PLANT SHALL BE REJECTED IF DEEMED UNHEALTHY OR UNFIT AT ANY TIME DURING THE CONTRACT OR WARRANTY DURATION.
- 12. IF ANY PLANT/MATERIAL SUBSTITUTIONS ARE REQUESTED BY CONTRACTOR, THEN NOTICE SHALL BE GIVEN TO PROJECT MANAGER OR DESIGNEE AT MINIMUM SEVENTY-TWO (72) HOURS (NOT INCLUDING WEEKENDS) PRIOR TO DESIRED ORDERING DATE/TIME. WHEN SUBSTITUTIONS ARE REQUESTED BY CONTRACTOR, SUGGESTED ACCEPTABLE REPLACEMENTS SHALL ALSO BE PRESENTED AT TIME FOR FULL AND COMPLETE REVIEW BY LANDSCAPE ARCHITECT OR OWNER.
- 13. BALLED AND BURLAPPED PLANTS/TREES TO BE PLANTED PRIOR TO CONTAINER OR BEDDING PLANTS.
- 14. BALLED AND BURLAPPED MATERIAL SHALL COMPLY WITH THE FOLLOWING GUIDELINES:
 14.1. TREES DESIGNATED B&B SHALL BE PROPERLY DUG WITH FIRM, NATURAL BALLS OF SOIL RETAINING AS MANY FIBROUS ROOTS AS POSSIBLE, IN SIZES AND SHAPES AS SPECIFIED IN THE AMERICAN STANDARD FOR NURSERY STOCK ANSI
- 14.2. ROOT BALLS SHALL BE FIRMLY WRAPPED WITH NONSYNTHETIC, ROTTABLE BURLAP AND SECURED WITH NAILS AND HEAVY, NONSYNTHETIC TWINE.
- 14.3. ROOT COLLAR SHALL BE APPARENT AT SURFACE OF BALL, OR THE CONTRACTOR WILL BE RESPONSIBLE FOR
- REMOVING EXCESS SOIL FROM THE TOP OF THE ROOTBALL.

 14.4. REMOVE ALL BURLAP, LACING, AND WIRE BASKET FROM AT LEAST THE TOP 1/2 OF THE ROOTBALL AND DISCARD FROM PLANTING HOLE.
- 14.5. DO NOT MANEUVER BY TRUNK. HANDLE BY ROOT BALL ONLY.
- 15. CONTAINERIZED PLANTS SHALL COMPLY WITH THE FOLLOWING GUIDELINES:
- 15.1. MATERIAL SHALL HAVE FIRM, NATURAL BALLS OF SOIL RETAINING AS MANY FIBROUS ROOTS AS POSSIBLE, IN SIZES AND SHAPES AS SPECIFIED IN THE AMERICAN STANDARD FOR NURSERY STOCK ANSI Z60.1
- 15.2. ROOT COLLAR SHALL BE APPARENT AT SURFACE OF BALL, OR THE CONTRACTOR WILL BE RESPONSIBLE FOR REMOVING EXCESS SOIL FROM THE TOP OF THE ROOTBALL.
- 15.3. REMOVE CONTAINER PRIOR TO PLANTING.
- 16. TREES TO BE STAKED WILL BE DESIGNATED BY THE LANDSCAPE ARCHITECT. TREE STAKING FOR CANOPY AND LARGE EVERGREEN TREES SHALL NOT EXCEED 90 DAYS.
- 17. PLANT BED PREPARATION:
 17.1. ALL PLANT BEDS ARE TO RECEIVE A MINIMUM OF 4" OF APPROVED TOPSOIL TILLED IN TO A DEPTH OF 8" TO ENSURE
- INTEGRATION WITH EXISTING SOIL.

 17.2. APPROVED TOPSOIL IS TO BE PREFERABLY FROM ON-SITE STOCKPILE FROM STRIPPING OPERATIONS SEE EROSION
- AND SEDIMENT CONTROL PLANS.

 17.3. IF ON-SITE TOPSOIL IS NOT AVAILABLE, CONTRACTOR SHALL PROVIDE TO SITE ACCORDINGLY.
- 18. ALL MULCH TO BE CERTIFIED TO BE FREE OF WEEDS, NON-NATIVE INVASIVE SPECIES AND THEIR LARVAE. MULCH SAMPLE SUBMITTAL SHALL BE PROVIDED TO LANDSCAPE ARCHITECT BEFORE SITE DELIVERY.

SEEDING/SODDING NOTES

- 1. ROUGH GRADING TO BE COMPLETED PRIOR TO THE START OF PLANT INSTALLATION. SUBSTANTIAL COMPLETION SIGN-OFF BY LANDSCAPE ARCHITECT CONTRACTOR TO ENSURE NO CHANNELIZED FLOWS AROUND THE SITE.
- 2. ALL SEEDED/SODDED AREAS SHALL BE FINISHED GRADE AT THE THICKNESS OF THE SOD.
- 3. NO SEEDED/SODDED AREAS SHALL BE SODDED UNTIL ALL OTHER CONSTRUCTION ACTIVITIES, INCLUDING PLANTING AND MULCHING HAVE OCCURRED AND LANDSCAPE ARCHITECT HAVE REVIEWED THE FINAL GRADING.
- 4. SOD AREAS WILL BE ACCEPTED WHEN IN COMPLIANCE WITH ALL THE FOLLOWING CONDITIONS: 4.1. ROOTS ARE THOROUGHLY KNIT TO THE SOIL
- 4.2. ABSENCE OF VISIBLE JOINTS
- 4.3. ALL AREAS SHOW A UNIFORM STAND OF SPECIFIED GRASS IN HEALTHY CONDITION4.4. AT LEAST 30 DAYS HAVE ELAPSED SINCE THE COMPLETION OF WORK UNDER THIS SECTION.
- 5. QUALITY GUARANTEE:
 5.1. SOD SHALL BE UNIFORM IN COLOR, LEAF TEXTURE, LEAF AND ROOD DENSITY, AND FREE FROM WEED, DISEASES, AND OTHER VISIBLE IMPERFECTIONS AT TIME OF FINAL ACCEPTANCE.
 GUARANTEE DOES NOT COVER DAMAGE AS A RESULT OF FERTILIZERS, PESTICIDES, OR OTHER APPLICATIONS NOT SUPERVISED BY THE CONTRACTOR OR AS A RESULT OF ACTS OF
- GOD OR VANDALISM.

 5.2. SEED SHALL BE UNIFORM IN COLOR, LEAF TEXTURE, LEAF AND ROOD DENSITY, AND FREE FROM WEED, DISEASES, AND OTHER VISIBLE IMPERFECTIONS AT TIME OF FINAL ACCEPTANCE. GUARANTEE DOES NOT COVER DAMAGE AS A RESULT OF FERTILIZERS, PESTICIDES, OR OTHER APPLICATIONS NOT SUPERVISED BY THE CONTRACTOR OR AS A RESULT OF ACTS OF GOD OR VANDALISM.
- 6. CONTRACTOR SHALL BE RESPONSIBLE FOR ENSURING THAT THE SEED/SOD IS PROPERLY IRRIGATED DURING THE GROW-IN PERIOD AND SHALL BE RESPONSIBLE IF THE SOD SUFFERS IRREPARABLE HARM.
- 7. SEED/SOD IS SUBJECT TO INSPECTION AND ACCEPTANCE. LANDSCAPE ARCHITECT AND/OR CLIENT RESERVES THE RIGHT TO REJECT AT ANY TIME OR PLACE PRIOR TO ACCEPTANCE, ANY WORK AND SOD WHICH IN THE LANDSCAPE ARCHITECTS OPINION FAILS TO MEET THESE SPECIFICATIONS REQUIREMENTS.

8. SOD STANDARDS:


- 8.1. GENERAL: HEALTHY, THICK TURF HAVING UNDERGONE A PROGRAM OF REGULAR FERTILIZATION, MOWING AND WEED CONTROL; FREE OF OBJECTABLE WEEDS; UNIFORM IN GREEN COLOR, LEAF TEXTURE AND DENSITY; HEALTHY, VIGOROUS ROOT SYSTEM; INSPECTED AND FOUND FREE OF DISEASE, NEMATODES, PEST AND PEST LARVAE BY THE ENTOMOLOGIST OF THE STATE DEPARTMENT OF AGRICULTURE.
- 8.2. EACH PIECE OF SOD: SANDY-LOAM SOIL BASE THAT WILL NOT BREAK, CRUMBLE OR TEAR DURING SOD INSTALLATION.
- 8.3. THICKNESS: MINIMUM 3/4" THICK, EXCLUDING THE TOP GROWTH THATCH.
- 8.4. THATCH: NOT TO EXCEED 1/2" UNCOMPRESSED.
- 8.5. SIZE: CUT IN STRIPS 18" WIDE NO MORE THAN 24 HOURS PRIOR TO DELIVERY.
- 9. SOD DELIVERY, STORAGE AND HANDLING GUIDELINES ARE AS FOLLOWS:
- 9.1. SOD SHALL BE DELIVERED ON PALLETS PROPERLY LOADED ON VEHICLES AND WITH ROOT SYSTEM PROTECTED FROM EXPOSURE TO SUN, WIND, AND HEAT IN ACCORDANCE WITH STANDARD PRACTICE AND LABELED WITH BOTANICAL AND COMMON NAME OF EACH GRASS SPECIES IN ACCORDANCE WITH FEDERAL SEED ACT. SOD THAT HAS BEEN DAMAGED BY POOR HANDLING OR IMPROPER STORAGE IS SUBJECT TO REJECTION BY THE LANDSCAPE ARCHITECT OR OWNER.
- 9.1.1. PROTECT FROM DEHYDRATION, CONTAMINATION, FREEZING AND HEATING AT ALL TIMES. KEEP STORED SOD MOIST AND UNDER SHADE OR COVERED WITH MOISTENED BURLAP.
- 9.1.2. DO NOT DROP SOD ROLLS FROM CARTS, TRUCKS OR PALLETS.
- 9.1.3. DO NOT DELIVER MORE SOD THAN CAN BE INSTALLED WITHIN 36 HOURS.
- 9.1.4. DO NOT STACK SOD MORE THAN 2 FEET DEEP.


PLANT SCHED	ULE							
TREES	QTY	BOTANICAL NAME	COMMON NAME	HEIGHT	CALIPER	B&B OR CONT.		REMARKS
AL	5	Acer saccharum 'Legacy'	Legacy Sugar Maple	10`-12`	3"-3 1/2"	B&B		Strong, Central Leader Buffer & Canopy Tree
CC	2	Carpinus caroliniana	American Hornbeam	8`-10`	2"	B & B		Strong central leader Parking Lot
G	12	llex opaca 'Greenleaf'	Greenleaf American Holly	6`-7`	2 1/2"	B & B		Replacement Tree
MA	1	Metasequoia glyptostroboides 'Arrowhead'	Arrowhead Dawn Redwood	6`-7`	1 1/2"-2"	B & B		Replacement Tree
NS	23	Nyssa sylvatica	Sour Gum	10`-12`	3"	В & В		Strong central leader Buffer & Understory Tree
PP	11	Picea likiangensis 'Purpurea'	Purple Lijiang Spruce	6`-8`	2 1/2"	B & B		Replacement Tree
PB	11	Pinus bungeana	Lacebark Pine	6`-7`	2"	B & B		Replacement Tree
QG	7	Quercus acutissima `Gobbler`	Sawtooth Oak	10`-12`	3"-3 1/2"	CONTAINER		Strong, Central Leader Street Tree
QL	5	Quercus lyrata	Overcup Oak	10`-12`	3"	B & B		Strong central leader Parking Lot
	•		•	•	•		•	
SHRUBS	QTY	BOTANICAL NAME	COMMON NAME	HEIGHT	WIDTH	CONT.		REMARKS
3G	12	Buxus microphylla 'Green Pillow'	Green Pillow Littleleaf Boxwood	12"	2`			
CSA	6	Camellia sasanqua `Shishi Gashira`	Shishi Gashira Camellia	Container	36" HT			Full, Dense
HP	22	Hydrangea paniculata 'Fire & Ice'	Panicle Hydrangea	6" MIN.				
HG	8	Hydrangea paniculata 'Grandiflora'	PeeGee Panicle Hydrangea	12"	18"			
HT	3	Hydrangea quercifolia 'BIV01' TM	Tara Oakleaf Hydrangea	24"	24"	CONTAINER		
IS	43	llex glabra 'Shamrock'	Shamrock Inkberry Holly	18"	18"			
	•		•		•	•	•	•
GROUND COVERS	QTY	BOTANICAL NAME	COMMON NAME	HEIGHT	SPREAD	CONT. SIZE	SPACING	REMARKS
AG	545	Acorus gramineus 'Ogon'	Golden Variegated Sweetflag	4"pot	8"		12" o.c.	
CX	58	Carex amphibola	Creek Sedge	6"	8"	6" POT	18" o.c.	
CA	97	Carex appalachica	Appalachian Sedge			FLAT	12" o.c.	
C3	231	Carex eburnea	Bristleleaf Sedge	flat	4"	4" POT	12" o.c.	
CT	94	Carex stricta	Tussock Sedge	12"	12"	1 GAL.	24" o.c.	
CE2	4,832 sf	Cynodon dactylon x transvaalensis `DT-1` TM	TifTuf Bermuda Grass			Seed		
HA .	7	Hosta x tardiana 'Halcyon'	Halcyon Hosta	6"	12"		30" o.c.	
MCA	37	Muhlenbergia capillaris	Pink Muhly	1 gal			30" o.c.	
VINE	QTY	BOTANICAL NAME	COMMON NAME	HEIGHT	SPREAD	CONT. SIZE	SPACING	REMARKS
HY	1	Hydrangea anomala petiolaris	Climbing Hydrangea	6" PLUG		LANDSCAPE PLUG	60" o.c.	

a.	Town Certification. This design has been reviewed by the Engineer for the Town of Knightdale, and
	to the best of my knowledge and belief, it conforms to the requirements established in the Standard
	Specifications of the Town of Knightdale.

Ву:	Date:
Town Engineer	
These plans are approved by the Town	of Knightdale and serve as construction plans for this proj
D	Deter


Land Use Administrator

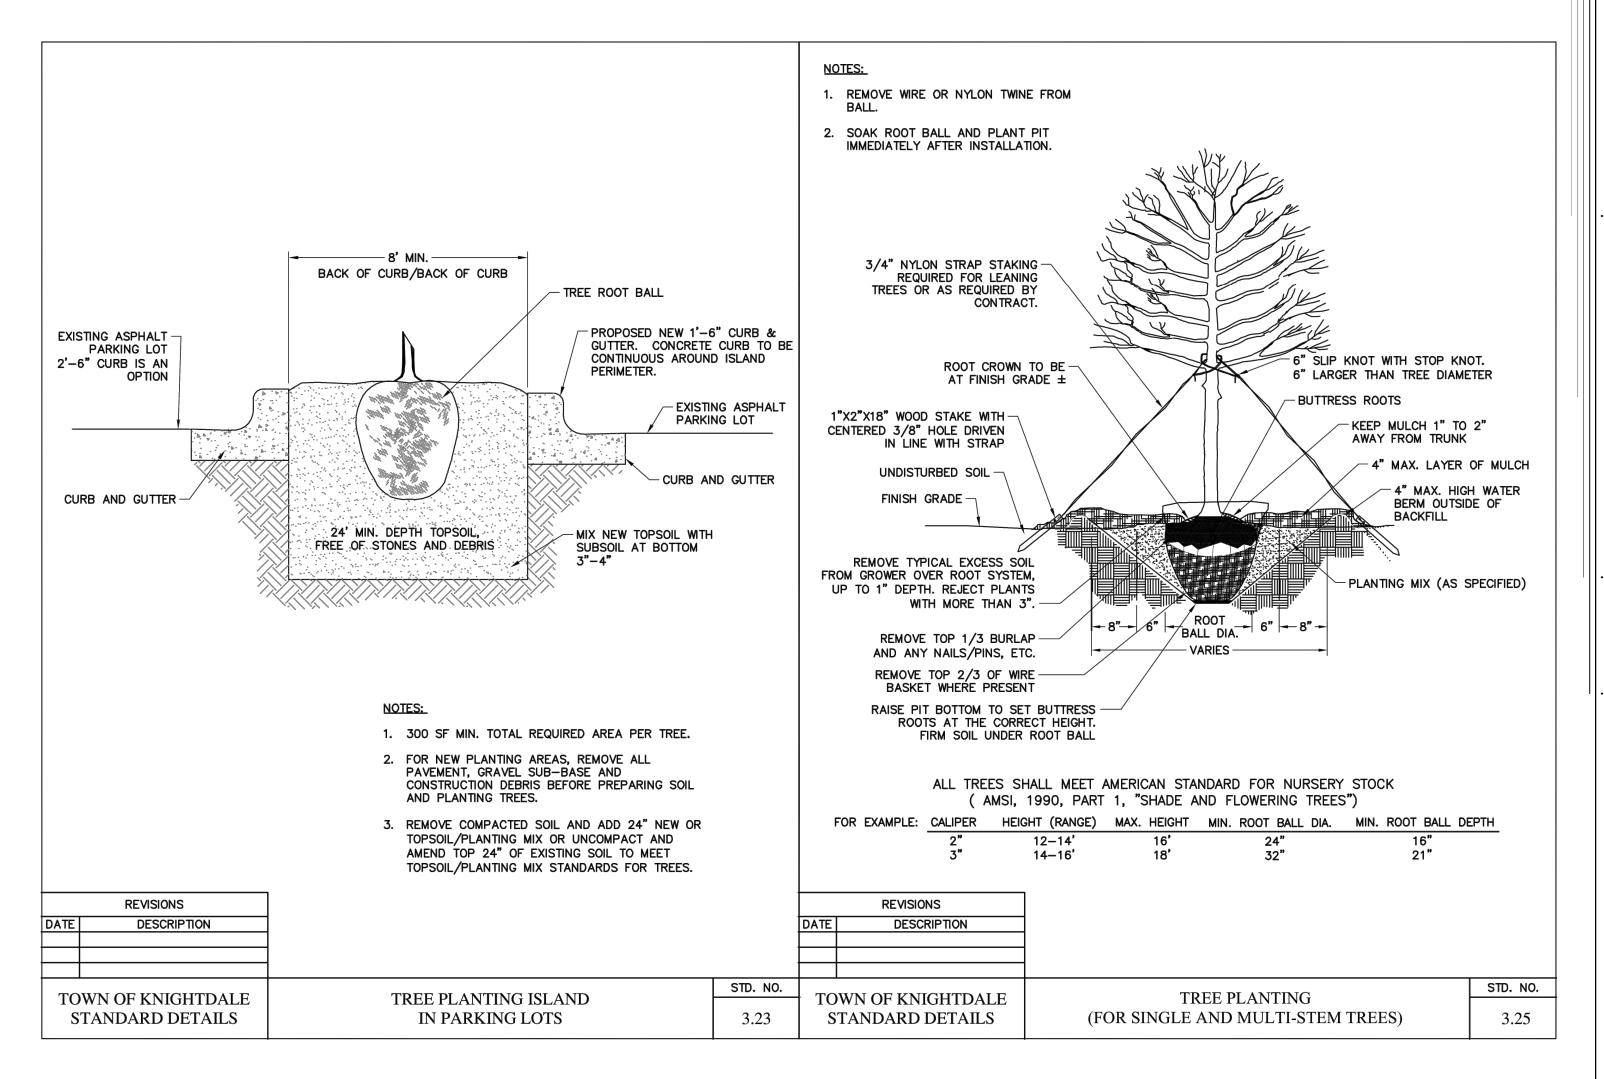

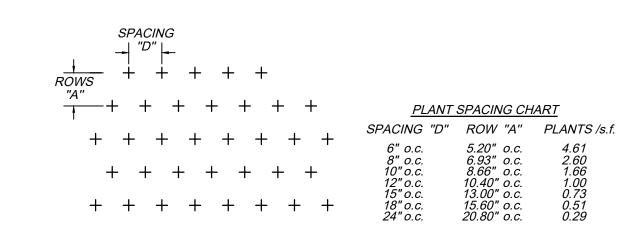

TRIANGULAR SPACING FOR GROUNDCOVERS

SCALE: NTS

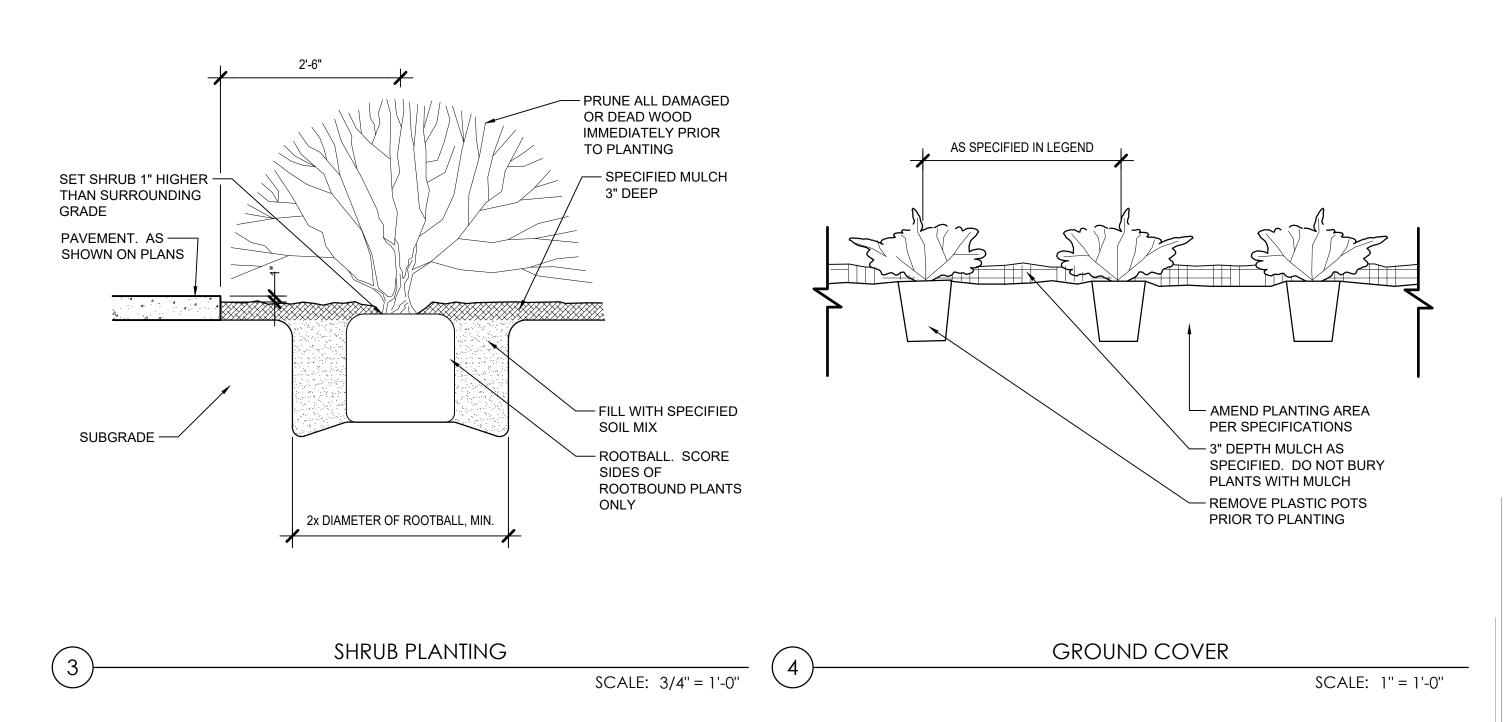



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Wake Veterinary Hospital
Rowdy Ridegbacks Holdings LLC
1007 Tandal Place, Knightdale, NC

PROJECT PHASE:
CONSTRUCTION
DRAWINGS

DATE:
12.14.2022

SIGNATURE SET

SHEET TITLE:


PLANTING

NOTES &

DETAILS

SHEET NUMBER:

L401

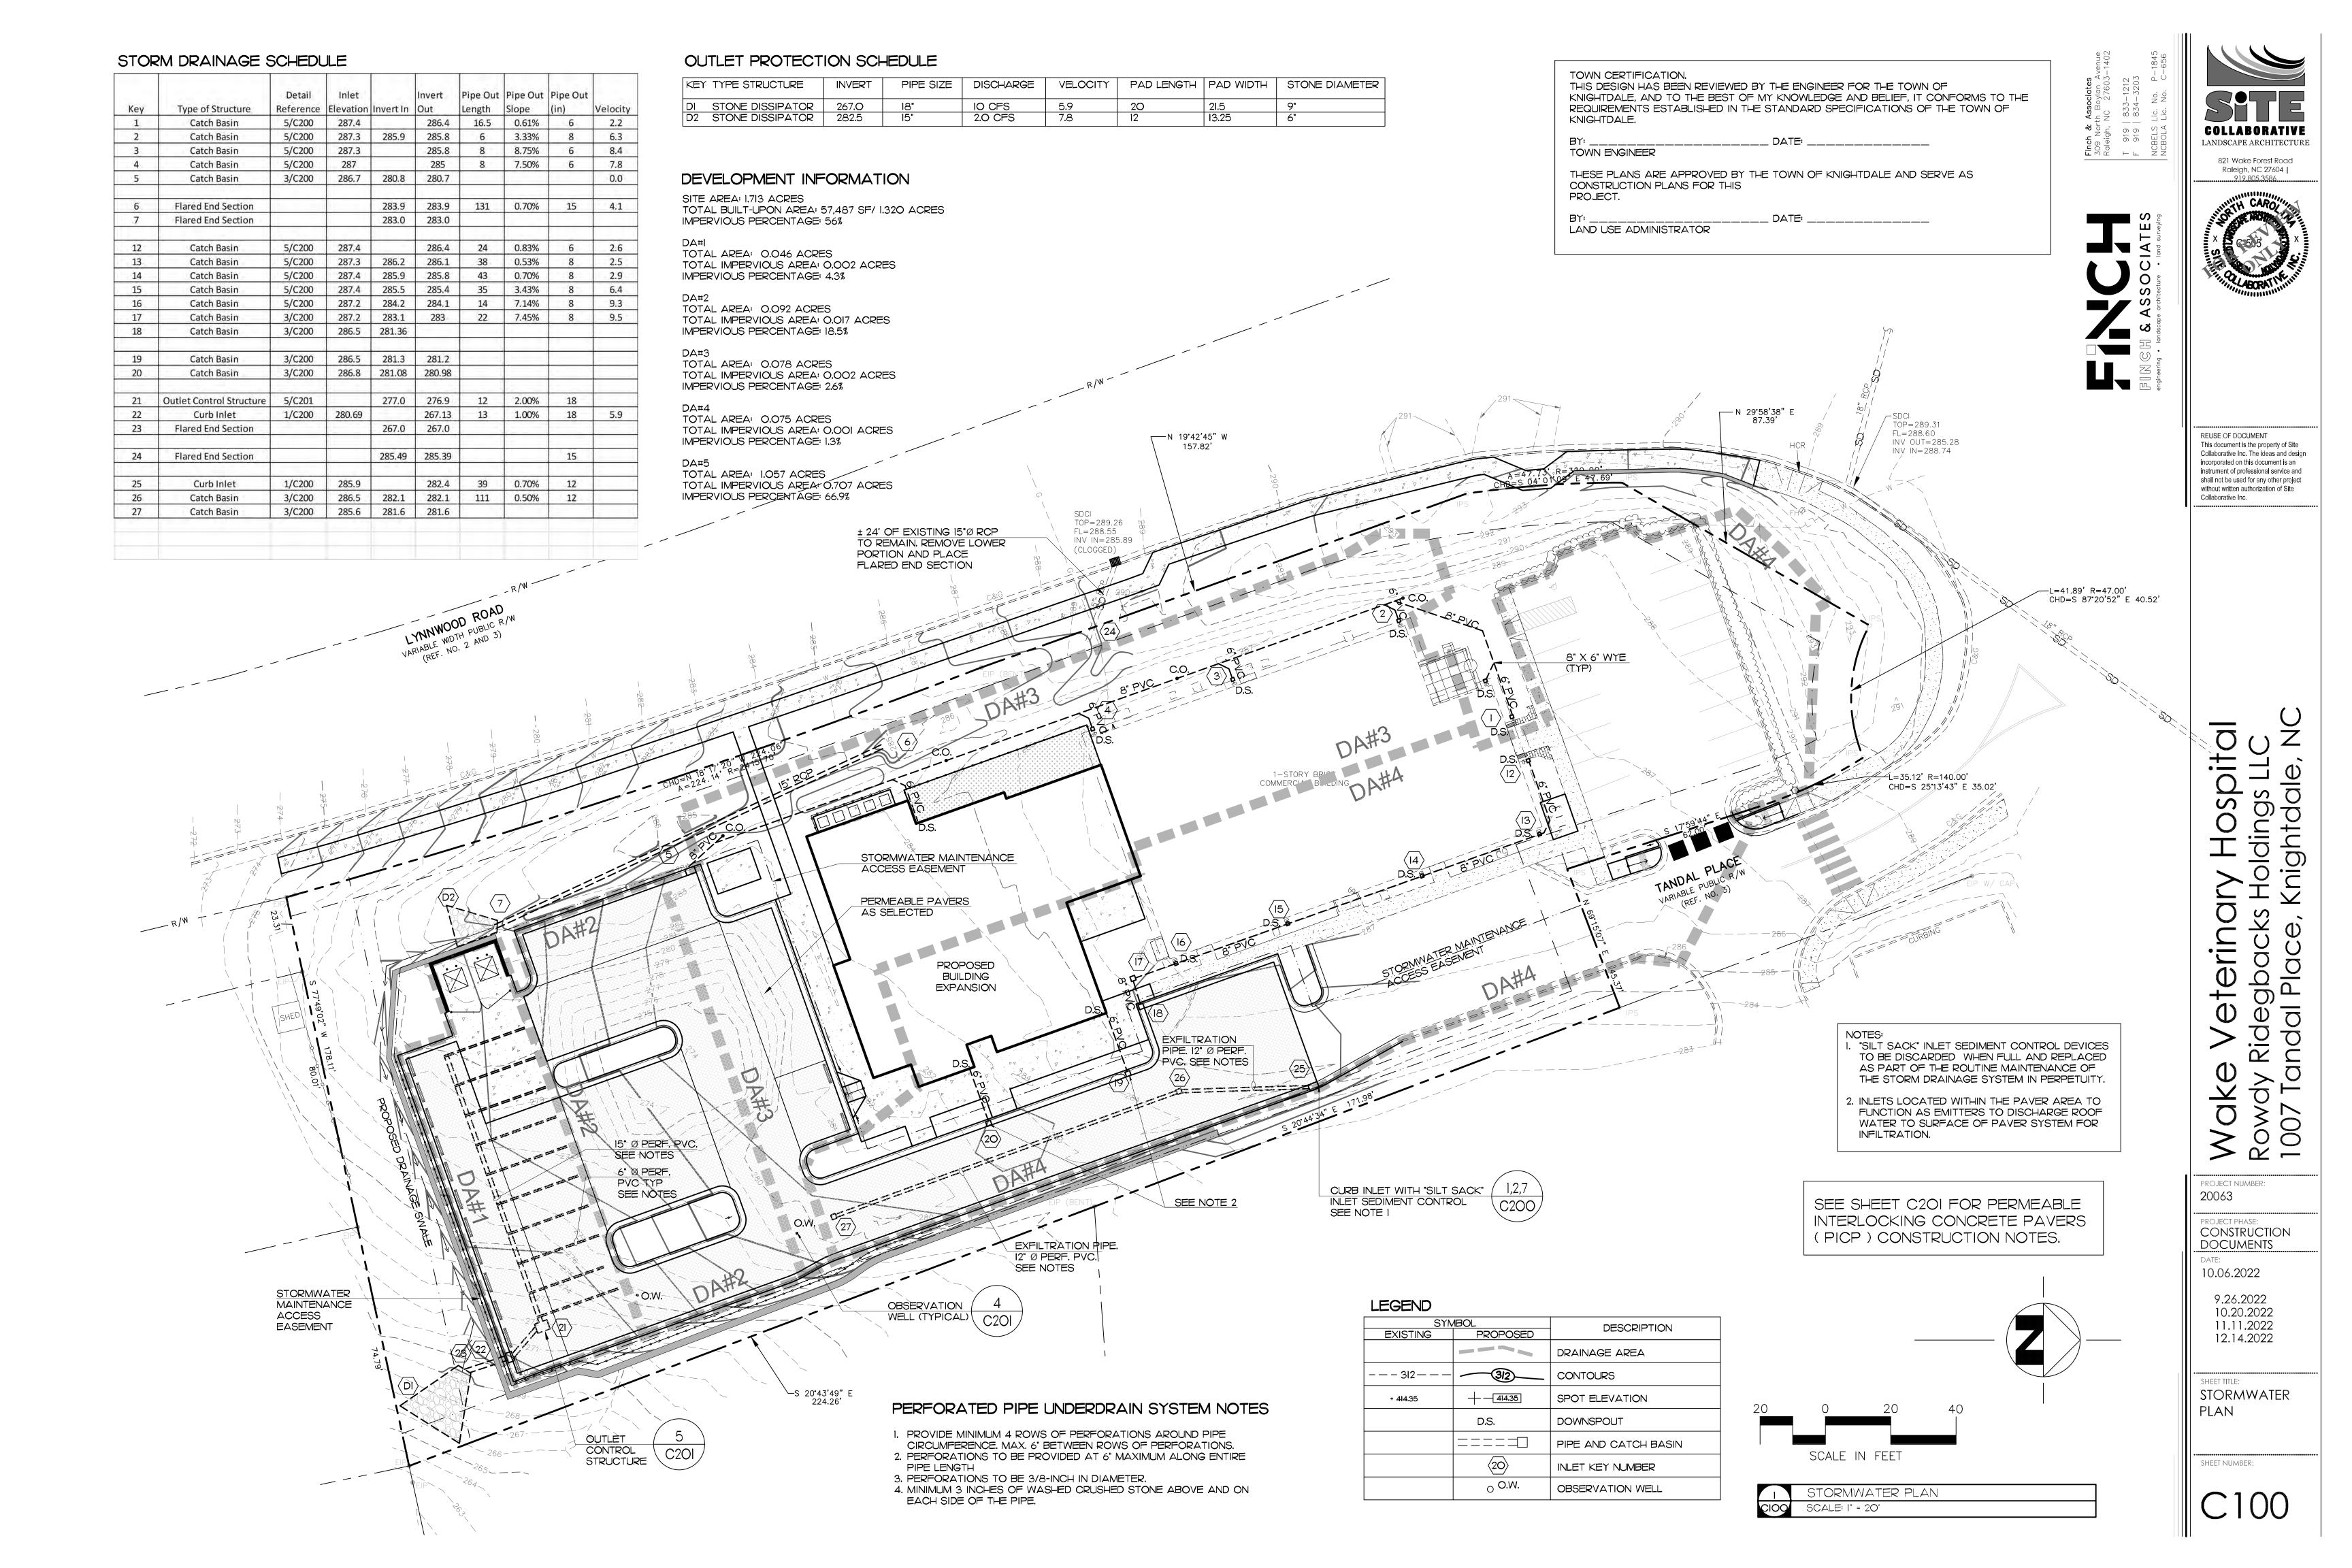

1) PLANIMETRIC INFORMATION SHOWN HEREIN IS TAKEN FROM A FIELD SURVEY BY FINCH AND ASSOCIATES.


3) LOCATIONS FOR EXISTING UTILITIES SHOWN ON THESE PLANS ARE APPROXIMATE ONLY. CONTRACTOR SHALL VERIFY THE LOCATIONS OF ALL UTILITIES AND SHALL BE RESPONSIBLE FOR ANY DAMAGE TO SAME. PRIOR TO ANY TRENCHING OR EXCAVATION, CONTRACTOR SHALL NOTIFY THE OWNER'S REPRESENTATIVE TO

4) CONTRACTOR SHALL AT ALL TIMES MAINTAIN ADEQUATE SAFETY MEASURES, ACTIVITIES, AND BARRICADES FOR THE PROTECTION OF ALL PERSONS ON OR ABOUT THE SITE. ALL CONSTRUCTION OPERATIONS SHALL BE ACCOMPLISHED IN ACCORDANCE WITH APPLICABLE REGULATIONS OF THE OCCUPATIONAL SAFETY AND HEALTH DIVISION OF THE NORTH CAROLINA DEPARTMENT OF LABOR. COPIES OF THE APPLICABLE REGULATIONS MAY BE OBTAINED FROM THE NORTH CAROLINA DEPARTMENT OF LABOR, OCCUPATIONAL HEALTH AND SAFETY DIVISION, 413 NORTH SALISBURY STREET, RALEIGH, NORTH CAROLINA. CONTRACTOR SHALL BE RESPONSIBLE FOR THE DESIGN OF ADEQUATE SHORING AND BRACING IN ALL TRENCHES BE RESPONSIBLE FOR INSTALLATION AND MAINTENANCE OF ADEQUATE SHORING AND BRACING, AND THE AND EXCAVATIONS THAT ARE A PART OF THE CONSTRUCTION OPERATIONS OF THIS PROJECT. CONTRACTOR SHALL PROTECTION OF ALL PERSONS AND PROPERTY ON OR ABOUT THE CONSTRUCTION SITE.

6) EXISTING SITE SOILS WITHIN THE PERMEABLE PAVER AREA SHALL NOT BE COMPACTED. REFER TO NOTES ON

7) EXCAVATED MATERIAL FROM THE SITE SHALL NOT BE USED AS FILL IN THE AREA OF THE

8) WHERE FILL IS REQUIRED TO ESTABLISH SUBGRADE ELEVATIONS SHOWN, FILL MATERIAL SHALL BE A GRANULAR MATERIAL CONTAINING LESS THAN 10% FINES. COMPACT FILL MATERIAL IN ACCORDANCE WITH GRADING PLANS AND DETAILS. FOLLOWING PLACEMENT OF FILL AND PRIOR TO PLACEMENT OF AGGREGATE STORAGE MATERIAL, VERIFY PERMEABILITY AND MAKE ANY NEEDED ADJUSTMENTS TO MAINTAIN MINIMUM INFILTRATION RATES OF EXISTING SOIL PRIOR TO CONSTRUCTION. SEE NOTES ON SHEET C201 FOR SURFACE

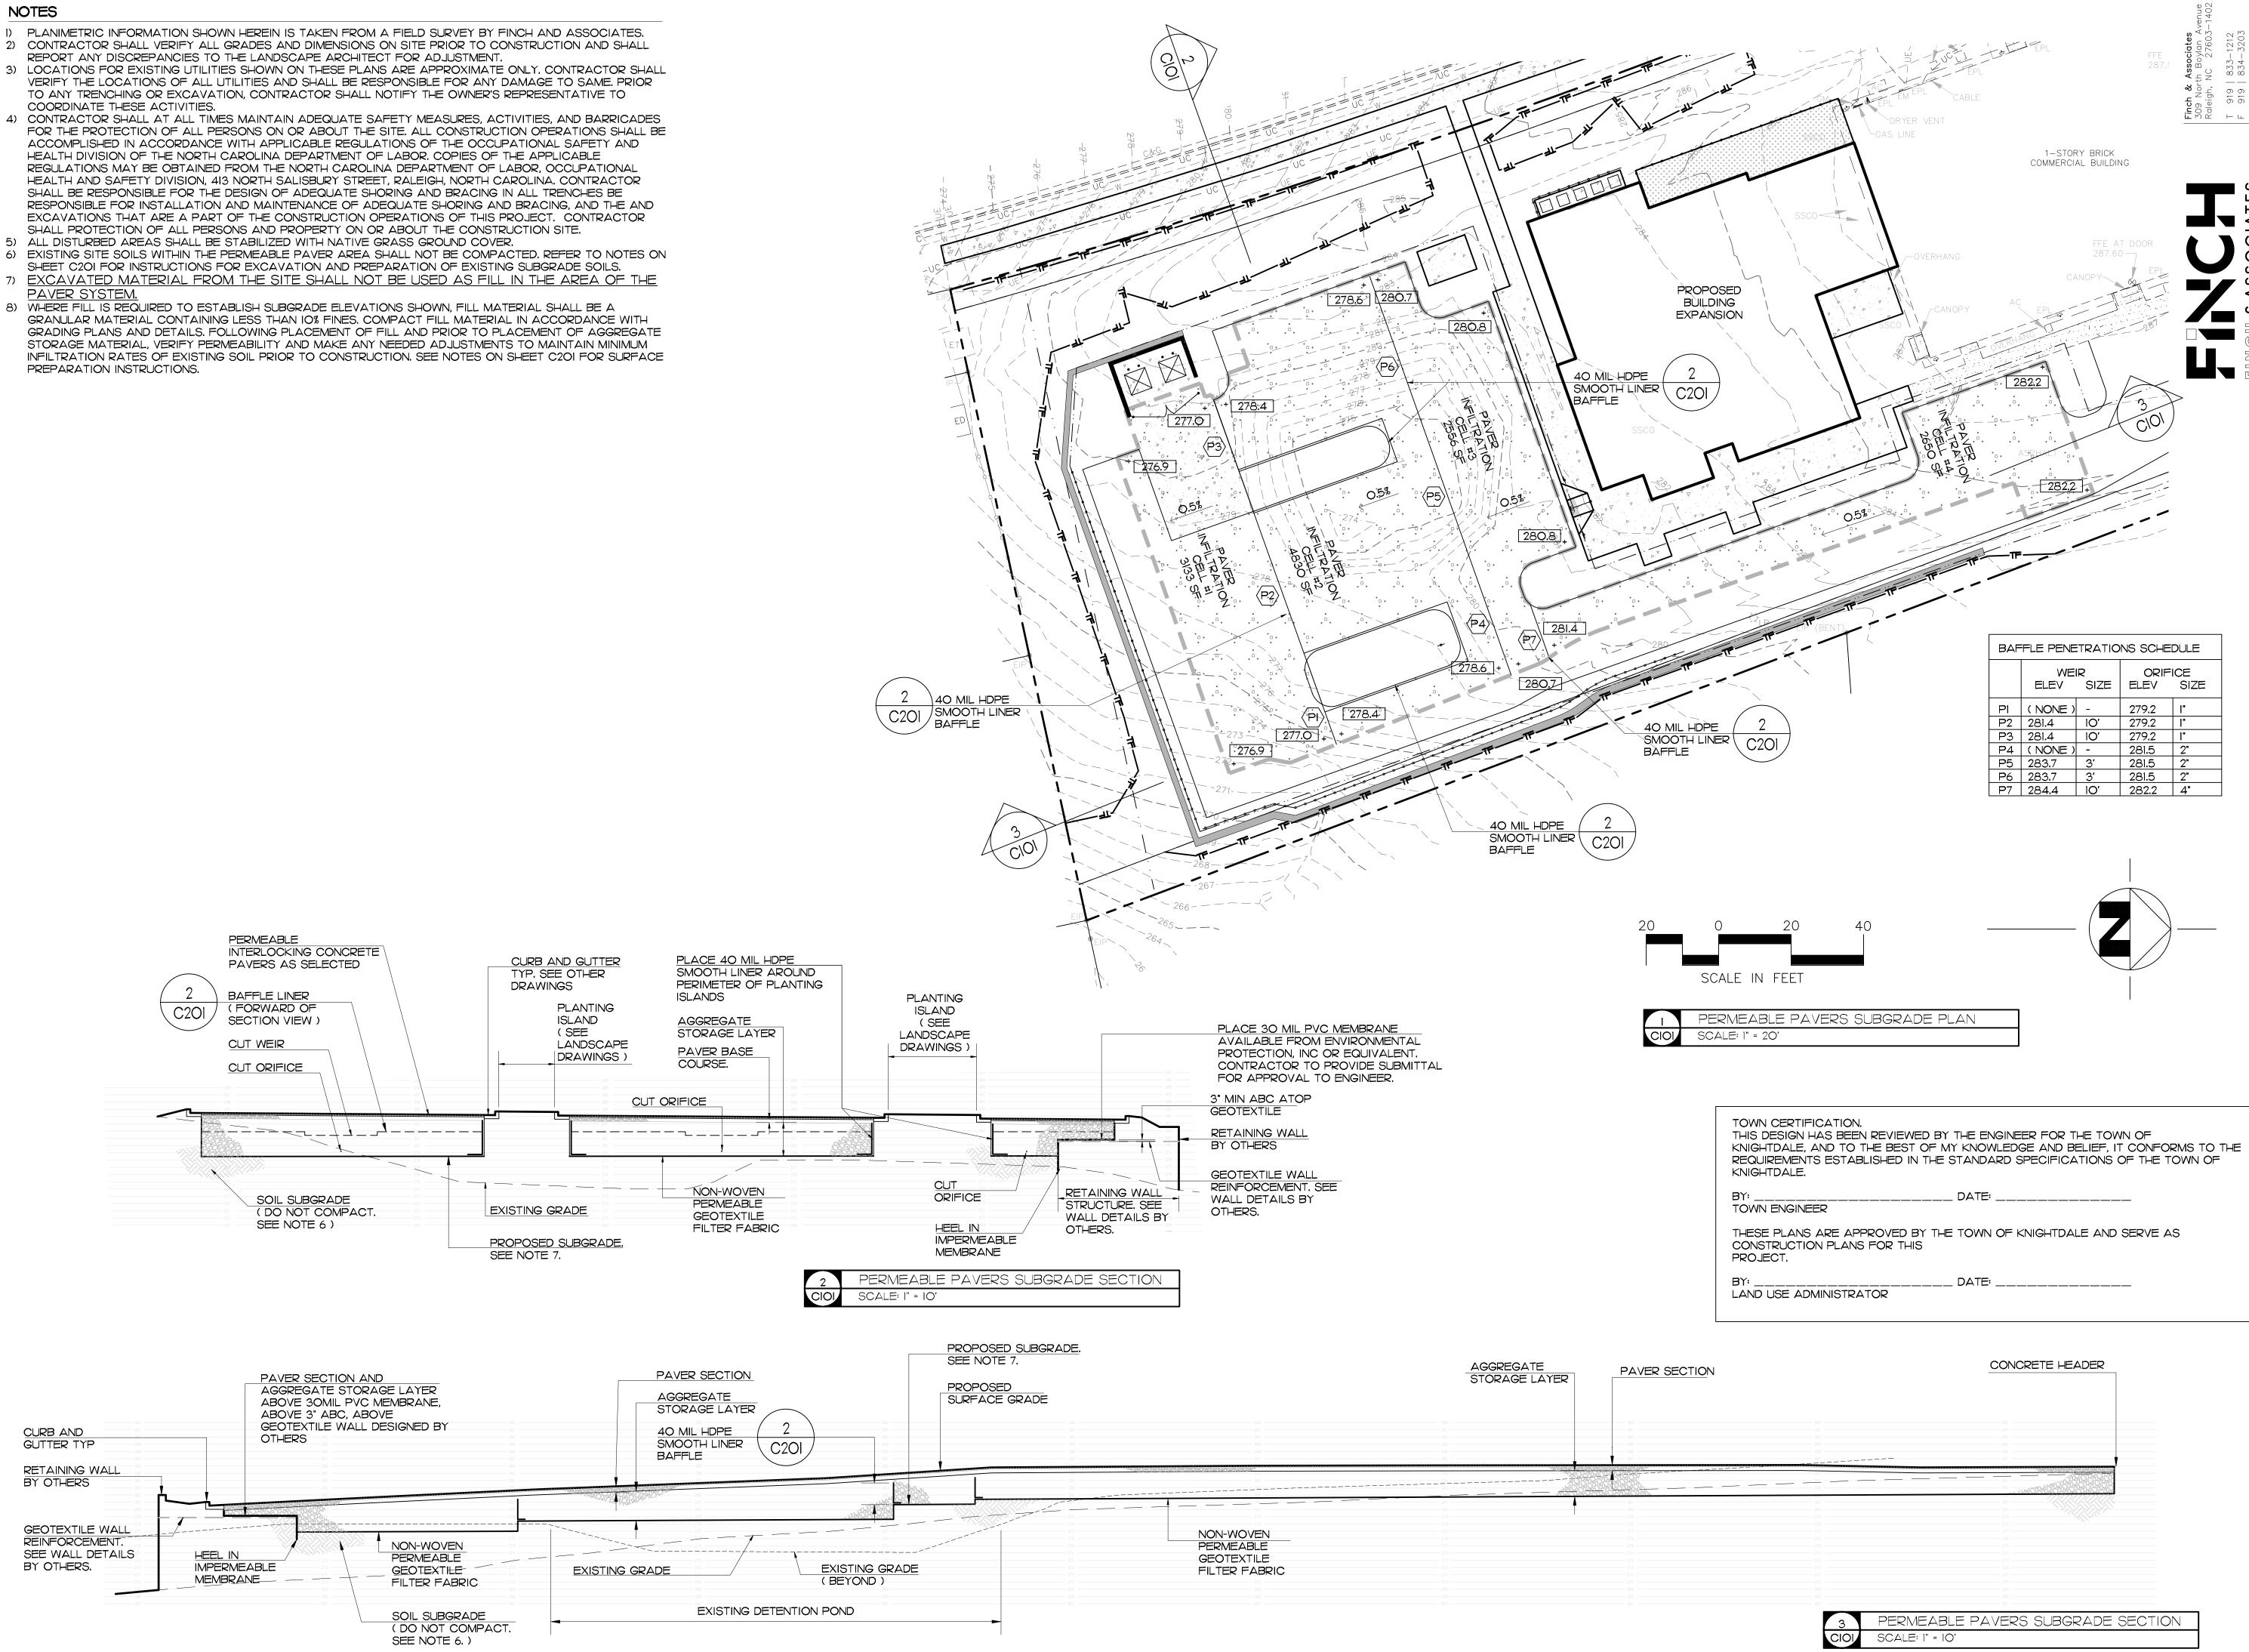



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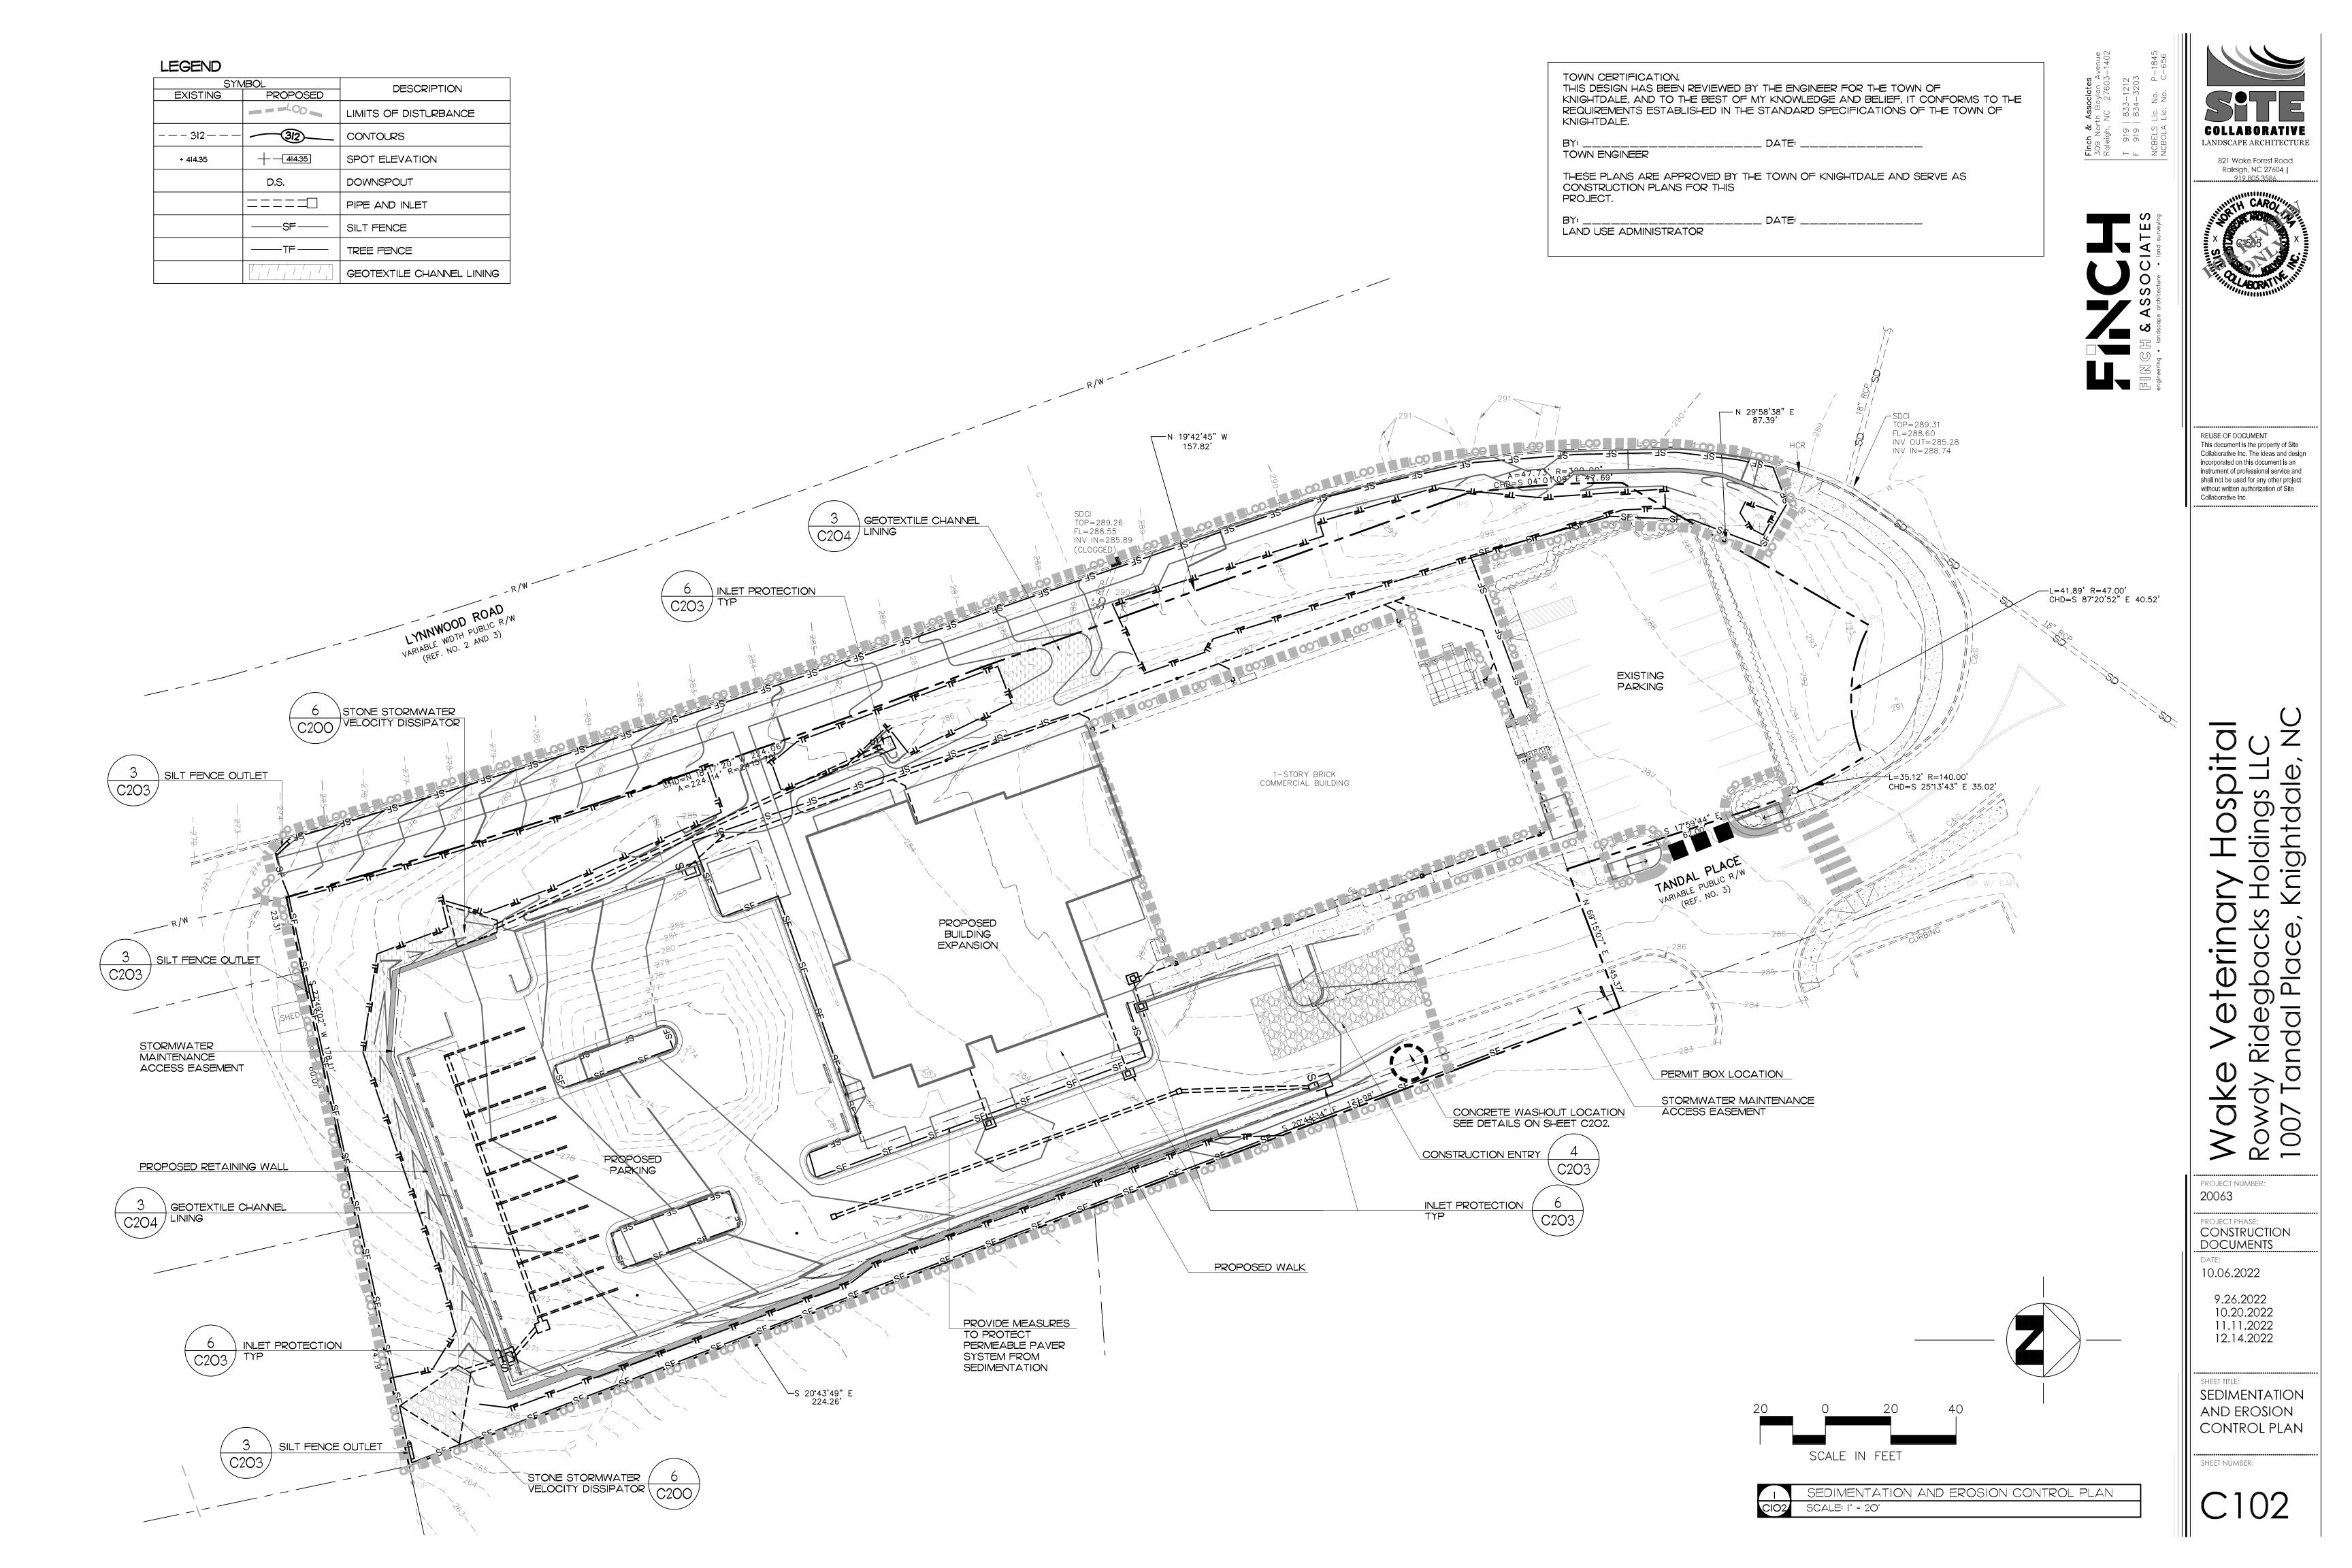
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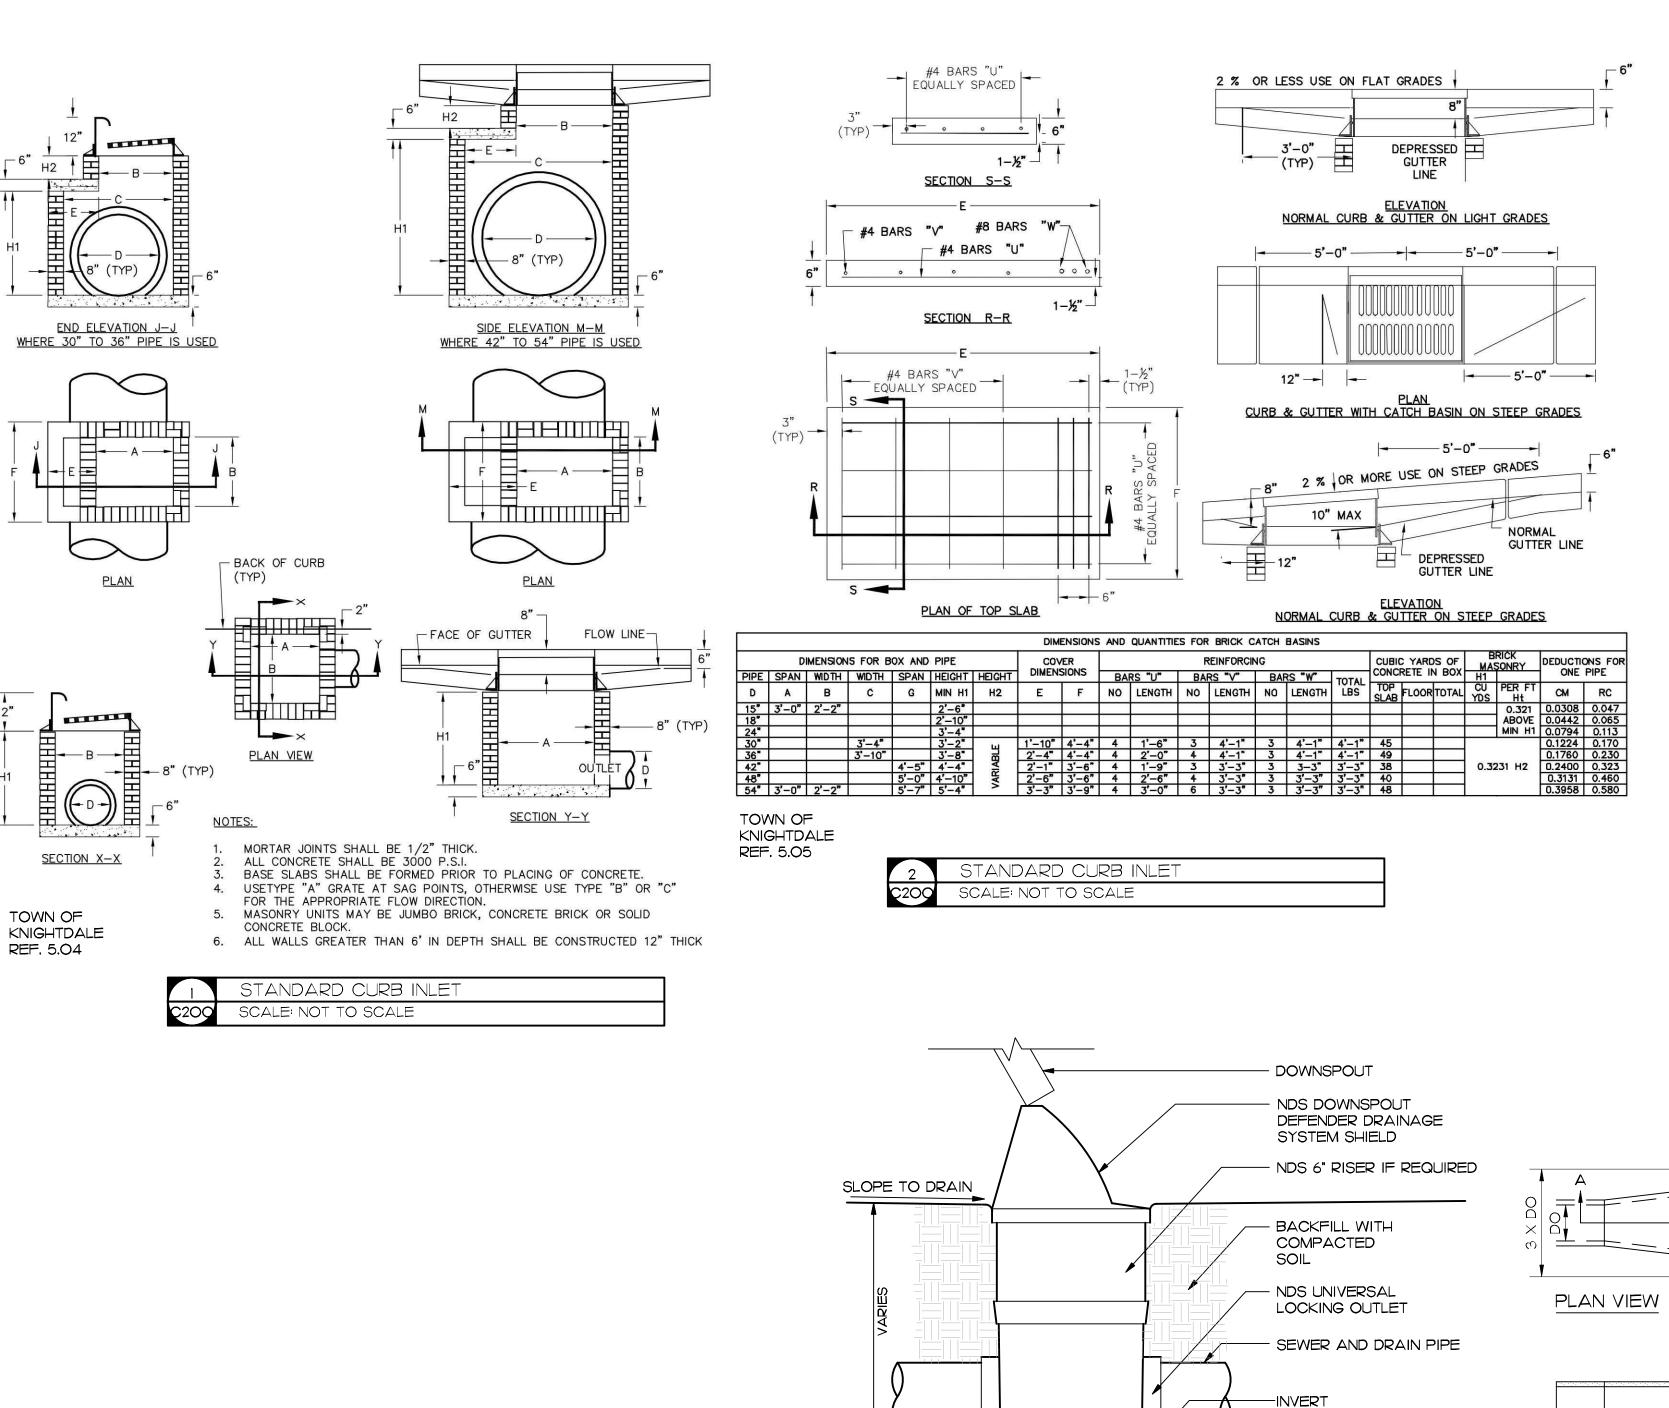
PROJECT PHASE: CONSTRUCTION DOCUMENTS

10.06.2022

9.26.2022 10.20.2022 11.11.2022 12.14.2022

STORMWATER PLAN






ELEVATION

MANUFACTURED CATCH BASIN

SCALE: NOT TO SCALE

-NDS 12" SQUARE CATCH BASIN

CRUSHED STONE

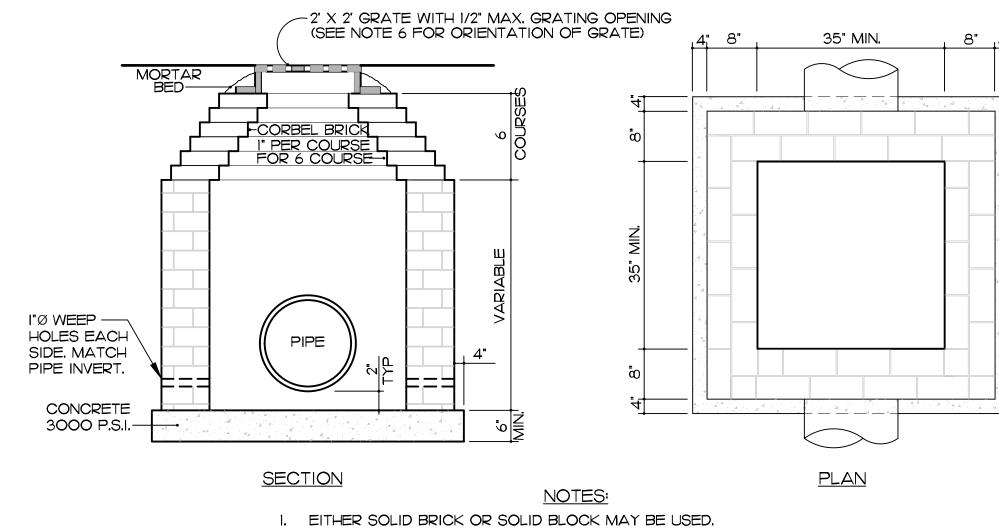

FOR 24" R.C.P. AND LARGER USE PIPE DIA. PLUS 12" FOR MINIMUM INSIDE DIMENSION.

4. WHERE STEPS ARE REQUIRED, USE OF PRECAST CONCRETE SLAB SHALL BE USED AS TOP

6. IF GRATING HAS ELONGATED OPENINGS, THE GRATING SHALL BE SET SO THAT THE LONG

DIMENSION OF THE OPENING IS PERPENDICULAR TO THE DIRECTION OF TRAVEL.

STANDARD STEPS REQUIRED . 16" O.C. WHERE DEPTH EXCEEDS 3'.


INLETS DEEPER THAN IO' SHALL REQUIRE DOUBLE WALLS.

BRICK INLET

SCALE: NOT TO SCALE

AND GRATE POSITIONED OVER STEPS.

COLLABORATIVE LANDSCAPE ARCHITECTURE 821 Wake Forest Road Raleigh, NC 27604

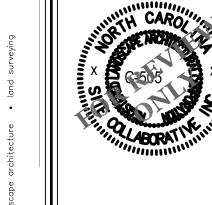

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PROJECT NUMBER: 20063

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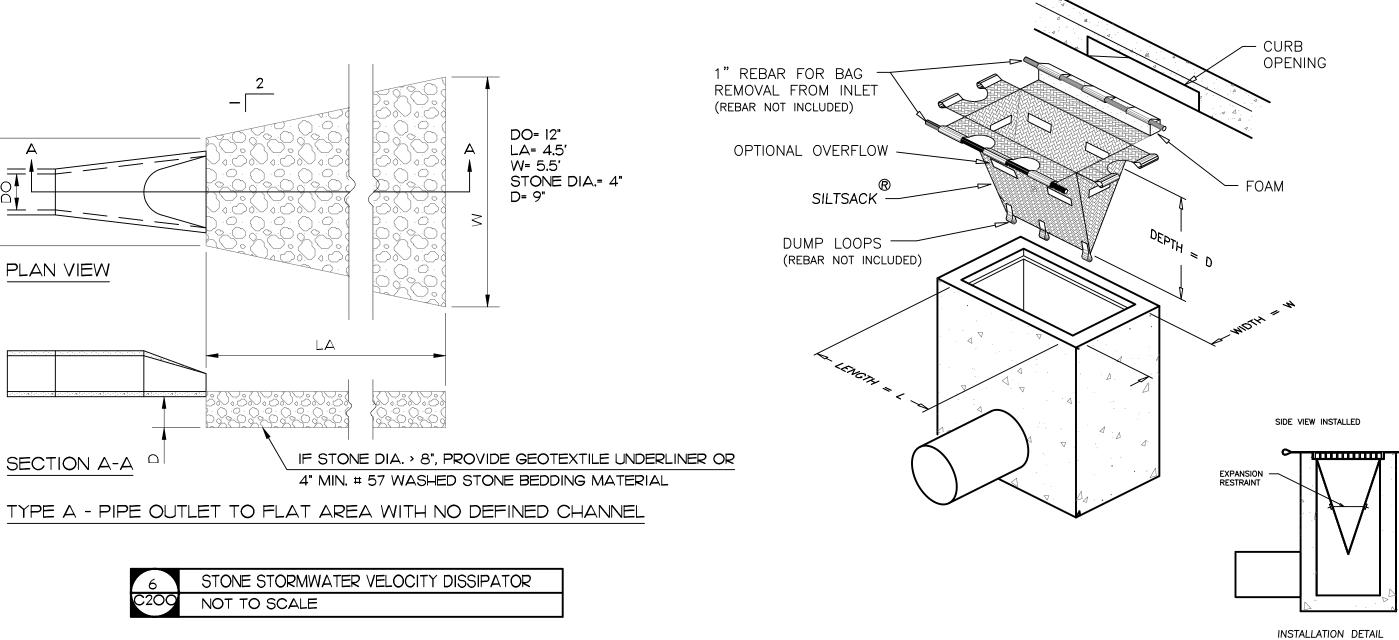
DOCUMENTS

10.06.2022

9.26.2022 10.20.2022 11.11.2022 12.14.2022

STORMWATER DETAILS

SHEET NUMBER:



TOWN CERTIFICATION. THIS DESIGN HAS BEEN REVIEWED BY THE ENGINEER FOR THE TOWN OF KNIGHTDALE, AND TO THE BEST OF MY KNOWLEDGE AND BELIEF, IT CONFORMS TO THE REQUIREMENTS ESTABLISHED IN THE STANDARD SPECIFICATIONS OF THE TOWN OF KNIGHTDALE.

TOWN ENGINEER

INLET SEDIMENT CONTROL


SCALE: NOT TO SCALE

THESE PLANS ARE APPROVED BY THE TOWN OF KNIGHTDALE AND SERVE AS CONSTRUCTION PLANS FOR THIS PROJECT.

LAND USE ADMINISTRATOR

PERMEABLE INTERLOCKING CONCRETE PAVERS (PICP) CONSTRUCTION NOTES

- I. PRIOR TO CONSTRUCTION OF THE PERMEABLE PAVEMENT SYSTEM, ENSURE THAT ALL ADJACENT AREAS HAVE BEEN STABILIZED WITH APPROPRIATE GROUND COVER. INSTALL DIVERSIONS AND SILT FENCE AS SHOWN ON PLANS AND AS NEEDED TO PREVENT EROSION AND POSSIBLE CONTAMINATION WITH SEDIMENTS. PERMEABLE PAVEMENT AREA SHALL BE CLEARLY MARKED ON SITE. CONSTRUCTION TRAFFIC SHALL BE ROUTED AROUND PERMEABLE PAVEMENT AREA USING FENCING OR OTHER BARRIERS AS REQUIRED UNTIL INSTALLATION IS COMPLETE.
- 2. COORDINATE REQUIRED INSPECTIONS OF THE PERMEABLE PAVER SYSTEM WITH TOWN OF KNIGHTDALE STORMWATER INSPECTOR.
- 3. EXCAVATION SHALL BE CONDUCTED IN DRY WEATHER WITH DRY SOIL CONDITIONS. GRADE TO ELEVATIONS AND SLOPES AS SHOWN ON THE SUBGRADE PLAN. CONTRACTOR SHALL TAKE NECESSARY STEPS TO MINIMIZE COMPACTION OF SUBGRADE. OPERATE EXCAVATION EQUIPMENT FROM OUTSIDE THE PAVEMENT AREA OR FROM UNEXCAVATED PORTIONS OF THE AREA. DIG THE FINAL 9 TO 12 IN. BY USING THE TEETH OF THE EXCAVATOR BUCKET TO LOOSEN SOIL AND DO NOT SMEAR THE SUBGRADE SOIL SURFACE. FINAL GRADING OR SMOOTHING OF THE SUBGRADE SHOULD BE DONE BY HAND IF POSSIBLE. MINIMIZE THE TIME BETWEEN EXCAVATION AND PLACEMENT OF THE AGGREGATE. REMOVE ANY SEDIMENTS THAT ACCUMULATE.
- 4. IMMEDIATELY AFTER EXCAVATION AND BEFORE THE AGGREGATE IS PLACED, A DIRECT MEASUREMENT OF THE SOIL'S INFILTRATION RATE SHALL BE CONDUCTED BY A QUALIFIED PROFESSIONAL. REPEAT IF SUBGRADE IS EXPOSED TO RAINFALL PRIOR TO PLACEMENT OF AGGREGATE. SCARIFY, RIP OR TRENCH THE SOIL SUBGRADE SURFACE AS NEEDED TO MAINTAIN THE SOIL'S PREDISTURBANCE INFILTRATION RATE.
- 5. PLACE NON-WOVEN PERMEABLE GEOTEXTILE FILTER FABRIC AND BAFFLE LINERS IN ACCORDANCE WITH MANUFACTURER'S RECOMMENDATIONS AND AS SHOWN ON PLANS, SECURE MATERIALS TO PREVENT DEFORMATION DURING PLACEMENT OF AGGREGATE, REMOVE ANY SEDIMENTS FROM FILTER FABRIC AND REPLACE FABRIC AS NEEDED TO MAINTAIN PERMEABILITY.
- 6. PLACE CATCH BASINS, OUTLET STRUCTURE, OBSERVATION WELLS AND UNDERDRAIN SYSTEM WHEN SUBGRADE PREPARATION ALLOWS. DEAD ENDS OF UNDERDRAIN PIPES SHALL BE CLOSED WITH A SUITABLE CAP PLACED OVER THE END AND HELD FIRMLY IN PLACE. PORTIONS OF THE UNDERDRAIN SYSTEM WITHIN ONE FOOT OF THE OUTLET STRUCTURE ARE SOLID AND NOT PERFORATED.
- 7. INSPECT ALL AGGREGATES TO ENSURE THEY ARE FREE FROM FINES PRIOR TO PLACEMENT. ANY AGGREGATE THAT CANNOT BE PLACED IMMEDIATELY SHALL BE STORED ON AN IMPERVIOUS SURFACE OR GEOTEXTILE TO KEEP AGGREGATE FREE OF SEDIMENT.
- 8. ALL AGGREGATE SHALL BE SPREAD (NOT DUMPED) BY A FRONT-END LOADER OR FROM DUMP TRUCKS DEPOSITING FROM NEAR THE EDGE OF THE EXCAVATED AREA OR RESTING DIRECTLY ON DEPOSITED AGGREGATE PILES. MOISTEN AND SPREAD THE WASHED STONE WITHOUT DRIVING ON THE SOIL SUBGRADE. PROTECT DRAINAGE SYSTEM COMPONENTS AND REPAIR ANY DAMAGE. COMPACT AGGREGATE AS RECOMMENDED BY THE PAVER MANUFACTURER. ENSURE ADEQUATE COMPACTION IN CORNERS AND AREAS ADJACENT TO UTILITY STRUCTURES. DO NOT CRUSH AGGREGATES DURING COMPACTION AS THIS GENERATES ADDITIONAL FINES THAT MAY CLOG THE SOIL SUBGRADE.
- 9. INSTALL PAVEMENT EDGE RESTRAINTS AND CURB AND GUTTER.
- IO. INSTALL BEDDING AND PAVER COURSES AS SHOWN ON PLANS AND DETAILS. CONTRACTOR PERFORMING PAVER INSTALLATION SHALL HOLD A PICP SPECIALIST CERTIFICATE FROM THE INTERLOCKING CONCRETE PAVEMENT INSTITUTE.
- II. PROTECT PERMEABLE PAVER SYSTEM FROM DAMAGE UNTIL SITE CONSTRUCTION IS COMPLETE. REMOVE AND REPLACE PAVERS AND AGGREGATE BASE COURSE DAMAGED BY CONSTRUCTION OR SEDIMENTATION.
- 12. WHEN CONSTRUCTION IS COMPLETE, CONTACT PROJECT ENGINEER FOR FINAL INSPECTION. CONDUCT INFILTRATION TEST USING NCSU SIMPLE INFILTRATION TEST OR OTHER APPROPRIATE TEST METHOD TO DEMONSTRATE PERMEABILITY OF PAVEMENT SYSTEM SURFACE.
- 13. FOLLOWING COMPLETION OF CONSTRUCTION, CONTRACTOR SHALL PROVIDE AS-BUILT DRAWINGS TO ENGINEER, INDICATING ANY CHANGES FROM THE CONSTRUCTION DRAWINGS.

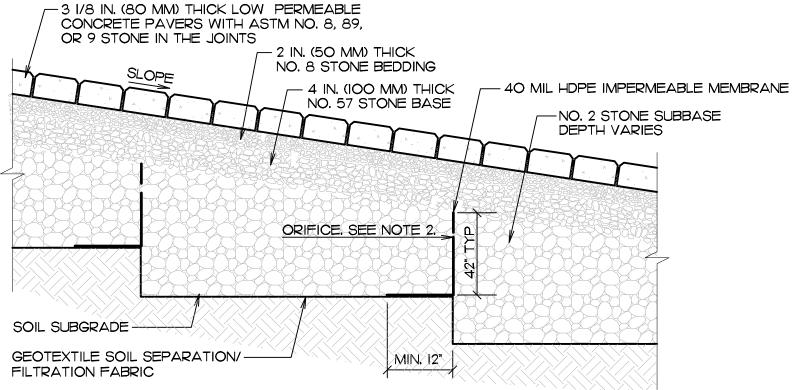


NOTES

1. SEE PLANS FOR LOCATIONS, HEIGHT, AND WIDTHS OF BAFFLES
2. CUT ORIFICES AND WEIRS IN IMPERMEABLE MEMBRANES ACCORDING TO


LOCATIONS, SIZES, AND ELEVATIONS REPORTED ON PLANS.

3. PROTECT IMPERMEABLE LINER FROM DAMAGE DURING AGGREGATE PLACEMENT.




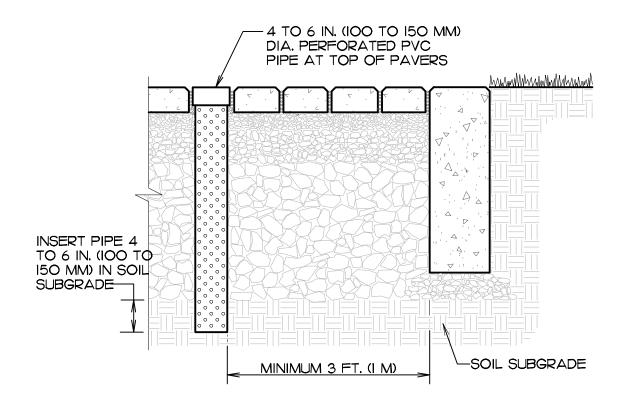




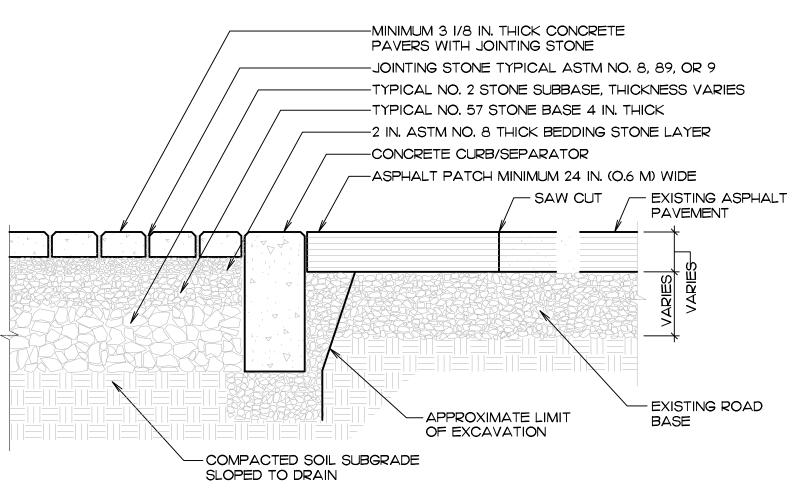



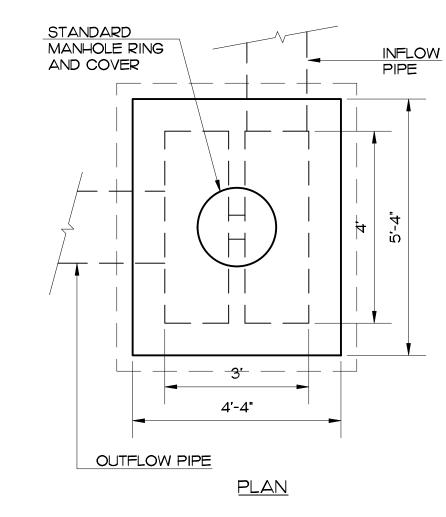


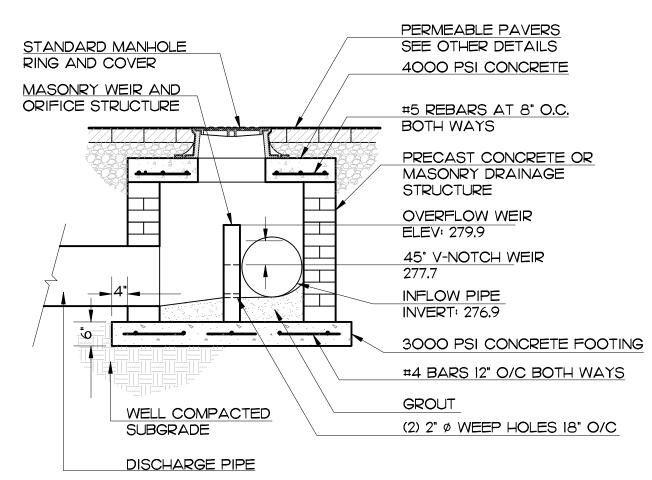


SECTION



•	THE ENGINEER FOR THE TOWN OF Y KNOWLEDGE AND BELIEF, IT CONFORMS TO THE STANDARD SPECIFICATIONS OF THE TOWN OF
BY: TOWN ENGINEER	_ DATE:
THESE PLANS ARE APPROVED BY THE CONSTRUCTION PLANS FOR THIS PROJECT.	TOWN OF KNIGHTDALE AND SERVE AS
BY: LAND USE ADMINISTRATOR	DATE:

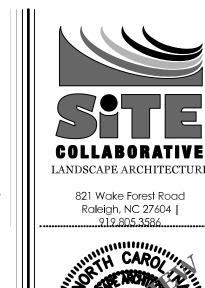

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ake Veterinary Hospital

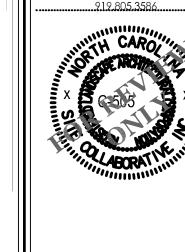vdy Ridegbacks Holdings LLC

7 Tandal Place, Knightdale, NC

PROJECT NUMBER: 20063

PROJECT PHASE: CONSTRUCTION DOCUMENTS

DATE: 10.06.2022

9.26.2022
10.20.2022
11.11.2022
12.14.2022

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SHEET TITLE:
STORMWATER
DETAILS

SHEET NUMBER:

C201

CONSTRUCTION NARRATIVE

The proposed improvements include the expansion of the existing building and construction of new walks and parking. In conjunction with this new development, the area of the existing detention basin will be repurposed. Post-construction stormwater treatment and control will be accomplished using permeable interlocking concrete pavers with infiltration where new vehicular greas are proposed. All runoff from existing and proposed building roofs and impervious pavements is to be collected in catch basins and discharged directly into the aggregate storage of the paver system. Sumps in the catch basins are to provide pretreatment of the stormwater prior to its entry into the aggregate.

The proposed area of disturbance is 60,400 square feet, 1.4 acres.

Proposed sedimentation and erosion control measures include perimeter silt fence and silt fence outlets, inlet protection, and seeding of disturbed areas.

CONSTRUCTION SEQUENCE

- 1. Schedule an Initial Pre-construction conference with the Town of Knightdale. Obtain a land-disturbance permit. Any fines, penalties, or additional charges incurred by the Owner due to land disturbing activities by the Contractor prior to the issuance of all applicable permits shall be charged to the Contractor.
- 2. Install all perimeter controls as shown on the approved plans.
- 3. Schedule an Onsite Pre-Construction Meeting with the Town of Knightdale to inspect the installed perimeter controls
- 4. If approved, proceed with installing temporary diversions, silt fence, or other measures as shown on the approved plans. CLEAR ONLY AS NECESSARY TO INSTALL THESE DEVICES. Seed temporary diversions and berms immediately after construction. It is the responsibility of the Contractor to install, maintain, and minimize erosion problems on the site. Maintain sizes, volumes, and devises to ensure the integrity and usefulness of the proposed measures. Contractor may relocate or modify erosion control measures to make adjustments for unforeseen field conditions so long as sizes, volumes, and construction are maintained to insure the integrity and usefulness of the proposed measures. All relocations or modifications shall have the prior approval of the Landscape Architect and the Erosion Control Inspector.
- 5. Call Town of Knightdale Erosion Control Inspector to schedule an onsite inspection and obtain a Certificate of Coverage.
- 6. Maintain Devices as needed. Inspect all silt fencing after each rainfall event and repair any damaged or weakened segments. Rough grade site.
- 7. Protect inlets with block and gravel controls, sediment traps or other approved measures as shown in the approved
- 8. Begin clearing, grubbing, construction, building, etc. The contractor shall conduct the work in phases to minimize the amount of area disturbed at any one time and stabilize disturbed areas as quickly as possible. Delay removal of existing vegetation and hardscape until ready to proceed with construction in the affected areas.
- 9. Install additional sedimentation and erosion control measures as shown on plan and as work allows to prevent sedimentation into stabilized areas from areas under construction.
- 10. Maintain functionality of the existing storm drainage system until such time as equivalent functionality can be provided by newly constructed drainage devices and outlet structures. See notes pertaining to construction of the permeable paver system on sheet C201. The contractor shall protect the permeable interlocking concrete paver system (PICP) and crushed aggregate base course from infiltration of sediment. At project completion, contractor shall repair or replace pavers and aggregate base course as needed in any locations where sedimentation has occurred to restore functionality of the paver system and shall replace any damaged pavers.
- 11. Stabilize site as areas are brought up to finish grade with vegetation, paving, ditch linings, silt fence, etc. Seed and Mulch denuded areas per Ground Stabilization Time Frames. It is the contractor's responsibility to minimize sediment intrusion into the stormwater control measure during all phases of construction.

See the following for ground stabilization:

- A) Soil stabilization shall be achieved on any area of the site where land-disturbing activities have temporarily or permanently ceased according to the following schedule:
- i. All permanent dikes, swales, ditches, perimeter slopes, and all slopes steeper than 3:1 shall be provided temporary or permanent stabilization with ground cover as soon as practicable, but in any event within 7 calendar days from the last land-disturbing activity.
- ii. All other disturbed areas shall be provided temporary or permanent stabilization with ground cover as soon as practicable, but in any event within 14 calendar days from the last land—disturbing activity.
- B) Conditions In meeting the stabilization requirements above, the following conditions or exemptions shall apply: i. Extensions of time my be approved by the permitting authority based on weather or other site-specific conditions that make compliance impracticable.
- ii. All slopes 50' in length or greater shall apple the ground cover within 7 days except when the slope is flatter than 4:1. Slopes less than 50' shall apply ground cover within 14 days when slopes are steeper than 3:1, the 7 day-requirement applies,
- iii. Any sloped area flatter than 4:1 shall be exempt for the 7-day cover requirement. iv. Slopes 10' or less in length shall be exempt from the 7-day ground cover requirement except when the slope is steeper than 2:1. v. Although stabilization is usually specified as ground cover, other methods, such as chemical stabilization, may be allowed on a case-by-case basis.
- 12. When construction is complete and all areas are stabilized completely, call Erosion Control Inspector for an inspection.
- 13. If site is approved, remove temporary diversions, silt fence, sediment basins, etc., and seed out or stabilize any resulting bare areas. All remaining permanent erosion control devices, such as velocity dissipators, should now be installed
- 14. When vegetation has become established (90% germination), call for a final inspection by the Erosion Control Inspector. Obtain a Certificate of Completion and submit to Landscape Architect and Owner.
- * Construction phasing may be improved by the relocation of certain erosion measures or the installation of additional measures. (All phasing proposals by Contractor shall be submitted to the Landscape Architect for approval with subsequent approval by the Erosion Control Inspector required.) Contractor shall provide, install, and maintain all measures necessary to complete the work shown on these drawings and to minimize sediment intrusion into the stormwater control measure during all phases of construction.

TOWN CERTIFICATION. THIS DESIGN HAS BEEN REVIEWED BY THE ENGINEER FOR THE TOWN OF KNIGHTDALE, AND TO THE BEST OF MY KNOWLEDGE AND BELIEF, IT CONFORMS TO THE REQUIREMENTS ESTABLISHED IN THE STANDARD SPECIFICATIONS OF THE TOWN OF KNIGHTDALE.
BY: TOWN ENGINEER
THESE PLANS ARE APPROVED BY THE TOWN OF KNIGHTDALE AND SERVE AS CONSTRUCTION PLANS FOR THIS PROJECT.
BY: LAND USE ADMINISTRATOR

GROUND STABILIZATION AND MATERIALS HANDLING PRACTICES FOR COMPLIANCE WIT THE NCG01 CONSTRUCTION GENERAL PERMIT Implementing the details and specifications on this plan sheet will result in the construction

activity being considered compliant with the Ground Stabilization and Materials Handling sections of the NCG01 Construction General Permit (Sections E and F, respectively). The permittee shall comply with the Erosion and Sediment Control plan approved by the delegated authority having jurisdiction. All details and specifications shown on this sheet may not apply depending on site conditions and the delegated authority having jurisdiction

	Re	equired Ground Stabil	ization Timeframes
Sit	te Area Description	Stabilize within this many calendar days after ceasing land disturbance	Timeframe variations
(a)	Perimeter dikes, swales, ditches, and perimeter slopes	7	None
(b)	High Quality Water (HQW) Zones	7	None
(c)	Slopes steeper than 3:1	7	If slopes are 10' or less in length and are not steeper than 2:1, 14 days are allowed
(d)	Slopes 3:1 to 4:1	14	 -7 days for slopes greater than 50' in length and with slopes steeper than 4:1 -7 days for perimeter dikes, swales, ditches, perimeter slopes and HQW Zones -10 days for Falls Lake Watershed
(e)	Areas with slopes flatter than 4:1	14	 -7 days for perimeter dikes, swales, ditches, perimeter slopes and HQW Zon -10 days for Falls Lake Watershed unless there is zero slope

ground stabilization shall be converted to permanent ground stabilization as soon as practicable but in no case longer than 90 calendar days after the last land disturbing activity. Temporary ground stabilization shall be maintained in a manner to render the surface stable against accelerated erosion until permanent ground stabilization is achieved

GROUND STABILIZATION SPECIFICATION ground sufficiently so that rain will not dislodge the soil. Use one of the

Temporary Stabilization	Permanent Stabilization
 Temporary grass seed covered with straw or other mulches and tackifiers Hydroseeding Rolled erosion control products with or without temporary grass seed Appropriately applied straw or other mulch Plastic sheeting 	Permanent grass seed covered with straw or other mulches and tackifiers Geotextile fabrics such as permanent soil reinforcement matting Hydroseeding Shrubs or other permanent plantings covered with mulch Uniform and evenly distributed ground cover

POLYACRYLAMIDES (PAMS) AND FLOCCULANTS

- Select flocculants that are appropriate for the soils being exposed during construction, selecting from the NC DWR List of Approved PAMS/Flocculants.
- Apply flocculants at or before the inlets to Erosion and Sediment Control Measures. Apply flocculants at the concentrations specified in the NC DWR List of Approved

sufficient to restrain erosion

retaining walls

Structural methods such as concrete, asphalt or

Rolled erosion control products with grass seed

- PAMS/Flocculants and in accordance with the manufacturer's instructions. Provide ponding area for containment of treated Stormwater before discharging
- Store flocculants in leak-proof containers that are kept under storm-resistant cover or surrounded by secondary containment structures.

- Maintain vehicles and equipment to prevent discharge of fluids.
- Provide drip pans under any stored equipment. Identify leaks and repair as soon as feasible, or remove leaking equipment from the
- 1. Collect all spent fluids, store in separate containers and properly dispose as
- Remove leaking vehicles and construction equipment from service until the problem

LITTER, BUILDING MATERIAL AND LAND CLEARING WASTE

- Never bury or burn waste. Place litter and debris in approved waste containers.
- recentacle) on site to contain construction and domestic wastes Locate waste containers at least 50 feet away from storm drain inlets and surface
- Locate waste containers on areas that do not receive substantial amounts of runoff
- Anchor all lightweight items in waste containers during times of high winds.
- 8. Dispose waste off-site at an approved disposal facility.

- Do not dump paint and other liquid waste into storm drains, streams or wetlands
- waters unless no other alternatives are reasonably available
- 4. Containment must be labeled, sized and placed appropriately for the needs of site.

Install portable toilets on level ground, at least 50 feet away from storm drains, on a gravel pad and surround with sand bags.

EARTHEN STOCKPILE MANAGEMENT

- Show stockpile locations on plans. Locate earthen-material stockpile areas at least 50 feet away from storm drain inlets, sediment basins, perimeter sediment controls and surface waters unless it can be shown no other alternatives are reasonably
- Protect stockpile with silt fence installed along toe of slope with a minimum offset of five feet from the toe of stockpile
- Provide stable stone access point when feasible
- Stabilize stockpile within the timeframes provided on this sheet and in accordance with the approved plan and any additional requirements. Soil stabilization is defined as vegetative, physical or chemical coverage techniques that will restrain accelerated

QUIPMENT AND VEHICLE MAINTENANCE

- hazardous waste (recycle when possible)
- Bring used fuels, lubricants, coolants, hydraulic fluids and other petroleum products to a recycling or disposal center that handles these materials.

- 2. Provide a sufficient number and size of waste containers (e.g dumpster, trash
- waters unless no other alternatives are reasonably available.
- from upland areas and does not drain directly to a storm drain, stream or wetland.
- Cover waste containers at the end of each workday and before storm events or provide secondary containment. Repair or replace damaged waste containers.
- 7. Empty waste containers as needed to prevent overflow. Clean up immediately if containers overflow.
- 9. On business days, clean up and dispose of waste in designated waste containers.

PAINT AND OTHER LIQUID WASTI

- Locate paint washouts at least 50 feet away from storm drain inlets and surface
- Contain liquid wastes in a controlled area.

Prevent the discharge of soaps, solvents, detergents and other liquid wastes from construction sites.


PORTABLE TOILETS

1. E&SC Plan Documentation

- streams or wetlands unless there is no alternative reasonably available. If 50 foot offset is not attainable, provide relocation of portable toilet behind silt fence or place
- Provide staking or anchoring of portable toilets during periods of high winds or in high
- Monitor portable toilets for leaking and properly dispose of any leaked material. Utilize a licensed sanitary waste hauler to remove leaking portable toilets and replace with properly operating unit.

- erosion on disturbed soils for temporary or permanent control needs.



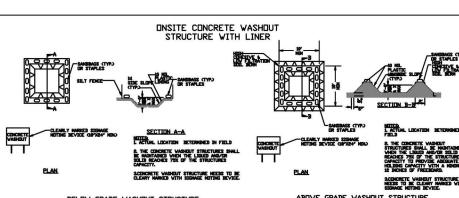

CONCRETE WASHOUTS

- Manage washout from mortar mixers in accordance with the above item and in addition place the mixer and associated materials on impervious barrier and within
- alternate method or product is to be used, contact your approval authority for review and approval. If local standard details are not available, use one of the two types of temporary concrete washouts provided on this detail.
- sections. Stormwater accumulated within the washout may not be pumped into or discharged to the storm drain system or receiving surface waters. Liquid waste must be pumped out and removed from project.
- can be shown that no other alternatives are reasonably available. At a minimum, install protection of storm drain inlet(s) closest to the washout which could receive spills or overflow.
- Locate washouts in an easily accessible area, on level ground and install a stone
- approving authority. Install at least one sign directing concrete trucks to the washout within the project
- limits. Post signage on the washout itself to identify this location. Remove leavings from the washout when at approximately 75% capacity to limit overflow events. Replace the tarp, sand bags or other temporary structural components when no longer functional. When utilizing alternative or proprietary
- 10. At the completion of the concrete work, remove remaining leavings and dispose of in an approved disposal facility. Fill pit, if applicable, and stabilize any disturbance

HERBICIDES, PESTICIDES AND RODENTICIDES

- Store and apply herbicides, pesticides and rodenticides in accordance with label
- label, which lists directions for use, ingredients and first aid steps in case of accidental poisoning
- Do not store herbicides, pesticides and rodenticides in areas where flooding is possible or where they may spill or leak into wells, stormwater drains, ground water

Create designated hazardous waste collection areas on-site.

- . Place hazardous waste containers under cover or in secondary containment
- 3. Do not store hazardous chemicals, drums or bagged materials directly on the ground

SELF-INSPECTION, RECORDKEEPING AND REPORTING

NCG01 GROUND STABILIZATION AND MATERIALS HANDLING

SELF-INSPECTION, RECORDKEEPING AND REPORTING

SECTION A: SELF-INSPECTION Self-inspections are required during normal business hours in accordance with the table below. When adverse weather or site conditions would cause the safety of the inspection personnel to be in jeopardy, the inspection may be delayed until the next business day on which it is safe to perform the inspection. In addition, when a storm event of equal to or

Frequency Inspect (during normal business hours)		Inspection records must include:				
(1) Rain gauge maintained in good working order	Daily	Daily rainfall amounts. If no daily rain gauge observations are made during weekend or holiday periods, and no individual-day rainfall information is available, record the cumulative rain measurement for those un attended days (and this will determine if a site inspection is needed). Days on which no rainfall occurred shall be recorded as "zero." The permittee may use another rain-monitoring device approved by the Division.				
(2) E&SC Measures	At least once per 7 calendar days and within 24 hours of a rain event ≥ 1.0 inch in 24 hours	1. Identification of the measures inspected, 2. Date and time of the inspection, 3. Name of the person performing the inspection, 4. Indication of whether the measures were operating properly, 5. Description of maintenance needs for the measure, 6. Description, evidence, and date of corrective actions taken.				
(3) Stormwater discharge outfalls (SDCs)	At least once per 7 calendar days and within 24 hours of a rain event ≥ 1.0 inch in 24 hours	1. Identification of the discharge outfalls inspected, 2. Date and time of the inspection, 3. Name of the person performing the inspection, 4. Evidence of indicators of stormwater pollution such as oil sheen, floating or suspended solids or discoloration, 5. Indication of visible sediment leaving the site, 6. Description, evidence, and date of corrective actions taken.				
(4) Perimeter of site	At least once per 7 calendar days and within 24 hours of a rain event ≥ 1:0 inch in 24 hours	If visible sedimentation is found outside site limits, then a record of the following shall be made: Actions taken to clean up or stabilize the sediment that has left the site limits, Description, evidence, and date of corrective actions taken, and An explanation as to the actions taken to control future releases.				
(5) Streams or wetlands onsite or offsite (where accessible)	At least once per 7 calendar days and within 24 hours of a rain event ≥ 1.0 inch in 24 hours	If the stream or wetland has increased visible sedimentation or a stream has visible increased turbidity from the construction activity, then a record of the following shall be made: 1. Description, evidence and date of corrective actions taken, and 2. Records of the required reports to the appropriate Division Regional Office per Part III, Section C, Item (2)(a) of this permit.				
(6) Ground stabilization measures	After each phase of grading	1. The phase of grading (installation of perimeter E&SC measures, clearing and grubbing, installation of storm drainage facilities, completion of all land-disturbing activity, construction or redevelopment, permanent ground cover). 2. Documentation that the required ground stabilization measures have been provided within the required timeframe or an assurance that they will be provided as				

NOTE: The rain inspection resets the required 7 calendar day inspection requirement.

SELF-INSPECTION, RECORDKEEPING AND REPORTING SECTION B: RECORDKEEPING

The approved E&SC plan as well as any approved deviation shall be kept on the site. The approved E&SC plan must be kept up-to-date throughout the coverage under this permit. The following items pertaining to the E&SC plan shall be kept on site and available for inspection at all times during normal business hours

Item to Document **Documentation Requirements** (a) Each E&SC measure has been installed Initial and date each E&SC measure on a copy and does not significantly deviate from the of the approved E&SC plan or complete, date locations, dimensions and relative elevations and sign an inspection report that lists each shown on the approved E&SC plan. E&SC measure shown on the approved E&SC plan. This documentation is required upon the initial installation of the E&SC measures or if the E&SC measures are modified after initial

construction phase.

plan or complete, date and sign an inspection

Initial and date a copy of the approved E&SC

plan or complete, date and sign an inspection

(b) A phase of grading has been completed. Initial and date a copy of the approved E&SC

Initial and date a copy of the approved E&SC (c) Ground cover is located and installed in accordance with the approved E&SC plan or complete, date and sign an inspection report to indicate compliance with approved ground cover specifications. (d) The maintenance and repair Complete, date and sign an inspection report. requirements for all E&SC measures

report to indicate the completion of the 2. Additional Documentation to be Kept on Site In addition to the E&SC plan documents above, the following items shall be kept on the site and available for inspectors at all times during normal business hours, unless the Division provides a site-specific exemption based on unique site conditions that make

- this requirement not practical: (a) This General Permit as well as the Certificate of Coverage, after it is received.
- (b) Records of inspections made during the previous twelve months. The permittee shall record the required observations on the Inspection Record Form provided by the Division or a similar inspection form that includes all the required elements. Use of electronically-available records in lieu of the required paper copies will be allowed if shown to provide equal access and utility as the hard-copy records.
- 3. Documentation to be Retained for Three Years All data used to complete the e-NOI and all inspection records shall be maintained for a period of three years after project completion and made available upon request. [40 CFR 122.41]

NCG01 SELF-INSPECTION, RECORDKEEPING AND REPORTING

DRAW DOWN OF SEDIMENT BASINS FOR MAINTENANCE OR CLOSE OUT

have been performed.

to E&SC measures.


(e) Corrective actions have been taken

Sediment basins and traps that receive runoff from drainage areas of one acre or more shall use outlet structures that withdraw water from the surface when these devices need to be drawn down for maintenance or close out unless this is infeasible. The circumstances in which it is not feasible to withdraw water from the surface shall be rare (for example, times with extended cold weather). Non-surface withdrawals from sediment basins shall be allowed only when all of the following criteria have been met:

PART II, SECTION G, ITEM (4)

- (a) The E&SC plan authority has been provided with documentation of the non-surface withdrawal and the specific time periods or conditions in which it will occur. The non-surface withdrawal shall not commence until the E&SC plan authority has approved these items, (b) The non-surface withdrawal has been reported as an anticipated bypass in accordance with Part III, Section C, Item (2)(c) and (d) of this permit,
- (c) Dewatering discharges are treated with controls to minimize discharges of pollutants from stormwater that is removed from the sediment basin. Examples of appropriate controls include properly sited, designed and maintained dewatering tanks, weir tanks, and filtration systems, (d) Vegetated, upland areas of the sites or a properly designed stone pad is used to the extent feasible at the outlet of the dewatering treatment devices described in Item (c) above,
- (e) Velocity dissipation devices such as check dams, sediment traps, and riprap are provided at the discharge points of all dewatering devices, and (f) Sediment removed from the dewatering treatment devices described in Item (c) above is disposed of in a manner that does not cause deposition of sediment into waters of the United States.

EFFECTIVE: 04/01/19

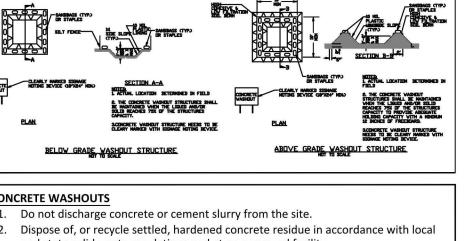

- and state solid waste regulations and at an approved facility.
- lot perimeter silt fence. Install temporary concrete washouts per local requirements, where applicable. If ar
- Do not use concrete washouts for dewatering or storing defective curb or sidewalk
- Locate washouts at least 50 feet from storm drain inlets and surface waters unless it
- entrance pad in front of the washout. Additional controls may be required by the
- products, follow manufacturer's instructions.
- caused by removal of washout.

- Store herbicides, pesticides and rodenticides in their original containers with the
- or surface water. If a spill occurs, clean area immediately. Do not stockpile these materials onsite.

HAZARDOUS AND TOXIC WASTE

EFFECTIVE: 04/01/19

SECTION C: REPORTING 1. Occurrences that Must be Reported Permittees shall report the following occurrences:

(a) Visible sediment deposition in a stream or wetland.

- (b) Oil spills if:
- . They are 25 gallons or more, They are less than 25 gallons but cannot be cleaned up within 24 hours,
- · They cause sheen on surface waters (regardless of volume), or . They are within 100 feet of surface waters (regardless of volume). (c) Releases of hazardous substances in excess of reportable quantities under Section 311

of the Clean Water Act (Ref: 40 CFR 110.3 and 40 CFR 117.3) or Section 102 of CERCLA

- (Ref: 40 CFR 302.4) or G.S. 143-215.85.
- (d) Anticipated bypasses and unanticipated bypasses (e) Noncompliance with the conditions of this permit that may endanger health or the

2. Reporting Timeframes and Other Requirements After a permittee becomes aware of an occurrence that must be reported, he shall contact the appropriate Division regional office within the timeframes and in accordance with the other requirements listed below. Occurrences outside normal business hours may also be

Reporting Timeframes (After Discovery) and Other Requirements

(a) Visible sediment deposition in a stream or wetland	 Within 24 hours, an oral or electronic notification. Within 7 calendar days, a report that contains a description of the sediment and actions taken to address the cause of the deposition. Division staff may waive the requirement for a written report on a case-by-case basis. If the stream is named on the NC 303(d) list as impaired for sediment-related causes, the permittee may be required to perform additional monitoring, inspections or apply more stringent practices if staff determine that additional requirements are needed to assure compliant with the federal or state impaired-waters conditions.
(b) Oil spills and release of hazardous substances per Item 1(b)-(c) above	 Within 24 hours, an oral or electronic notification. The notification shall include information about the date, time, nature, volume and location of the spill or release.
(c) Anticipated bypasses [40 CFR	 A report at least ten days before the date of the bypass, if possible. The report shall include an evaluation of the anticipated quality and

reported to the Department's Environmental Emergency Center personnel at (800)


- 122.41(m)(3)] effect of the bypass. (d) Unanticipated Within 24 hours, an oral or electronic notification bypasses [40 CFR Within 7 calendar days, a report that includes an evaluation of the 122.41(m)(3)] quality and effect of the bypass (e) Noncomplianc Within 24 hours, an oral or electronic notification
- with the condition Within 7 calendar days, a report that contains a description of the of this permit that noncompliance, and its causes: the period of noncompliance. including exact dates and times, and if the noncompliance has not may endanger health or the been corrected, the anticipated time noncompliance is expected to environment[40] continue; and steps taken or planned to reduce, eliminate, and CFR 122.41(I)(7)] prevent reoccurrence of the noncompliance. [40 CFR 122.41(I)(6).

case-by-case basis.

Division staff may waive the requirement for a written report on a



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20063

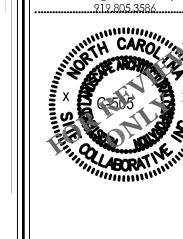PRO IFCT PHASE

10.06.2022

9.26.2022

CONSTRUCTION

DOCUMENTS

10.20.2022 11.11.2022 12.14.2022

AND EROSION CONTROL DETAILS

SEDIMENTATION

SEEDING FOR EROSION CONTROL AND PERMANENT SEEDING

- 1) CHISEL COMPACTED AREAS AND SPREAD TOPSOIL 4 INCHES DEEP OVER ADVERSE SOIL CONDITIONS.
- RIP THE ENTIRE AREA TO A 6-INCH DEPTH.
- REMOVE ALL LOOSE ROCKS, ROOTS, AND OTHER OBSTRUCTIONS LEAVING SURFACES REASONABLY SMOOTH AND UNIFORM.
- CONTINUE TILLAGE UNTIL A WELL PULVERIZED, FIRM, REASONABLY UNIFORM SEEDBED IS PREPARED 4-6 INCHES DEEP.
- SEED ON A FRESHLY PREPARED SEEDBED AND COVER SEED LIGHTLY WITH SEEDING EQUIPMENT OR CULTIPACK AFTER SEEDING.
- MULCH IMMEDIATELY AFTER SEEDING AND ANCHOR MULCH.
- INSPECT ALL SEEDED AREAS AND MAKE NECESSARY REPAIRS OR RESEEDING WITHIN THE PLANTING SEASON IF POSSIBLE. IF GRASS STAND SHOULD BE OVER 60% DAMAGED, REESTABLISH FOLLOWING ORIGINAL LIME, FERTILIZER, AND SEEDING RATES.
- CONSULT CONSERVATION INSPECTOR ON MAINTENANCE TREATMENT AND FERTILIZATION AFTER PERMANENT COVER IS ESTABLISHED.

	SEEDING SCHEDULE		
	MAXIMUM SLOPE 3:1		
SEEDING PERIOD	SEEDING TYPE	APPLICATION RATE (LBS/ACRE)	
AUGUST 15 - NOVEMBER 01	TALL FESCUE	300	
NOVEMBER 01 - MARCH 01	TALL FESCUE AND	300	
NOVEMBER UI - MARCH UI	ABRUZZI RYE	25	
MARCH 01 - APRIL 15	TALL FESCUE	300	
APRIL 15 - JUNE 30	HULLED COMMON BERMUDAGRASS	25	
	TALL FESCUE AND	120	
JULY 01 - AUGUST 15	*BROWNTOP MILLET OR	35	
	*SORGHUM-SUDAN HYBRIDS	30	
	SLOPES 2:1 TO 3:1		
MARCH 01 - JUNE 01	SERICEA LESPEDEZA (SCARIFIED) AND	50	
MARCH 01 - APRIL 15	TALL FESCUE OR	120	
MARCH 01 - JUNE 30	WEEPING LOVEGRASS OR	10	
MARCH UI - JUNE 30	HULLED COMMON BERMUDAGRASS	25	
	*TALL FESCUE AND	120	
JUNE 01 - SEPTEMBER 01	*BROWNTOP MILLET OR	35	
	*SORGHUM-SUDAN HYBRIDS	30	
SEPTEMBER 01 — MARCH 01	SERICEA LESPEDEZA (UNHULLED, USCARIFIED) AND	70	
	TALL FESCUE OR	120	
NOVEMBER 01 - MARCH 01	ABRUZZI RYE	25	

*TEMPORARY — RESEED ACCORDING TO OPTIMUM SEASON FOR DESIRED PERMANEN' VEGETATION. DO NOT ALLOW TEMPORARY COVER TO GROW OVER 12" IN HEIGHT BEFORE MOWING, OTHERWISE FESCUE MAY BE SHADED OUT. CONSULT CONSERVATION ENGINEER OR SOIL CONSERVATION SERVICE FOR ADDITIONAL INFORMATION CONCERNING OTHER ALTERNATIVES FOR VEGETATION OF DENUDED AREAS. THE ABOVE VEGETATION RATES ARE THOSE WHICH DO WELL UNDER LOCAL CONDITIONS; OTHER SEEDING RATE COMBINATIONS ARE POSSIBLE.

GROUND COVER - WHEREVER LAND DISTURBING ACTIVITY IS UNDERTAKEN ON A TRACT COMPRISING MORE THAN ONE (1) ACRE, A GROUND COVER SUFFICIENT TO RESTRAIN EROSION MUST BE PLANTED OR PROVIDED WITHIN 15 WORKING DAYS OR 90 CALENDAR DAYS. GRADED SLOPES AND FILLS - WITHIN 15 WORKING DAYS OR 30 CALENDAR DAYS, OR

COMPLETION OF ANY PHASE OF GRADING, WHICHEVER PERIOD IS SHORTER, SLOPES SHALL BE


PLANTED OR OTHERWISE PROVIDED WITH GROUND COVER, DEVICES, OR STRUCTURES

SUFFICIENT TO RESTRAIN EROSION. TOWN OF KNIGHTDALE




REF. 2.01

- 1. NCDOT # 5 OR #57 WASHED STONE SHALL BE USED. PAD TO BE 50'L X 20'W X 6" D AT A MINIMUM.
- 2. TURNING RADIUS SUFFICIENT TO ACCOMMODATE LARGE TRUCKS IS TO BE PROVIDED.
- 3. ENTRANCE(S) SHOULD BE LOCATED TO PROVIDE FOR MAXIMUM UTILITY BY ALL CONSTRUCTION VEHICLES.
- 4. MUST BE MAINTAINED IN A CONDITION WHICH WILL PREVENT TRACKING OR DIRECT FLOW OF MUD ONTO STREETS. PERIODIC TOPDRESSING WITH STONE WILL BE NECESSARY; KEEP SOME HANDY.
- 5. ANY MATERIAL WHICH STILL MAKES IT ONTO THE ROAD MUST BE CLEANED UP IMMEDIATELY.

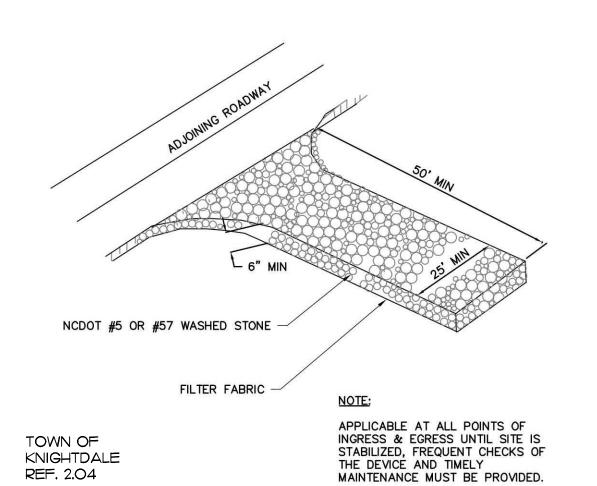

CONSTRUCTION ENTRY SCALE: NOT TO SCALE

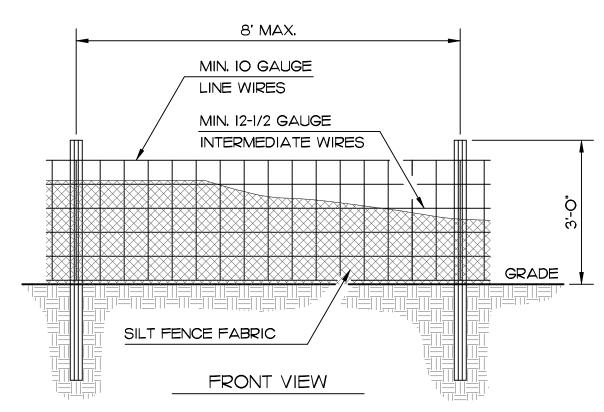


NOTES 1) FENCE FABRIC SHALL BE A MINIMUM OF 32" IN WIDTH AND HAVE A MINIMUM OF 6 LINE WIRES WITH 12" STAY SPACING.

2) SILT FENCE FABRIC SHALL BE A MINIMUM OF 32" IN WIDTH AND SHALL BE STAPLED OR WIRED TO THE FENCE. 3) STEEL POSTS SHALL BE 5'-O" IN HEIGHT AND SHALL BE OF


THE SELF-FASTENER ANGLE


4) INSPECTIONS SHALL BE MADE AFTER EACH RAINFALL AND SEDIMENT DEPOSITS REMOVED WHEN THEY REACH 1/3 THE HEIGHT OF THE FENCE.

STEEL TYPE

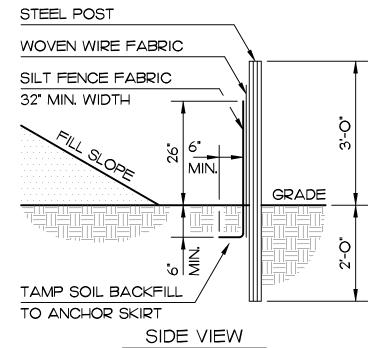



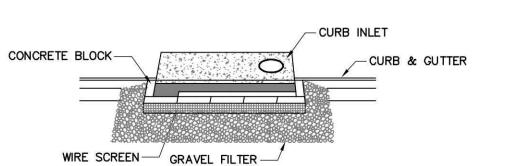

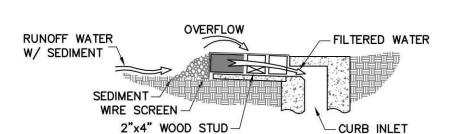

BLOCK & GRAVEL CURB INLET SEDIMENT FILTER

SPECIFIC APPLICATION:

TOWN OF

REF. 2.08


KNIGHTDALE

THIS METHOD OF INLET PROTECTION IS APPLICABLE AT CURB INLETS WHERE AN OVERFLOW CAPABILITY IS NECESSARY TO PREVENT EXCESSIVE PONDING IN FRONT OF THE STRUCTURE.


MAINTENANCE:

- 1. THE STRUCTURE SHALL BE INSPECTED AFTER EACH RAIN AND REPAIRS MADE AS NEEDED.
- 2. SEDIMENT SHALL BE REMOVED AND THE TRAP RESTORED TO ITS ORIGINAL DIMENSIONS WHEN THE SEDIMENT HAS ACCUMULATED TO 1/2 THE DESIGN DEPTH OF THE TRAP.
- 3. REMOVED SEDIMENT SHALL BE DEPOSITED IN A SUITABLE AREA AND IN SUCH A MANNER THAT IT WILL NOT ERODE.
 - 4. STRUCTURES SHALL BE REMOVED AND THE AREA STABILIZED WHEN THE REMAINING DRAINAGE AREA HAS BEEN PROPERLY STABILIZED.




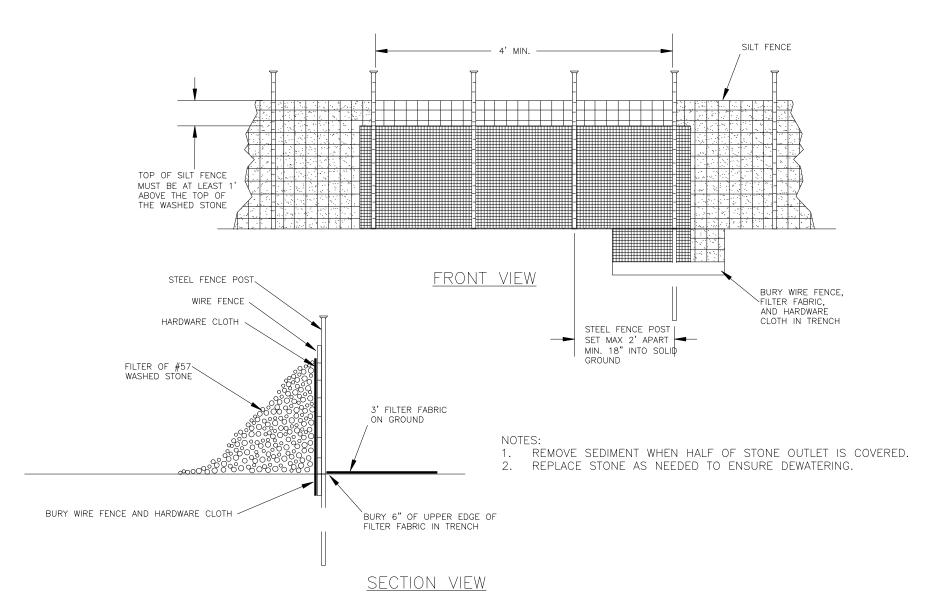

STANDARD SILT FENCE OUTLET NOT TO SCALE

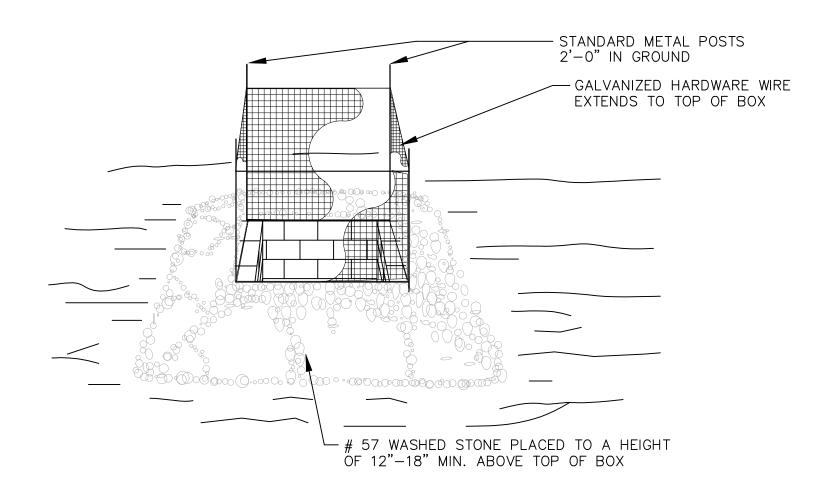


STANDARD INLET PROTECTION NOT TO SCALE

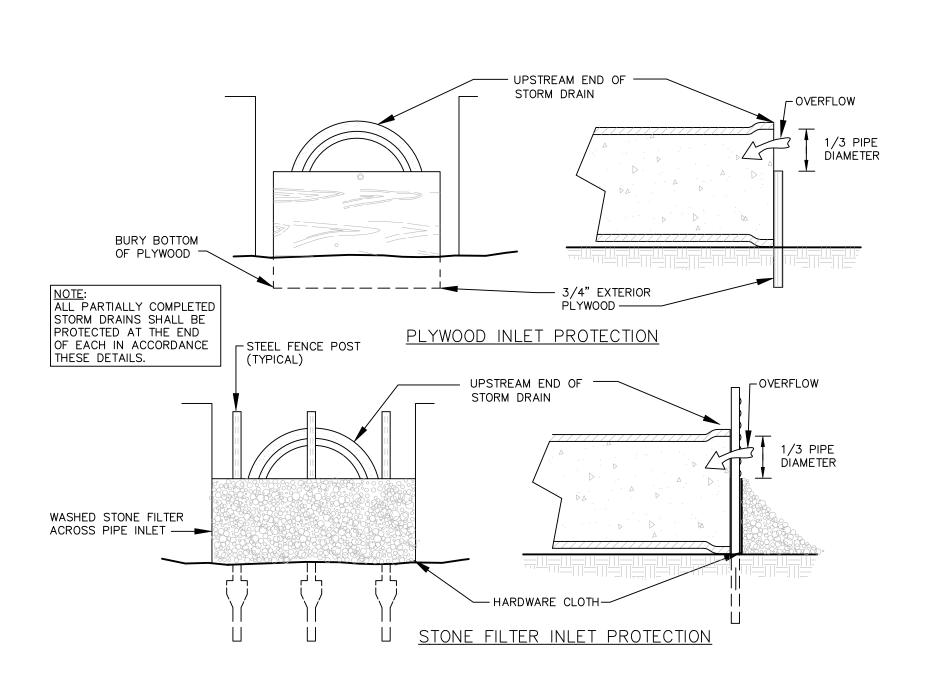



LANDSCAPE ARCHITECTURI 821 Wake Forest Road Raleigh, NC 27604

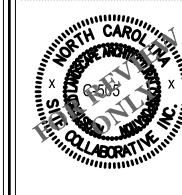

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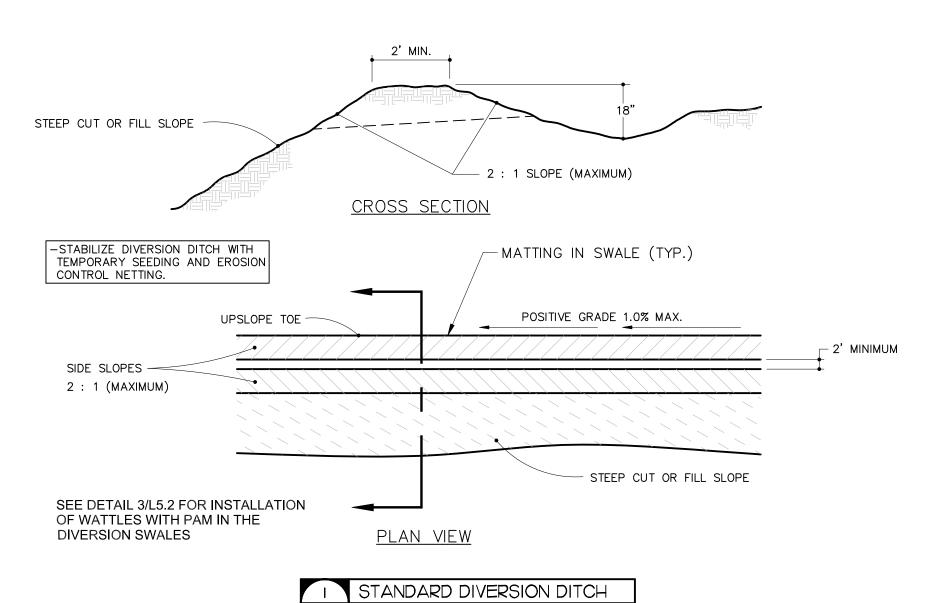
PROJECT NUMBER: 20063 PRO IFOT PHASE. CONSTRUCTION **DOCUMENTS**


10.06.2022 9.26.2022 10.20.2022 11.11.2022 12.14.2022

SEDIMENTATION AND EROSION CONTROL DETAILS


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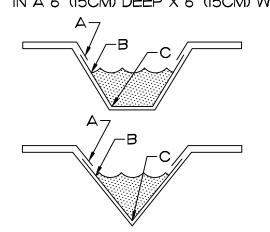




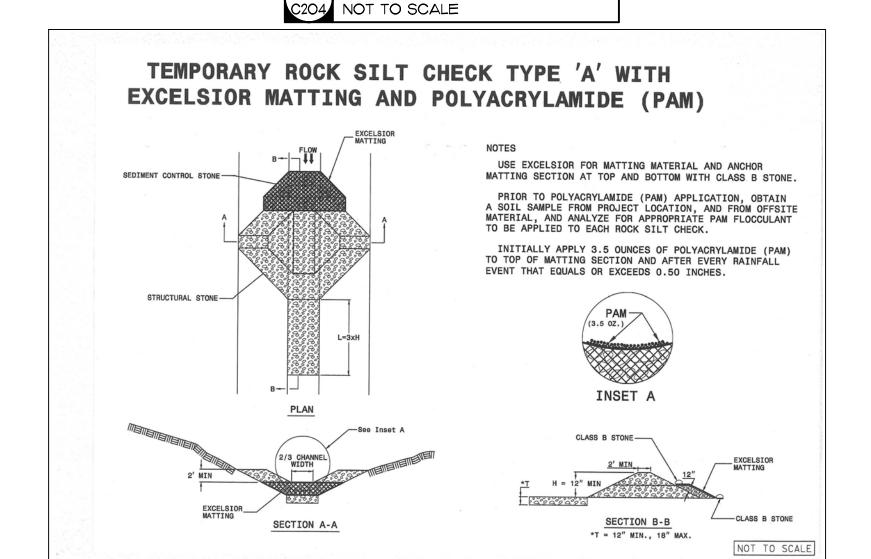

- I. PREPARE SOIL BEFORE INSTALLING BLANKETS, INCLUDING ANY NECESSARY APPLICATION OF LIME, FERTILIZER, AND SEED.
- 2. BEGIN AT THE TOP OF THE CHANNEL BY ANCHORING THE BLANKET IN A 6" (15CM) DEEP X 6" (15CM) WIDE TRENCH WITH APPROXIMATELY 12" (30CM) OF BLANKET EXTENDED BEYOND THE UP-SLOPE PORTION OF THE TRENCH. ANCHOR THE BLANKET WITH A ROW OF STAPLES/STAKES APPROXIMATELY 12" (30CM) APART IN THE BOTTOM OF THE TRENCH. BACKFILL AND COMPACT THE TRENCH AFTER STAPLING. APPLY SEED TO COMPACTED SOIL AND FOLD REMAINING 12" (30CM) PORTION OF BLANKET BACK OVER SEED AND COMPACTED SOIL. SECURE BLANKET OVER COMPACTED SOIL WITH A ROW OF STAPLES/STAKES SPACED APPROXIMATELY 12" (30CM) APART ACROSS THE WIDTH OF THE BLANKET.
- 3. ROLL CENTER BLANKET IN DIRECTION OF WATER FLOW IN BOTTOM OF CHANNEL. BLANKETS WILL UNROLL WITH APPROPRIATE SIDE AGAINST THE SOIL SURFACE. ALL BLANKETS MUST BE SECURELY FASTENED TO SOIL SURFACE BY PLACING STAPLES/STAKES IN APPROPRIATE LOCATIONS AS SHOWN IN THE STAPLE PATTERN GUIDE. WHEN USING OPTIONAL DOT SYSTEM, STAPLES/STAKES SHOULD BE PLACED THROUGH EACH OF THE COLORED DOTS CORRESPONDING TO THE APPROPRIATE STAPLE PATTERN.
- 4. PLACE CONSECUTIVE BLANKETS END OVER END (SHINGLE STYLE) WITH A 4"-6" (IOCM-15CM) OVERLAP. USE A DOUBLE ROW OF STAPLES STAGGERED 4" (IOCM) APART AND 4" (IOCM) ON CENTER TO SECURE BLANKETS.
- 5. FULL LENGTH EDGE OF BLANKETS AT TOP OF SIDE SLOPES MUST BE ANCHORED WITH A ROW OF STAPLES/STAKES APPROXIMATELY I2" (30CM) APART IN A 6" (15CM) DEEP X 6" (15CM) WIDE TRENCH. BACKFILL AND COMPACT THE TRENCH AFTER STAPLING.
- 6. ADJACENT BLANKETS MUST BE OVERLAPPED APPROXIMATELY 2"-5" (5CM-12.5CM) (DEPENDING ON BLANKET TYPE) AND STAPLED.

 TO ENSURE PROPER SEAM ALIGNMENT, PLACE THE EDGE OF THE OVERLAPPING BLANKET (BLANKET BEING INSTALLED ON TOP) EVEN WITH THE COLORED SEAM STITCH ON THE BLANKET BEING OVERLAPPED.
- 7. IN HIGH FLOW CHANNEL APPLICATIONS, A STAPLE CHECK SLOT IS RECOMMENDED AT 30 TO 40 FOOT (9M-12M) INTERVALS. USE A DOUBLE ROW OF STAPLES STAGGERED 4" (IOCM) APART AND 4" (IOCM) ON CENTER OVER ENTIRE WIDTH OF THE CHANNEL.
- 8. THE TERMINAL END OF THE BLANKETS MUST BE ANCHORED WITH A ROW OF STAPLES/STAKES APPROXIMATELY 12" (30CM) APART IN A 6" (15CM) DEEP X 6" (15CM) WIDE TRENCH. BACKFILL AND COMPACT THE TRENCH AFTER STAPLING.

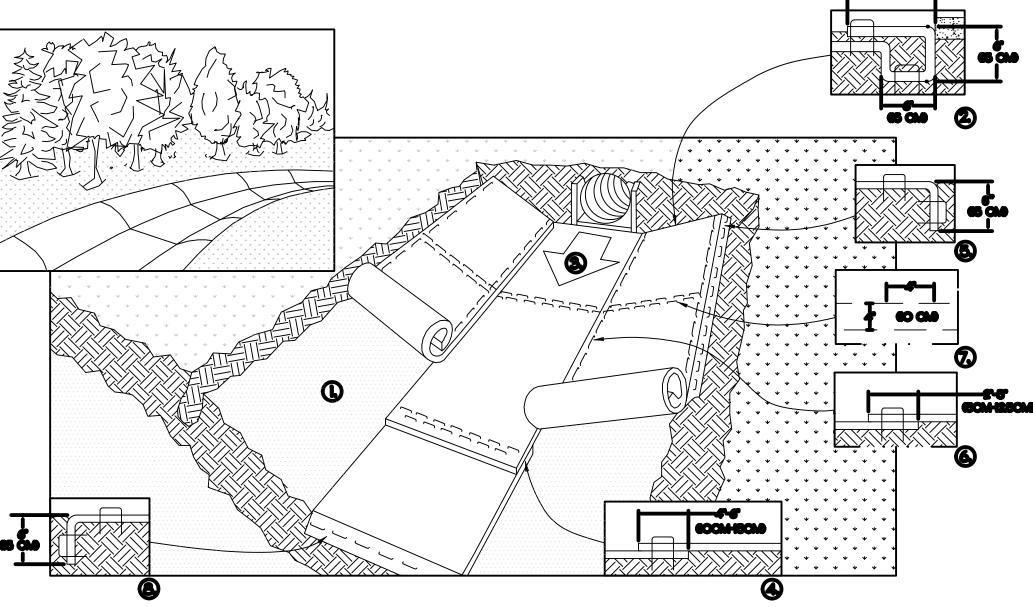

CRITICAL POINTS

A. OVERLAPS AND SEAMS
B. PROJECTED WATER LINE
C. CHANNEL BOTTOM/SIDE
SLOPE VERTICES

- * HORIZONTAL STAPLE SPACING SHOULD BE ALTERED IF NECESSARY TO ALLOW STAPLES TO SECURE THE CRITICAL POINTS ALONG THE CHANNEL SURFACE.
 - ** IN LOOSE SOIL CONDITIONS, THE USE OF STAPLE OR STAKE LENGTHS GREATER THAN 6" (15 CM) MAY BE NECESSARY TO PROPERLY ANCHOR THE BLANKETS.



The long-term double net 100% biodegradable erosion control blanket shall be a machine-produced mat of coconut fiber with a functional longevity up to 24 months. The blanket shall be of consistent thickness with the coconut evenly distributed over the entire area of the mat. The blanket shall be covered on the top and bottom sides with 100% biodegradable woven, natural, organic fiber netting. The top netting shall consist of machine directional strands from from two intertwined yarns with cross directional strands (commonly referred to as a Leno weave) to form an approximate 0.50 x 1.00 (1.27 x 2.54 cm) mesh. The blanket shall be sewn together on 1.50 inch (3.81 cm) centers with

The blanket shall meet requirements established by the Erosion Control Technology Council (ECTC) Specification and the US Dept. of Transportation, Federal Highway Administration's (FHWA) Standard Specifications for Construction of Roads and Bridges on Federal Highway Projects, FP-03 Section 713.17 as a type 4 Long Term Erosion Control Blanket.

Installation staple patterns shall be clearly marked on the blanket with environmentally safe paint. The blanket shall be manufactured with a colored thread stitched along both outer edges (approximately 2-5 inches [5-12.5 cm] from the edge) as an overlap guide for adjacent mats

TOWN CERTIFICATION.

CONSTRUCTION PLANS FOR THIS

LAND USE ADMINISTRATOR

KNIGHTDALE.

PROJECT.

THIS DESIGN HAS BEEN REVIEWED BY THE ENGINEER FOR THE TOWN OF

KNIGHTDALE, AND TO THE BEST OF MY KNOWLEDGE AND BELIEF, IT CONFORMS TO THE REQUIREMENTS ESTABLISHED IN THE STANDARD SPECIFICATIONS OF THE TOWN OF

._____ DATE: _____

THESE PLANS ARE APPROVED BY THE TOWN OF KNIGHTDALE AND SERVE AS

Matrix: 100% Coconut fibers; 0.5 lbs/syd (0.27 kg/sm)


Nettings: Top - Leno woven 100% biodegradable organic jute fiber; 9.3 lb/1000 sf (4.5 kg/100 sm)

Bottom - 100% biodegradable organic jute fiber; 7.7 lb/1000sf (376 kg/100 sm)

Thread: Biodegradable

nch & Associates 19 North Boylan Avenu 1eigh, NC 27603-140 919 | 833-1212 919 | 834-3203

COLLABORATIVE
LANDSCAPE ARCHITECTURI
821 Wake Forest Road

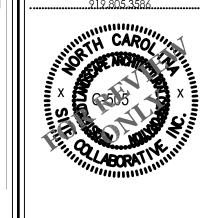

Raleigh, NC 27604

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Collaborative Inc.

Wake Veterinary Hospita Rowdy Ridegbacks Holdings LLC 1007 Tandal Place, Knightdale, N

PROJECT NUMBE
20063
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PROJECT PHASE: CONSTRUCTION DOCUMENTS


10.06.2022


9.26.2022 10.20.2022 11.11.2022 12.14.2022

SHEET TITLE:
SEDIMENTATION
AND EROSION
CONTROL DETAILS

SHEET NUMBER:


C204

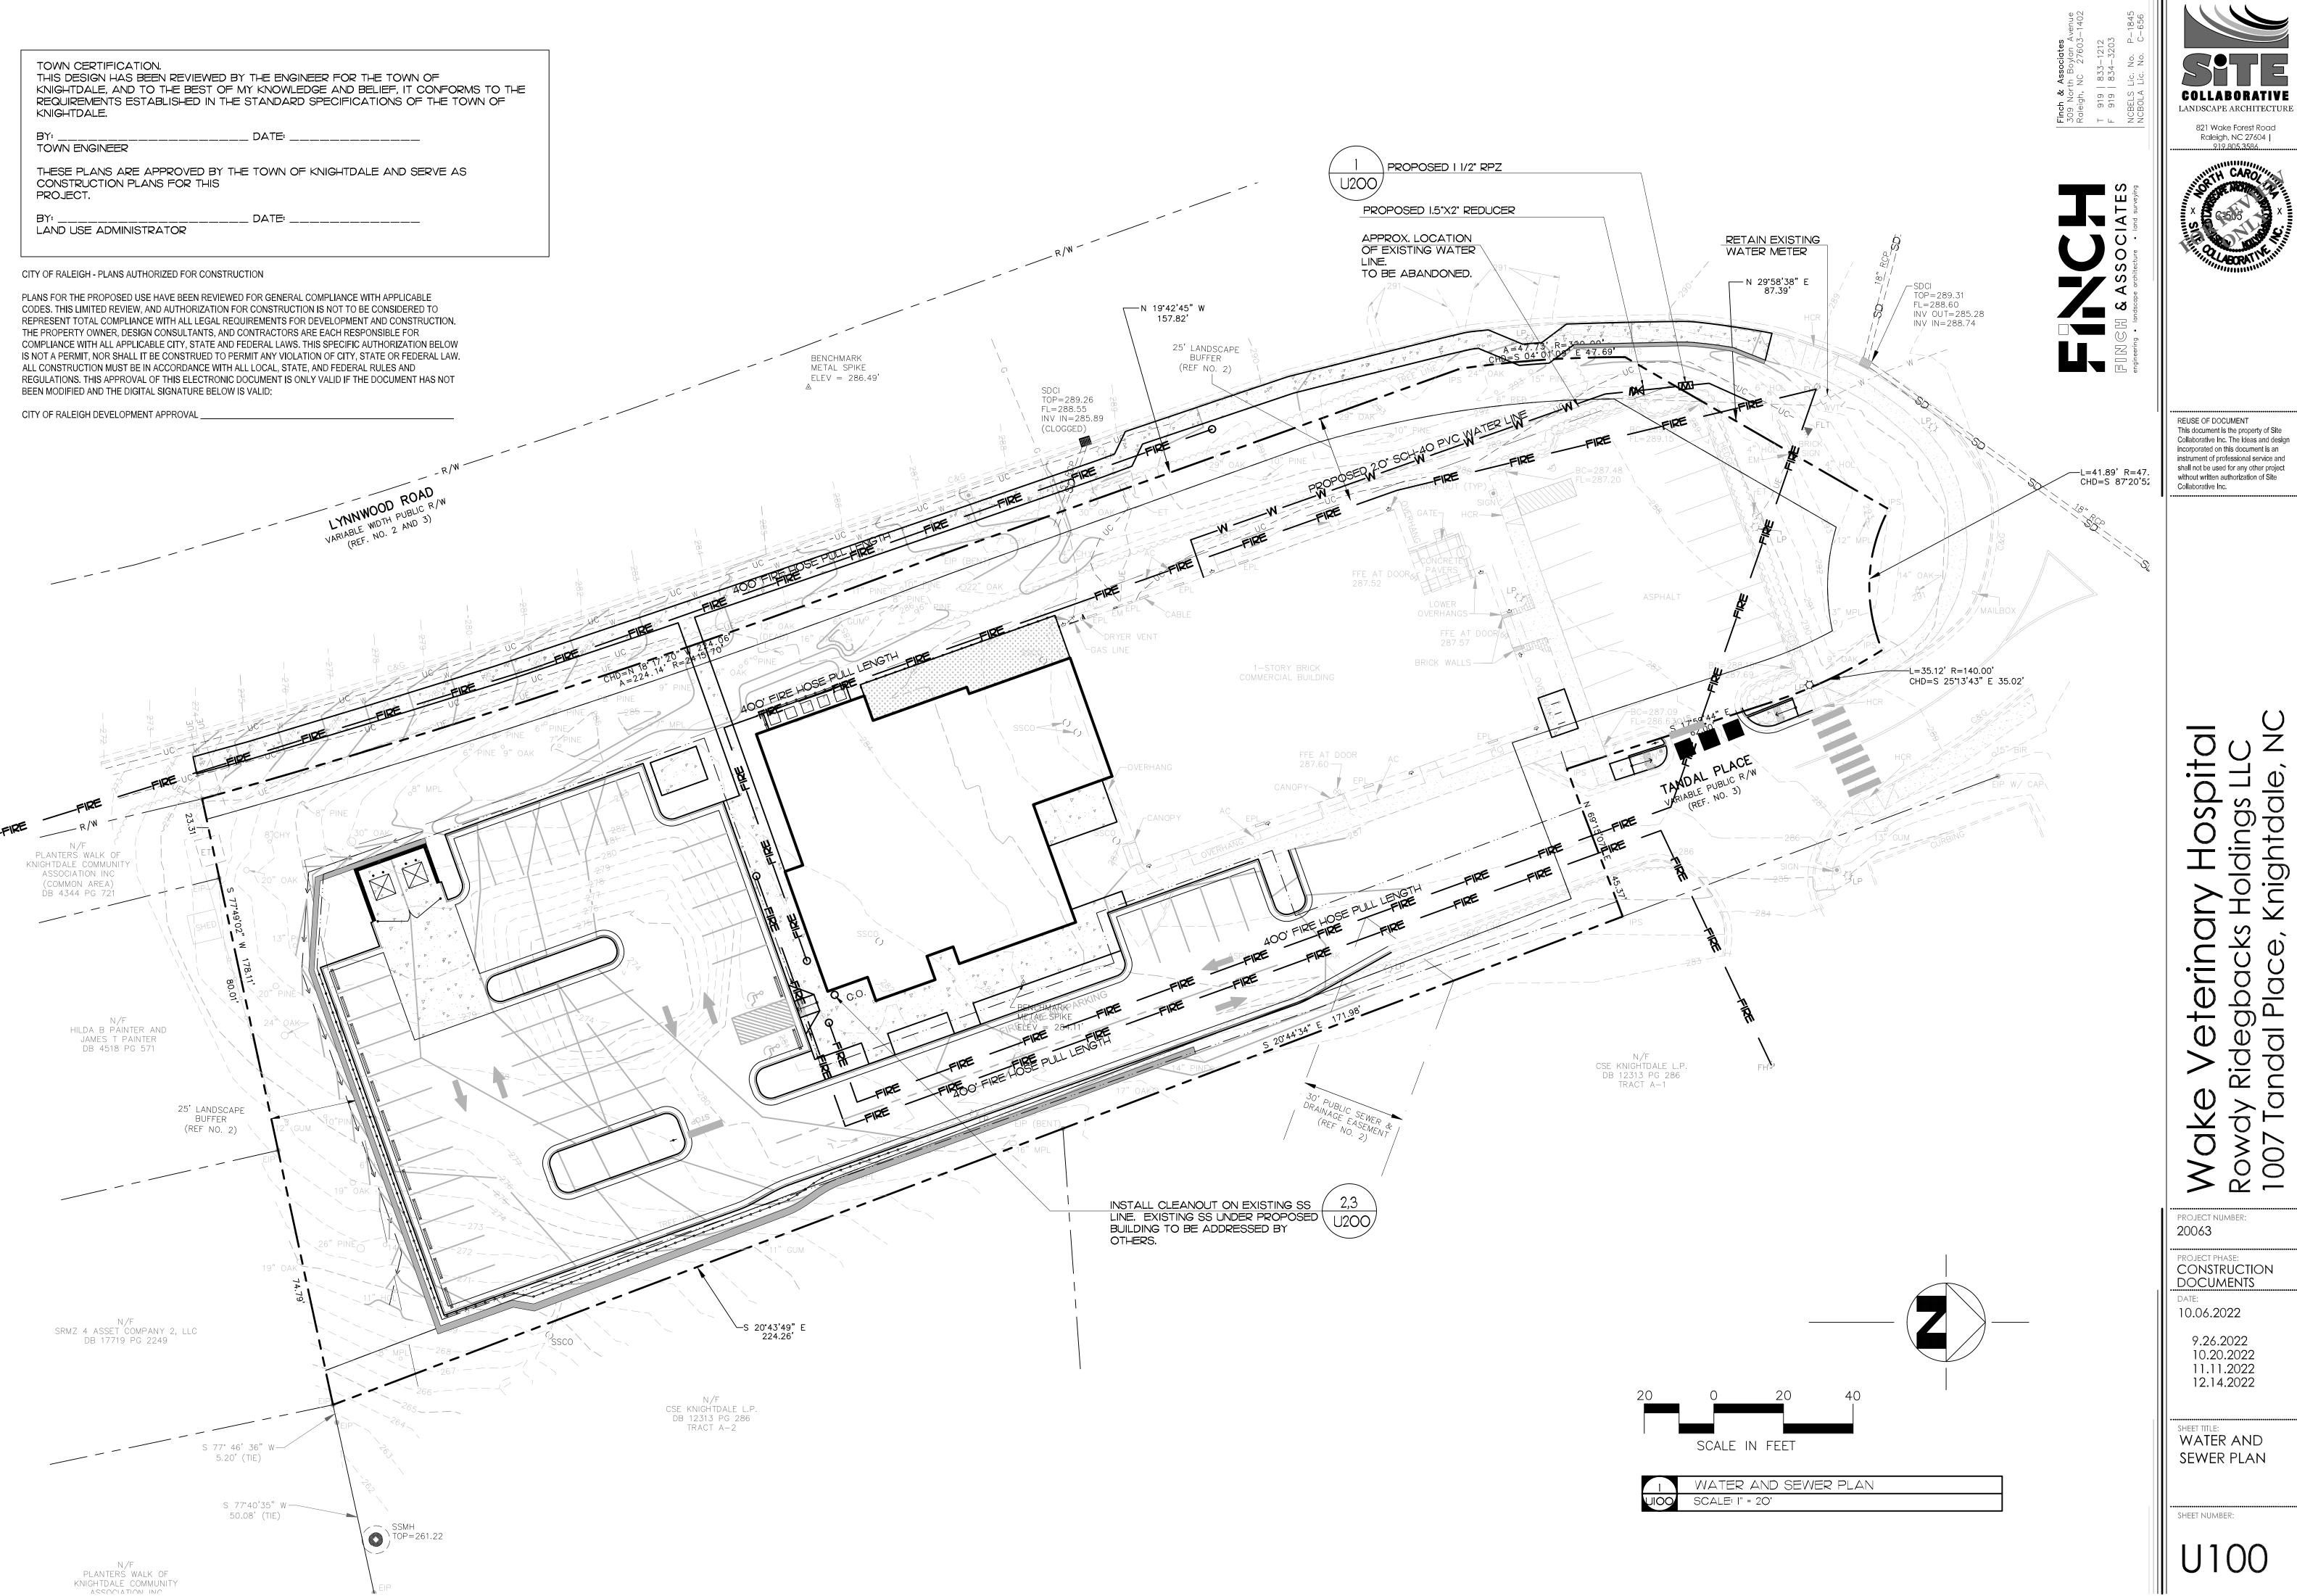

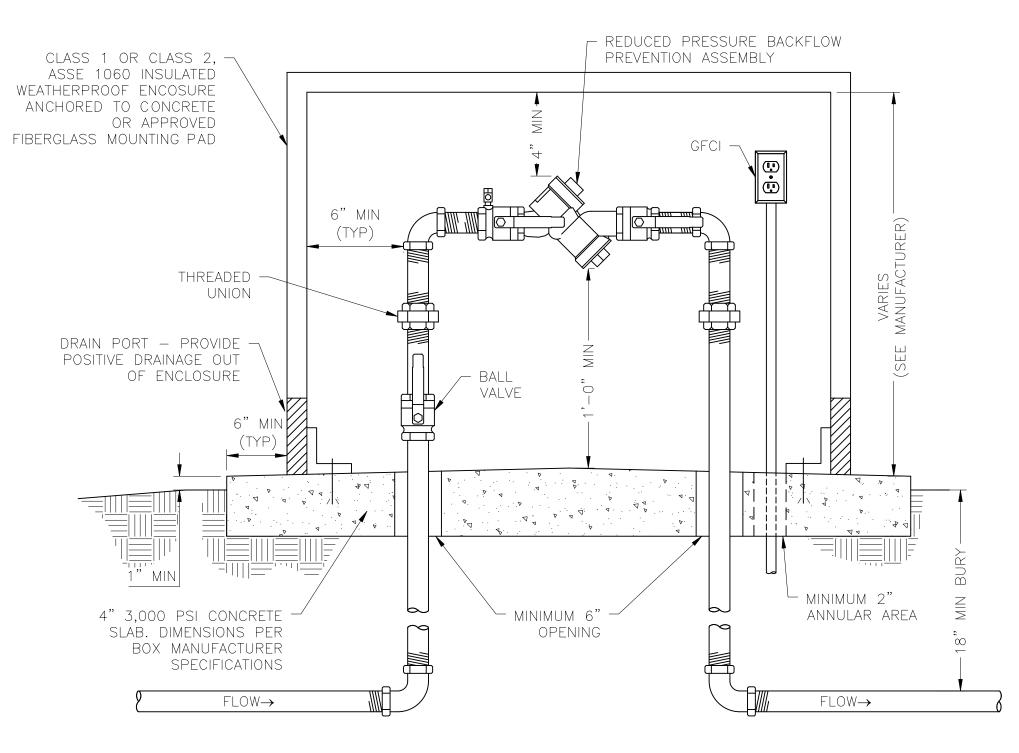


RPZ BACKFLOW PREVENTER SCALE: NOT TO SCALE


- I. REDUCED PRESSURE PRINCIPLE BACKFLOW PREVENTION ASSEMBLY SHALL COMPLY WITH ASSE 1013 & AWWA C511.
- 2. BACKFLOW PREVENTION ASSEMBLIES SHALL BE REDUCED PRESSURE PRINCIPLE TYPE FOR PROPOSED INSTALLATION. BACKFLOW PREVENTION ASSEMBLIES SHALL BE MANUFACTURED IN CONFORMANCE WITH AWWA C 511 (REDUCED PRESSURE) AND SHALL BE APPROVED BY THE FOUNDATION FOR CROSS-CONNECTION CONTROL AND HYDRAULIC RESEARCH, UNIV. OF SOUTHERN CALIFORNIA AND NCDENR, DIVISION OF ENVIRONMENTAL HEALTH. USE A FEBCO 1.5" LF860U OR SIMILAR PRODUCT.
- 3. BACKFLOW PREVENTION ASSEMBLY SHALL BE INSTALLED WITHIN 50-FT OF THE METER. 4. BACKFLOW ASSEMBLY SHALL BE CENTERED ON
- CONCRETE OR OTHER APPROVED MOUNTING PAD AND CENTERED WITHIN ENCLOSURE. 5. MINIMUM INSULATED CLASS I OR CLASS II, ASSE 1060 WEATHERPROOF ENCLOSURE REQUIRED.
- 6. I2O V GFCI ELECTRICAL RECEPTACLE TO BE INSTALLED IN ACCORDANCE WITH THE N.C. ELECTRICAL CODE FOR OUTDOOR OPERATION. 7. PIPE MATERIAL SHALL BE PVC (SCH. 80 OR
- BETTER), COPPER (TYPE K), OR BRASS (ASTM B43). 8. IRRIGATION ASSEMBLIES TO BE DRAINED DURING
- WINTER MONTHS BY PROPERTY OWNER. 9. INSTALLATION SHALL BE IN COMPLIANCE WITH ALL APPLICABLE SPECIFICATIONS IN ADDITION TO THE N.C. PLUMBING CODE.
- IO. INSTALL HEATER AS RECOMMENDED BY MANUFACTURER>

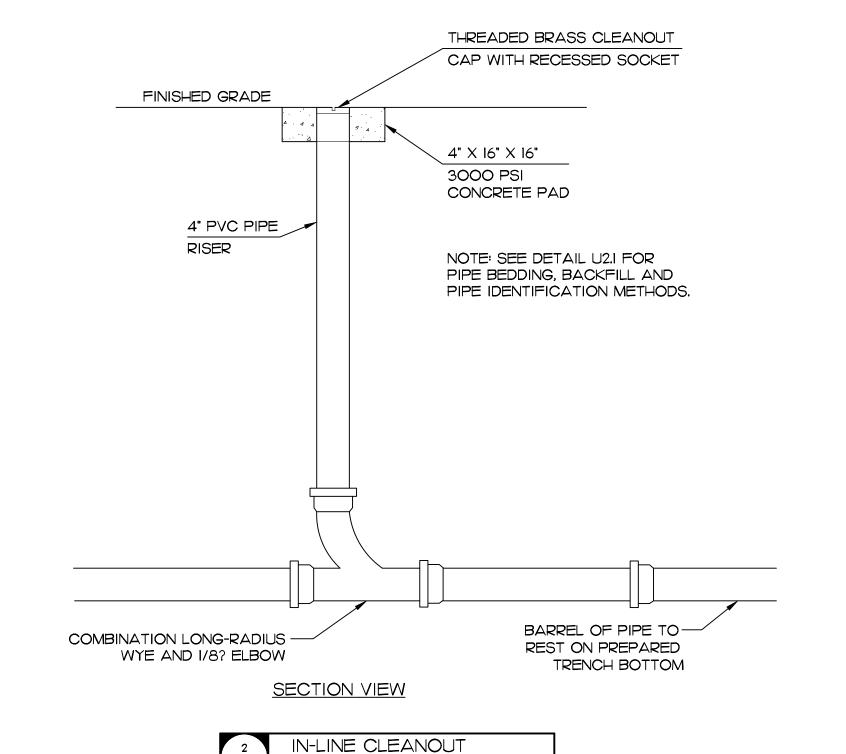


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NOTE: 1'x 1'x 6" CONCRETE PAD

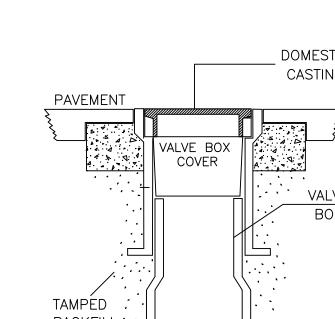

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COLLABORATIVE

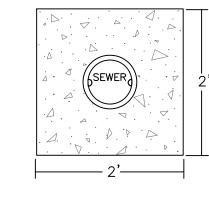LANDSCAPE ARCHITECTURE

821 Wake Forest Road Raleigh, NC 27604
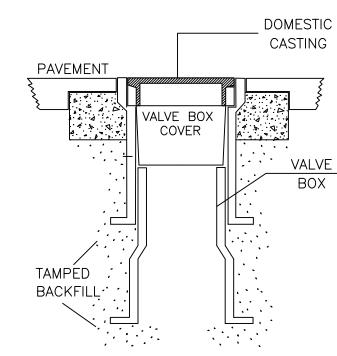
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PROJECT NUMBER:

20063 CONSTRUCTION

DOCUMENTS

10.06.2022 9.26.2022 10.20.2022

11.11.2022

12.14.2022

WATER AND

SEWER DETAILS

SHEET NUMBER:

TOWN CERTIFICATION. THIS DESIGN HAS BEEN REVIEWED BY THE ENGINEER FOR THE TOWN OF KNIGHTDALE, AND TO THE BEST OF MY KNOWLEDGE AND BELIEF, IT CONFORMS TO THE REQUIREMENTS ESTABLISHED IN THE STANDARD SPECIFICATIONS OF THE TOWN OF KNIGHTDALE.

TOWN ENGINEER


THESE PLANS ARE APPROVED BY THE TOWN OF KNIGHTDALE AND SERVE AS CONSTRUCTION PLANS FOR THIS PROJECT.

LAND USE ADMINISTRATOR

CITY OF RALEIGH - PLANS AUTHORIZED FOR CONSTRUCTION

PLANS FOR THE PROPOSED USE HAVE BEEN REVIEWED FOR GENERAL COMPLIANCE WITH APPLICABLE CODES. THIS LIMITED REVIEW, AND AUTHORIZATION FOR CONSTRUCTION IS NOT TO BE CONSIDERED TO REPRESENT TOTAL COMPLIANCE WITH ALL LEGAL REQUIREMENTS FOR DEVELOPMENT AND CONSTRUCTION. THE PROPERTY OWNER, DESIGN CONSULTANTS, AND CONTRACTORS ARE EACH RESPONSIBLE FOR COMPLIANCE WITH ALL APPLICABLE CITY, STATE AND FEDERAL LAWS. THIS SPECIFIC AUTHORIZATION BELOW IS NOT A PERMIT, NOR SHALL IT BE CONSTRUED TO PERMIT ANY VIOLATION OF CITY, STATE OR FEDERAL LAW. ALL CONSTRUCTION MUST BE IN ACCORDANCE WITH ALL LOCAL, STATE, AND FEDERAL RULES AND REGULATIONS. THIS APPROVAL OF THIS ELECTRONIC DOCUMENT IS ONLY VALID IF THE DOCUMENT HAS NOT BEEN MODIFIED AND THE DIGITAL SIGNATURE BELOW IS VALID:

CITY OF RALEIGH DEVELOPMENT APPROVAL

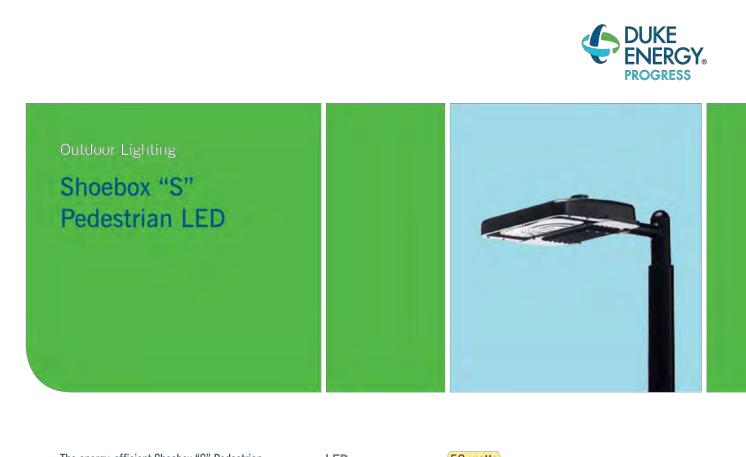

The energy-efficient Shoebox "S" Pedestrian LED combines a decorative, contemporary style is perfect for streets, parking lots, commercial ouildings and residential communities. The Shoebox "S" Pedestrian LED provides excellent color rendition along with a controlled light pattern that reduces glare and keeps the light directed only where you want it.

50 watts (Light Emitting Diode) 12', 13', <mark>16'</mark> Black Color Smooth round concrete Fluted concrete Poles Fiberglass Decorative aluminum Neighborhoods **Applications** Shopping centers

duke-energy.com/OutdoorLighting or call us toll free at 866.769.6417



Shoebox "S" Pedestrian LED

Light source: LED (white) Wattage: 50 Lumens: 3,730


Color temperature: 4,000K

2015 Duke Energy Corporation 151307 7/15

REV# DATE

Rev A | 06/21/22 | Pedestrian Shoebox

Light pattern: IESNA Type III (oval) IESNA Backlight - Uplight - Glare (BUG) Rating: B1-U0-G1

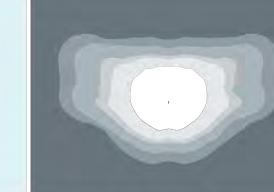

REVISION

light distribution pattern

Poles available:			
Name	Mounting height	Color	
Fiberglass	16'	Black	
Style V	12', 16'	Black	
Style VI	12'	Black	
Style VII	13'	Black	

Features	Benefits
Little or no installation cost	Frees up capital for other projects
Design services by lighting professionals included	Meets industry standards and lighting ordinances
Maintenance included	Eliminates high and unexpected repair bills
Electricity included	Less expensive than metered service
Warranty included	Worry-free
One low monthly cost on your electric bill	Convenience and savings for you
Turnkey operation	Provides hassle-free installation and service
Backed by over 40 years of experience	A name you can trust today and tomorrow

Statistics						
Description	Symbol	Avg	Max	Min	Max/Min	Avg/Min
New Parking	x	1.6 fc	4.3 fc	0.6 fc	7.2:1	2.7:1

Symbol	Label	Quantity	Description	Number Lamps	Lumens Per Lamp	Light Loss Factor
•	А	3	Existing 50w Shoebox - Type IV - 3000K	16	382	0.85
•	В	1	Exisiting 150w Roadway - Type III - 4000K	1	19201	0.85
X	С	2	Proposed 50w Shoebox - Type IV - 3000K	16	382	0.85
¥	D	3	Proposed 50w Shoebox - Type IV - 3000K	16	382	0.85

Customer approval

NJ

BY

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to the best of my knowledge and belief, it conforms to the requirements established in the Standard Specifications of the Town of Knightdale. Town Engineer These plans are approved by the Town of Knightdale and serve as construction plans for this project. Land Use Administrator

**O.O 0 7.6 2.5 [†]2 4 [†]2.3 [†]2.0 [†]1,3 [†]0.8 [†]0.4 [†]0.1 [†]0.1 [†]0.0 **\dots \forall 0.0 \quad \quad 0.0 \quad \forall 0.0 \quad \foral **O.O **\bigsign = \frac{1}{2} \text{.0} \frac{1}{

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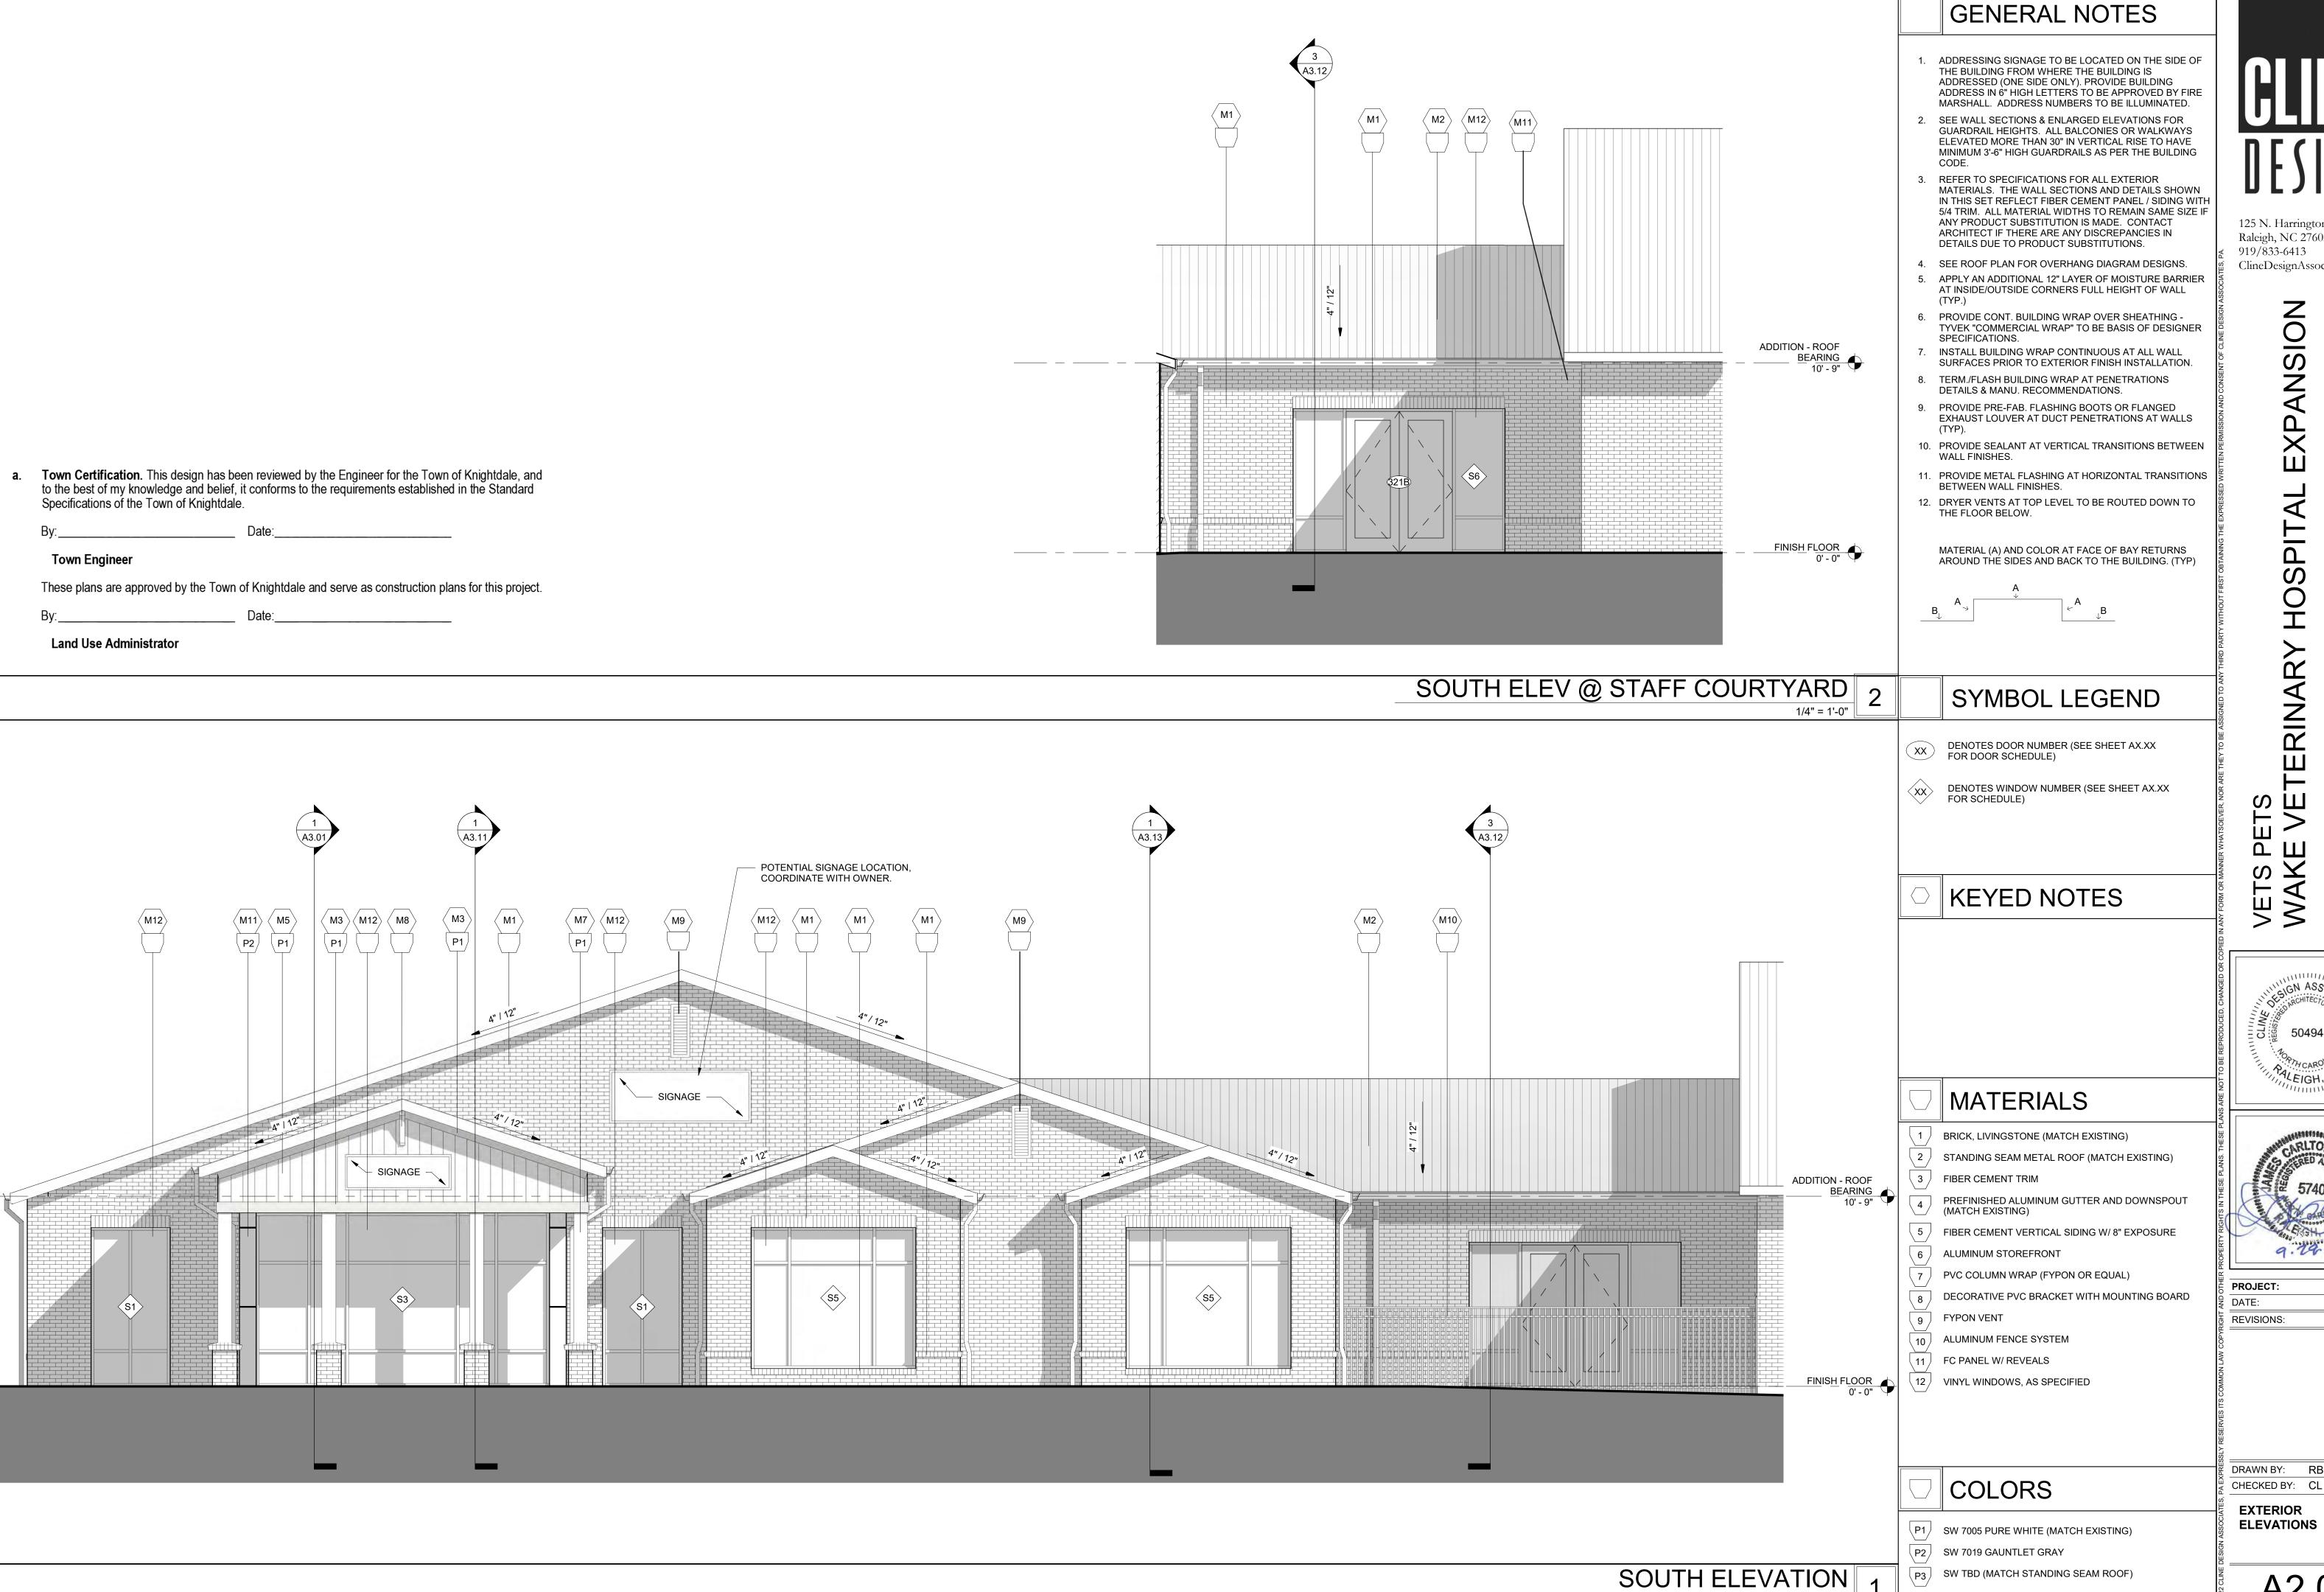
PROGRESS

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unauthorized use of or reliance on this document.

1007 TANDAL PLACE Knightdale, NC SITE LIGHTING PLAN Designed by <u>DEP LIGHTING SOLUTIONS</u> _Scale ___1" = 30'_ Reviewed by _Size <u>"Arch D"</u> Date __06/21/2022 Description <u>LED 50w Shoebox</u> Sht. 1 OF 1 22-0228A Drawing No.₋

				LIGHTING DESIGN TOL
				†0 0 †0 0 †0 0 †0 0 †0 0 †0 0
v - 3000K	10	302	0.65	[†] 0.0 [†] 0.0 [†] 0.0 [†] 0.0 [†] 0.0
V - 3000K	16	382	0.85	[†] 0.0 [†] 0.0 [†] 0.0 [†] 0.0 [†] 0.0
V - 3000K	16	382	0.85	†0.0 †0.0 †0.0 †0.0 †0.0
				[†] 0.0 [†] 0.0 [†] 0.0 [†] 0.0 [†] 0.0



125 N. Harrington St. Raleigh, NC 27603

XPANSION

HOSPIT

919/833-6413 ClineDesignAssoc.com


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DATE

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125 N. Harrington St. Raleigh, NC 27603 919/833-6413

XPANSION

HOSPIT

R
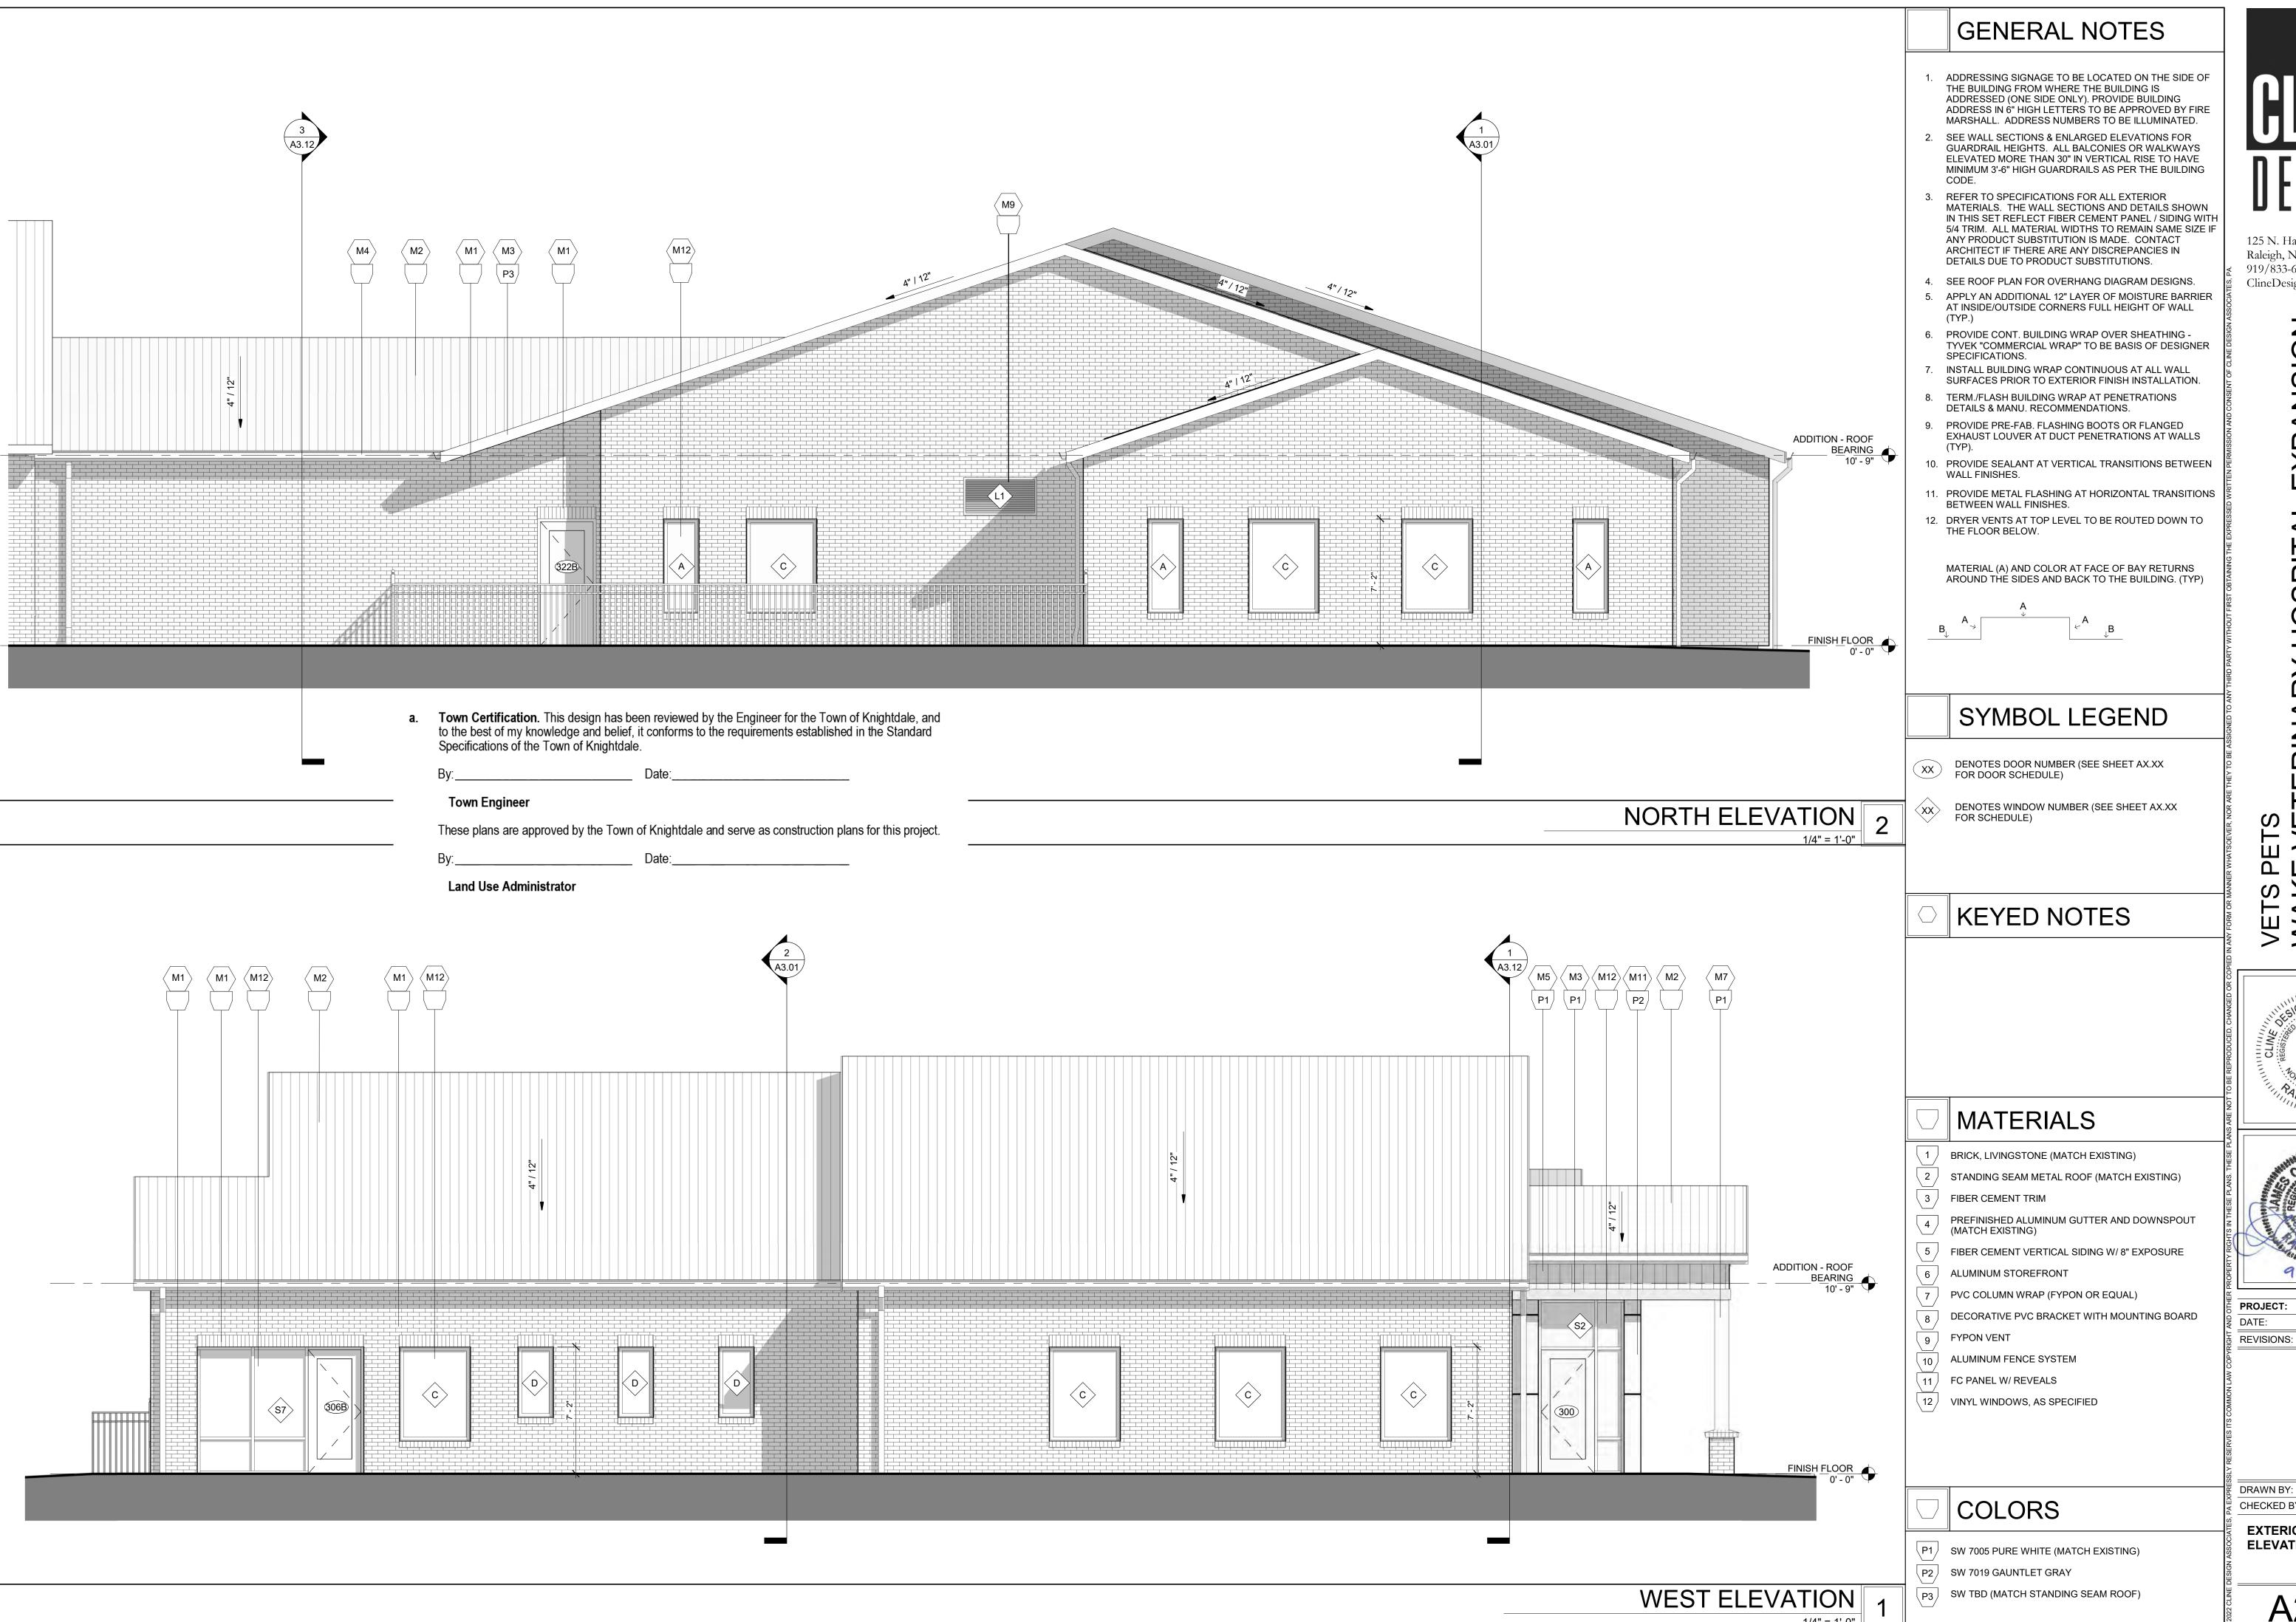
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020156

09.29.22

DATE

DRAWN BY: CHECKED BY: CL

EXTERIOR ELEVATIONS

A2.02

a. Town Certification. This design has been reviewed by the Engineer for the Town of Knightdale, and to the best of my knowledge and belief, it conforms to the requirements established in the Standard Specifications of the Town of Knightdale.

_____ Date:____

Town Engineer

These plans are approved by the Town of Knightdale and serve as construction plans for this project.

By:_____ Date:____

Land Use Administrator



BUILDING SECTION A 1

1 A3.

CLINE DESIGN

125 N. Harrington St. Raleigh, NC 27603 919/833-6413 ClineDesignAssoc.com

RINARY HOSPITAL EXPANSION

MA

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 PROJECT:
 020156

 DATE:
 09.29.22

 REVISIONS:
 DATE

DRAWN BY: RB
CHECKED BY: CL

BUILDING SECTIONS

A3.01