# **CONSTRUCTION DRAWINGS FOR KNIGHTDALE STATION** R6D AND R4 KNIGHTDALE, WAKE COUNTY, NORTH CAROLINA AUGUST 31, 2018

SITE DATA TABLE - PH	ASE R6D	AND R4
TOTAL PHASE AREA RECREATIONAL OPEN SPACE (ACTIVE) RECREATIONAL OPEN SPACE (PASSIVE) TOTAL OPEN SPACE MAXIMUM DENSITY ALLOWED (UNITS/ACRE) PROPOSED DENSITY (UNITS/ACRE) TOTAL NUMBER OF LOTS ALLOWED TOTAL NUMBER OF LOTS ALLOWED TOTAL NUMBER OF LOTS PROVIDED TOTAL NUMBER OF PARKING SPACES PROVIDED TOTAL LINEAR FEET IN STREETS (PUBLIC) TOTAL LINEAR FEET OF CURB & GUTTER (30") TOTAL LINEAR FEET OF SIDEWALK LINEAR FEET IN WATERLINES (6 IN)	1.17 AC 3.47 AC 4.67 AC 12 2.6 N/A 125 41 6,203 LF	
	LOTS 356-415	LOTS 416-480
MINIMUM LOT WIDTH REQUIRED LOT WIDTH (TYP.) MINIMUM LOT AREA PROVIDED MEDIAN LOT AREA PROVIDED AVERAGE LOT AREA PROVIDED	60 LF 60 LF 6,297 SF 7,790 SF 8,130 SF	30 LF 30 LF 3,930 SF 4,635 SF 4,602 SF
LOT SETBACI	κs	
FRONT YARD REAR YARD SIDE YARD REAR SETBACK FROM LANE/ALLEY ACCESSORY STRUCTURE SIDE/REAR SETBACK	-5 FT MIN. S (WIDTH 60' (	
* PER UDO SECTION 4.6(C)(3), ACCESSORY BUILDINGS SHALL OF 5' FROM ANY PRINCIPAL BUILDING OR OTHER ACCESSO	L BE A MINIMUM RY BUILDING.	
** PER UDO SECTION 4.6(C), ACCESSORY BUILDINGS SHALL COLLECTIVELY COVER MORE THAN 20% OF THE TOTAL CO LOTS' REAR AND SIDE YARDS; INDIVIDUALLY EXCEED THE	NOT EXCEED 800 SF; DMBINED AREA OF TH	E.
PRINCIPAL BUILDING.		

INFRASTRUCTURE DATA										
SECTIONS	AREA [AC]	UNITS	STREETS [LF]	30" CURB & GUTTER[LF]	SIDEWALK [LF]		8" WATER MAIN [LF]	STORM DRAINAGE [LF]	8" SEWER MAIN [LF]	SEWER FLOW [GPD]
PHASE R6D	8.8	12	685	1,377	1,359	17	667	648	686	3,000
PHASE R4 SECTION A	16.7	51	2,336	4,097	3,882	85	2,155	3,433	2,269	12,750
PHASE R4 SECTION B	22.2	62	3,182	3,625	3,581	70	1,781	1,385	847	15,500
TOTAL	47.7	125	6,203	9,099	8,822	172	4,603	5,466	3,802	31,250


# **DEVELOPER/OWNER**

KNIGHTDALE INVESTORS, LLC.

P.O. BOX 3557 CARY, NC 27519



ATTN: THAD MOORE TELEPHONE: (919) 481-3000 FAX: (919) 677-8600

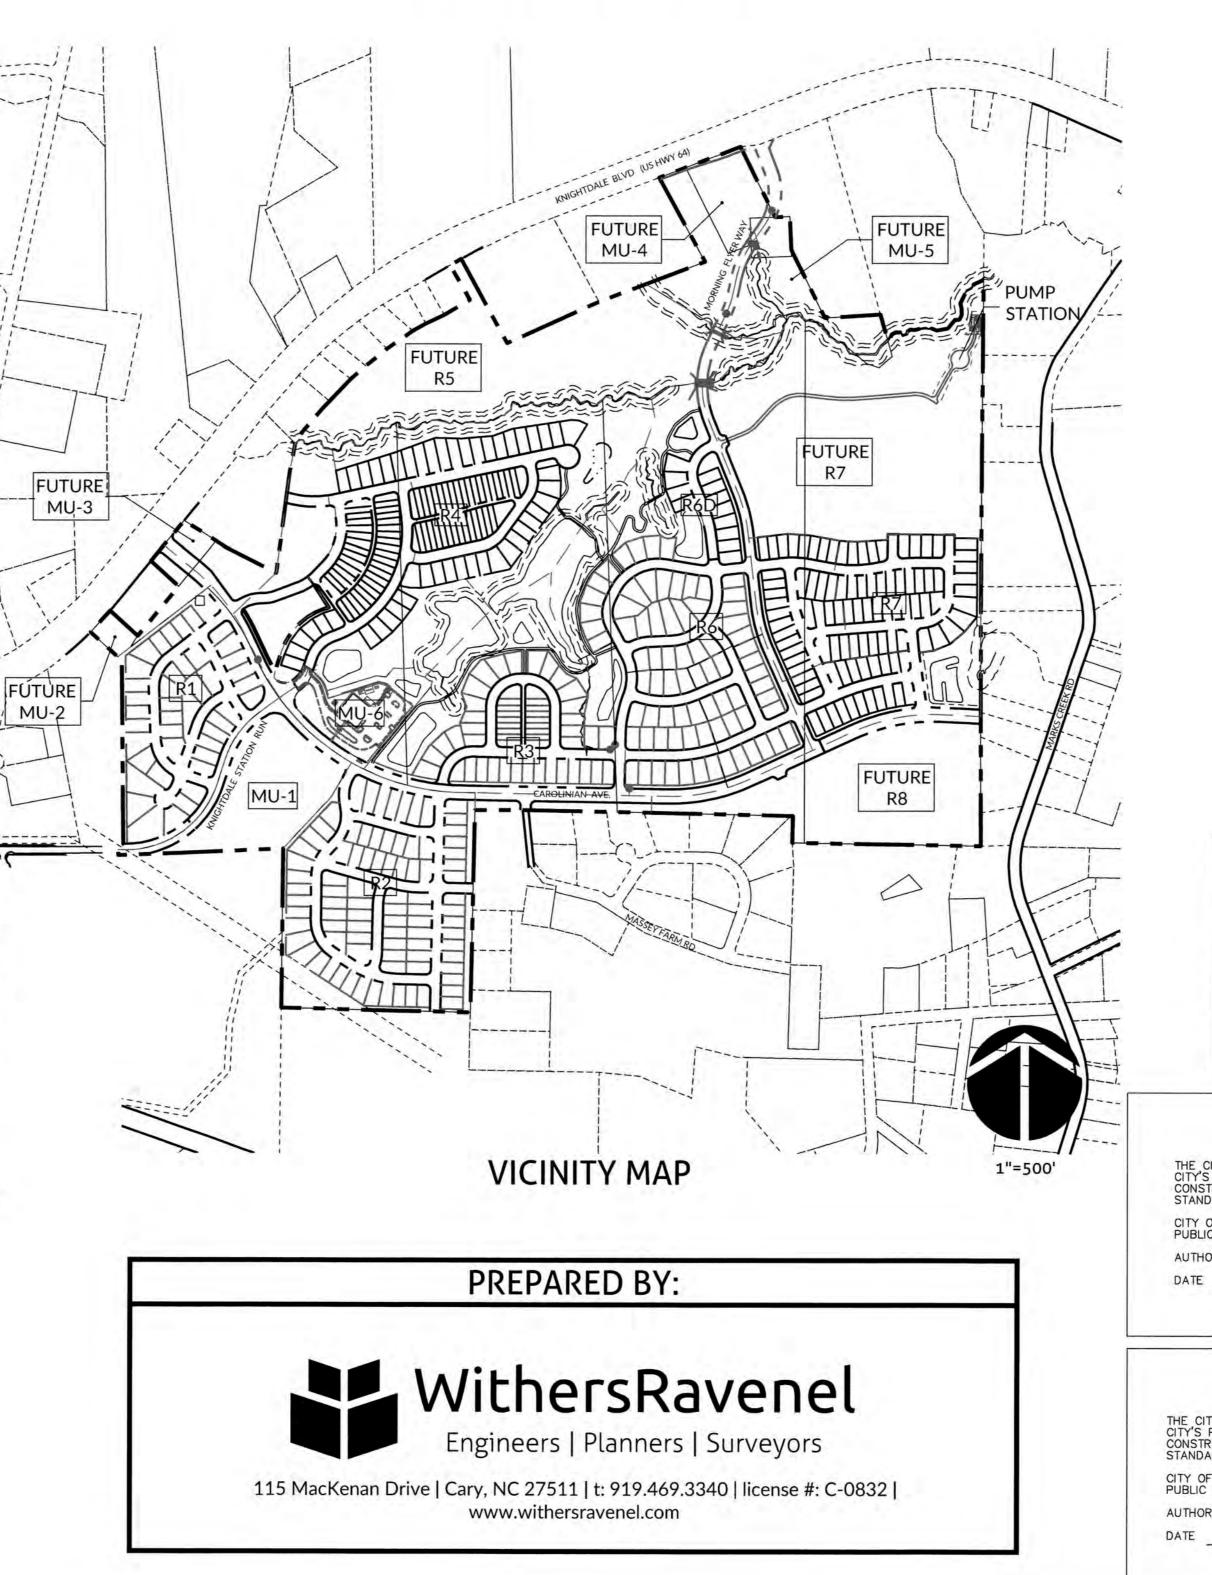

INDEX OF SHEETS			
Sheet lumber	Sheet Title		
0.0	COVER		
1.0	OVERALL EXISTING CONDITIONS		
1.1	EXISTING CONDITIONS		
2.0	OVERALL SUBDIVISION PLAN		
3.0	OVERALL SITE PLAN		
3.1	SITE PLAN		
3.2	SITE PLAN		
3.3	SITE PLAN		
3.4	PAVEMENT MARKING & SIGNAGE PLAN		
3.5	PAVEMENT MARKING & SIGNAGE PLAN		
3.6	PAVEMENT MARKING & SIGNAGE PLAN		
4.0	OVERALL UTILITY PLAN		
4.1	UTILITY PLAN		
4.2	UTILITY PLAN		
4.3	UTILITY PLAN		
5.0	<b>OVERALL STORM DRAINAGE &amp; GRADING PLAN</b>		
5.1	STORM DRAINAGE PLAN		
5.2	STORM DRAINAGE PLAN		
5.3	STORM DRAINAGE PLAN		
5.4	STORM DRAINAGE SCHEDULES		
5.5	GRADING PLAN		
5.6	GRADING PLAN		
5.7	GRADING PLAN		
6.0	PRE - OVERALL EROSION CONTROL PLAN		
6.1	SKIMMER BASIN DETAILS		
6.2	POST - OVERALL EROSION CONTROL PLAN		
6.3	EROSION CONTROL PLAN		
6.4	EROSION CONTROL PLAN		
6.5	EROSION CONTROL PLAN		
7.1	METROLINER PLACE PLAN & PROFILE		
7.2	METROLINER PLACE AND RED ARROW DR. PLAN & PROFILE		
7.3	ORIENT EXPRESS DRIVE PLAN & PROFILE		
7.4	PORTLAND ROSE DRIVE PLAN & PROFILE		
7.5	B AND O PASS AND NICKEL PLATE LANE PLAN & PROFILE		
7.6	PECONIC BAY LANE AND LIGHTRAIL DR. PLAN & PROFILE		
7.7	SANITARY SEWER OUTFALLS K AND L PLAN AND PROFILE		
8.0	SCM#8 PLAN & DETAILS		
8.1	SCM#9 PLAN & DETAILS		
8.2	SCM DETAILS		
9.1	ROADWAY DETAILS		
9.2	STORM DRAINAGE DETAILS		
9.3	EROSION CONTROL DETAILS		
9.4	WATER UTILITY DETAILS		
9.5	SEWER UTILITY DETAILS		
L1.0	OVERALL LANDSCAPE PLAN		
L1.1	LANDSCAPE PLAN		
L1.2	LANDSCAPE PLAN		
L1.3	LANDSCAPE PLAN		
L1.4	LANDSCAPE DETAILS		

ATTENTION	CONTRACTORS		

THE CONSTRUCTION CONTRACTOR RESPONSIBLE FOR THE EXTENSION OF WATER AND SEWER, AS APPROVED IN THESE PLANS, IS RESPONSIBLE FOR <u>CONTACTING</u> THE PUBLIC UTILITIES DEPARTMENT AT <u>(919) 996–4540</u> AT <u>LEAST 24 HOURS</u> PRIOR TO BEGINNING ANY CONSTRUCTION.

FAILURE TO NOTIFY BOTH CITY DEPARTMENTS IN ADVANCE OF BEGINNING CONSTRUCTION WILL RESULT IN THE ISSUANCE OF MONETARY FINES AND REQUIRE REINSTALLATION OF ANY WATER OR SEWER FACILITIES NOT INSPECTED AS A RESULT OF THIS NOTIFICATION FAILURE.

FAILURE TO CALL FOR INSPECTION, INSTALL A DOWNSTREAM PLUG, HAVE PERMITTED PLANS ON THE JOB SITE, OR ANY OTHER VIOLATION OF CITY OF RALEIGH STANDARDS WILL RESULT IN A FINE AND POSSIBLE EXCLUSION FROM FUTURE WORK IN THE CITY OF RALEIGH.

PUBLIC WATER DISTRIBUTION/EXTENSION SYSTEM

THE CITY OF RALEIGH CONSENTS TO THE CONNECTION AND EXTENSION OF THE CITY'S PUBLIC WATER SYSTEM AS SHOWN ON THIS PLAN. THE MATERIAL AND CONSTRUCTION METHODS USED FOR THIS PROJECT SHALL CONFORM TO THE STANDARDS AND SPECIFICATIONS OF THE CITY'S PUBLIC UTILITIES HANDBOOK. CITY OF RALEIGH PUBLIC UTILITIES DEPARTMENT PERMIT # W - 3574AUTHORIZATION TO CONSTRUCT AND M. Bumple PUBLIC SEWER COLLECTION/EXTENSION SYSTEM

THE CITY OF RALEIGH CONSENTS TO THE CONNECTION AND EXTENSION OF THE CITY'S PUBLIC SEWER SYSTEM AS SHOWN ON THIS PLAN. THE MATERIAL AND CONSTRUCTION METHODS USED FOR THIS PROJECT SHALL CONFORM TO THE STANDARDS AND SPECIFICATIONS OF THE CITY'S PUBLIC UTILITIES HANDBOOK. CITY OF RALEIGH PUBLIC UTILITIES DEPARTMENT PERMIT # 5-4486

- forle m. Semplo AUTHORIZATION TO CONSTRUCT 1128/19

 TOWN CERTIFICATION.
 THIS DESIGN HAS BEEN REVIEWED BY THE

 ENGINEER FOR THE TOWN OF KNIGHTDALE, AND TO THE BEST OF

 MY KNOWLEDGE AND BELIEF, IT CONFORMS TO THE REQUIREMENTS

 ESTABLISHED IN THE STANDARD SPECIFICATIONS OF THE TOWN OF

 KNIGHTDALE.

 BY:
 DATE:


 BY:
 DATE:

 TOWN APPROVED STANDARDS SHALL CONTROL. IN THE EVENT OF A CONFLICT OR INCONSISTENCY BETWEEN THESE CONSTRUCTION DRAWINGS AND THE TOWN OF KNIGHTDALE'S APPROVED STANDARDS FOR THIS PROJECT, THE APPROVED STANDARDS SHALL CONTROL. TOWN OF KNIGHTDALE APPROVED STANDARDS SHALL CONTROL. TOWN OF KNIGHTDALE APPROVED STANDARDS SHALL MEAN ALL DEVELOPMENT DOCUMENTS NECESSARY FOR APPROVAL FOR THE PROPERTY INCLUDING, BUT NOT LIMITED TO, ANY SPECIAL USE PERMIT, SUBDIVISION PLAN, SITE PLAN, SUBDIVISION (S), PHASING SCHEDULE, DEVELOPMENT AGREEMENT, UTILITY ALLOCATION AGREEMENT ANNEXATION AGREEMENT, THE TOWN OF KNIGHTDALE STANDARD SPECIFICATION AND DETAILS MANUAL AND APPLICABLE PROVISIONS OF THE NORTH CAROLINA STATE BUILDING CODE.


PROFESSIONAL DESIGN ENGINEER CERTIFICATION. THESE IMPROVEMENTS SHALL BE CONSTRUCTED IN ACCORDANCE WITH THE FOLLOWING DRAWINGS AND WITH THE STANDARD SPECIFICATIONS OF THE TOWN OF KNIGHTDALE. I, <u>NICHOLAS J. ANTRILLI.</u> PE, CERTIFY THAT THE STANDARD SPECIFICATIONS OF THE TOWN OF KNIGHTDALE HAVE BEEN THOROUGHLY CHECKED AND FOUND TO BE APPLICABLE TO THIS PROJECT. ALL EXCEPTIONS TO THE APPLICABLE TOWN STANDARDS HAVE BEEN PREVIOUSLY APPROVED BY THE TOWN OF KNIGHTDALE AND SAID EXCEPTIONS ARE SHOWN ON SHEET(S) \_\_\_\_\_\_OF THESE DRAWINGS. DRAWINGS.

TASAL DATE: 08 31 18


SEAL 38549

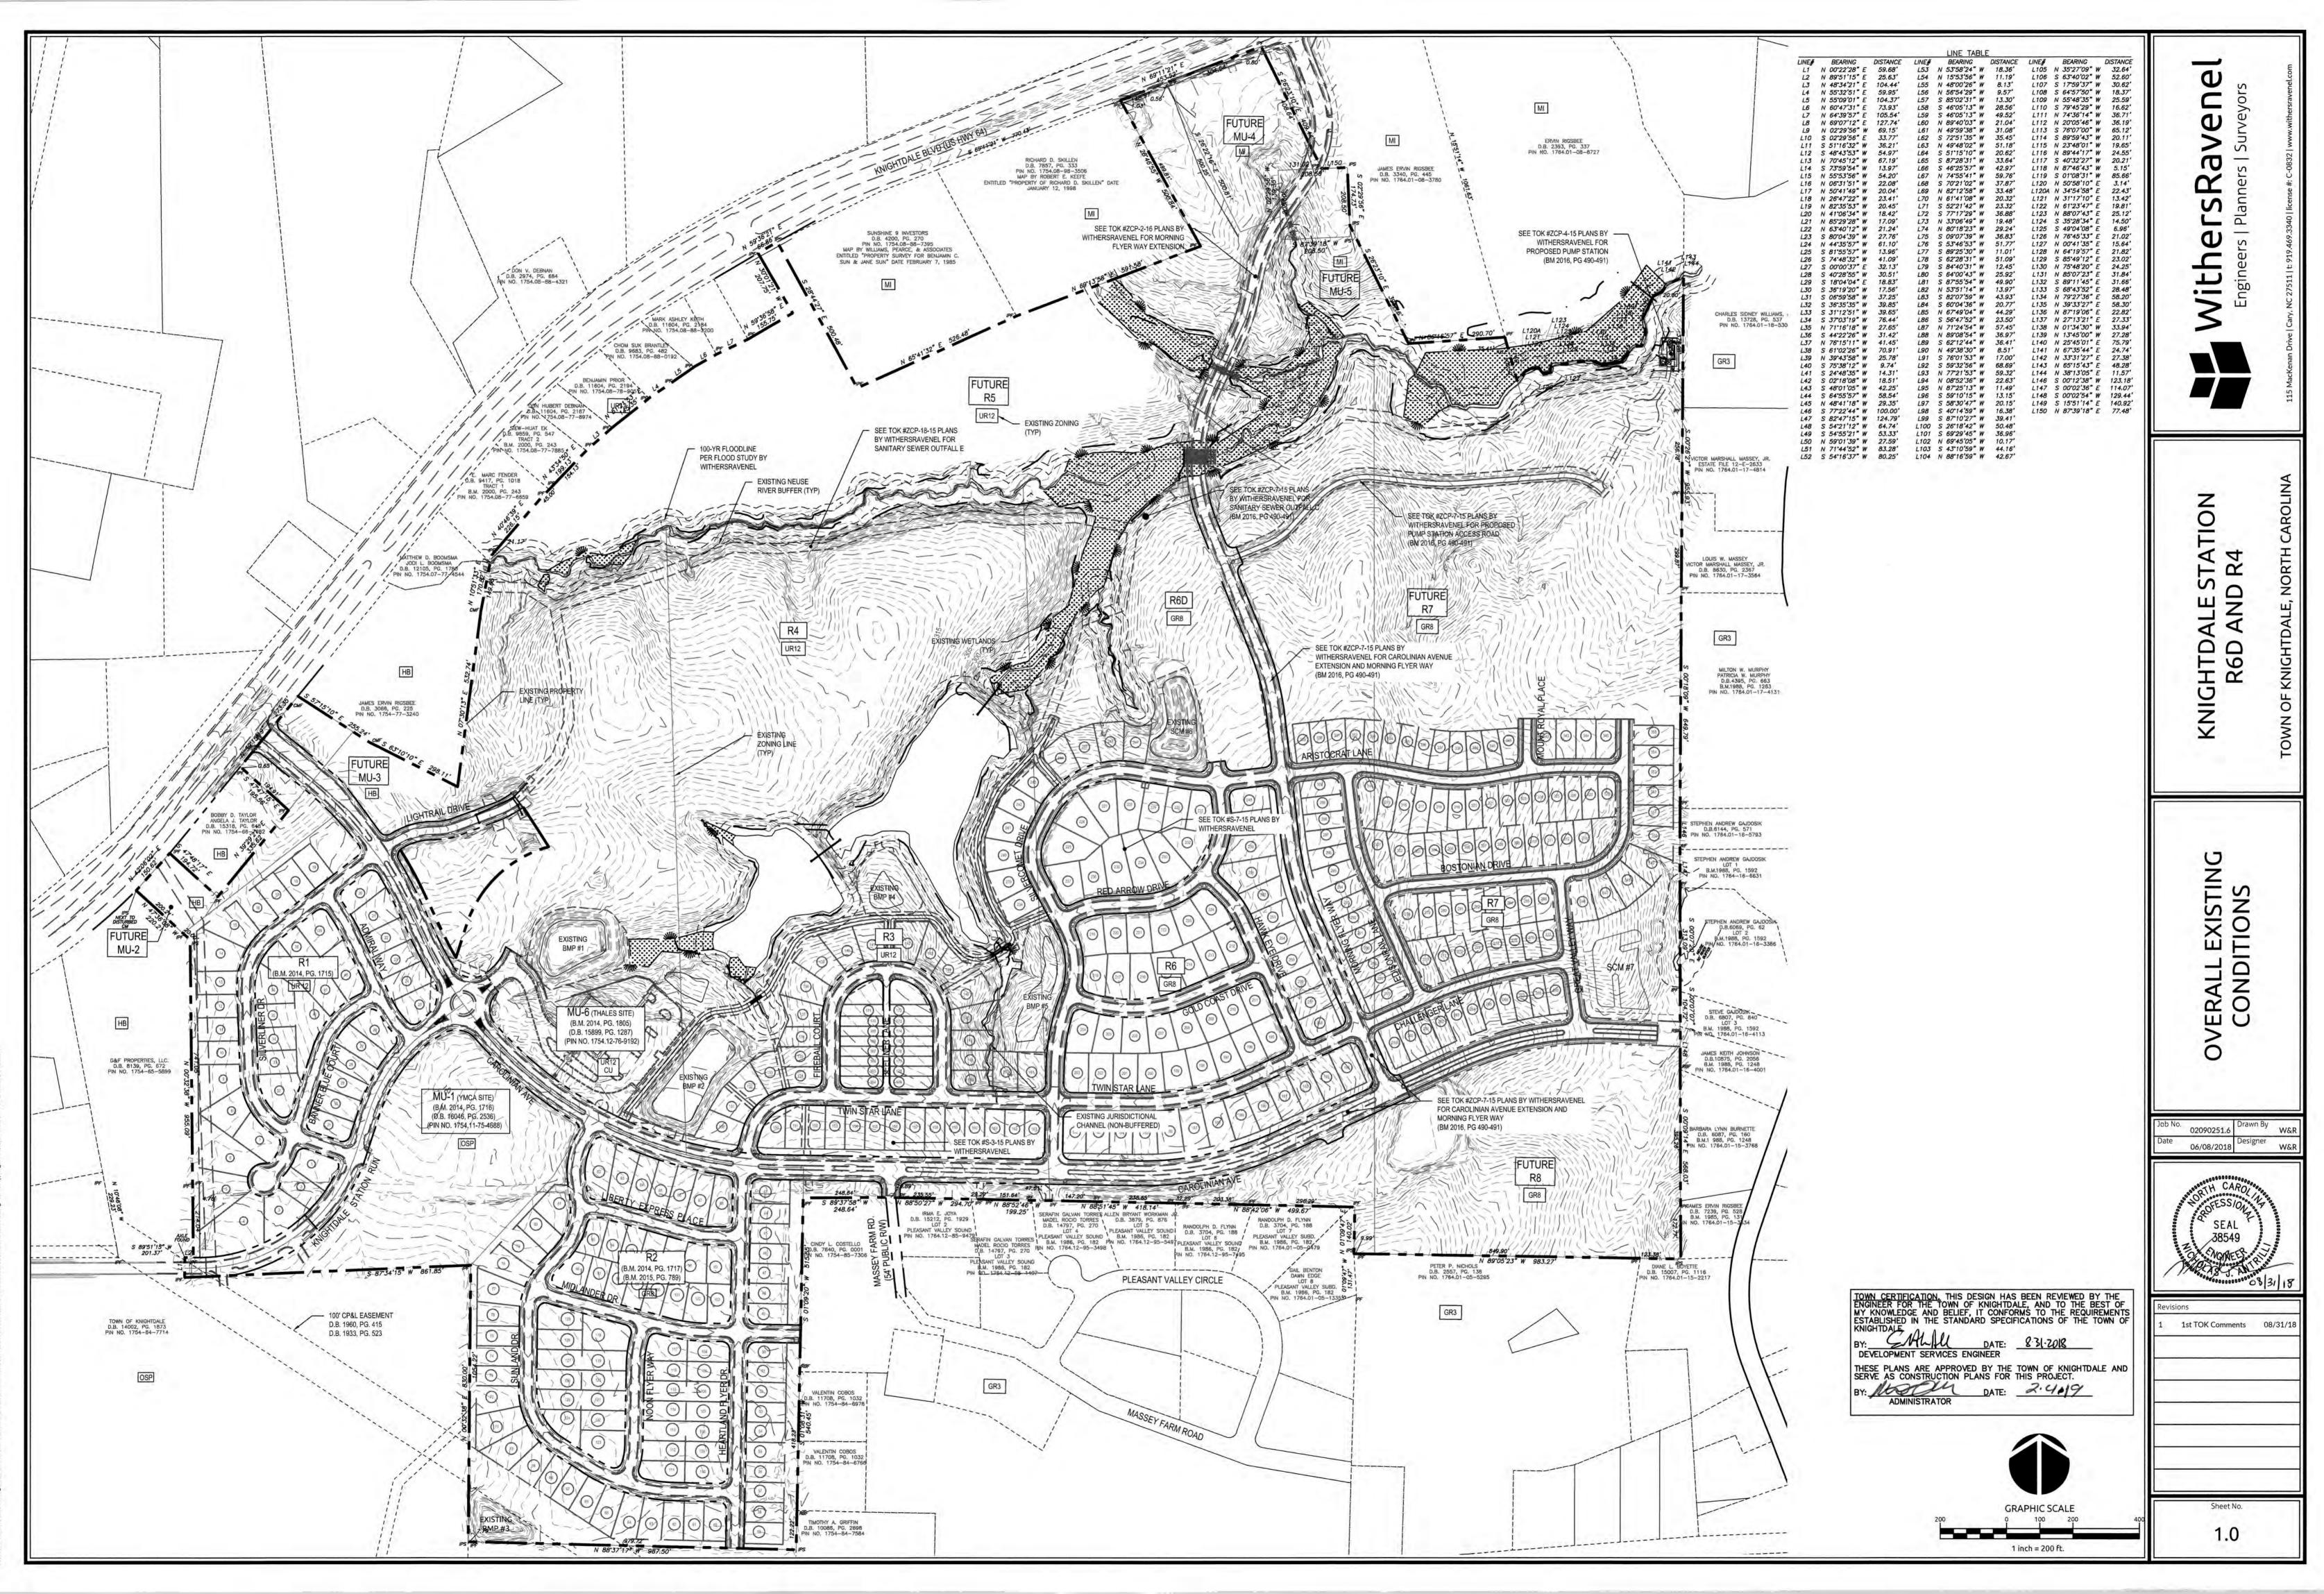


-0250/090251.6-Knightdale Station Phase R4/CAD/MASTER-CONSTRUCTION DRAWINGS/1.0 OVERALL EXISTING CONDITIONS.dwr-Thursday, August 30, 2018 8:49:46 PM - DURVEA, COLLEE

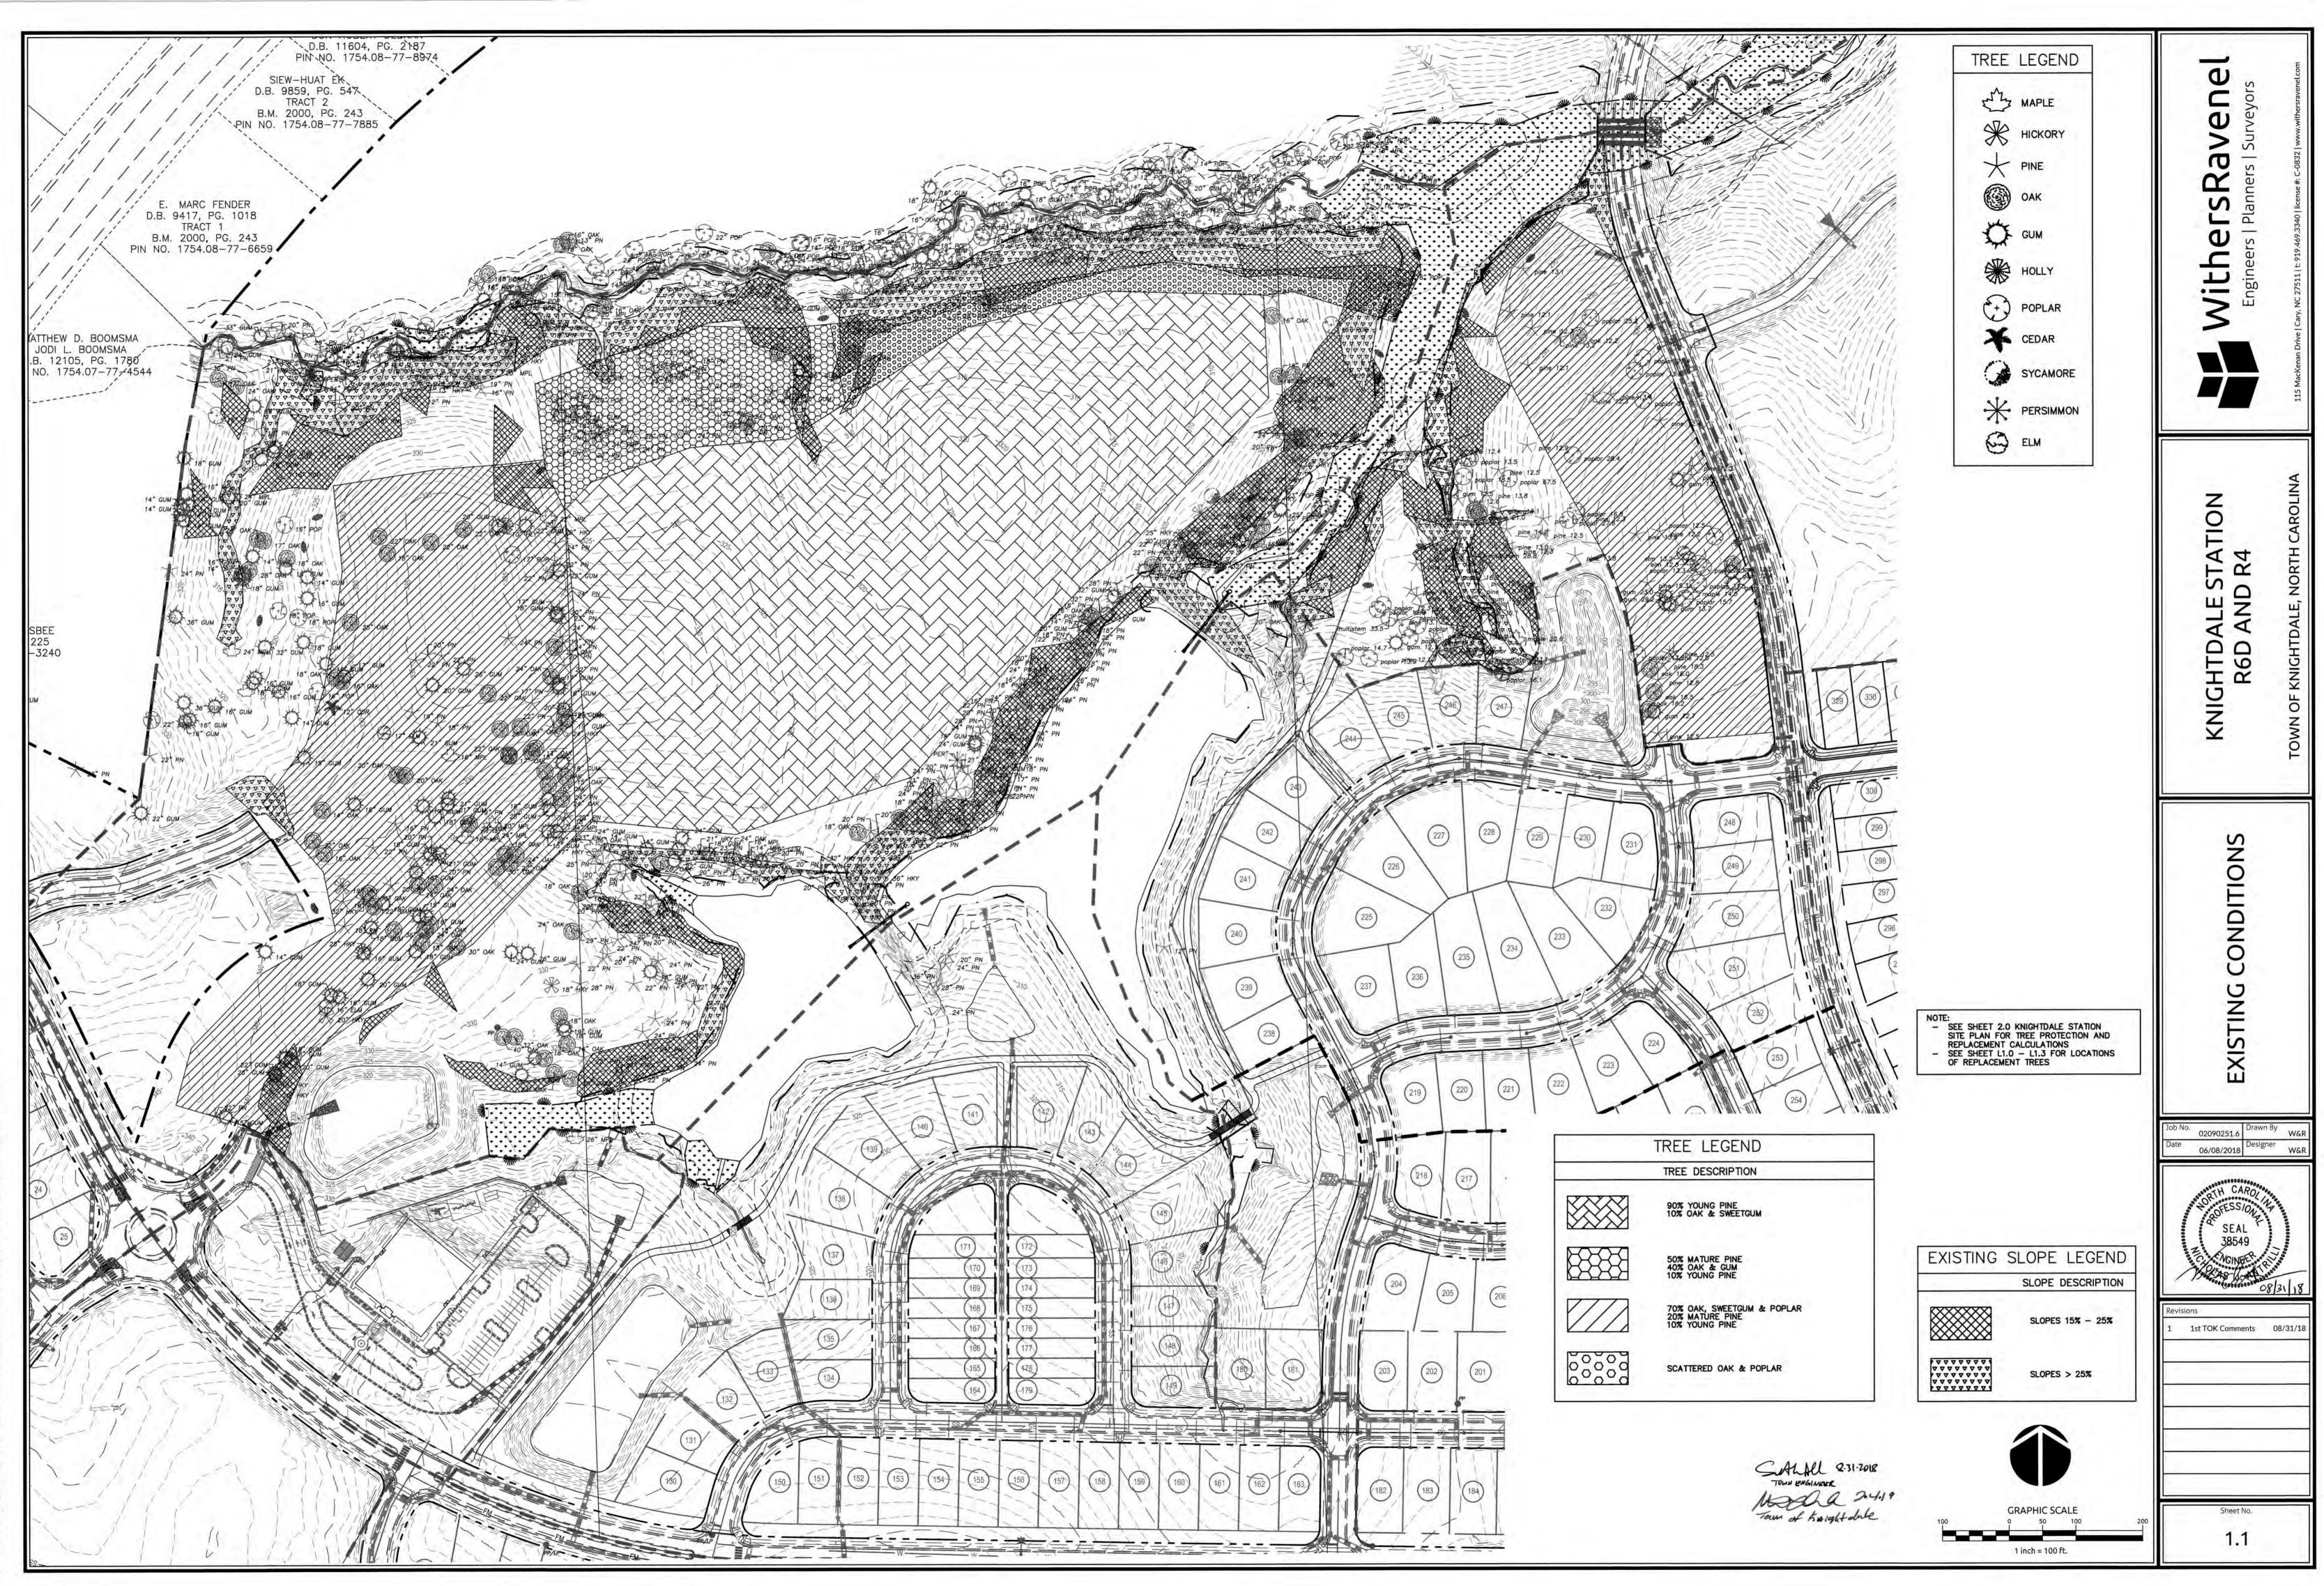

K(09)09-0250(090251.6-Knightdale Station Phase R4)CAD/MASTER-CONSTRUCTION DRAWINGS\1.1 EXISTING CONDITIONS.dwg-Thursday, August 30, 2018 8:50:13 PM - DURYEA, COLLEI

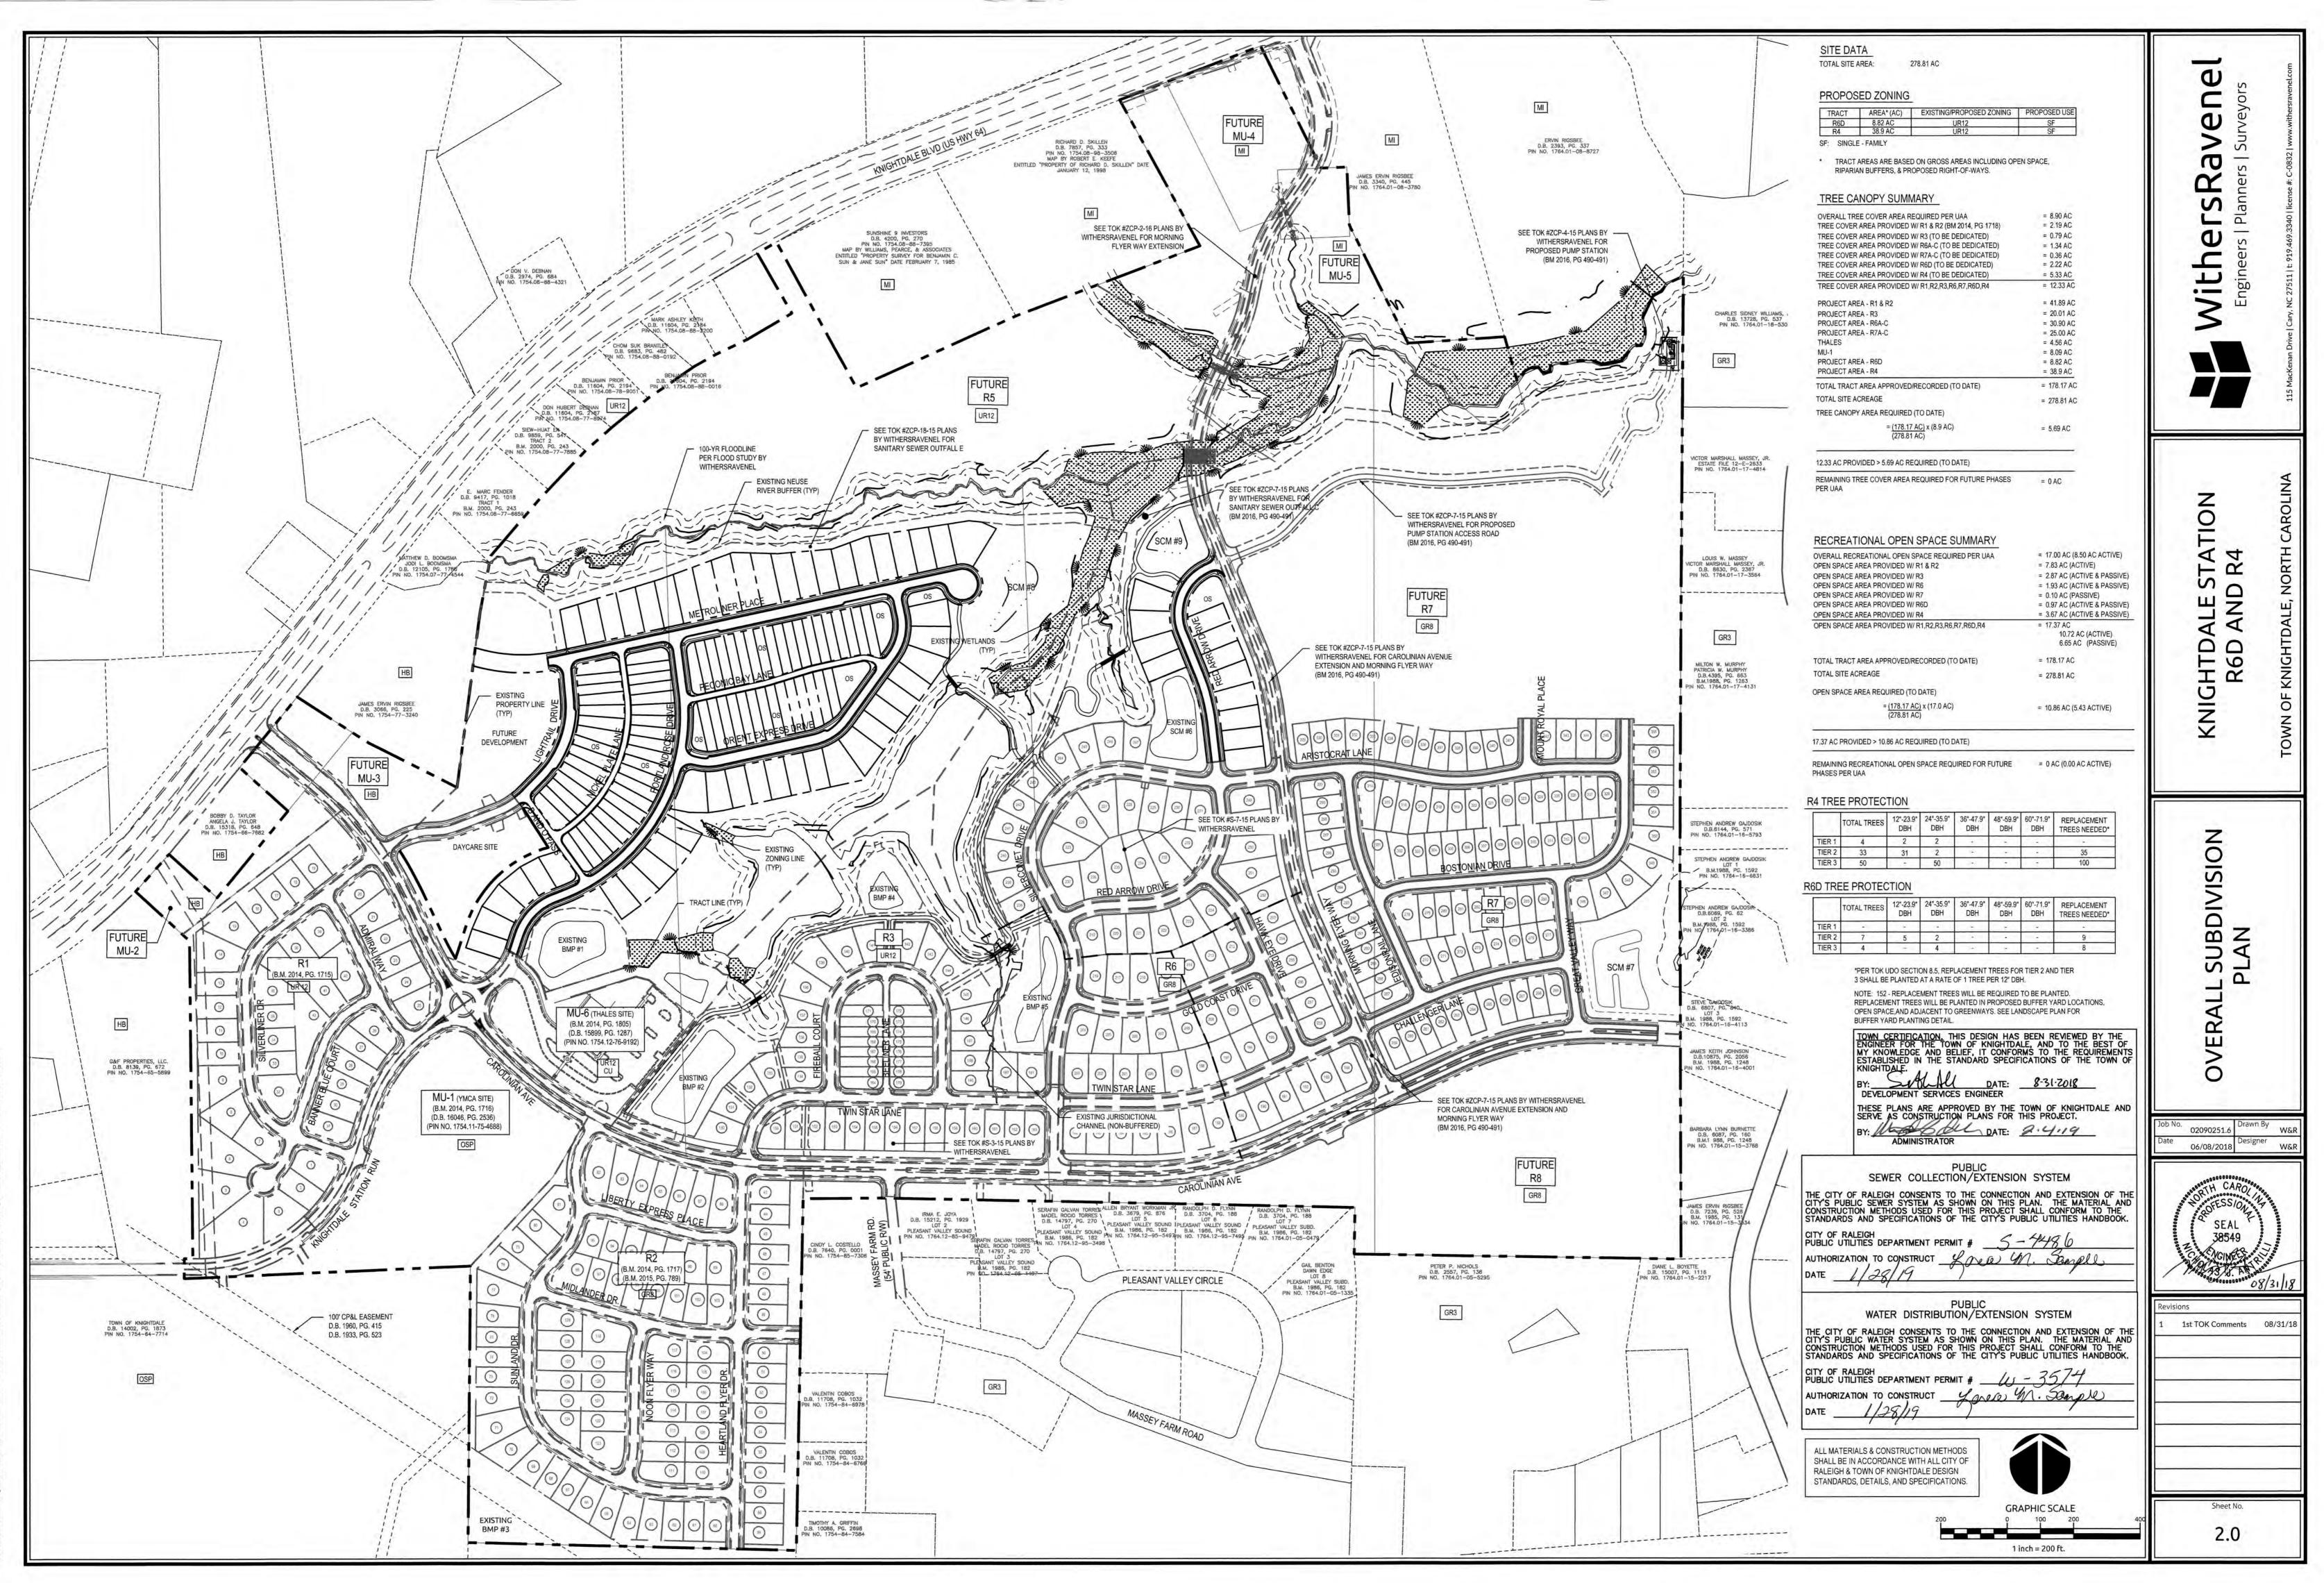


09\09-0250\090251.6-Knightdale Station Phase R4\CAD\MASTER-CONSTRUCTION DRAWINGS\2.0 KNIGHTDALE STATION SITE PLAN.dwg- Thursday, August 30, 2018 8:50:36 PM - DURYEA, COL

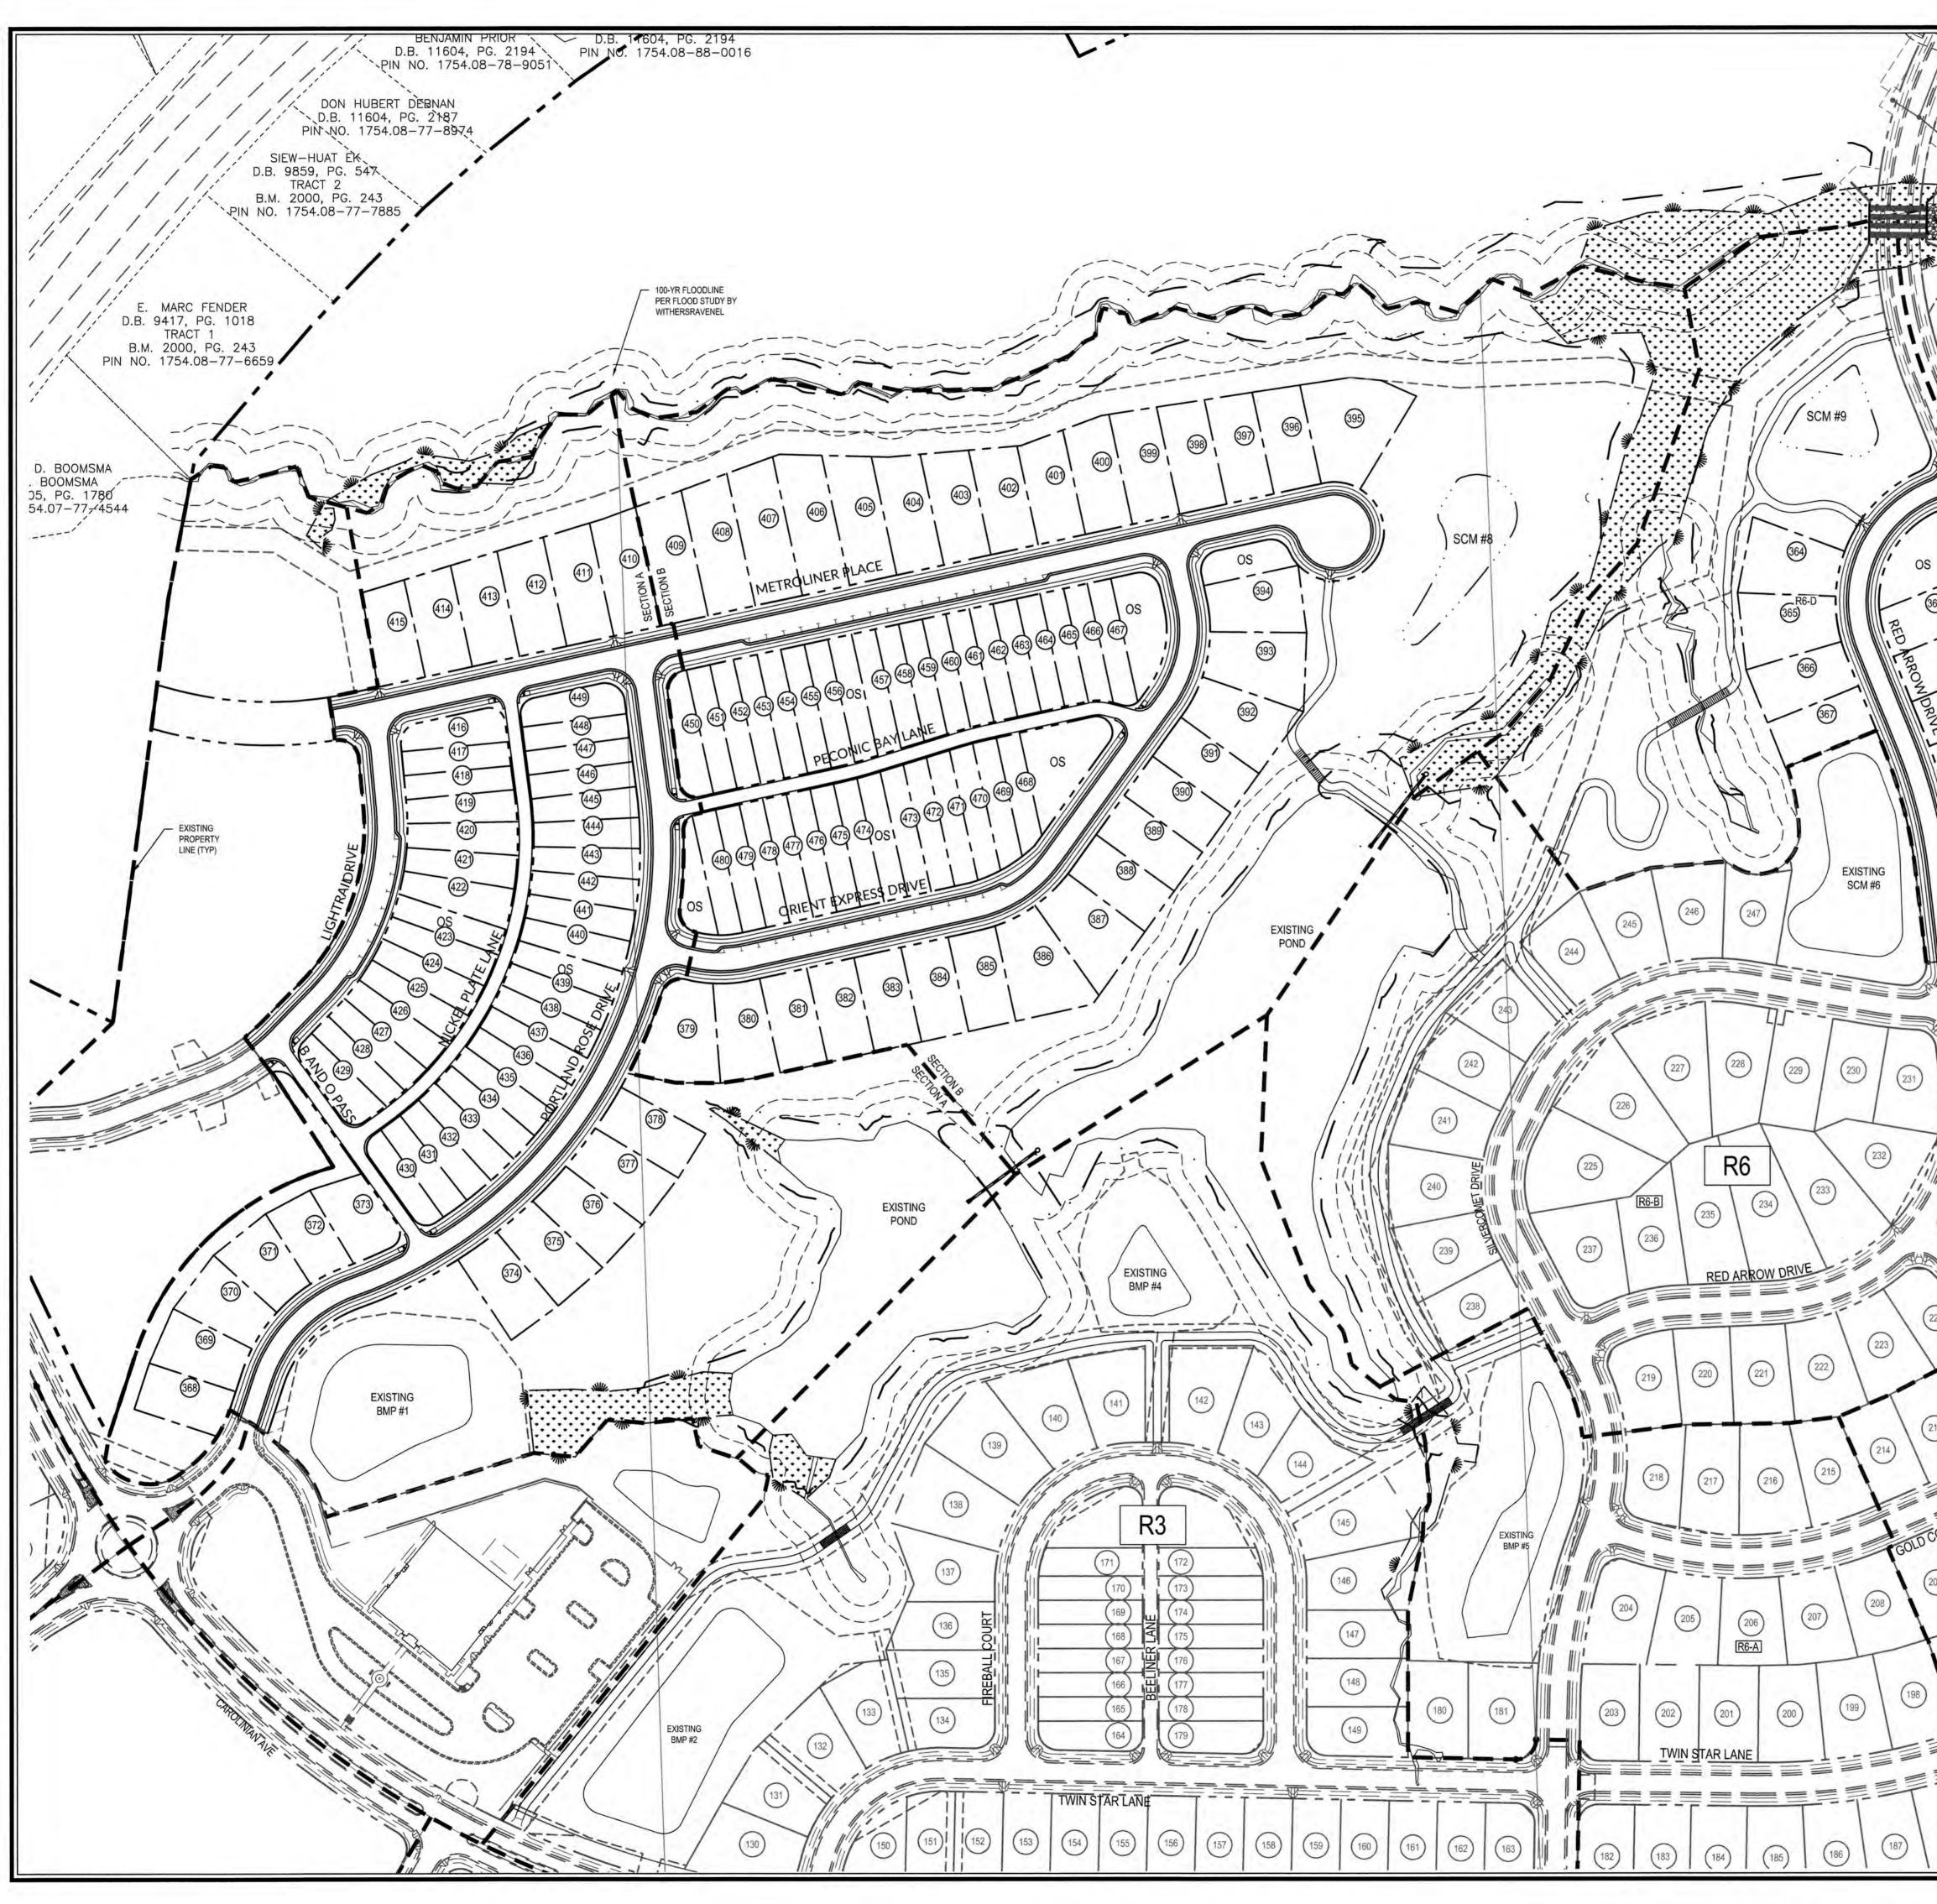


09\09-0250\090251.6-Knightdale Station Phase R4\CAD\MASTER-CONSTRUCTION DRAWINGS\3.0 OVERALL SITE PLAN.dwg-Thursday, August 30, 2018 8:50:58 PM - DURYEA, COLL

	Addition of the state of the st
THE RT NORTH	KNIGHTDALE STATION R6D AND R4 Town of Knightdale, North Carolina
240       290         290       R7         290       907         200       907         250       907         250       290         251       907         250       200         251       200         250       200         251       200         250       20	OVERALL SITE PLAN OVERALL SITE PLAN Drawn BA M&W
$\frac{PUBLIC}{SEWER COLLECTION/EXTENSION SYSTEM}$ THE CITY OF RALEIGH CONSERVING NOT THE CONFORMATION AND EXTENSION OF THE CITY OF RALEIGH CONSERVING NOT THE MATERIAL AND CONSTRUCTION METHODS USED FOR THIS PLANE. THE MATERIAL AND CONSTRUCTION METHODS USED FOR THIS PLANE. THE MATERIAL AND DOORSTRUCTION METHODS USED FOR THIS PLANE. THE MATERIAL AND DOORSTRUCTION TO CONSTRUCT ON SOFTHE CITY'S PUBLIC UTILITIES HANDBOOK. CITY OF RALEIGH PUBLIC UTILITIES DEPARTMENT PERMIT # <u>5 - 744,986</u> AUTHORIZATION TO CONSTRUCT <u>CONCOL M. Sorthow</u> DUBLIC UTILITIES DEPARTMENT PERMIT # <u>5 - 744,986</u> AUTHORIZATION TO CONSTRUCT <u>CONCOL M. Sorthow</u> DATE <u>1/28/19</u> WATER DISTRIBUTION/EXTENSION OF THE CITY OF RALEIGH CONSERVICTION METHODS USED FOR THIS PLAN. THE MATERIAL AND CONSTRUCTION METHODS USED FOR THIS PLANE. MATERIAL AND CONSTRUCTION METHODS USED FOR THIS PLANE. AND PLAN	Date 06/08/2018 Designer W&R 06/08/2018 Designer W&R 06/08/2018 Designer W&R 06/08/2018 Designer W&R 06/08/2018 Designer W&R 06/08/2018 Designer W&R 07 00 00 00 00 00 00 00 00 00 00 00 00 0
ALL MATERIALS & CONSTRUCTION METHODS SHALL BE IN ACCORDANCE WITH ALL CITY OF RALEIGH & TOWN OF KNIGHTDALE DESIGN STANDARDS, DETAILS, AND SPECIFICATIONS.	Sheet No. 3.0

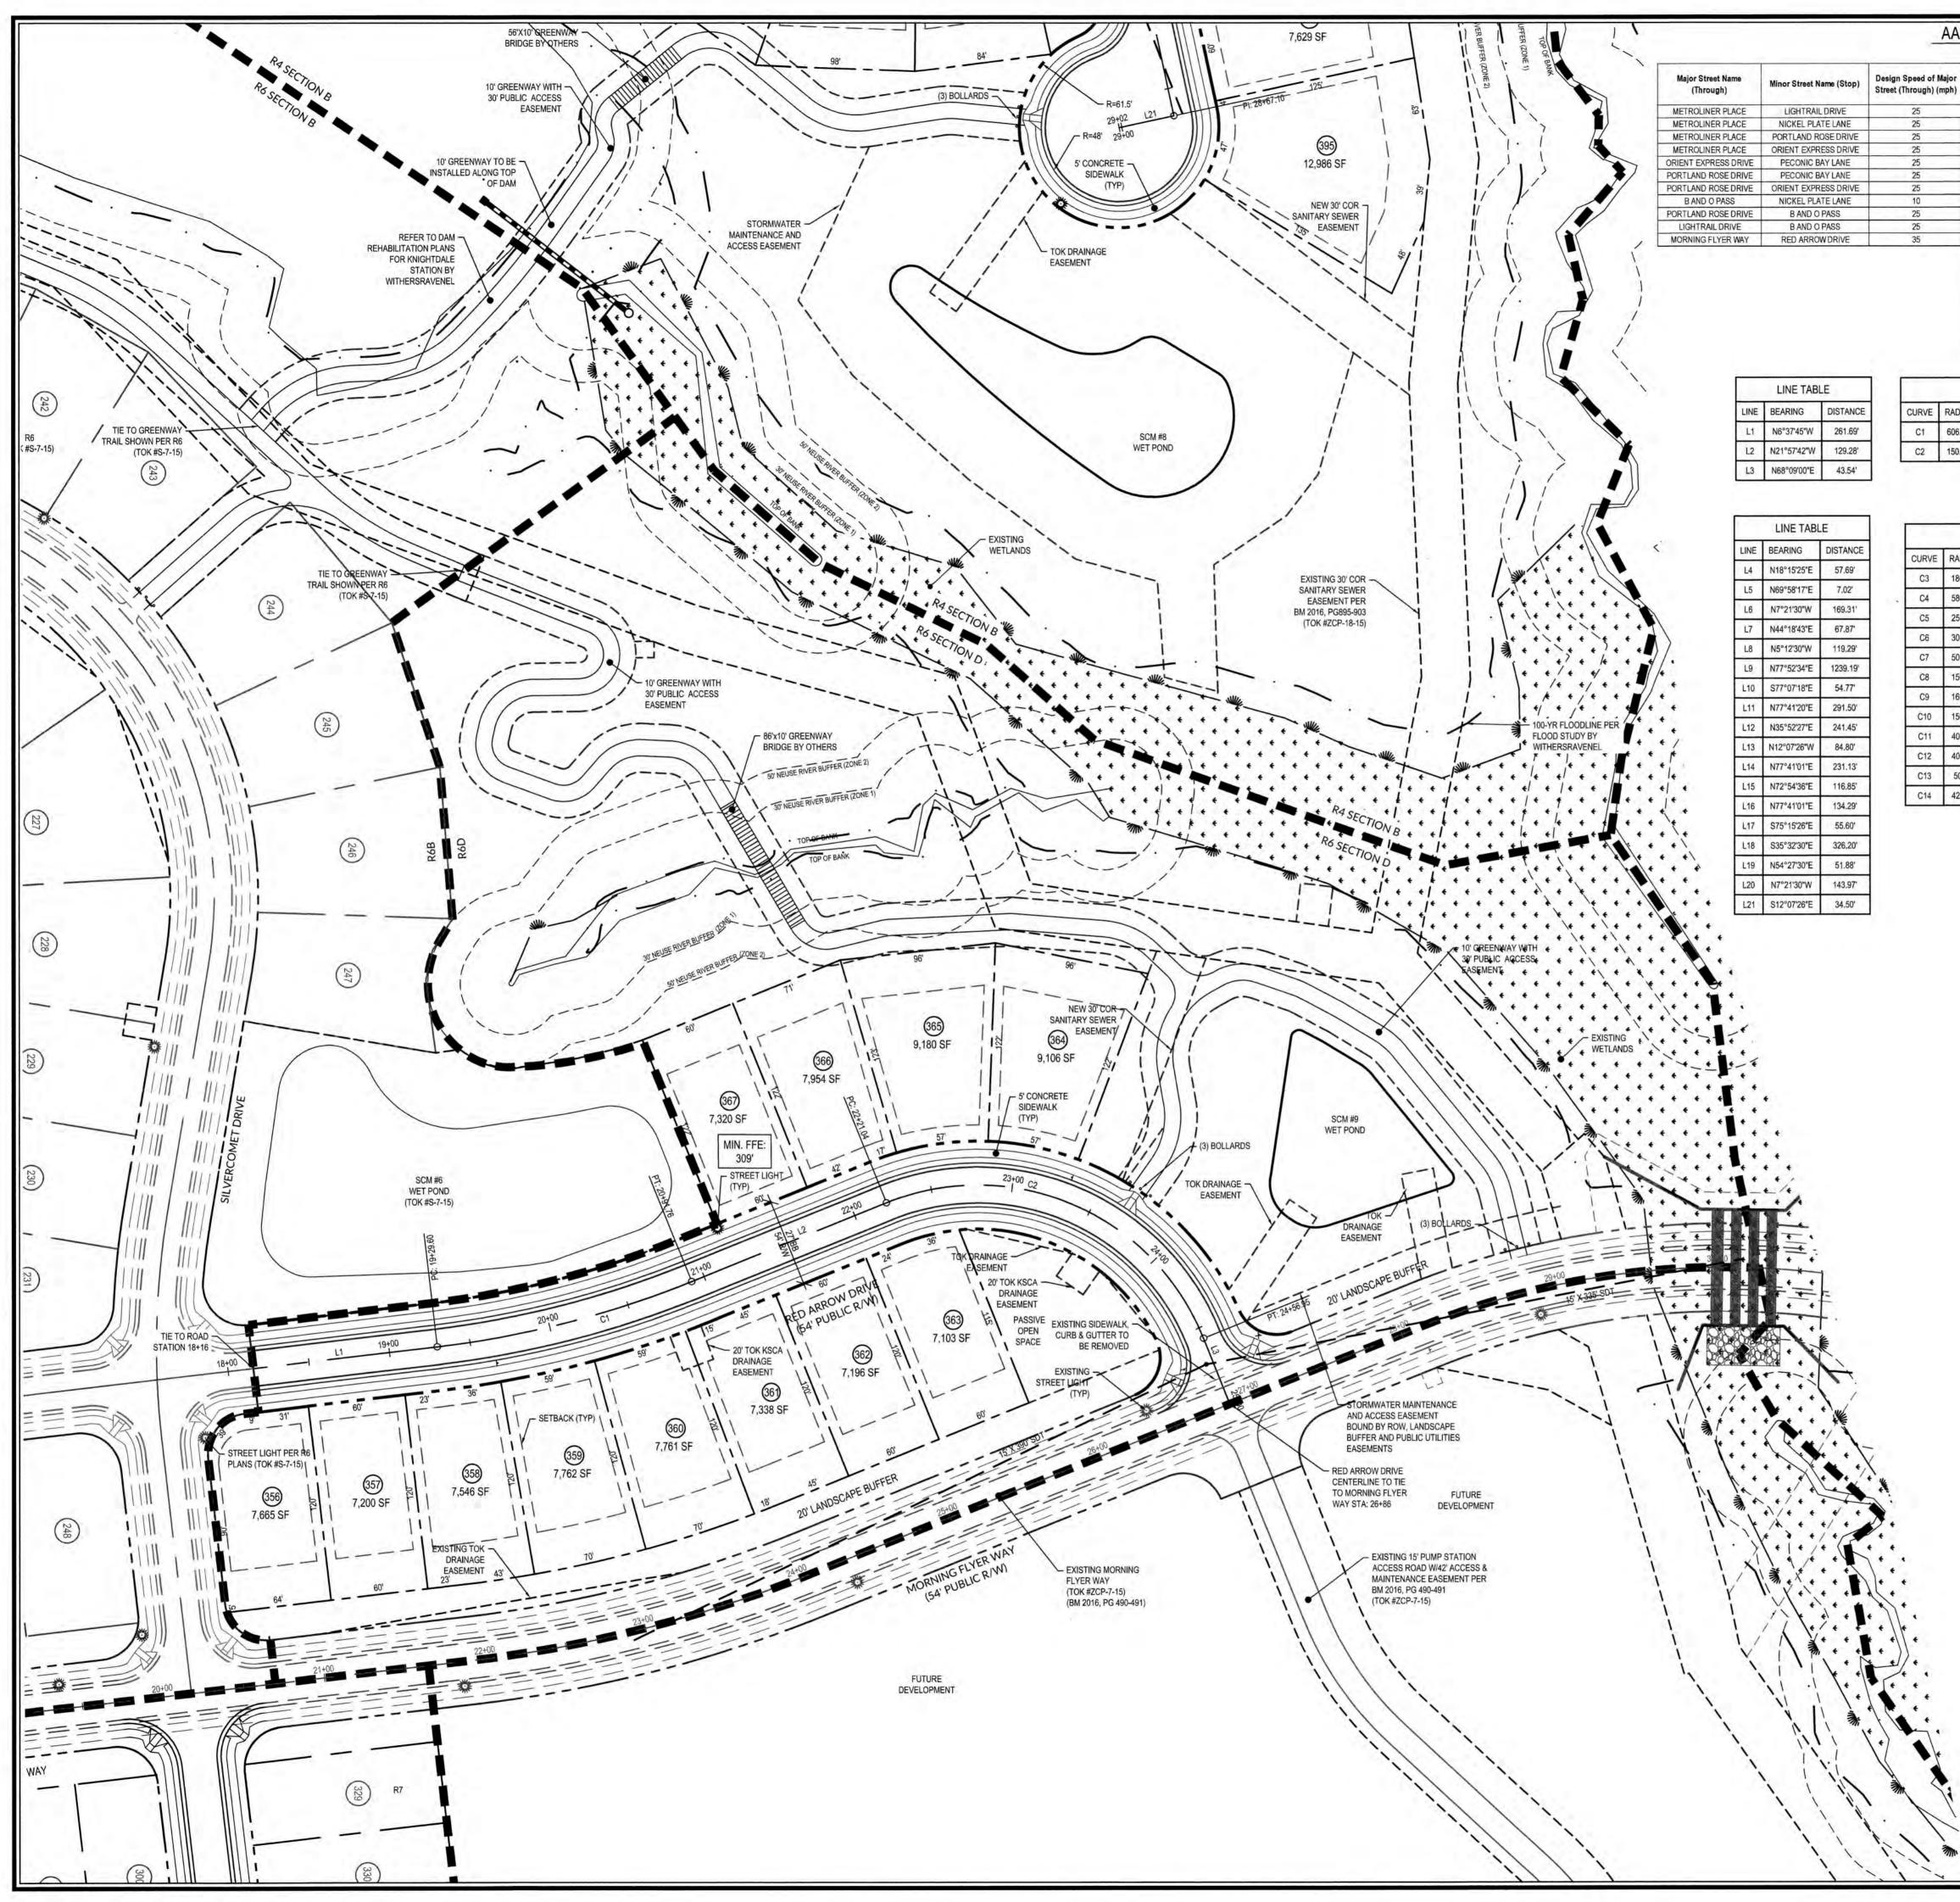


250(090251.6-Knightdale Station Phase R4\CAD\MASTER-CONSTRUCTION DRAWINGS\3.1-3.3 SITE PLANS.dwg- Friday, August 31, 2018 11:37:00 AM - DUR

v 🗸	Proposed Right Turn Sight Distance (ft.)	Proposed Left Turn Sight Distance (ft.)	Calculated Right Turn Sight Distance (ft.)	Calculated Left Turn Sight Distance (ft.)	Right Turn Time Gap (sec.)	Left Turn Time Gap (sec.)	Approach Grade of Minor Street (Stop) (%)	ajor /
MithersRavene Engineers   Planners   Surveyors	240 240	280 280	239 239	276 276	6.50 6.50	7.50 7.50	-1.35 -1.16	iph)
Sur	240 240 240	280 280 280	239 239 239	276 276 276	6.50 6.50 6.50	7.50 7.50 7.50	-1.05 -1.58 -1.65	
Sa lers	240 240 100	280 280 110	239 239 96	276 276 110	6.50 6.50 6.50	7.50 7.50 7.50	1.65 1.58 1.16	
<b>FSRa</b> Planners	240 240 335	280 280 390	239 239 334	276 276 386	6.50 6.50 6.50	7.50 7.50 7.50	-1.15 1.15 -1.55	
		CLASSIFI LOCAL S	SPEED LIMIT 25 MPH	COAD ROW DRIVE	DED AD	the second state		
<b>/ithe</b> Engineers	STREET	LOCAL S LOCAL S LOCAL S	25 MPH 25 MPH 25 MPH	AIL DRIVE INER PLACE EXPRESS DRIVE	) LIGHTR	1 2.	R6D 2	
<b>Vit</b> Engine	STREET EY	LOCAL S	25 MPH 10 MPH	ND ROSE DRIVE	5	12 1.	R4 15	
>		ALLI	10 MPH 10 MPH	PLATE LANE C BAY LANE			CURVE TABLE	_
	17 70 40	-	- R6D & R4 A-I	LONG C		BEARING N14°17'44"W		RADIUS
	17.72 AC	4		ON ROADWAYS & SIDE	1.	N23°05'39"E	)' 235.91' 212.34	150.00
	4.82 AC 3.58 AC 27.5%	3	@ 2,400 SF/LOT)	RVIOUS AREA (60 LOTS RVIOUS AREA (65 LOTS D PERCENT IMPERVIO	LOT IMPE			
	0.82 %	0	(0.39 AC/47.72 AC)	PERCENT IMPERVIOUS FLYER WAY)			CURVE TABLE	
z				NOTES	GENERAL	BEARING N44°06'51"E	00' 162.47' 157.01	RADIU 180.0
LION		ING.	ING AND PROPOSED ZON		1. SEE SHEET	N31°18'24"E N56°56'52"E	00' 36.51' 109.38	580.0 250.0
	VENEL.		DELINEATED AND SURV	AND STREAM BUFFER	3. WETLANDS	N19°33'07"E S76°54'37"E	00' 28.97' 425.99	300.0 500.0
D R4	A Part of the Part of the Part of the State	ITILITY ALLOCATION A	OF KNIGHTDALE SEPT. 3, VARDED BASED ON THE B. 014722, PAGES 01758	OCATION HAS BEEN A	5. WATER ALL	S89°42'59"E N56°46'53"E		150.0 160.0
	GHTING POLICY. ITED, THE	TION 11.5 - STREET LIC	ED FOR R7 PER UDO SEG STANDARD LIGHT SPECIF	SHTS SHALL BE PROVID	6. STREET LIC	N11°52'31"E N75°17'49"E		150.0 400.0
	STS TO MAINTAIN		O PAY THE TOWN THE DI COVERING A PERIOD OF	ED FIXTURE AND POLE	THE DESIR	N75°17'49"E S88°47'12"E		400.0
R6 R6	R 3720175400J		GROUND DISTANCES. THIN THE FEMA FLOODPI TIVE DATE OF MAY 2, 200		8. THIS PROP	N23°33'00"E	00' 458.53' 436.62	425.0
KNIGH	NGINEERS TLANDS OR	S ARMY CORPS OF EN	2) AND/OR UNITED STATE QUIRED PRIOR TO CONS	F WATER QUALITY (DW APPROVAL SHALL BE RI	9. DIVISION O (USACOE)			
N N N			RSECTIONS SHALL BE A RWISE NOTED. THE TUR		10. THE TURNO			
•	IRB.	D AT THE BACK OF CU	1 OF 17.5 FEET MEASURE N IS PUBLIC RIGHT-OF-W	YS SHALL BE A MINIMUI	WITH ALLE			
	CURB LINE	EIGHT (8') ABOVE THE	TIALLY OBSTRUCTING WA EIGHTS OF TWO (2') AND VELED WAY IN NO CURB	HICLE BETWEEN THE H	PARKED VE			
			AT THE GREENWAY CON	NGLE.	SIGHT TRIA			
z								
ILAN								
E PLAN								
SITE PLAN	WED BY THE THE BEST OF	HAS BEEN REVIE	<u>on.</u> This design F Town of Knigh	IOWN CERTIFICAT	G			
SITE PLAN	THE BEST OF REQUIREMENTS THE TOWN OF	TDALE, AND TO IFORMS TO THE ECIFICATIONS OF	ON. THIS DESIGN E TOWN OF KNIGH ND BELIEF, IT COI HE STANDARD SP	ENGINEER FOR TH				
SITE PLAN	THE BEST OF REQUIREMENTS THE TOWN OF	TDALE, AND TO IFORMS TO THE ECIFICATIONS OF :: <u>8-31-2018</u>	E TOWN OF KNIGH ND BELIEF, IT CO HE STANDARD SP AU DATE ERVICES ENGINEER	ENGINEER FOR THAY KNOWLEDGE A STABLISHED IN KNIGHTDALE. BY: DEVELOPMENT S				
SITE PLAN	THE BEST OF REQUIREMENTS THE TOWN OF	TDALE, AND TO FORMS TO THE ECIFICATIONS OF E: <u>8-31-2018</u> HE TOWN OF KN DR THIS PROJECT	E TOWN OF KNIGH ND BELIEF, IT COI HE STANDARD SP DATE ERVICES ENGINEER E APPROVED BY T RUCTION PLANS F DATE	ENGINEER FOR THAY KNOWLEDGE A ESTABLISHED IN KNIGHTDALE. BY: DEVELOPMENT S THESE PLANS AR SERVE AS CONST BY:				
Job No. 02090251.6 Drawn By V	THE BEST OF REQUIREMENTS THE TOWN OF B IIGHTDALE AND T. 19	TDALE, AND TO FORMS TO THE ECIFICATIONS OF E: <u>831.2018</u> HE TOWN OF KN OR THIS PROJEC E: <u>2.4</u>	E TOWN OF KNIGH ND BELIEF, IT COI HE STANDARD SP DATE ENVICES ENGINEER E APPROVED BY T RUCTION PLANS F DATE RATOR PUBLIC	ENGINEER FOR THAY KNOWLEDGE A ESTABLISHED IN KNIGHTDALE. BY: DEVELOPMENT S THESE PLANS AR SERVE AS CONST BY: ADMINIST				
	THE BEST OF REQUIREMENTS THE TOWN OF B IIGHTDALE AND T. 219 ENSION OF THE MATERIAL AND	TDALE, AND TO FORMS TO THE ECIFICATIONS OF ECIFICATIONS OF HE TOWN OF KN OR THIS PROJEC ECITION SYSTEM ECTION AND EXTING IS PLAN. THE	E TOWN OF KNIGH ND BELIEF, IT COI HE STANDARD SP DATE ENVICES ENGINEER E APPROVED BY T RUCTION PLANS F DATE ATOR PUBLIC LECTION/EXTEN AS SHOWN ON T	SEWER COL				
Job No. 02090251.6 Drawn By V Date Designer	THE BEST OF REQUIREMENTS THE TOWN OF B IIGHTDALE AND T. IIGHTDALE AND T. IIGHTDALE AND OF MATERIAL AND ORM TO THE	TDALE, AND TO FORMS TO THE ECIFICATIONS OF ECIFICATIONS OF HE TOWN OF KN OR THIS PROJEC ECITION AND FXT HIS PLAN. THE ECTION AND EXT HIS PLAN. THE CT SHALL CONFO	E TOWN OF KNIGH ND BELIEF, IT COI HE STANDARD SP DATE ENVICES ENGINEER E APPROVED BY T RUCTION PLANS F DATE RATOR PUBLIC	SEWER COL RALEIGH CONSEL SEWER COL RALEIGH CONSEL NMETHODS USE AND SPECIFICATION	THE CITY OF CITY'S PUBLIC CONSTRUCTIO STANDARDS			
Job No. 02090251.6 Date 06/08/2018 Designer V Designer Designer V V Designer V Designer V Designer V Designer V Designer V Designer V V V Designer V V Designer V Designer V V Designer V V Designer V V	THE BEST OF REQUIREMENTS THE TOWN OF B IIGHTDALE AND T. IIGHTDALE AND T. IIGHTDALE AND OF MATERIAL AND ORM TO THE	TDALE, AND TO FORMS TO THE ECIFICATIONS OF ECIFICATIONS OF HE TOWN OF KN OR THIS PROJEC ECITION AND FXT HIS PLAN. THE ECTION AND EXT HIS PLAN. THE CT SHALL CONFO	E TOWN OF KNIGH ND BELIEF, IT COI HE STANDARD SP DATE ENVICES ENGINEER E APPROVED BY T RUCTION PLANS F DATE ATOR PUBLIC LECTION/EXTEN TAS SHOWN ON TO OF FOR THIS PROJE INS OF THE CITY'S PERMIT #	SEWER COL RALEIGH CONSEL SEWER COL RALEIGH CONSEL SEWER SYSTEM N METHODS USE AND SPECIFICATION	THE CITY OF CITY'S PUBLIC CONSTRUCTIO STANDARDS CITY OF RALL PUBLIC UTILI			
Job No. 02090251.6 Drawn By V Date 06/08/2018 Designer V Designer V	THE BEST OF REQUIREMENTS THE TOWN OF B IIGHTDALE AND T. IIGHTDALE AND T. IIGHTDALE AND OF MATERIAL AND ORM TO THE	TDALE, AND TO FORMS TO THE ECIFICATIONS OF ECIFICATIONS OF HE TOWN OF KN OR THIS PROJEC ECITION AND FXT HIS PLAN. THE ECTION AND EXT HIS PLAN. THE CT SHALL CONFO	E TOWN OF KNIGH ND BELIEF, IT COI HE STANDARD SP <u>DATE</u> ENVICES ENGINEER E APPROVED BY T RUCTION PLANS F DATE T	SEWER COL RALEIGH CONSEIN SEWER COL RALEIGH CONSEIN SEWER SYSTEM	THE CITY OF CITY'S PUBLIC CONSTRUCTIO STANDARDS CITY OF RALL PUBLIC UTILI			
Job No. 02090251.6 Date 06/08/2018 Designer V Designer Designer V V Designer V Designer V Designer V Designer V Designer V Designer V V V Designer V V Designer V Designer V V Designer V V Designer V V	THE BEST OF REQUIREMENTS THE TOWN OF B IIGHTDALE AND T. IIGHTDALE AND T. I	TDALE, AND TO FORMS TO THE ECIFICATIONS OF E. <u>831.2018</u> HE TOWN OF KN OR THIS PROJEC E. <u>2.4</u> SION SYSTEM ECTION AND EXTINE TO SHALL CONFO PUBLIC UTILITIE 5 -4486 400. Support	E TOWN OF KNIGH ND BELIEF, IT COI HE STANDARD SP 	ADMINIST	THE CITY OF CITY'S PUBLIC CONSTRUCTIO STANDARDS CITY OF RALL PUBLIC UTILIT AUTHORIZATIO DATE			
Job No. Date 06/08/2018 Drawn By V Date 06/08/2018 Designer V 06/08/2018 SEAL SEAL 38549 SEAL 38549	THE BEST OF REQUIREMENTS THE TOWN OF B IIGHTDALE AND T. IIGHTDALE AND T. I	TDALE, AND TO FORMS TO THE ECIFICATIONS OF E. <u>831.2018</u> HE TOWN OF KN OR THIS PROJEC E. <u>2.4</u> SION SYSTEM ECTION AND EXTINE TO SHALL CONFO PUBLIC UTILITIE 5 -4486 400. Support	E TOWN OF KNIGH ND BELIEF, IT COI HE STANDARD SP 	ADMINIST	THE CITY OF CITY'S PUBLIC CONSTRUCTIO STANDARDS CITY OF RALL PUBLIC UTILIT AUTHORIZATIO DATE			
Job No. Date 06/08/2018 Drawn By V Date 06/08/2018 Designer V October Signer V SEAL 38549 SEAL 38	THE BEST OF REQUIREMENTS THE TOWN OF B IIGHTDALE AND T. IIGHTDALE AND T. I	TDALE, AND TO FORMS TO THE ECIFICATIONS OF E. <u>831.2018</u> HE TOWN OF KN OR THIS PROJEC E. <u>2.4</u> SION SYSTEM ECTION AND EXTINE TO SHALL CONFO PUBLIC UTILITIE 5 -4486 400. Support	E TOWN OF KNIGH ND BELIEF, IT COI HE STANDARD SP 	ADMINIST SEWER COL RALEIGH CONSEIN SEWER COL RALEIGH CONSEIN SEWER SYSTEM METHODS USE AND SPECIFICATION WATER DISTF RALEIGH CONSEIN WATER DISTF RALEIGH CONSEIN WATER DISTF RALEIGH CONSEIN CONSTRUCT CONSTRU	THE CITY OF CITY'S PUBLIC CONSTRUCTIO STANDARDS CITY OF RALL PUBLIC UTILIT AUTHORIZATIO DATE			
Job No. Date 06/08/2018 Drawn By V Date 06/08/2018 Designer V 06/08/2018 SEAL SEAL 38549 SEAL 38549	THE BEST OF REQUIREMENTS THE TOWN OF B IIGHTDALE AND T. IIGHTDALE AND T. I	TDALE, AND TO FORMS TO THE ECIFICATIONS OF E. <u>831.2018</u> HE TOWN OF KN OR THIS PROJEC E. <u>2.9</u> SION SYSTEM ECTION AND EXT PUBLIC UTILITIE SION SYSTEM ECTION AND EXT HIS PLAN. THE CT SHALL CONFOL SION SYSTEM ECTION AND EXT HIS PLAN. THE CT SHALL CONFOL ECTION AND EXT HIS PLAN. THE CT SHALL CONFOL HIS PLAN. THE CT SHALL CONFOL ECTION AND EXT HIS PLAN. THE CT SHALL CONFOL HIS PLAN. THE HIS PLAN. THE CT SHALL CONFOL HIS PLAN. THE HIS PLAN. THE CT SHALL CONFOL HIS PLAN. THE HIS	E TOWN OF KNIGH ND BELIEF, IT COI HE STANDARD SP 	ADMINIST SEWER COL RALEIGH CONSEL SEWER SYSTEM N METHODS USE AND SPECIFICATION MATER DISTR RALEIGH CONSEL CONSTRUCT MATER DISTR RALEIGH CONSEL CONSTRUCT MATER DISTR RALEIGH CONSEL CONSTRUCT MATER DISTR RALEIGH CONSEL CONSTRUCT MATER DISTR RALEIGH CONSEL CONSTRUCT MATER DISTR MATER	THE CITY OF CITY'S PUBLIC CONSTRUCTIO STANDARDS CITY OF RALL PUBLIC UTILIT AUTHORIZATIO DATE			
Job No. Date 06/08/2018 Drawn By V Date 06/08/2018 Designer V 06/08/2018 SEAL SEAL 38549 SEAL 38549	THE BEST OF REQUIREMENTS THE TOWN OF B IIGHTDALE AND T. IIGHTDALE AND T. I	TDALE, AND TO FORMS TO THE ECIFICATIONS OF E. <u>831.2018</u> HE TOWN OF KN OR THIS PROJEC E. <u>2.9</u> SION SYSTEM ECTION AND EXT PUBLIC UTILITIE SION SYSTEM ECTION AND EXT HIS PLAN. THE CT SHALL CONFOL SION SYSTEM ECTION AND EXT HIS PLAN. THE CT SHALL CONFOL ECTION AND EXT HIS PLAN. THE CT SHALL CONFOL HIS PLAN. THE CT SHALL CONFOL ECTION AND EXT HIS PLAN. THE CT SHALL CONFOL HIS PLAN. THE HIS PLAN. THE CT SHALL CONFOL HIS PLAN. THE HIS PLAN. THE CT SHALL CONFOL HIS PLAN. THE HIS	E TOWN OF KNIGH ND BELIEF, IT COI HE STANDARD SP 	ADMINIST SEWER COL RALEIGH CONSEIN SEWER COL RALEIGH CONSEIN SEWER SYSTEM METHODS USE AND SPECIFICATION WATER DISTF RALEIGH CONSEIN WATER DISTF RALEIGH CONSEIN WATER DISTF RALEIGH CONSEIN CONSTRUCT CONSTRU	THE CITY OF CITY'S PUBLIC CONSTRUCTIONS STANDARDS CITY OF RALL PUBLIC UTILIT AUTHORIZATION DATE			
Job No. Date 06/08/2018 Drawn By V Date 06/08/2018 Designer V 06/08/2018 SEAL SEAL 38549 SEAL 38549	THE BEST OF REQUIREMENTS THE TOWN OF B IIGHTDALE AND T. IIGHTDALE AND T. I	TDALE, AND TO FORMS TO THE ECIFICATIONS OF E. <u>831.2018</u> HE TOWN OF KN OR THIS PROJEC E. <u>2.9</u> SION SYSTEM ECTION AND EXT PUBLIC UTILITIE SION SYSTEM ECTION AND EXT HIS PLAN. THE CT SHALL CONFOL SION SYSTEM ECTION AND EXT HIS PLAN. THE CT SHALL CONFOL ECTION AND EXT HIS PLAN. THE CT SHALL CONFOL HIS PLAN. THE CT SHALL CONFOL ECTION AND EXT HIS PLAN. THE CT SHALL CONFOL HIS PLAN. THE HIS PLAN. THE CT SHALL CONFOL HIS PLAN. THE HIS PLAN. THE CT SHALL CONFOL HIS PLAN. THE HIS	E TOWN OF KNIGH ND BELIEF, IT COI HE STANDARD SP <u>U</u> DATE ENVICES ENGINEER E APPROVED BY T RUCTION PLANS F DATE PUBLIC LECTION/EXTENT ITS TO THE CONN AS SHOWN ON T PERMIT # PUBLIC PUBLIC DUBLIC DEDUTION/EXTENT AS SHOWN ON T D FOR THIS PROJE DIS OF THE CITYS PERMIT # PERMIT # PERMIT # T PERMIT # T D FOR THIS PROJE	ADMINIST SEWER COL RALEIGH CONSEI CONSTRUCTION METHODS RALEIGH CONSTRUCTION CONSTRUCTION METHODS STRUCTION METHODS STRUCTION STRUC	THE CITY OF CITY'S PUBLIC CONSTRUCTIC STANDARDS CITY OF RALL PUBLIC UTILIT AUTHORIZATIO DATE THE CITY OF CONSTRUCTIC STANDARDS CITY OF RALL PUBLIC UTILIT AUTHORIZATIO DATE			
Job No. Date 06/08/2018 Drawn By V Date 06/08/2018 Designer V 06/08/2018 SEAL SEAL 38549 SEAL 38549	THE BEST OF REQUIREMENTS THE TOWN OF B IIGHTDALE AND T. IIGHTDALE AND T. I	TDALE, AND TO FORMS TO THE ECIFICATIONS OF E. <u>831.2018</u> HE TOWN OF KN OR THIS PROJEC E. <u>2.9</u> SION SYSTEM ECTION AND EXT PUBLIC UTILITIE SION SYSTEM ECTION AND EXT HIS PLAN. THE CT SHALL CONFOL SION SYSTEM ECTION AND EXT HIS PLAN. THE CT SHALL CONFOL ECTION AND EXT HIS PLAN. THE CT SHALL CONFOL HIS PLAN. THE CT SHALL CONFOL ECTION AND EXT HIS PLAN. THE CT SHALL CONFOL HIS PLAN. THE HIS PLAN. THE CT SHALL CONFOL HIS PLAN. THE HIS PLAN. THE CT SHALL CONFOL HIS PLAN. THE HIS	E TOWN OF KNIGH ND BELIEF, IT COI HE STANDARD SP <u>U</u> DATE ENVICES ENGINEER E APPROVED BY T RUCTION PLANS F DATE PUBLIC LECTION/EXTENT ITS TO THE CONN AS SHOWN ON T PERMIT # PUBLIC PUBLIC DEDUTION/EXTENT ITS TO THE CONN AS SHOWN ON T D FOR THIS PROJE INS OF THE CITYS PERMIT # PERMIT # T PERMIT # T PERMIT # T PERMIT # T PERMIT # T D FOR THIS PROJE	ADMINIST SEWER COL RALEIGH CONSEI CONSTRUCTION METHODS WATER DIST RALEIGH CONSEI CONSTRUCTION METHODS SEVER DIST RALEIGH CONSEI CONSTRUCTION METHODS STRUCTION METHODS NO CONSTRUCTION STRUCTION METHODS STRUCTION METHODS STR	THE CITY OF CITY'S PUBLIC CONSTRUCTIC STANDARDS CITY OF RALL PUBLIC UTILIT AUTHORIZATIO DATE CITY'S PUBLIC CONSTRUCTION STANDARDS CITY OF RALL PUBLIC UTILIT AUTHORIZATIO DATE			
Job No. Date 06/08/2018 Drawn By V Date 06/08/2018 Designer V 06/08/2018 SEAL SEAL 38549 SEAL 38549	THE BEST OF REQUIREMENTS THE TOWN OF B UGHTDALE AND T. 19 ENSION OF THE MATERIAL AND ORM TO THE ES HANDBOOK. 10 ENSION OF THE MATERIAL AND ORM TO THE ES HANDBOOK. 14 14	TDALE, AND TO FORMS TO THE ECIFICATIONS OF E. <u>831.2018</u> HE TOWN OF KN OR THIS PROJEC E. <u>2.9</u> SION SYSTEM ECTION AND EXT PUBLIC UTILITIE SION SYSTEM ECTION AND EXT HIS PLAN. THE CT SHALL CONFOL SION SYSTEM ECTION AND EXT HIS PLAN. THE CT SHALL CONFOL ECTION AND EXT HIS PLAN. THE CT SHALL CONFOL HIS PLAN. THE CT SHALL CONFOL ECTION AND EXT HIS PLAN. THE CT SHALL CONFOL HIS PLAN. THE HIS PLAN. THE CT SHALL CONFOL HIS PLAN. THE HIS PLAN. THE CT SHALL CONFOL HIS PLAN. THE HIS	E TOWN OF KNIGH ND BELIEF, IT COI HE STANDARD SP <u>U</u> ATI ERVICES ENGINEER E APPROVED BY T RUCTION PLANS F ATI PUBLIC LECTION/EXTEN ITS TO THE CONN AS SHOWN ON T OFOR THIS PROJE INS OF THE CITY'S PERMIT # PUBLIC IBUTION/EXTEN ITS TO THE CONN AS SHOWN ON T OFOR THIS PROJE INS OF THE CITY'S PERMIT # T PERMIT # T PERMIT # T DECONNENT OF THE CITY'S	ADMINIST SEWER COL RALEIGH CONSEI CONSTRUCTION METHODS WATER DIST RALEIGH CONSEI CONSTRUCTION METHODS SEVER DIST RALEIGH CONSEI CONSTRUCTION METHODS STRUCTION METHODS NO CONSTRUCTION STRUCTION METHODS STRUCTION METHODS STR	THE CITY OF CITY'S PUBLIC CONSTRUCTIC STANDARDS CITY OF RALL PUBLIC UTILIT AUTHORIZATIO DATE THE CITY OF CITY'S PUBLIC CONSTRUCTIC STANDARDS CITY OF RALL PUBLIC UTILIT AUTHORIZATIO DATE AUTHORIZATIO DATE			

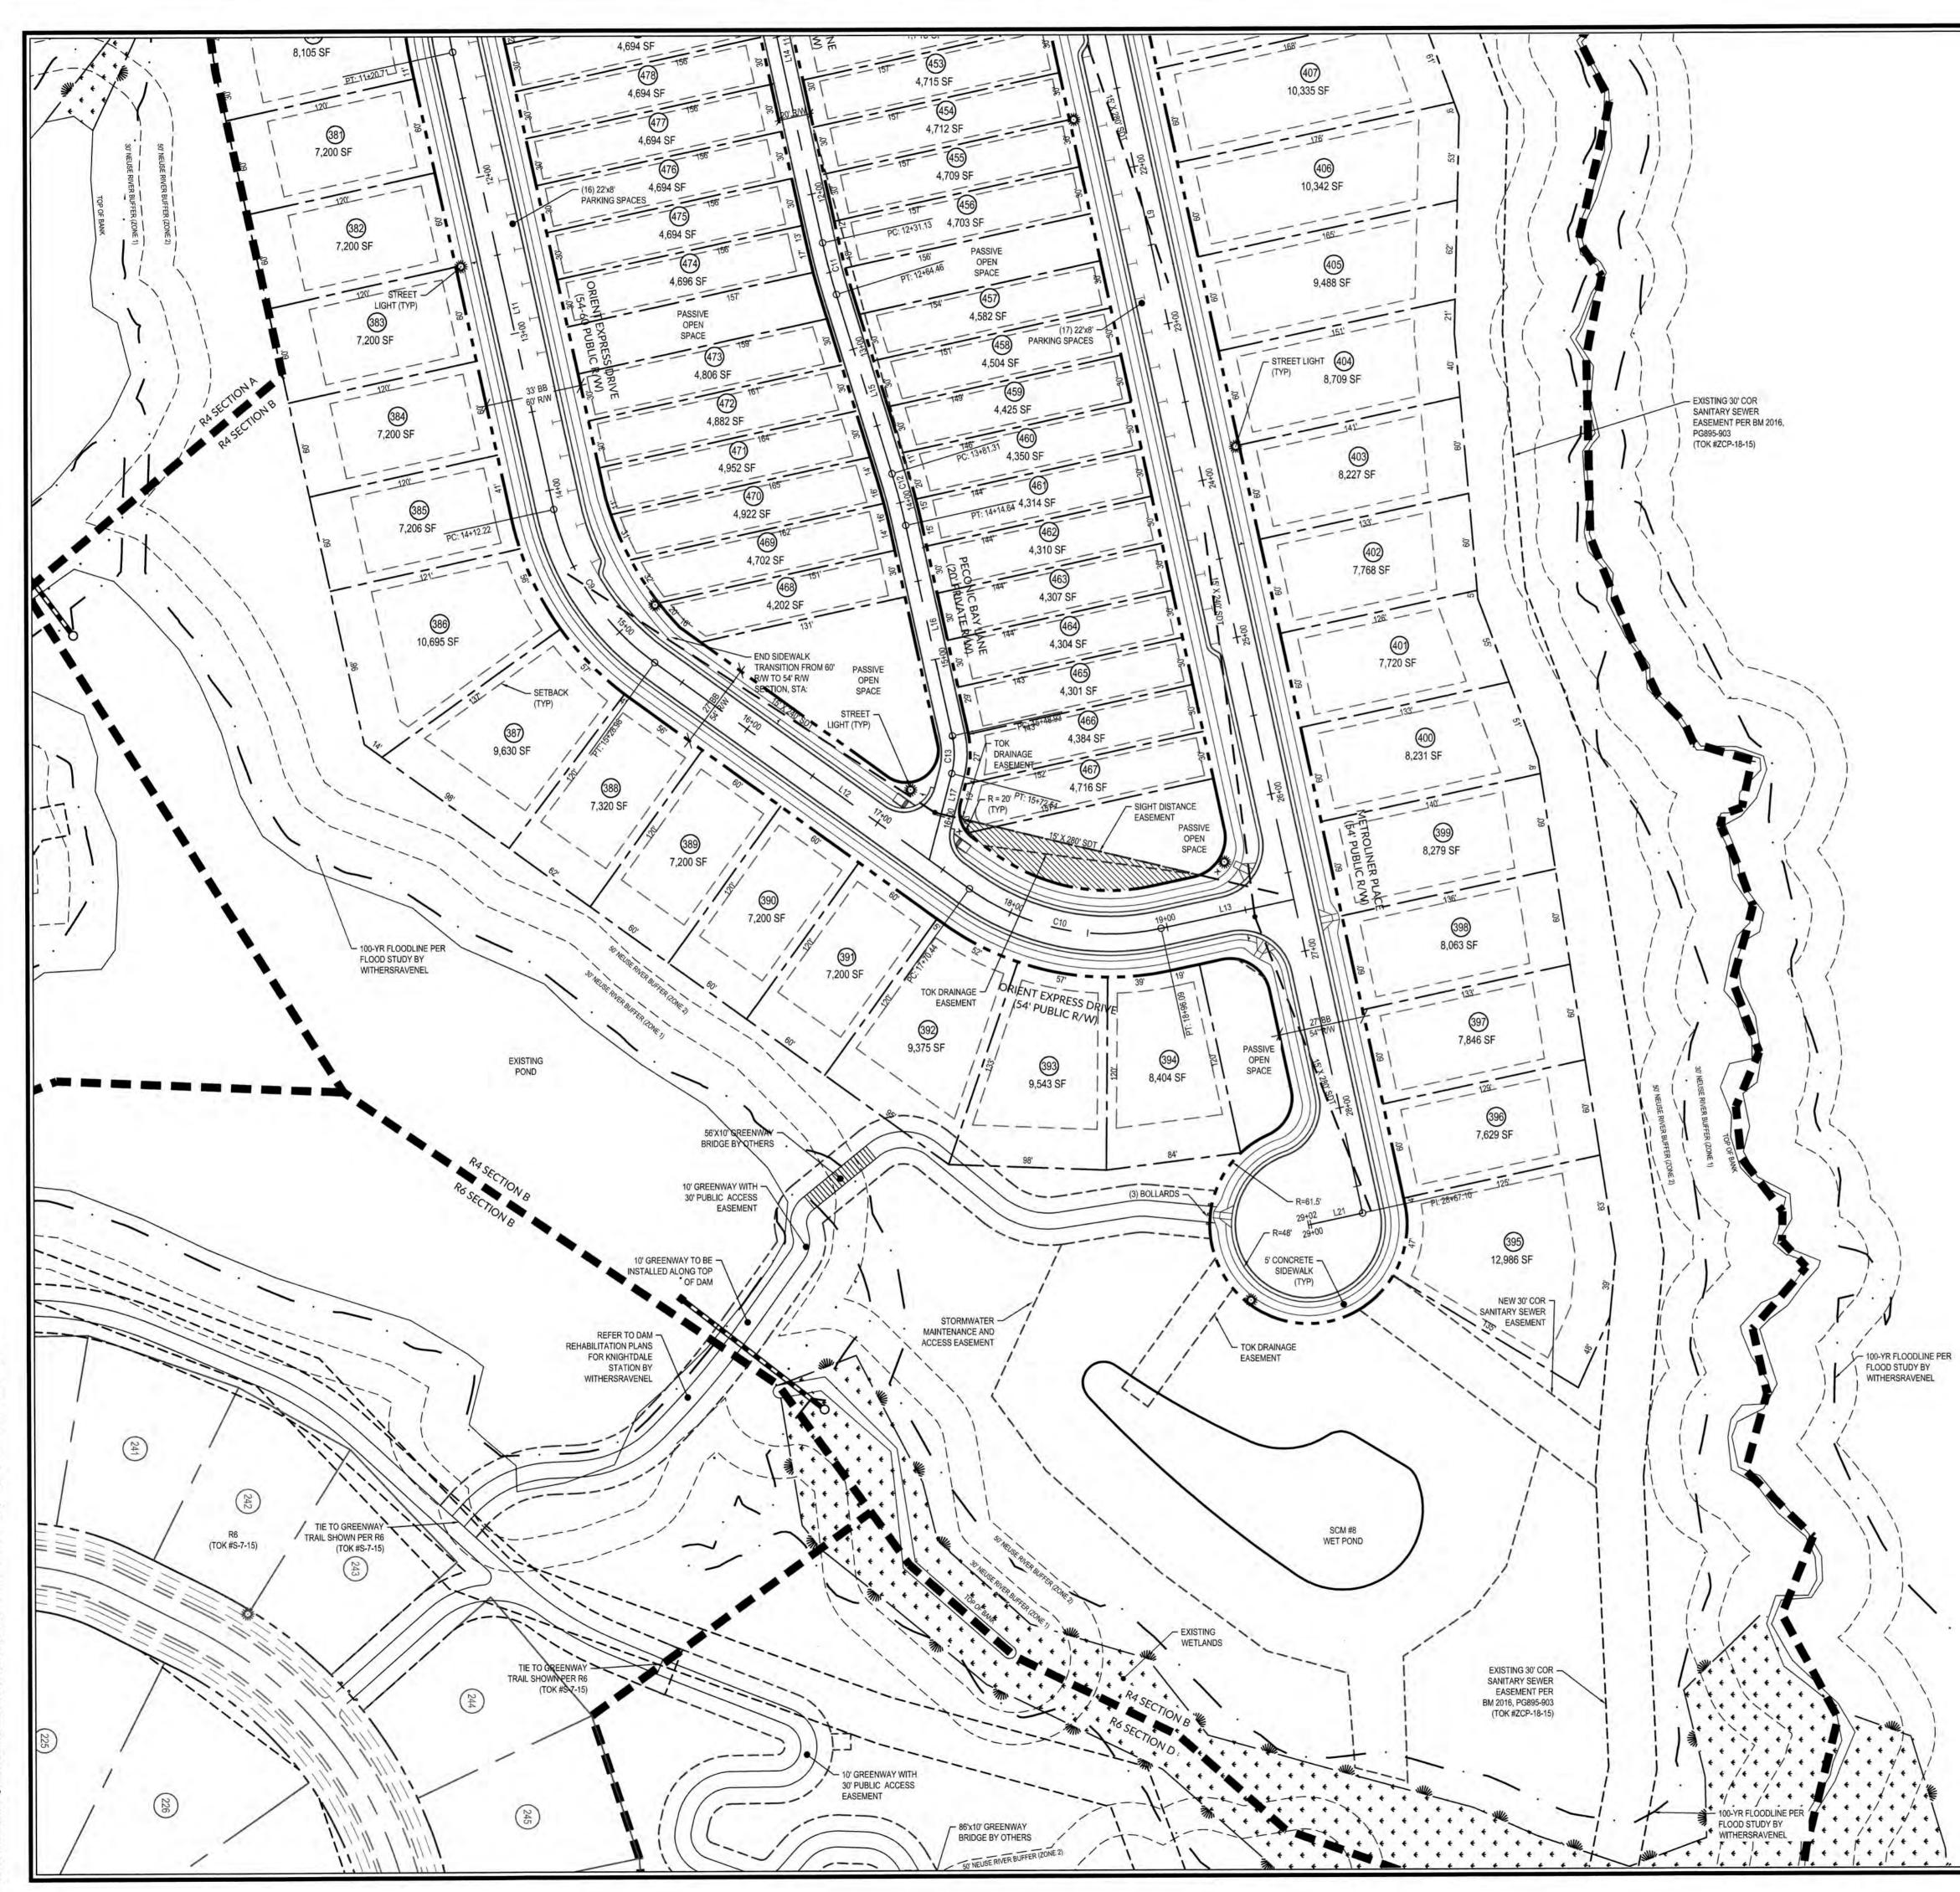

250(090251.6-Knightdale Station Phase R4)CAD\MASTER-CONSTRUCTION DRAWINGS\3.1-3.3 SITE PLANS.dwg- Friday, August 31, 2018 11:37:07 AM - DURYEA

	Adding WithersRavenel Engineers   Planners   Surveyors 115 MacKenan Drive   Cary. N.C. 27511   1: 919-469.3340   license #: C-0832   www.withersravenel.com
	KNIGHTDALE STATION R6D AND R4 Town of KNIGHTDALE, NORTH CAROLINA
TOWN CERTIFICATION. THIS DESIGN HAS BEEN REVIEWED BY THE ENGINEER FOR THE TOWN OF KNIGHTDALE, AND TO THE BEST OF MY KNOWLEDGE AND BELIEF, IT CONFORMS TO THE REQUIREMENTS ESTABLISHED IN THE STANDARD SPECIFICATIONS OF THE TOWN OF KNIGHTDALE.         BY:	SITE PLAN
PUBLIC SEWER COLLECTION/EXTENSION SYSTEM THE CITY OF RALEIGH CONSENTS TO THE CONNECTION AND EXTENSION OF THE CITY'S PUBLIC SEWER SYSTEM AS SHOWN ON THIS PLAN. THE MATERIAL AND CONSTRUCTION METHODS USED FOR THIS PROJECT SHALL CONFORM TO THE STANDARDS AND SPECIFICATIONS OF THE CITY'S PUBLIC UTILITIES HANDBOOK. CITY OF RALEIGH PUBLIC UTILITIES DEPARTMENT PERMIT # $5 - 4466$ AUTHORIZATION TO CONSTRUCT $4000$ , $40$ , $5000$ DATE $429/19$ PUBLIC WATER DISTRIBUTION/EXTENSION SYSTEM THE CITY OF RALEIGH CONSENTS TO THE CONNECTION AND EXTENSION OF THE CITY'S PUBLIC WATER SYSTEM AS SHOWN ON THIS PLAN. THE MATERIAL AND CONSTRUCTION METHODS USED FOR THIS PROJECT SHALL CONFORM TO THE STANDARDS AND SPECIFICATIONS OF THE CITY'S PUBLIC UTILITIES HANDBOOK. CITY OF RALEIGH CONSENTS TO THE CONNECTION AND EXTENSION OF THE CITY'S PUBLIC WATER SYSTEM AS SHOWN ON THIS PLAN. THE MATERIAL AND CONSTRUCTION METHODS USED FOR THIS PROJECT SHALL CONFORM TO THE STANDARDS AND SPECIFICATIONS OF THE CITY'S PUBLIC UTILITIES HANDBOOK. CITY OF RALEIGH PUBLIC UTILITIES DEPARTMENT PERMIT # $10 - 35744$ PUBLIC UTILITIES DEPARTMENT PERMIT # $10 - 35744$ AUTHORIZATION TO CONSTRUCT $4000 M - 5000 M$ .	Job No. 02090251.6 Date 06/08/2018 Designer W&R Designer Designer W&R Designer W&R Designer W&R Designer W&R Designer W&R Designer W&R Designer W&R Designer W&R Designer W&R Designer W&R Designer De
ALL MATERIALS & CONSTRUCTION METHODS SHALL BE IN ACCORDANCE WITH ALL CITY OF RALEIGH & TOWN OF KNIGHTDALE DESIGN STANDARDS, DETAILS, AND SPECIFICATIONS.	Sheet No. 3.2

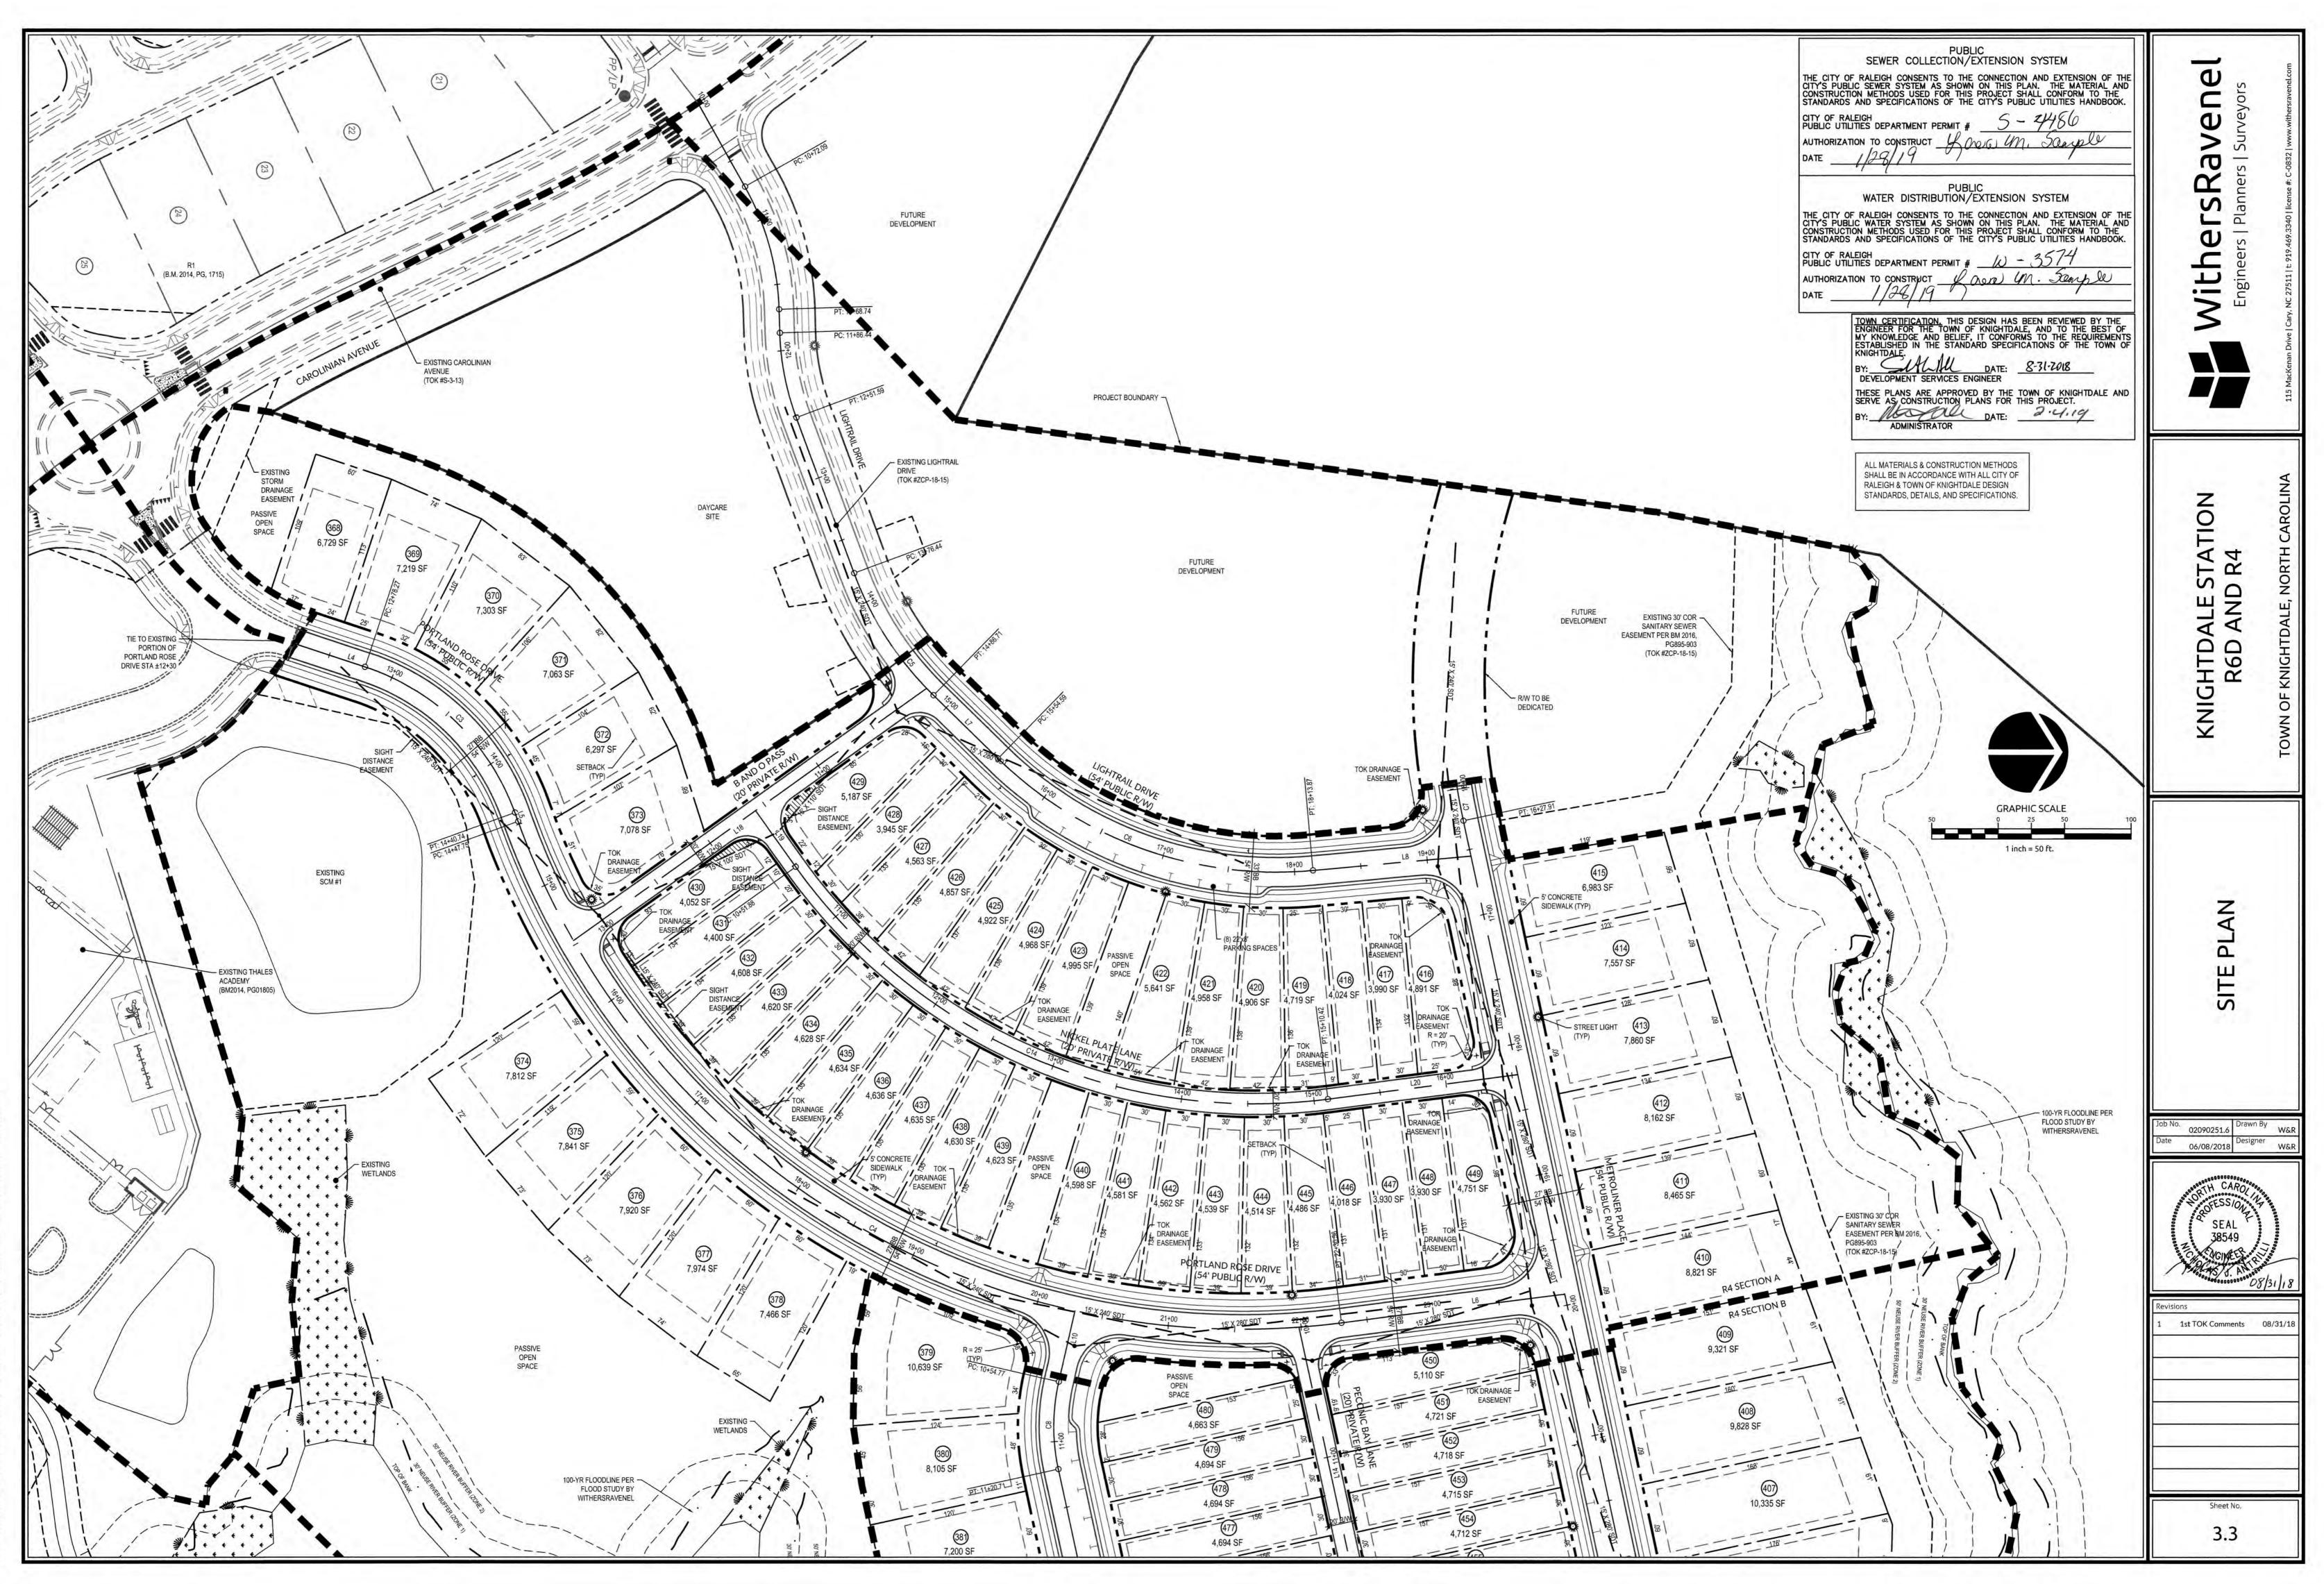

09\09-0250\090251.6-Knightdale Station Phase R4\CAD\MASTER-CONSTRUCTION DRAWINGS\3.1-3.3 SITE PLANS.dwg-Thursday, August 30, 2018 8:51:40 PM - DURYEA, COLI



9-0250(090251,6-Knightdale Station Phase R4)CAD\MASTER-CONSTRUCTION DRAWINGS\3.4-3.6 PAVEMENT MARKING & SIGNAGE PLANS.dwg- Friday, August 31, 2018 8:58:28 AM - DURYEA, COLLEI


PAVEMENT MARKINGS & SIGNAGE NOTES ALL PAVEMENT MARKINGS SHALL BE IN ACCORDANCE TO TOWN OF Ð KNIGHTDALE STANDARD AND SPECIFICATIONS, LATEST REVISIONS. 2. ALL PAVEMENT MARKINGS SHALL BE THERMOPLASTIC IN ACCORDANCE WITH TOWN OF KNIGHTDALE STANDARDS. 3. ALL SIGNAGE SHALL BE IN ACCORDANCE WITH MUTCD, LATEST C REVISION. STREET SIGNS SHALL FOLLOW THE TOWN OF KNIGHTDALE DETAIL 3.17.
 PARKING PAVEMENT MARKINGS SHALL BE 4" WHITE PAINT TO TOWN OF KNIGHTDALE STANDARDS. σ Y S Ð S Vith ш STATION R4 OLII S DN z ш шÌ AA 00 KNIG 6 1 KNIGH R( 0 U PLAN PAVEMENT MA SIGNAGE F TOWN CERTIFICATION. THIS DESIGN HAS BEEN REVIEWED BY THE ENGINEER FOR THE TOWN OF KNIGHTDALE, AND TO THE BEST OF MY KNOWLEDGE AND BELIEF, IT CONFORMS TO THE REQUIREMENTS ESTABLISHED IN THE STANDARD SPECIFICATIONS OF THE TOWN OF KNIGHTDALE. Drawn By 02090251.6 WSF PUBLIC SEWER COLLECTION/EXTENSION SYSTEM 06/08/2018 Designer W&R THE CITY OF RALEIGH CONSENTS TO THE CONNECTION AND EXTENSION OF THE CITY'S PUBLIC SEWER SYSTEM AS SHOWN ON THIS PLAN. THE MATERIAL AND CONSTRUCTION METHODS USED FOR THIS PROJECT SHALL CONFORM TO THE STANDARDS AND SPECIFICATIONS OF THE CITY'S PUBLIC UTILITIES HANDBOOK. TH CARO CITY OF RALEIGH PUBLIC UTILITIES DEPARTMENT PERMIT # 5-4486 FESSIO AUTHORIZATION TO CONSTRUCT former Un. Sample SEAL 38549 PUBLIC WATER DISTRIBUTION/EXTENSION SYSTEM THE CITY OF RALEIGH CONSENTS TO THE CONNECTION AND EXTENSION OF THE CITY'S PUBLIC WATER SYSTEM AS SHOWN ON THIS PLAN. THE MATERIAL AND CONSTRUCTION METHODS USED FOR THIS PROJECT SHALL CONFORM TO THE STANDARDS AND SPECIFICATIONS OF THE CITY'S PUBLIC UTILITIES HANDBOOK. 1st TOK Comments 08/31/18 CITY OF RALEIGH PUBLIC UTILITIES DEPARTMENT PERMIT # W - 3574AUTHORIZATION TO CONSTRUCT LORGE UM. Sample ALL MATERIALS & CONSTRUCTION METHODS SHALL BE IN ACCORDANCE WITH ALL CITY OF RALEIGH & TOWN OF KNIGHTDALE DESIGN STANDARDS, DETAILS, AND SPECIFICATIONS. GRAPHIC SCALE Sheet No 3.4 1 inch = 50 ft.

1	
/	
1	
1	
1 1	
- CERNER B	
R	
Z.	
R	
B	
FF	
R	
5	
1 2	
1 1	
4	
1	
/	
4	
1	
+ '	
+	




P/09-0250/090251.6-Knightdale Station Phase R4\CAD\MASTER-CONSTRUCTION DRAWINGS\3.4-3.6 PAVEMENT MARKING & SIGNAGE PLANS.dwg-Thursday, August 30, 2018 8:52:12 PM - DURYEA, COLLEEN

	A Withers Ravenel Engineers   Planners   Surveyors	115 MacKenan Drive   Cary, NC 27511   t: 919.469.3340   license #: C-0832   www.withersravenel.com
	KNIGHTDALE STATION R6D AND R4	TOWN OF KNIGHTDALE, NORTH CAROLINA
TOWN CERTIFICATION, THIS DESIGN HAS BEEN REVIEWED BY THE ENGINEER FOR THE TOWN OF KNIGHTDALE, AND TO THE BEST OF MY KNOWLEDGE AND BELEF, IT CONFORMS TO THE REQUIREMENTS ESTABLISHED IN THE STANDARD SPECIFICATIONS OF THE TOWN OF KNIGHTDALE.         BY:	PAVEMENT MARKING & SIGNAGE PLAN	
PUBLIC SEWER COLLECTION/EXTENSION SYSTEM         THE CITY OF RALEIGH CONSENTS TO THE CONNECTION AND EXTENSION OF THE CITY'S PUBLIC SEWER SYSTEM AS SHOWN ON THIS PLAN. THE MATERIAL AND CONSTRUCTION METHODS USED FOR THIS PROJECT SHALL CONFORM TO THE STANDARDS AND SPECIFICATIONS OF THE CITY'S PUBLIC UTILITIES HANDBOOK.         CITY OF RALEIGH PUBLIC UTILITIES DEPARTMENT PERMIT # 5 - 446 (6)         AUTHORIZATION TO CONSTRUCT         PUBLIC WATER DISTRIBUTION/EXTENSION SYSTEM         THE CITY'S PUBLIC UTILITIES HANDBOOK.         OF MALEIGH CONSENTS TO THE CONNECTION AND EXTENSION OF THE CITY OF RALEIGH CONSENTS TO THE CONNECTION AND EXTENSION OF THE CITY'S PUBLIC WATER SYSTEM AS SHOWN ON THIS PLAN. THE MATERIAL AND CONSTRUCTION METHODS USED FOR THIS PROJECT SHALL CONFORM TO THE STANDARDS AND SPECIFICATIONS OF THE CITY'S PUBLIC UTILITIES HANDBOOK.         CITY OF RALEIGH CONSENTS TO THE CONNECTION AND EXTENSION OF THE CITY'S PUBLIC WATER SYSTEM AS SHOWN ON THIS PLAN. THE MATERIAL AND CONSTRUCTION METHODS USED FOR THIS PROJECT SHALL CONFORM TO THE STANDARDS AND SPECIFICATIONS OF THE CITY'S PUBLIC UTILITIES HANDBOOK.         CITY OF RALEIGH CONSENTS TO THE CONNECTION AND EXTENSION OF THE STANDARDS AND SPECIFICATIONS OF THE CITY'S PUBLIC UTILITIES HANDBOOK.         CITY OF RALEIGH PUBLIC WATER SYSTEM         AUTHORIZATION TO CONSTRUCT         AUTHORIZATION TO CONSTRUCT         AUTHORIZATION TO CONSTRUCT         AUTHORIZATION TO CONSTRUCT         AUTHORIZ	Job No. 02090251.6 Drawn By Date 06/08/2018 Designer 06/08/2018 Designer 06/08/2018 Designer 08/07 SEAL 38549 38549 38549 08/3 Revisions 1 1st TOK Comments 08	W&R W&R
ALL MATERIALS & CONSTRUCTION METHODS SHALL BE IN ACCORDANCE WITH ALL CITY OF RALEIGH & TOWN OF KNIGHTDALE DESIGN STANDARDS, DETAILS, AND SPECIFICATIONS.	Sheet No. 3.5	

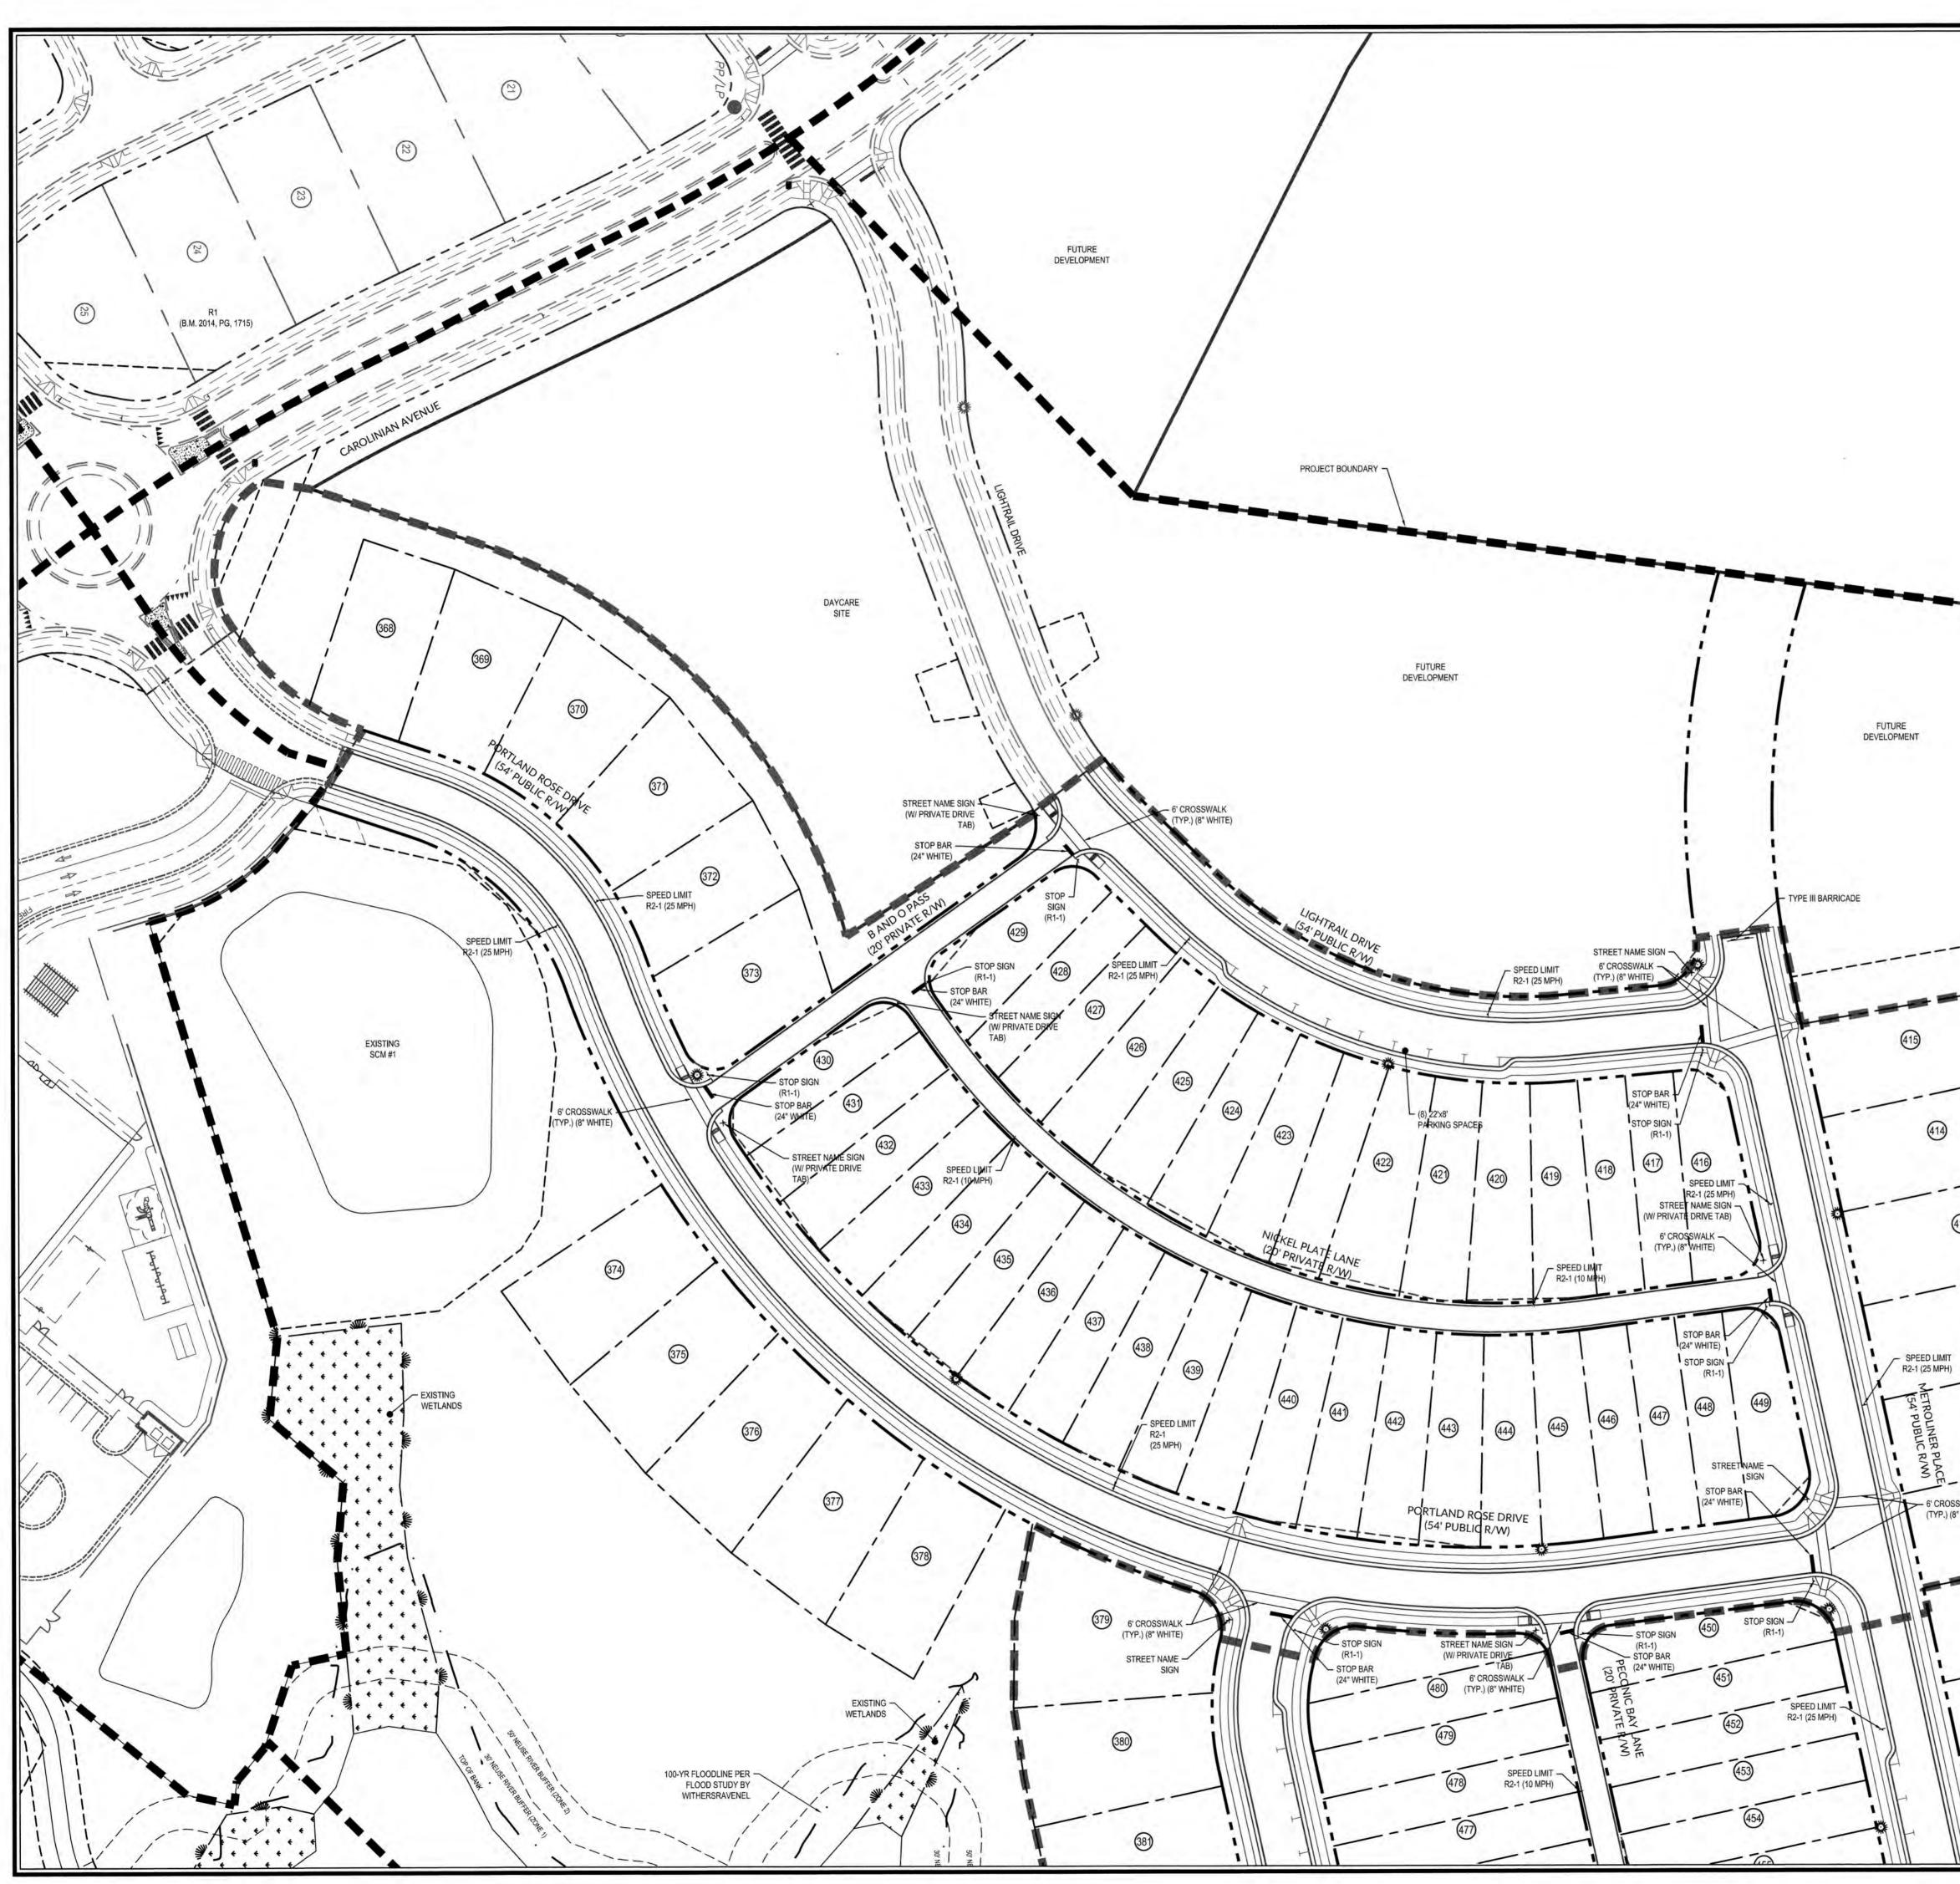

(09)(09-0250)(090251.6-Knightdale Station Phase R4)CAD)MASTER-CONSTRUCTION DRAWINGS\3.4-3.6 PAVEMENT MARKING & SIGNAGE PLANS.dwg-Thursday, August 30, 2018 8:52:18 PM - DURYEA, COLLE

PUBLIC SEWER COLLECTION/EXTENSION SYSTEM \_ Φ THE CITY OF RALEIGH CONSENTS TO THE CONNECTION AND EXTENSION OF THE CITY'S PUBLIC SEWER SYSTEM AS SHOWN ON THIS PLAN. THE MATERIAL AND CONSTRUCTION METHODS USED FOR THIS PROJECT SHALL CONFORM TO THE STANDARDS AND SPECIFICATIONS OF THE CITY'S PUBLIC UTILITIES HANDBOOK. C 0 Φ CITY OF RALEIGH PUBLIC UTILITIES DEPARTMENT PERMIT # 5 - 44486 > ypeoran. Sample AUTHORIZATION TO CONSTRUCT S 1/28/19 Ð DATE ----S R PUBLIC WATER DISTRIBUTION/EXTENSION SYSTEM S P THE CITY OF RALEIGH CONSENTS TO THE CONNECTION AND EXTENSION OF THE CITY'S PUBLIC WATER SYSTEM AS SHOWN ON THIS PLAN. THE MATERIAL AND CONSTRUCTION METHODS USED FOR THIS PROJECT SHALL CONFORM TO THE STANDARDS AND SPECIFICATIONS OF THE CITY'S PUBLIC UTILITIES HANDBOOK. Ы Ð ----S CITY OF RALEIGH PUBLIC UTILITIES DEPARTMENT PERMIT # W-3574 ith AUTHORIZATION TO CONSTRUCT forero UN. Somple Engir 3 TOWN CERTIFICATION. THIS DESIGN HAS BEEN REVIEWED BY THE ENGINEER FOR THE TOWN OF KNIGHTDALE, AND TO THE BEST OF MY KNOWLEDGE AND BELIEF, IT CONFORMS TO THE REQUIREMENTS ESTABLISHED IN THE STANDARD SPECIFICATIONS OF THE TOWN OF KNIGHTDALE. ALL MATERIALS & CONSTRUCTION METHODS SHALL BE IN ACCORDANCE WITH ALL CITY OF RALEIGH & TOWN OF KNIGHTDALE DESIGN STANDARDS, DETAILS, AND SPECIFICATIONS. TION 0 R4 SQ 2 ш ЧZ шĩ AA  $\cap$ 00 KNIGI F 9 KNIGH<sup>-</sup>R( 0 NMO **GRAPHIC SCALE** 25  $\infty$ + A. 1 inch = 50 ft. + + PAVEMENT MARKING SIGNAGE PLAN + + (414) (413) (412) - 100-YR FLOODLINE PER FLOOD STUDY BY WITHERSRAVENEL 02090251.6 Drawn By W&R 06/08/2018 Designer W&R (41) H CAR SEAL 38549 (410) - 6' CROSSWALK (TYP.) (8" WHITE) R4 SECTION A 08/31/18 ----R4 SECTION B 1st TOK Comments 08/31/18 409 408 (407) 3.6

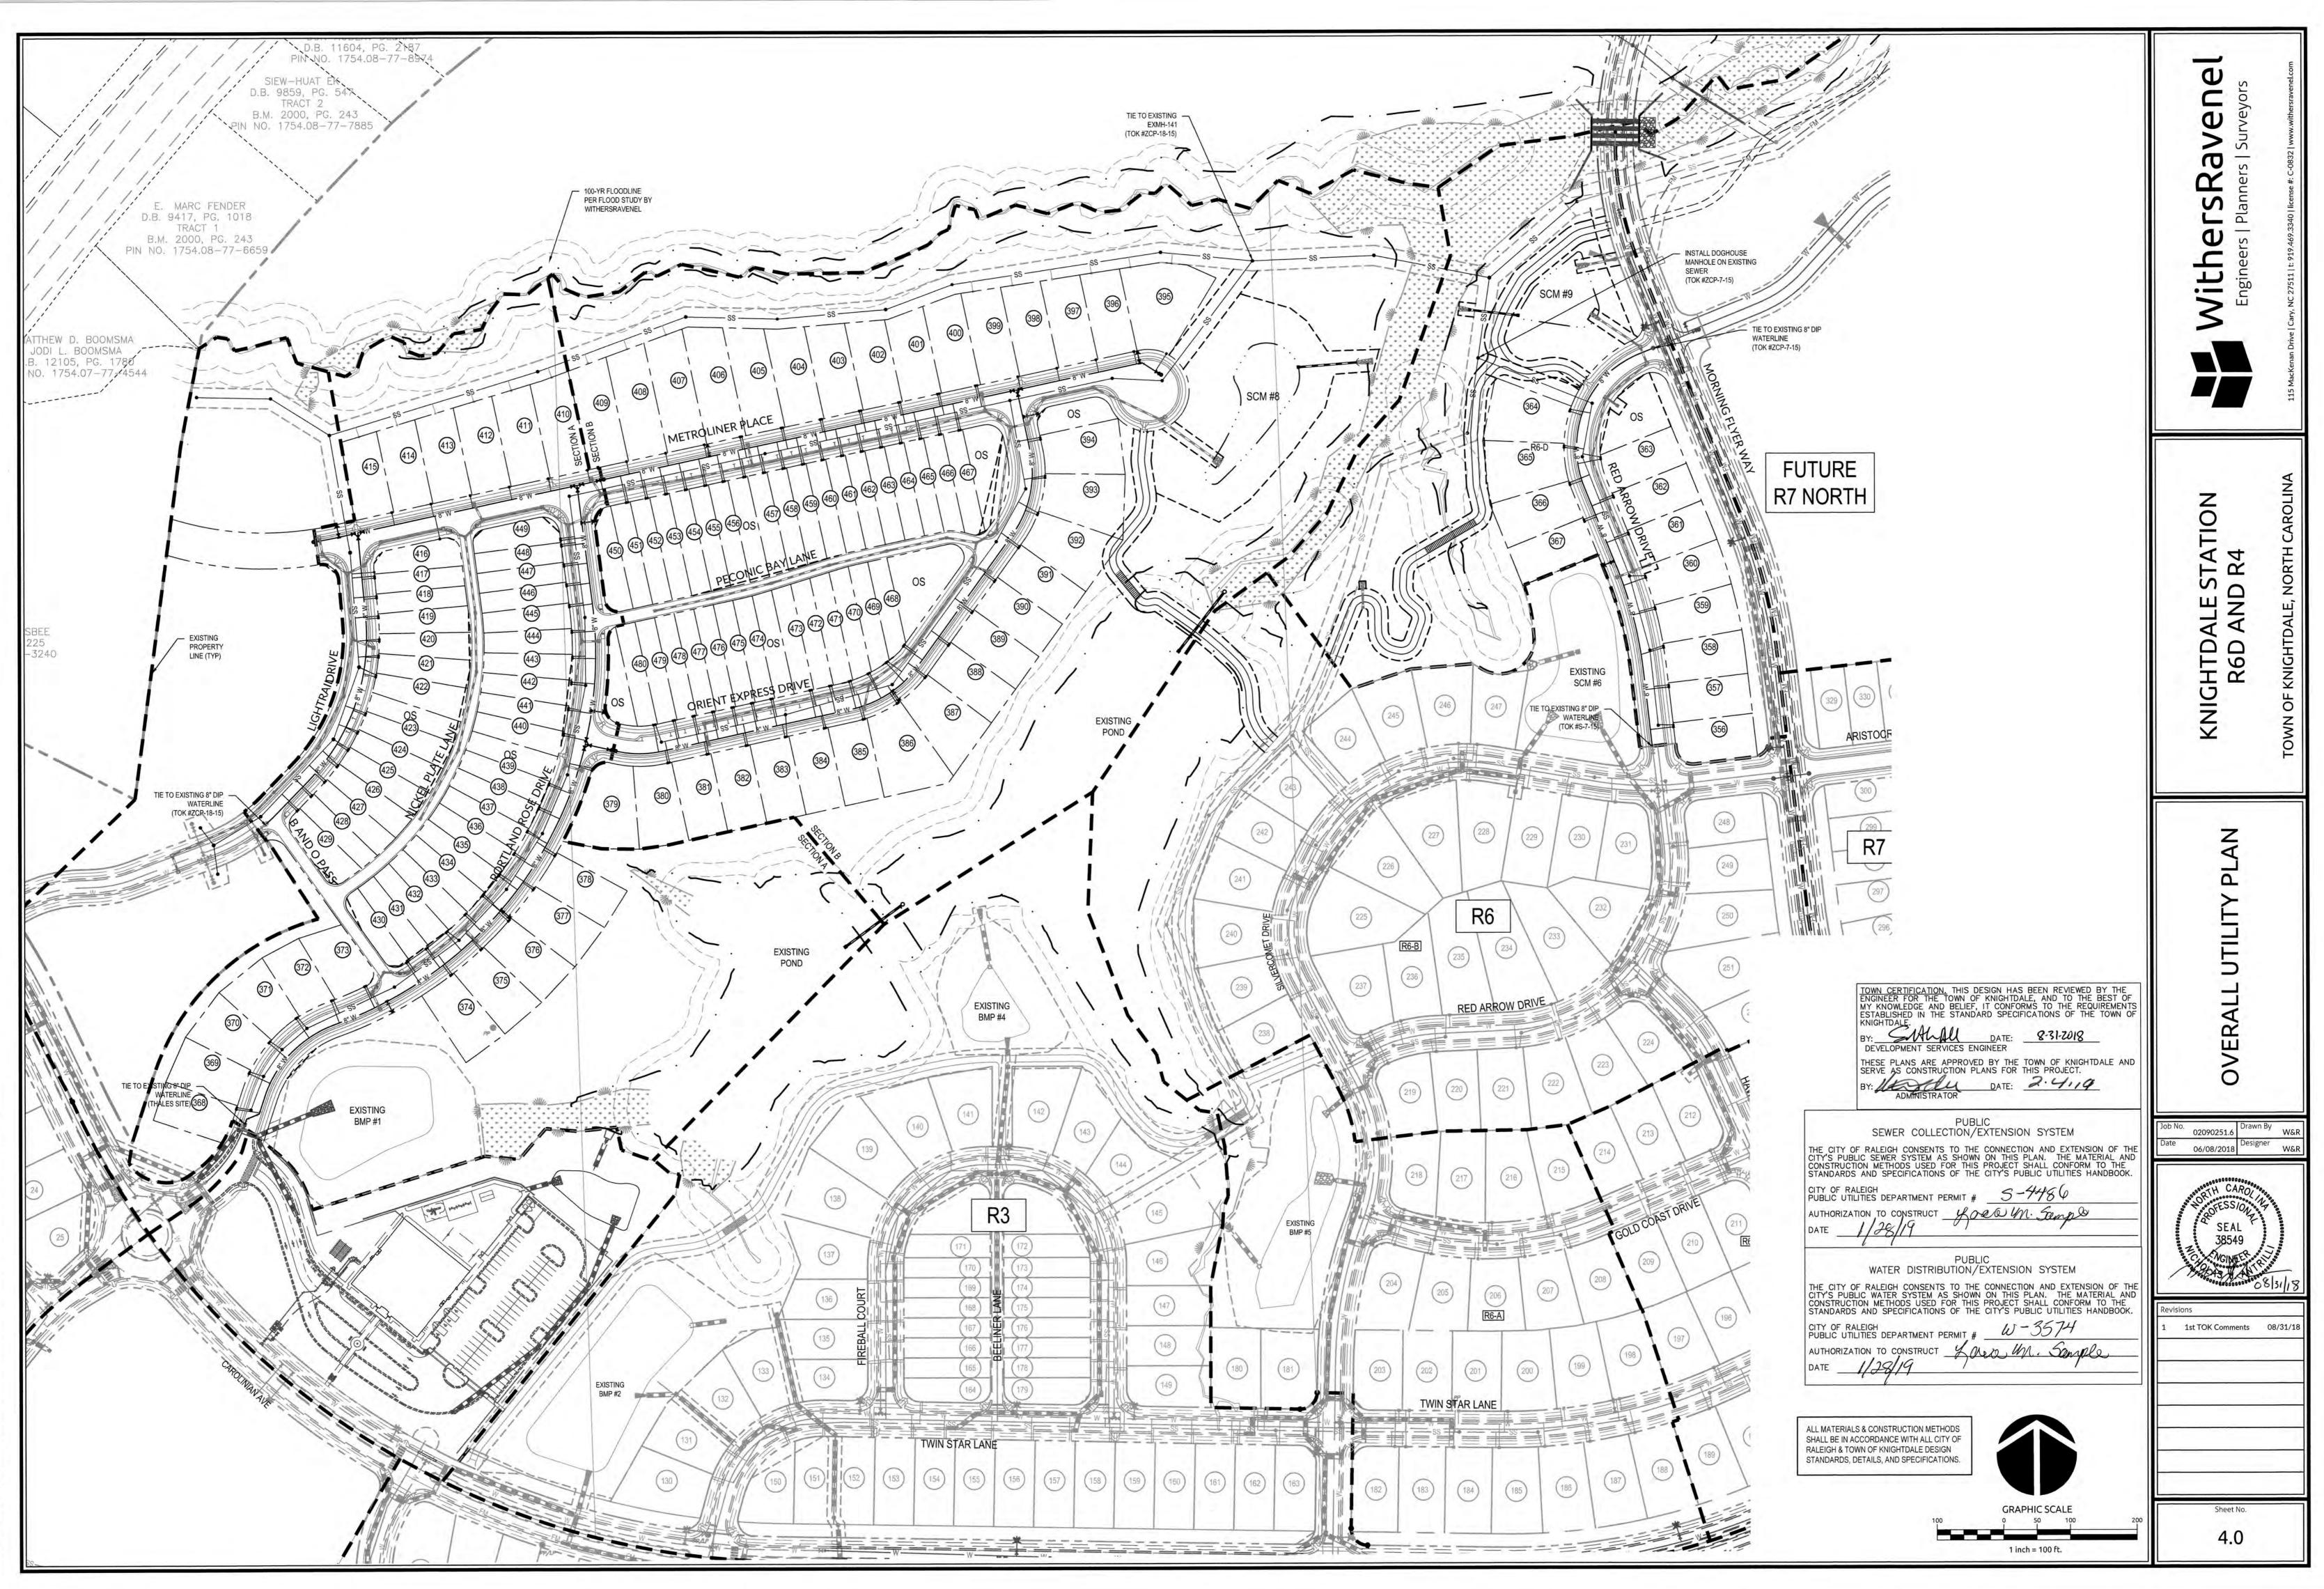

K:\09\09-0250\090251.6-Knightdale Station Phase R4\CAD\MASTER-CONSTRUCTION DRAWINGS\4.0 OVERALL UTILITY PLAN.dwg- Friday, August 31, 2018 11:37:33 AM - DURYEA, COLLEEN




09-0250/090251.6-Knightdale Station Phase R4\CAD\MASTER-CONSTRUCTION DRAWINGS\4.1-4.3 UTIUTY PLANS.dwg- Friday, August 31, 2018 11:38:03 AM - DURYEA, COL

<ul> <li>UTILITY NOTES</li> <li>1. ALL MATERIALS &amp; CONSTRUCTION METHODS SHALL BE IN ACCORDANCE WITH CITY OF RALEIGH DESIGN STANDARDS, DETAILS &amp; SPECIFICATIONS (REFERENCE:CORPUD HANDBOOK, CURRENT EDITION)</li> <li>2. UTILITY SEPARATION REQUIREMENTS:</li> <li>A) A DISTANCE OF 100' SHALL BE MAINTAINED BETWEEN SANITARY SEWER &amp; ANY PRIVATE OR PUBLIC WATER SUPPLY SOURCE SUCH AS AN IMPOUNDED RESERVOIR USED SA S JOURCE OF DRINKING WATER. IF ADEQUATE LATERAL SEPARATION CANNOT BE ACHIEVED, FERROUS SANITARY SEWER PIPE SHALL BE SPECIFIED &amp; INSTALLED TO WATERLINE SPECIFICATIONS. HOWEVER, THE MINIMUM SEPARATION SHALL NOT BE LESS THAN 25 FROM A PRIVATE WELL OR 50' FROM A PUBLIC WELL</li> <li>B) WHEN INSTALLING WATER &amp; OR SEWER MAINS, THE HORIZONTAL SEPARATION BETWEEN UTILITIES SHALL BE 10'. IF THIS SEPARATION CANNOT BE MAINTAINED DUE TO EXISTING CONDITIONS, THE VARIATION ALLOWED IF THE WATER MAIN IN A SEPARATE TRENCH WITH THE ELEVATION OF THE WATER MAIN AT LEAST 18' ABOVE THE TOP OF THE SEWER &amp; MUST BE APPROVED BY THE PUBLIC UTILITIES DIRECTOR. ALL DISTANCES ARE MEASURED FROM OUTSIDE DIAMETER TO OUTSIDE DIAMETER.</li> <li>C) WHERE IT IS IMPOSSIBLE TO GATAIN PROPER SEPARATION, OR ANYTIME A SANITARY SEWER PASSES OVER A WATERMAIN, DIP MATERIALS OR STEEL ENCASEMENT EXTENDED 10' ON EACH SIDE OF CROSSING MUST BE SPECIFIED &amp; INSTALLED TO WATERINE SPECIFICATIONS.</li> <li>D) 5.0' MINIMUM HORIZONTAL SEPARATION IS REQUIRED BETWEEN ALL SANITARY SEWER &amp; STORM SEWER FACILITIES, UNLESS DIP MATERIAL IS SPECIFIED FOR SANITARY SEWER.</li> <li>E) MAINTAIN 18' MIN. VERTICAL SEPARATION AT ALL WATERMAIN &amp; ROP STORM DRAIN CROSSINGS, MAINTAIN 24' MIN. VERTICAL SEPARATION AT ALL WATERMAIN &amp; ROP STORM DRAIN CROSSINGS, MAINTAIN 24' MIN. VERTICAL SEPARATION AT ALL WATERMAIN &amp; ROP STORM DRAIN CROSSINGS, MAINTAIN 24' MIN. VERTICAL SEPARATION AT ALL SANITARY SEWER &amp; CONTOR DRAIN CROSSINGS, MAINTAIN 24' MIN. VERTICAL SEPARATION AT ALL SANITARY SEWER &amp; SEVER FACILITIES WITH AS MIN. VERTICAL SEPARATION REQUIRED.</li> <li>3. ANY NECESSARY FIELD REVISIONS ARE</li></ul>	<b>Add WithersRavenel</b> Engineers   Planners   Surveyors
<ul> <li>Beind DSEU in Reduction of a site onless of heavise directions are not within a construction.</li> <li>Inities DEPARTMENT. THIS INCLUDES BABNDONING TAP AT MAIN &amp; REMOVAL OF SERVICE FROM ROW OR EASEMENT PER CORPUD HANDBOOK PROCEDURE.</li> <li>INSTALL 34" COPPER WATER SERVICES WITH METERS LOCATED AT ROW OR WITHIN A 2X2" WATERLINE EASEMENT IMMEDIATELY ADJACENT. NOTE: IT IS THE APPLICANT'S RESPONSIBILITY TO PROPERLY SIZE THE WATER SERVICE FOR EACH CONNECTION TO PROVIDE ADEQUATE FLOW &amp; PRESSURE.</li> <li>INSTALL 4" PVC SEWER SERVICES @ 1.0% MINIMUM GRADE WITH CLEANOUTS LOCATED AT ROW OR EASEMENT LINE &amp; SPACED EVERY 75 LINEAR FEET MAXIMUM.</li> <li>PRESSURE REDUCING VALVES ARE REQUIRED ON ALL WATER SERVICES EXCEEDING 80 PSI; BACKWATER VALVES ARE REQUIRED ON ALL SANITARY SEWER SERVICES HAVING BUILDING DRAINS LOWER THAN 1.0" ABOVE THE NEXT UPSTREAM MANHOLE.</li> <li>AL ENVIRONMENTAL PERMITS APPLICABLE TO THE PROJECT MUST BE OBTAINED FROM NCDWQ, USACE &amp;/OR FEMA FOR ANY RIPARIAN BUFFER, WETLAND &amp;/OR FLOODPLAIN IMPACTS (RESPECTIVELY) PRIOR TO CONSTRUCTION.</li> <li>AL ENVIRONMENTAL PERMITS APPLICABLE TO THE PROJECT MUST BE OBTAINED FROM NCDWQ, USACE &amp;/OR FEMA FOR ANY RIPARIAN BUFFER, WETLAND &amp;/OR FLOODPLAIN IMPACTS (RESPECTIVELY) PRIOR TO CONSTRUCTION.</li> <li>AL ENVIRONMENTAL PERMITS APPLICABLE TO THE PROJECT MUST BE OBTAINED FROM NCDWQ, USACE &amp;/OR FEMA FOR ANY RIPARIAN BUFFER, WETLAND &amp;/OR FLOODPLAIN IMPACTS (RESPECTIVELY) PRIOR TO CONSTRUCTION.</li> <li>REASE INTERCEPTOR / OIL WATER SEPARATOR SIZING CALCULATIONS &amp; INSTALLATION SPECIFICATIONS SHALL BE APPROVED BY THE COROCRAM COORDINATOR PRIOR TO CONSTRUCTION.</li> <li>GREASE INTERCEPTOR / OIL WATER SEPARATOR SIZING CALCULATIONS &amp; INSTALLATION SPECIFICATIONS SHALL BE APPROVED BY THE COROCRAM COORDINATOR PRIOR TO ISSUANCE OF A BUILDING PERMIT. CONTACT TIM BEASLEY AT (919) 996-2334 OR TIMOTHY BEASLEY@RALEIGHNC.GOV FOR MORE INFORMATION, THESE GUIDELINES ARE THE MINIMUM REQUIREMENTS. THE DEVICES SHALL MEET AMERICAN SOCIETY OF SANITARY ENGINEESTING INFORMATION PRIO</li></ul>	KNIGHTDALE STATION R6D AND R4 Town of Knightdale, North Carolina
EXISTING WATER & SEWER NOTE: TOK #ZCP-7-15 WATER & SEWER LINES SHOWN CORRESPOND TO COR PERMIT #W-3327 AND #S-4080.         ALL MATERIALS & CONSTRUCTION METHODS SHALL BE IN ACCORDANCE WITH ALL CITY OF RALEIGH & TOWN OF KNIGHTDALE DESIGN STANDARDS, DETAILS, AND SPECIFICATIONS.         EXISTING UTILITY NOTE: ALL EXISTING WATERMAINS & DOWNISTREAM SEWER FACILITIES TO WHICH THIS PROJECT CONNECTS SHALL BE ACCEPTED BY THE CITY OF RALEIGH FOR MAINTENANCE PRIOR TO RELEASE OF 1ST CO IN KNIGHTDALE STAILD RED & X PHASE OF DEVELOPMENT (SECTIONS A, B), REF: 2014 EDITION OF CORPUD HANDBOOK, PAGES 25-32	UTILITY PLAN
PUBLIC SEWER COLLECTION/EXTENSION SYSTEM THE CITY OF RALEIGH CONSENTS TO THE CONNECTION AND EXTENSION OF THE CITYS PUBLIC SEWER SYSTEM AS SHOWN ON THIS PROJECT SHALL CONFORM TO THE STANDARDS AND SPECIFICATIONS OF THE CITYS PUBLIC UTILITIES HANDBOOK. CITY OF RALEIGH PUBLIC UTILITIES DEPARTMENT PERMIT # 5-44766 AUTHORIZATION TO CONSTRUCT	Job No.     02090251.6     Drawn By     W&R       Date     06/08/2018     Designer     W&R       08/31/18     Designer     W&R
ALL MATERIALS & CONSTRUCTION METHODS SHALL BE IN ACCORDANCE WITH ALL CITY OF RALEIGH & TOWN OF KNIGHTDALE DESIGN STANDARDS, DETAILS, AND SPECIFICATIONS. GRAPHIC SCALE 50 0 25 50 100 1 inch = 50 ft.	Sheet No. 4.1




109-02501090251.6-Knightdale Station Phase R41CAD1MASTER-CONSTRUCTION DRAWINGS14.1-4.3 UTILITY PLANS.dwg- Friday, August 31, 2018 11:38:12 AM - DURYEA, COLLEI

	Add WithersRavenel Engineers   Planners   Surveyors 115 Mackenan Drive   Cary, NC 27511 Lt: 919-469.3340   license #: C-0832   www.withersravenel.com
EXISTING MH141 NOTE: CONTRACTOR SHALL MAKE CONNECTION INTO EXMH141 PER CITY OF RALEIGH STANDARD SPECIFICATIONS VIA A CONCRETE CORING MACHINE, AND THE PIPE CONNECTION MUST BE MADE WITH A FLEXIBLE RUBBER BOOT. SEE CITY OF RALEIGH SPECIFICATION FOR ADDITIONAL REQUIREMENTS.	KNIGHTDALE STATION R6D AND R4 Town of Knightdale, North Carolina
EXISTING SEWER NOTE: TOK #ZCP-7-15 SEWER LINES SHOWN CORRESPOND TO COR PERMIT #S-4080. EXISTING UTILITY NOTE: ALL EXISTING WATERMAINS & DOWNSTREAM SEWER FACILITIES TO WHICH THIS PROJECT CONNECTS SHALL BE ACCEPTED BY THE CITY OF RALEIGH FOR MAINTENANCE PRIOR TO RELEASE OF 1ST CO IN KNIGHTDALE STATION, R&D, R.4 PHASE OF DEVELOPMENT (SECTIONS A & B). REF: 2014 EDITION OF CORPUD HANDBOOK, PAGES 25-32 TOWN CERTIFICATION. THIS DESIGN HAS BEEN REVIEWED BY THE ENGINEER FOR THE TOWN OF KNIGHTDALE, AND TO THE BEST OF MY KNOWLEDGE AND BELIEF, IT COMFORMS TO THE REQUIREMENTS ESTABLISHED IN THE STANDARD SPECIFICATIONS OF THE TOWN OF KNIGHTDALE. BY: DEVELOPMENT SERVICES ENGINEER THESE PLANS ARE APPROVED BY THE TOWN OF KNIGHTDALE AND SERVE AS CONSTRUCTION PLANS FOR THIS PROJECT. BY: MADINISTRATOR	UTILITY PLAN
PUBLIC SEWER COLLECTION/EXTENSION SYSTEM         THE CITY OF RALEIGH CONSENTS TO THE CONNECTION AND EXTENSION OF THE CITY'S PUBLIC SEWER SYSTEM AS SHOWN ON THIS PLAN. THE MATERIAL AND CONSTRUCTION METHODS USED FOR THIS SPROJECT SHALL CONFORM TO THE STANDARDS AND SPECIFICATIONS OF THE CITY'S PUBLIC UTILITIES HANDBOOK.         CITY OF RALEIGH PUBLIC UTILITIES DEPARTMENT PERMIT #	Job No.     02090251.6     Drawn By     W&R       Date     06/08/2018     Designer     W&R       08/31/18     Designer     08/31/18
GRAPHIC SCALE 50 0 25 50 100 1 inch = 50 ft.	Sheet No. 4.2

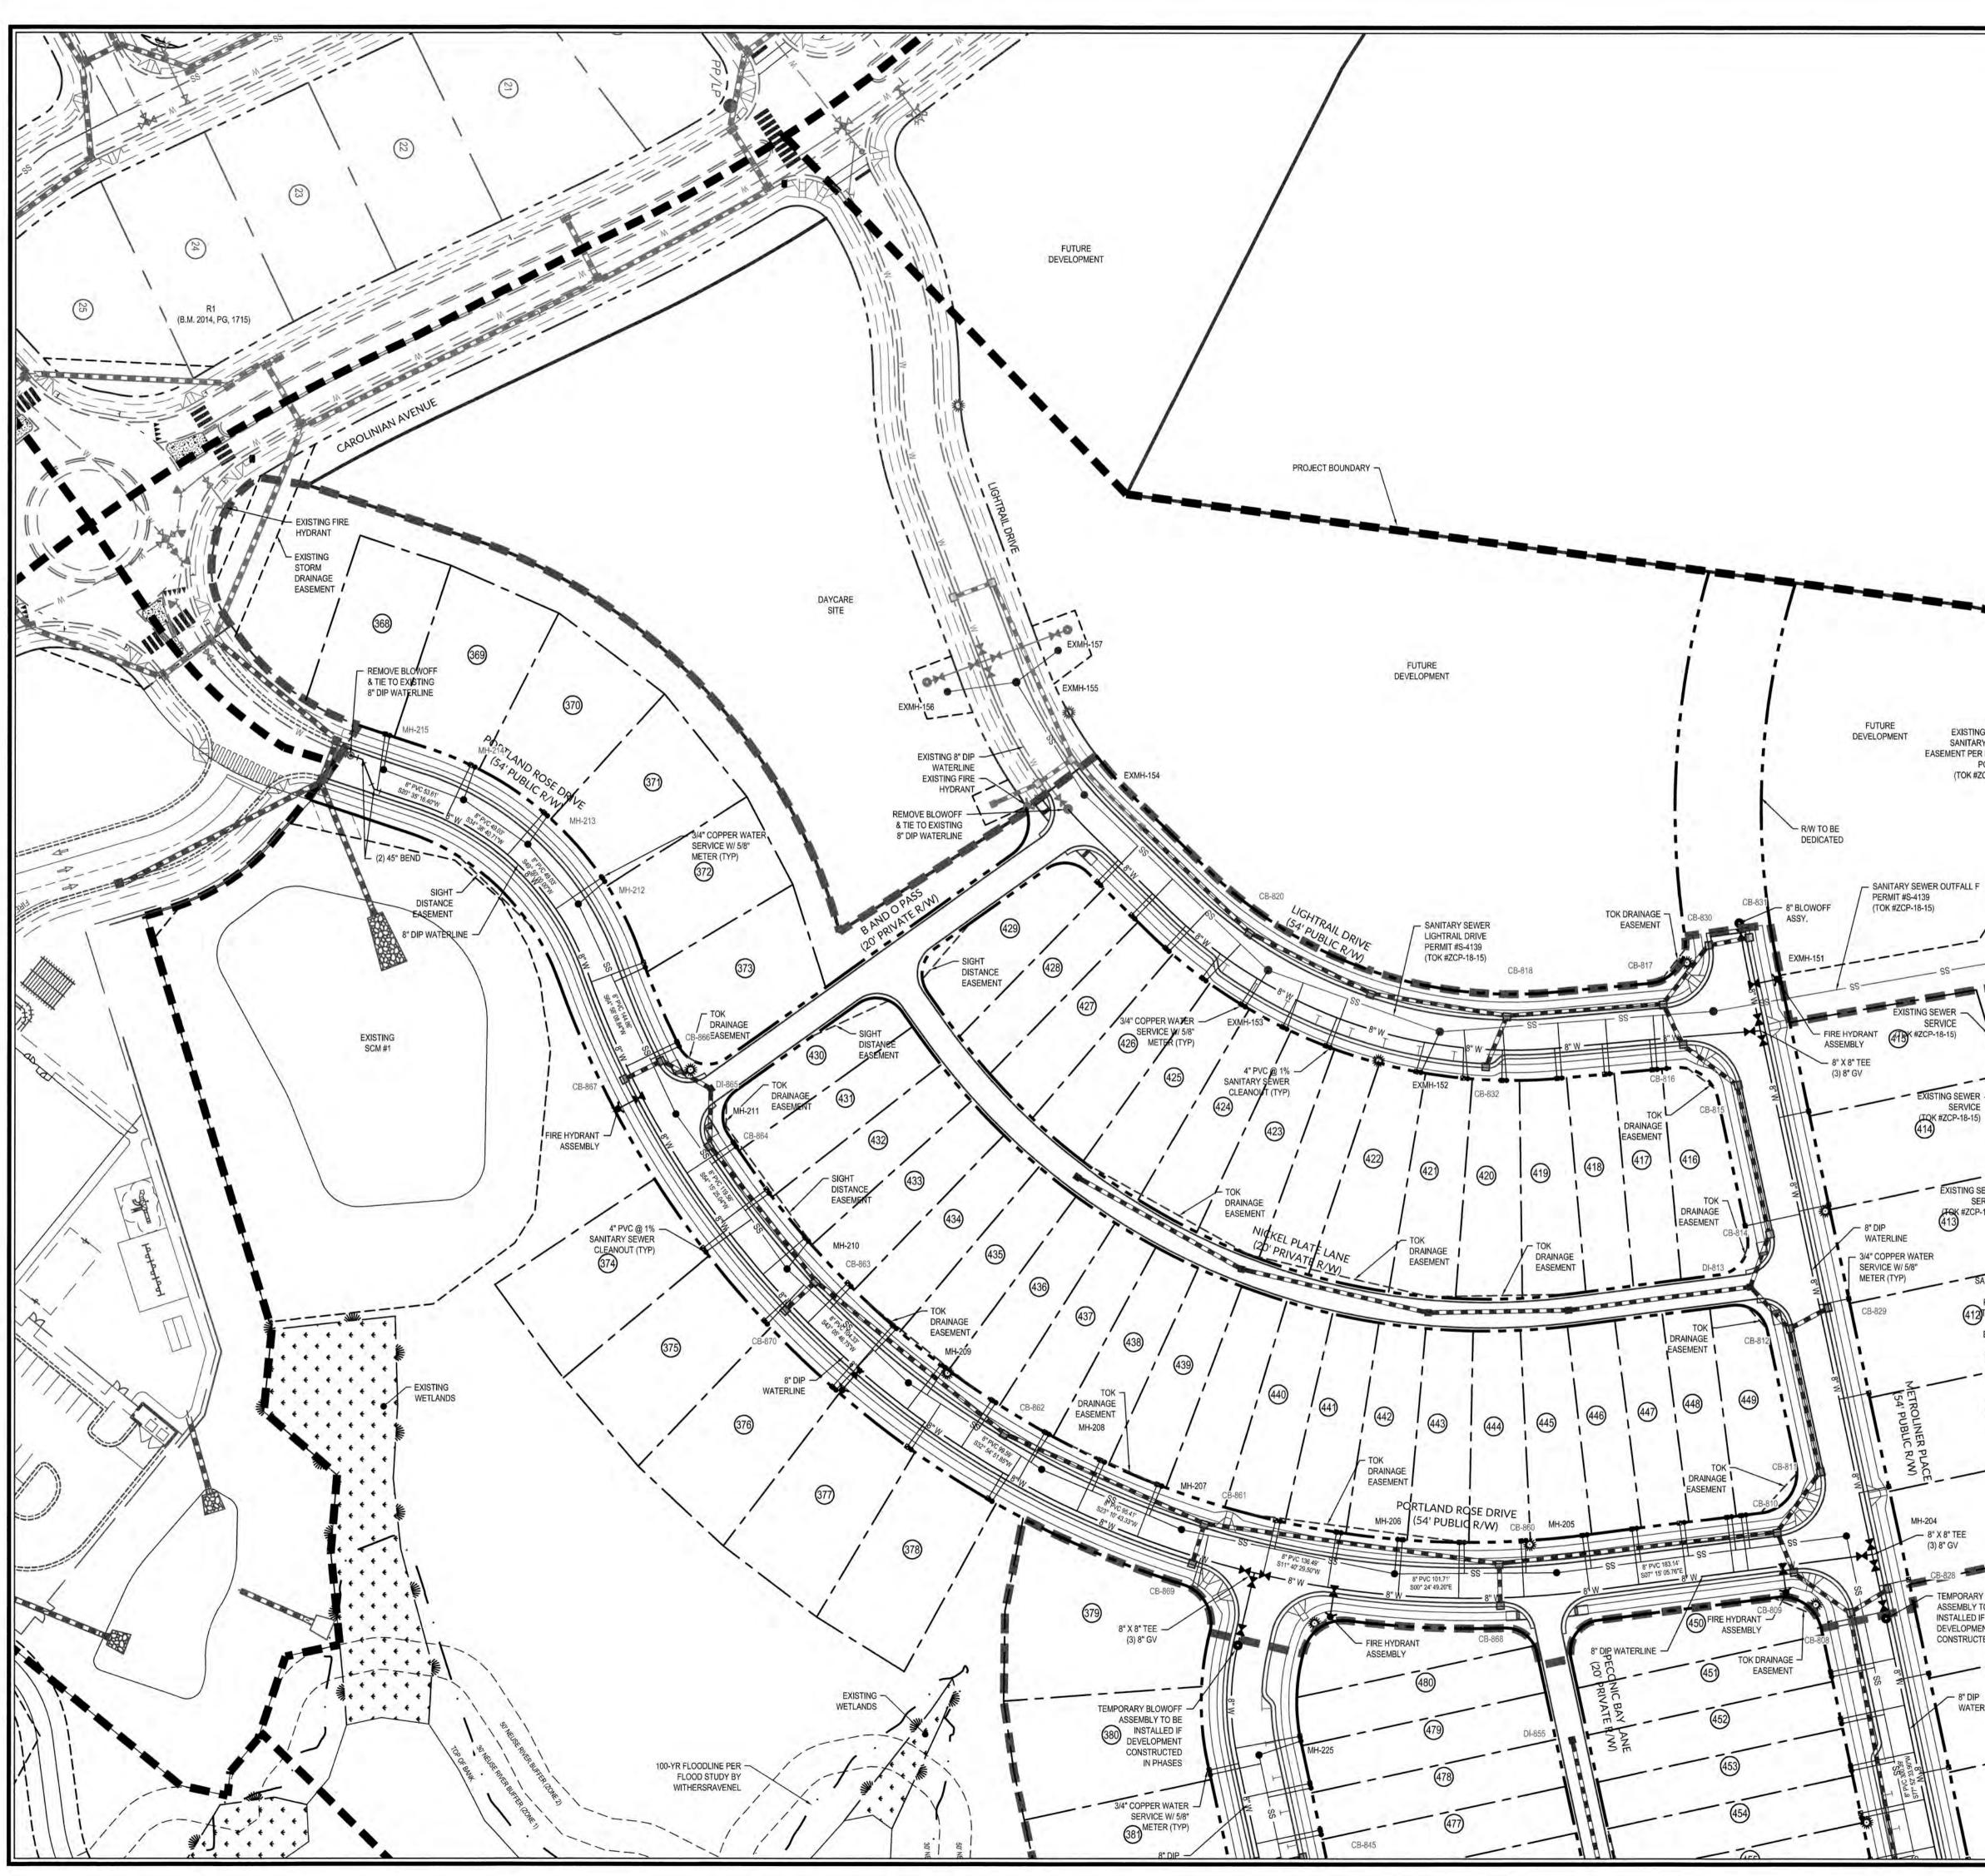


K:\09\09-0250\090251.6-Knightdale Station Phase R4\CAD\MASTER-CONSTRUCTION DRAWINGS\4.1-4.3 UTILITY PLANS.dwg- Friday. August 31, 2018 11:38:23 AM - DURYEA, COLLEEN

PUBLIC SEWER COLLECTION/EXTENSION SYSTEM -Φ THE CITY OF RALEIGH CONSENTS TO THE CONNECTION AND EXTENSION OF THE CITY'S PUBLIC SEWER SYSTEM AS SHOWN ON THIS PLAN. THE MATERIAL AND CONSTRUCTION METHODS USED FOR THIS PROJECT SHALL CONFORM TO THE STANDARDS AND SPECIFICATIONS OF THE CITY'S PUBLIC UTILITIES HANDBOOK. 0 CITY OF RALEIGH S-4486 Φ AUTHORIZATION TO CONSTRUCT & DEC M. Sumple > S P S Υ PUBLIC WATER DISTRIBUTION/EXTENSION SYSTEM S THE CITY OF RALEIGH CONSENTS TO THE CONNECTION AND EXTENSION OF THE CITY'S PUBLIC WATER SYSTEM AS SHOWN ON THIS PLAN. THE MATERIAL AND CONSTRUCTION METHODS USED FOR THIS PROJECT SHALL CONFORM TO THE STANDARDS AND SPECIFICATIONS OF THE CITY'S PUBLIC UTILITIES HANDBOOK. -D Φ \_\_\_\_ S With CITY OF RALEIGH PUBLIC UTILITIES DEPARTMENT PERMIT #  $\underline{W - 3574}$ AUTHORIZATION TO CONSTRUCT & DECO UN. Sample Engin 1129/19 DATE TOWN CERTIFICATION. THIS DESIGN HAS BEEN REVIEWED BY THE ENGINEER FOR THE TOWN OF KNIGHTDALE, AND TO THE BEST OF MY KNOWLEDGE AND BELIEF, IT CONFORMS TO THE REQUIREMENTS ESTABLISHED IN THE STANDARD SPECIFICATIONS OF THE TOWN OF KNIGHTDALE. BY: <u>BULLIU</u> DATE: <u>8-31-2018</u> DEVELOPMENT SERVICES ENGINEER ALL MATERIALS & CONSTRUCTION METHODS SHALL BE IN ACCORDANCE WITH ALL CITY OF RALEIGH & TOWN OF KNIGHTDALE DESIGN STANDARDS, DETAILS, AND SPECIFICATIONS. z TIO A 4 Fè R D N NO ЧZ EXISTING 30' COR -SANITARY SEWER EASEMENT PER BM 2016, 00 PG895-903 (TOK #ZCP-18-15) F 0 TA KNIG **GRAPHIC SCALE** 2012 1 inch = 50 ft. \* \* TING SEWER + + + Z EXISTING SEWER -SERVICE (TOK #ZCP-18-15) (414) Δ EXISTING SEWER SERVICE (413) (413) SANITARY SEWER OUTFALL E PERMIT #S-4139 (412)TOK #ZCP-18-15) 100-YR FLOODLINE PER EXISTING SEWER FLOOD STUDY BY SERVICE 02090251.0 WITHERSRAVENEL (TOK #ZCP-18-15) 06/08/2018 Designer EXISTING SEWER -W&I SERVICE (41)<sup>OK #ZCP-18-15)</sup> - EXISTING 30' COR SANITARY SEWER SEAL EXISTING SEWER EASEMENT PER &M 2016, 38549 SERVICE PG895-903 (410)TOK #ZCP-18-15) (TOK #ZCP-18-15) R4 SECTION A - 8" X 8" TEE -(3) 8" GV R4 SECTION B 1st TOK Comments 08/31/18 409 - TEMPORARY BLOWOFF ASSEMBLY TO BE INSTALLED IF DEVELOPMENT CONSTRUCTED IN PHASES 408 - 8" DIP WATERLINE Sheet No 4.3

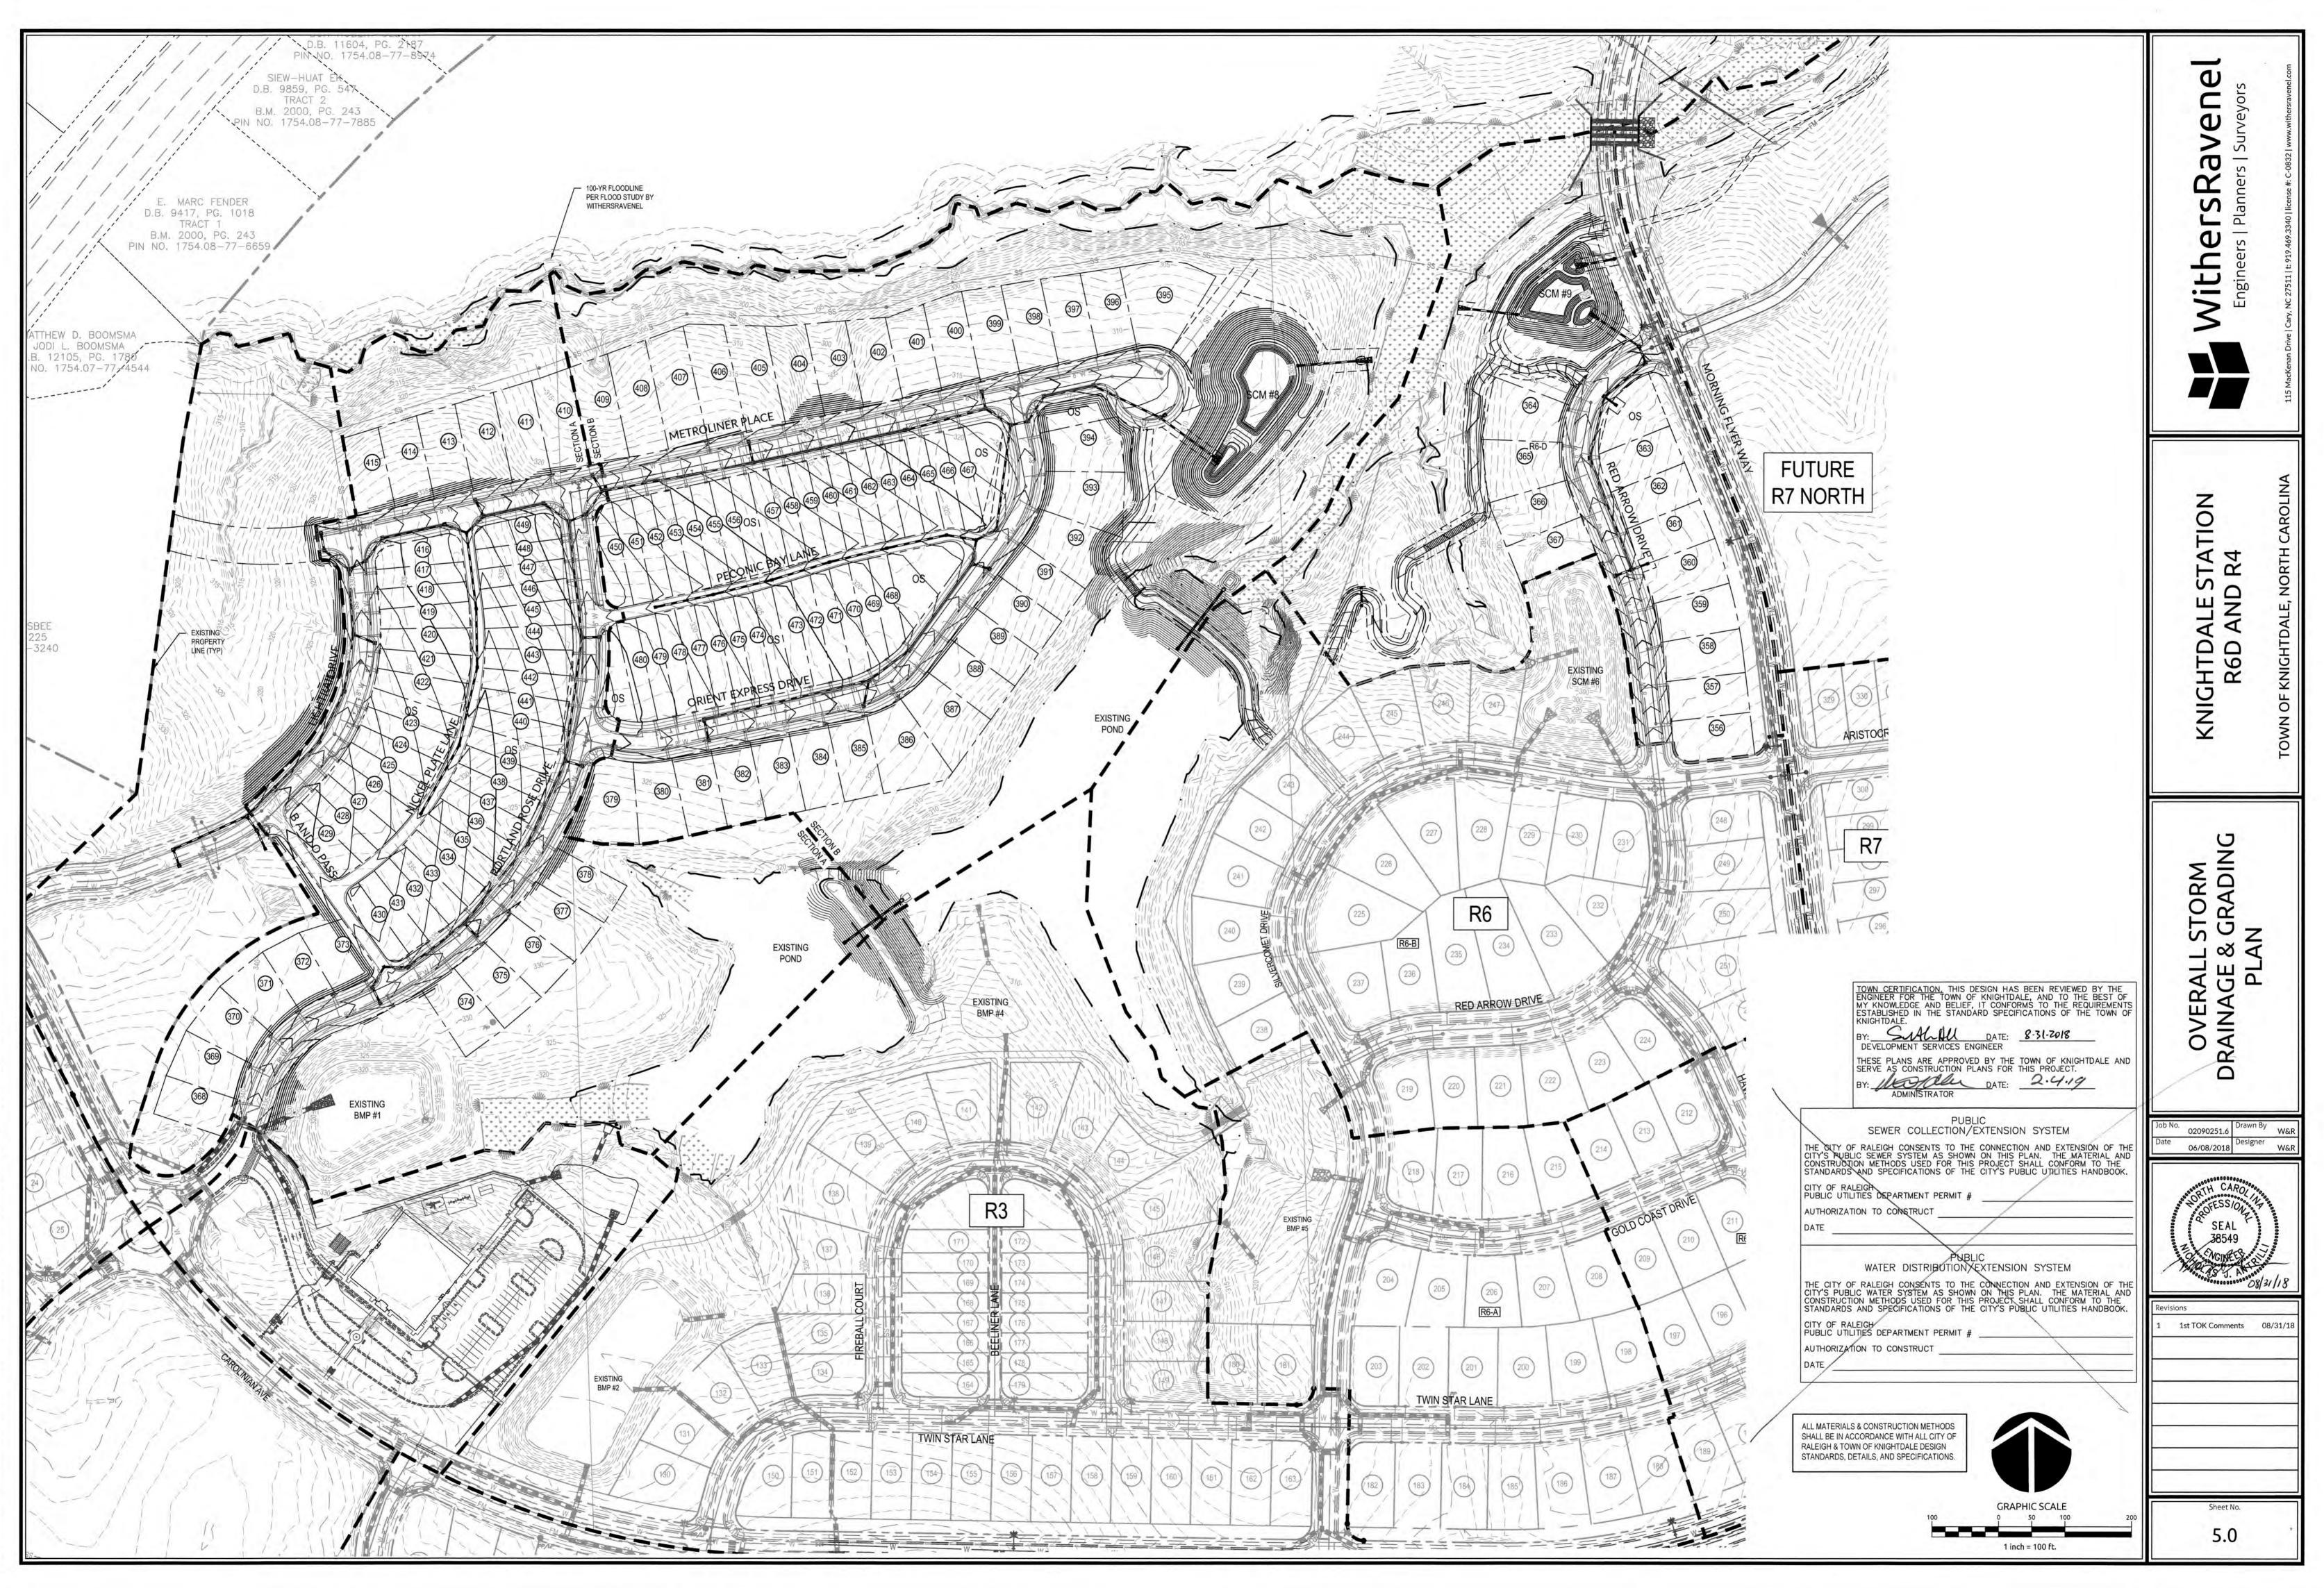


:109/09-0250/090251.6-Knightdale Station Phase R4\CAD\MASTER-CONSTRUCTION DRAWINGS\5:0 OVERALL STORM DRAINAGE AND GRADING PLAN.dwg- Friday, August 31, 2018 9:00:19 AM - DURYEA, COLLEEN

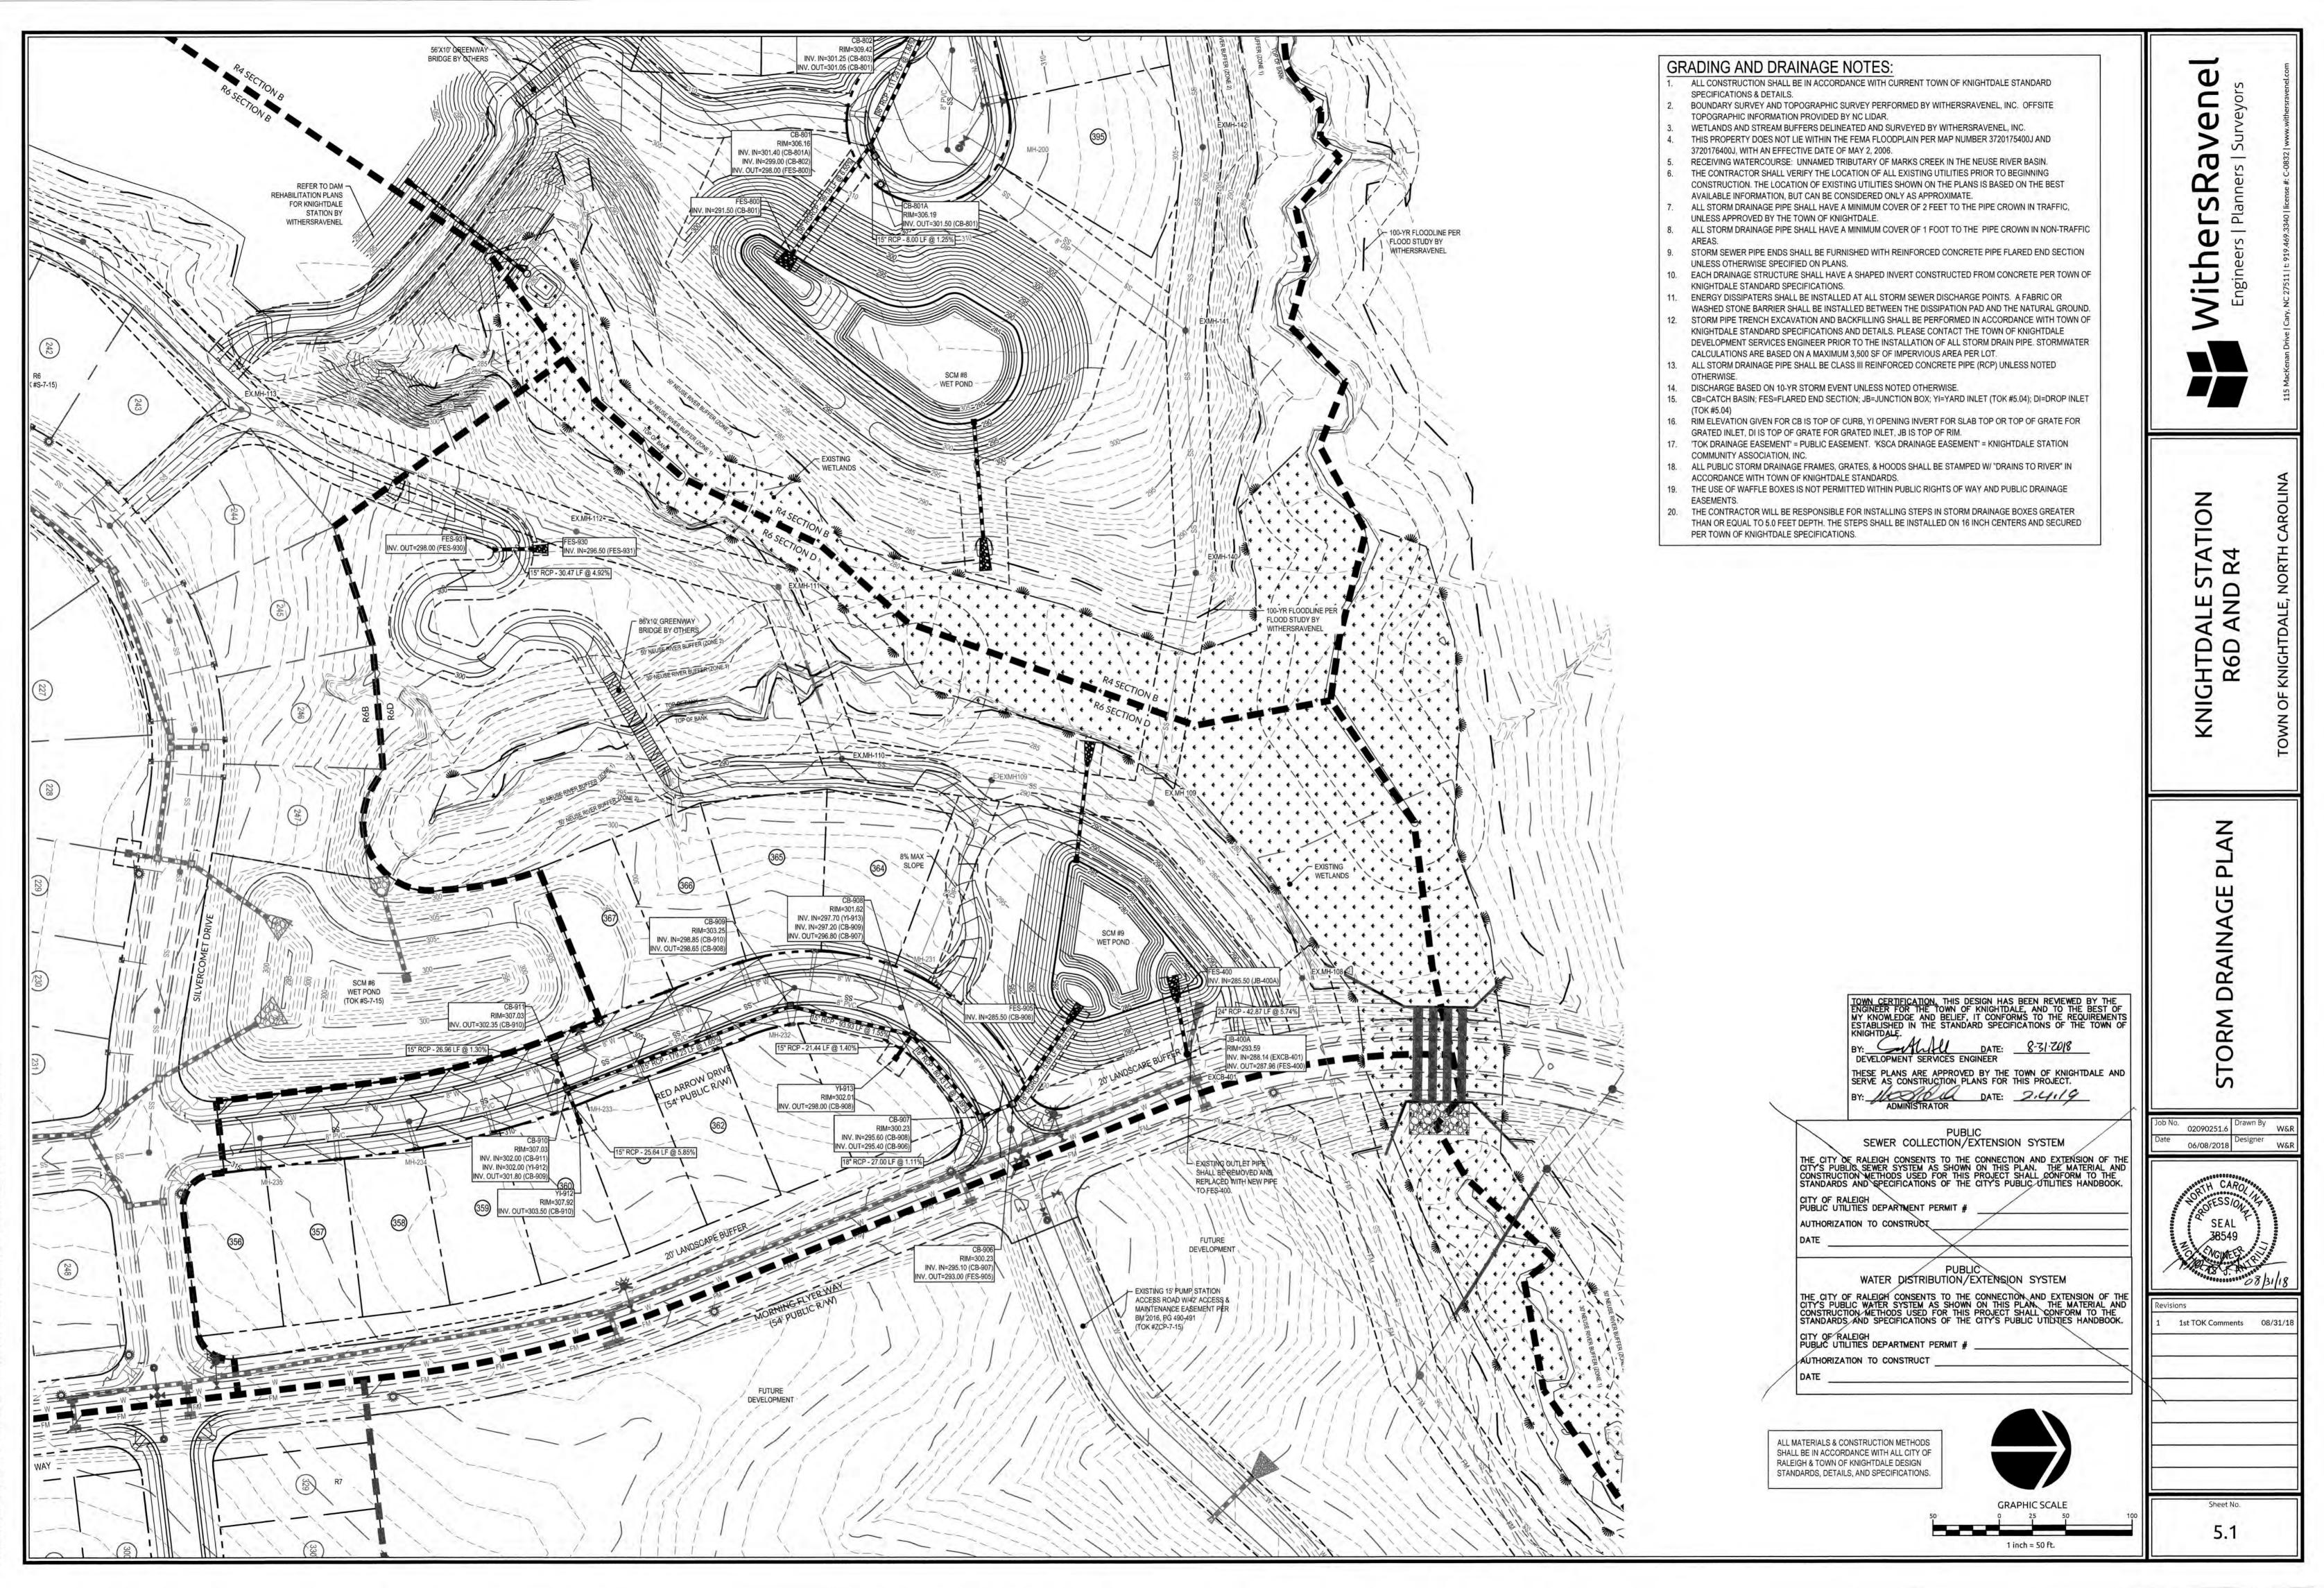


09/09-0250/090251.6-Knightale Station Phase R4/CAD/MASTER-CONSTRUCTION DRAWINGS\5.1-5.4 STORM DRAINAGE PLANS.dwg-Friday, August 31, 2018 12:26:31 PM - DURYEA, COLLEEN



09-0250(090251.6-Knightdale Station Phase R4\CAD\MASTER-CONSTRUCTION DRAWINGS\5.1-5.4 STORM DRAINAGE PLANS.dwg- Friday, August 31, 2018 12:26:39 PM - DURYE

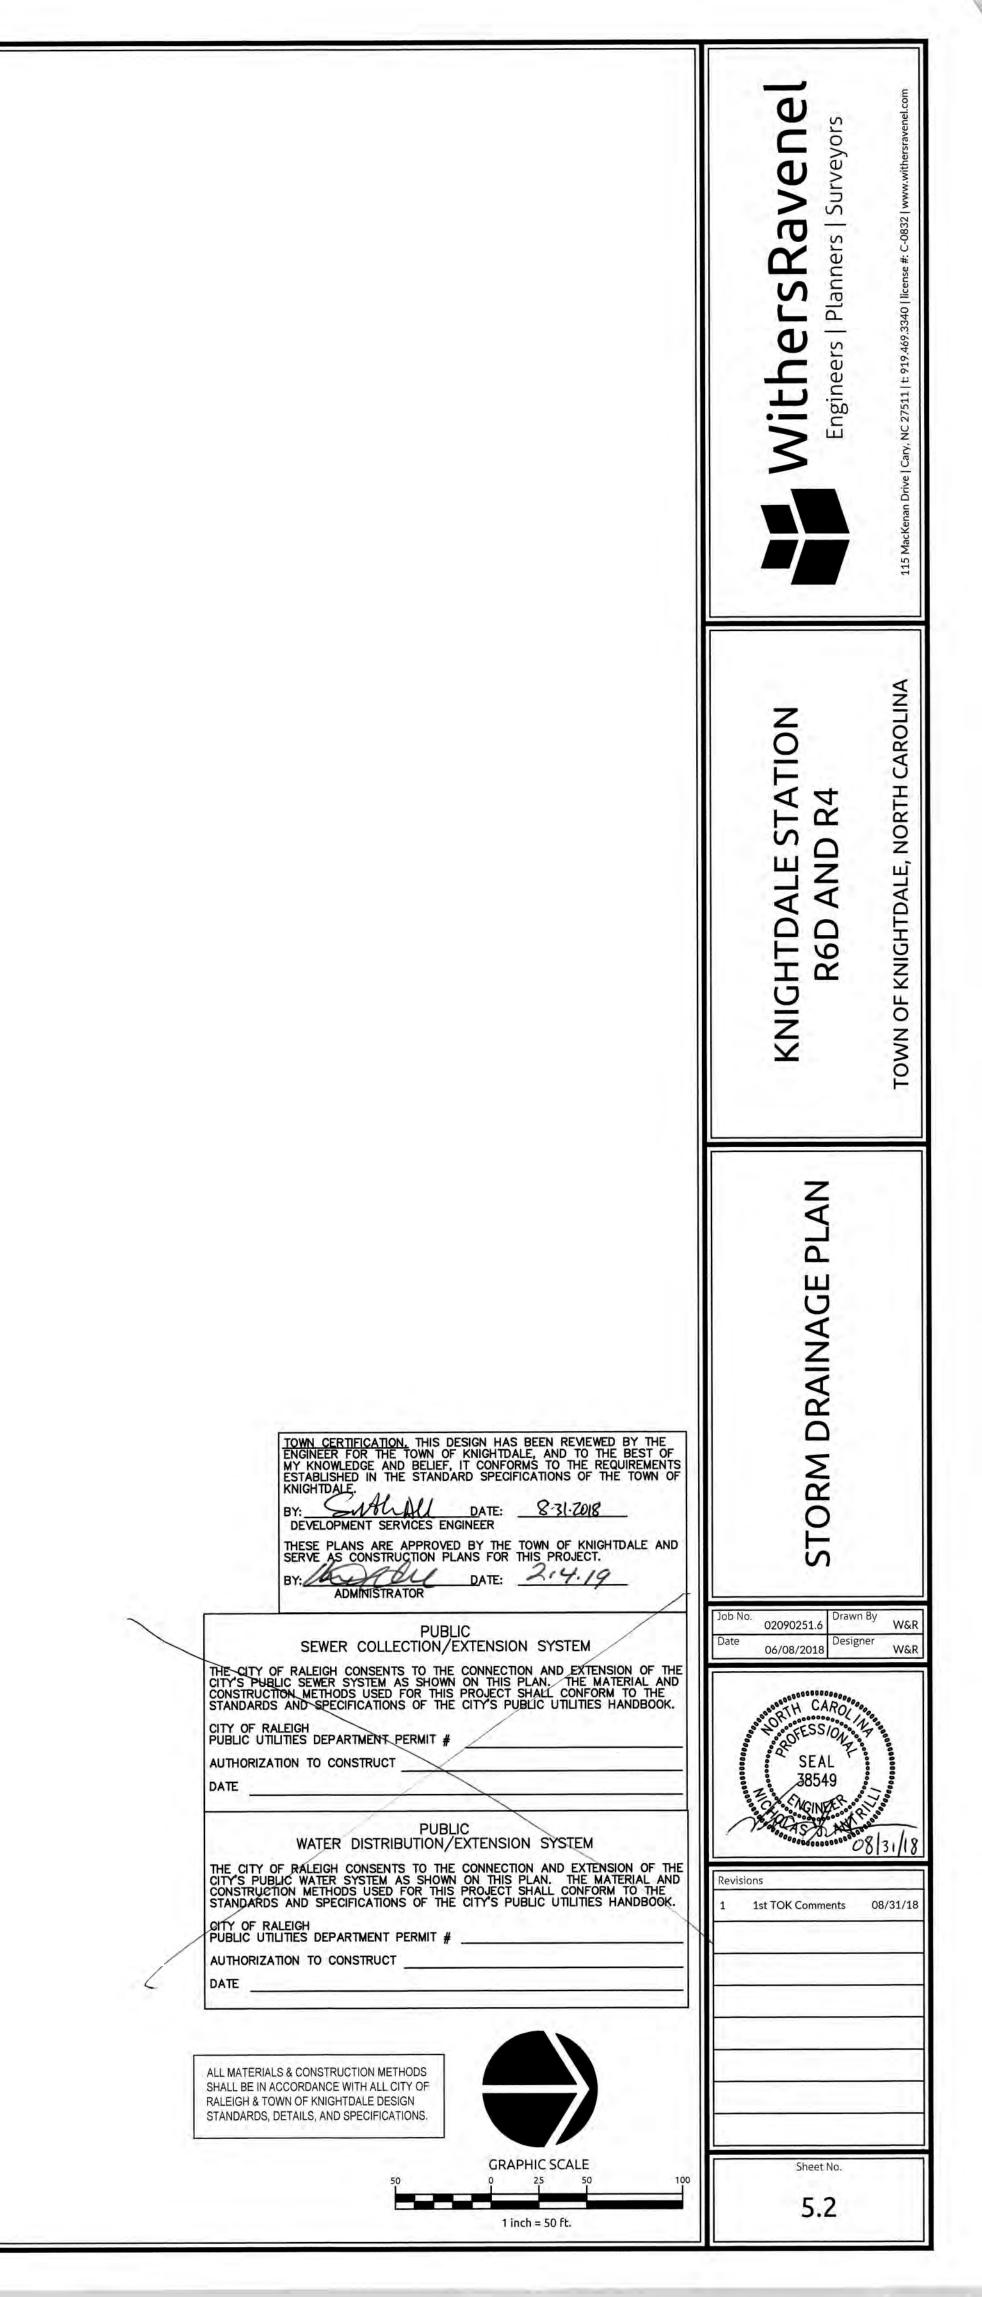

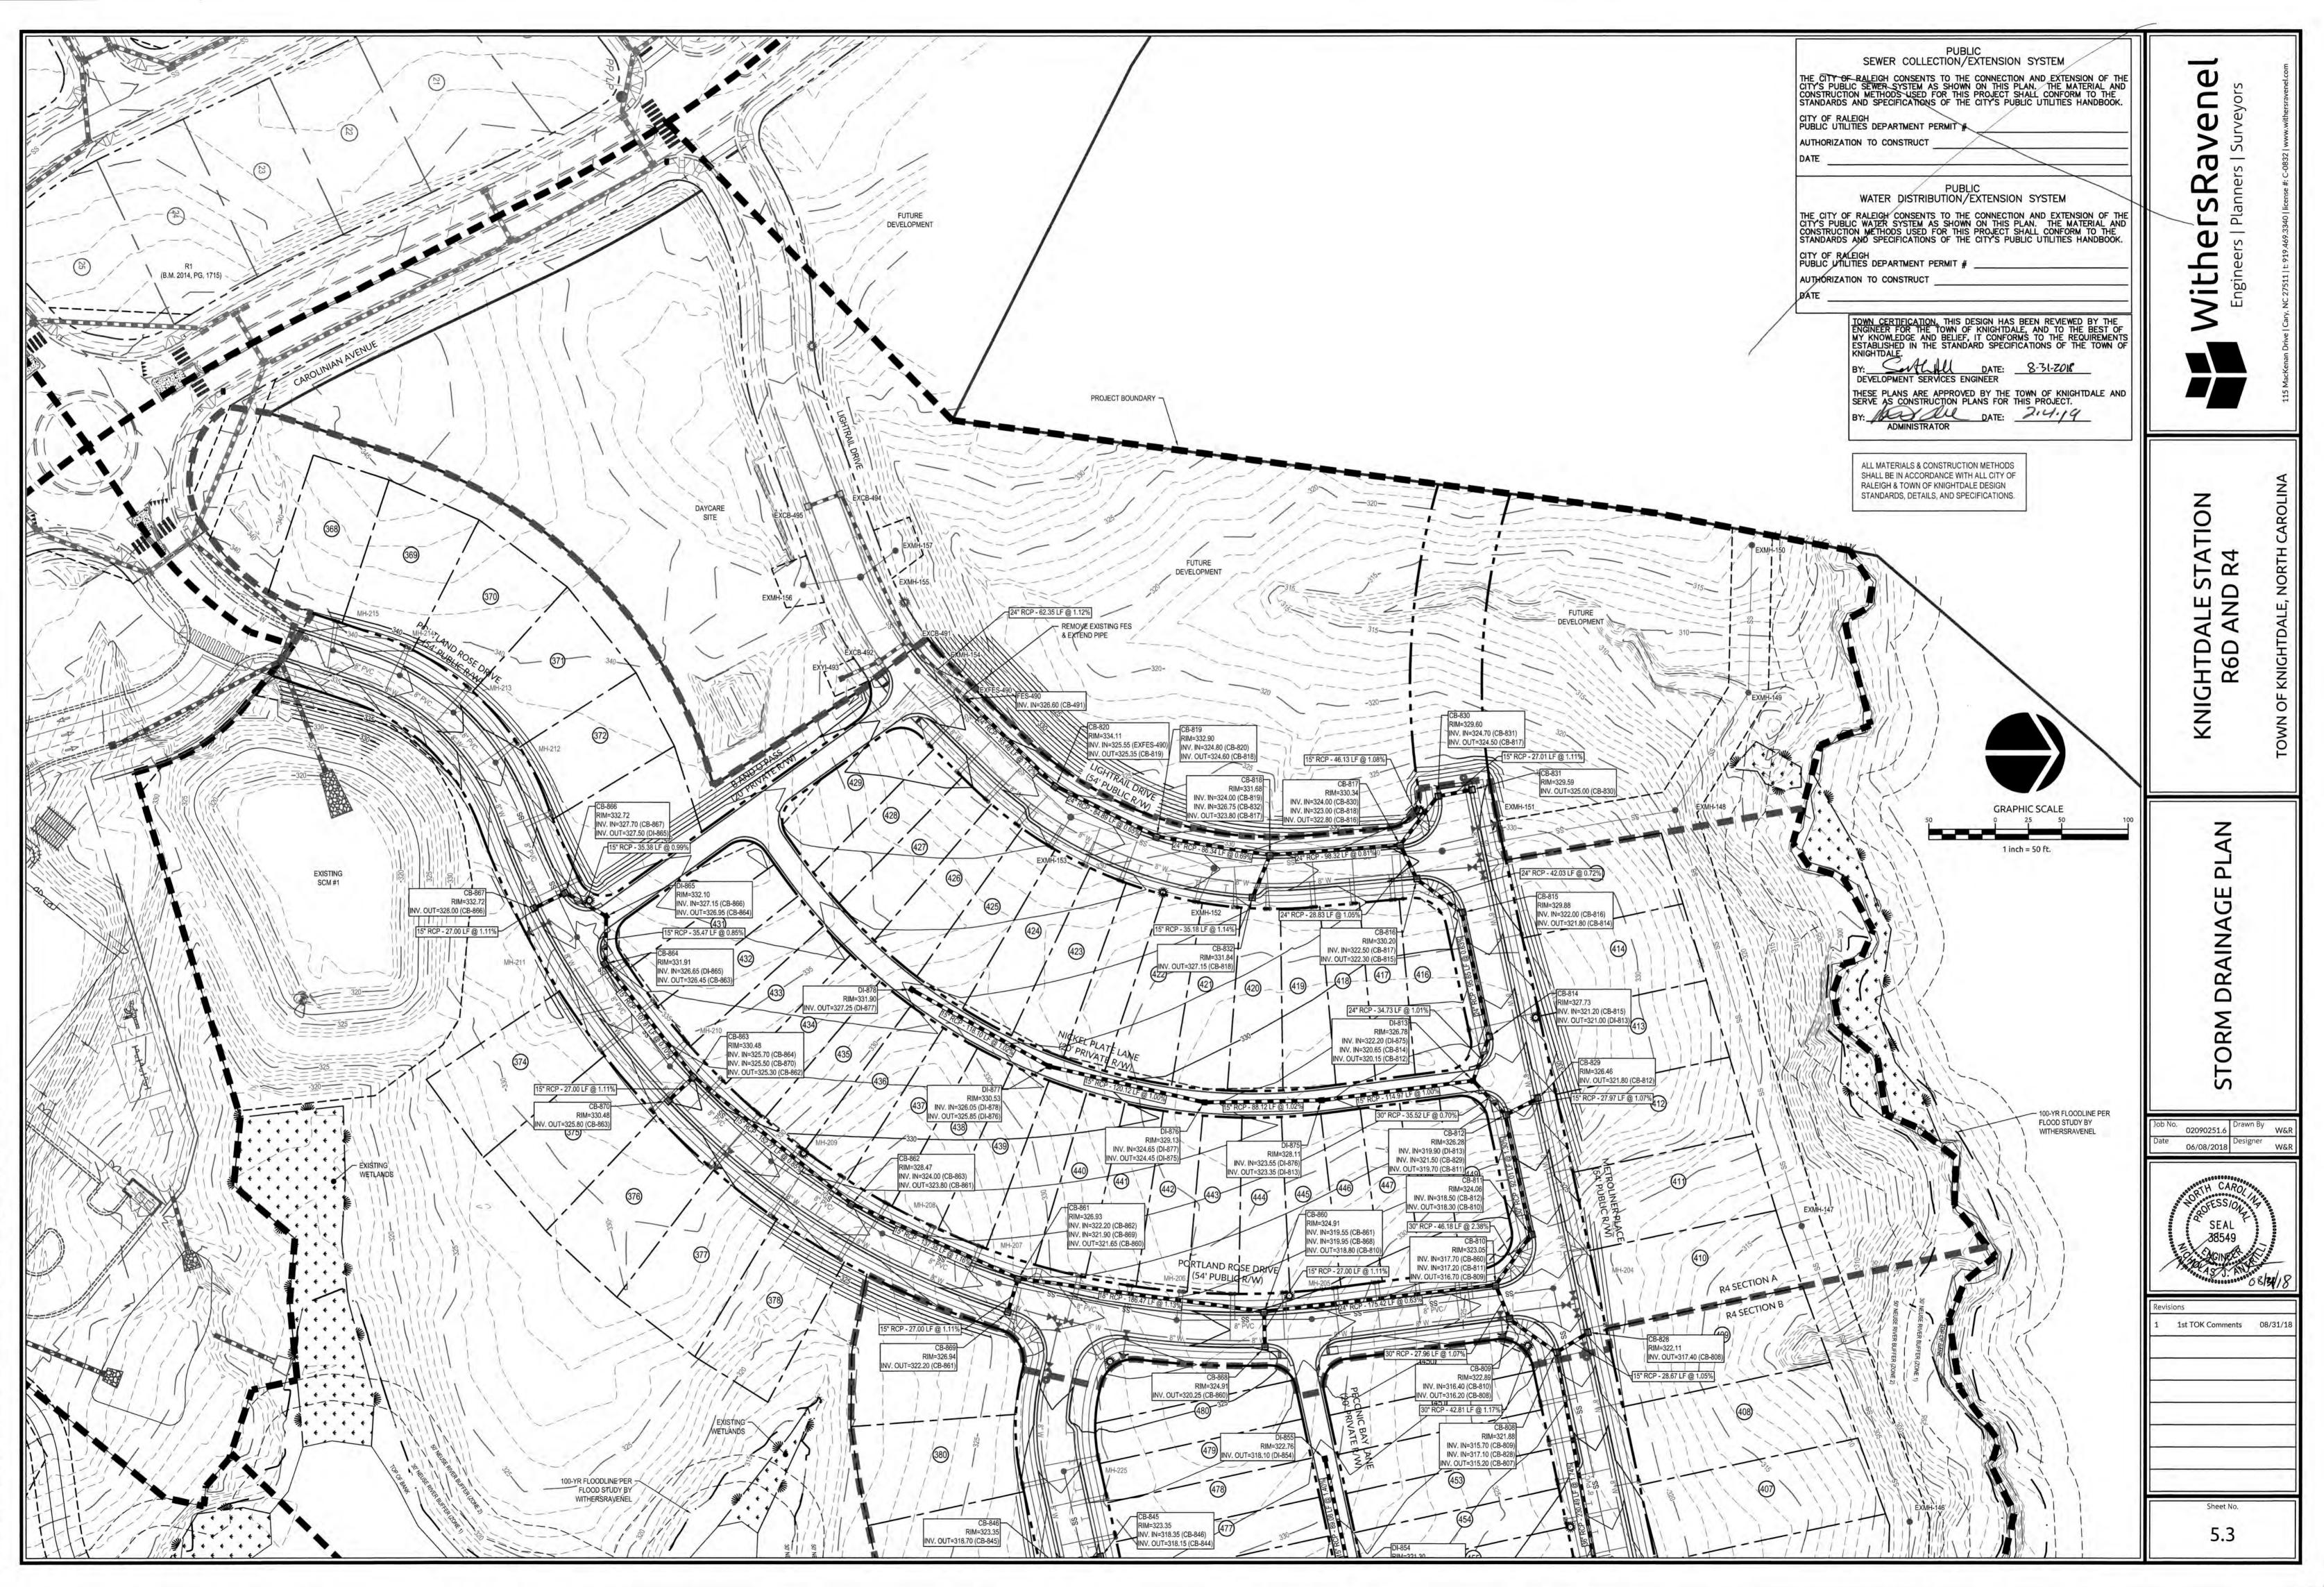

09/09-0250/090251.6-Knightdale Station Phase R4\CAD\MASTER-CONSTRUCTION DRAWINGS\5.1-5.4 STORM DRAINAGE PLANS.dwg- Friday, August 31, 2018 12:26:49 PM - DURYEA, COLLEEN

# STRUCTURE SCHEDULE

### FES 905

	ST	ORM STRUCTURE	TABLE	
STRUCTURE	RIM EL	STRUCTURE IN	INVERT 1N	INVERT OUT
CB-906	300.23	CB-907	295.10	293.00
CB-907	300.23	CB-908	295.60	295.40
CB-908	301.62	YI-913 CB-909	297.70 297.20	296.80
CB-909	303.25	CB-910	298.85	298.65
CB-910	307.03	CB-911 YI-912	302.00 302.00	301.80
CB-911	307.03			302.35
YI-912	307.92		1	303.50

# FES 800

STRUCTURE	RIM EL	STRUCTURE IN	INVERT 1N	INVERT OUT
CB-801	306.16	CB-801A CB-802	301.40 299.00	298.00
CB-801A	306.19		4	301.50
CB-802	309.42	CB-803	301.25	301.05
CB-803	310.62	CB-804	303.00	302.40
CB-804	311.57	CB-805	303.75	303.55
CB-805	311.57	CB-840 CB-806	306.05 305.10	304.05
CB-806	312.05	CB-825 CB-826	307.10 305.75	305.55
CB-807	317.74	CB-827 CB-808	312.65 311.20	311.00
CB-808	321.88	CB-809 CB-828	315.70 317.10	315.20
CB-809	322.89	CB-810	316.40	316.20
CB-810	323.05	CB-860 CB-811	317.70 317.20	316.70
CB-811	324.06	CB-812	318.50	318.30
CB-812	326.28	DI-813 CB-829	319.90 321.50	319.70
CB-814	327.73	CB-815	321.20	321.00
CB-815	329.88	CB-816	322.00	321.80
CB-816	330.20	CB-817	322.50	322.30
CB-817	330.34	CB-830 CB-818	324.00 323.00	322.80
CB-818	331.68	CB-819 CB-832	324.00 326.75	323.80
CB-819	332.90	CB-820	324.80	324.60
CB-820	334.11	EXFES-490	325.55	325.35

## FES 800

	ST	ORM STRUCTURE	TABLE	
STRUCTURE	RIM EL	STRUCTURE IN	INVERT 1N	INVERT OUT
CB-825	312.05			307.40
CB-826	314.03	CB-807	307.65	307.45
CB-827	317.74			313.00
CB-828	322.11			317.40
CB-829	326.46			321.80
CB-830	329.60	CB-831	324.70	324.50
CB-831	329.59			325.00
CB-832	331.84			327.15
CB-840	314.37	DI-841	308.60	308.40
CB-842	315.36	CB-843 CB-847	310.30 310.30	310.10
CB-843	317.91	CB-844	313.40	313.20
CB-844	319.24	CB-845 CB-848	314.55 314.55	314.35
CB-845	323.35	CB-846	318.35	318.15
CB-846	323.35			318.70
CB-847	315.23			310.55
CB-848	319.60	4.2.2.2.		314.95
CB-860	324.91	CB-861 CB-868	319.55 319.95	318.80
CB-861	326.93	CB-862 CB-869	322.20 321.90	321.65
CB-862	328.47	CB-863	324.00	323.80
CB-863	330.48	CB-864 CB-870	325.70 325.50	325.30

## FES 800

	51	ORM STRUCTURE		
STRUCTURE	RIM EL	STRUCTURE IN	INVERT 1N	INVERT OUT
CB-864	331.91	DI-865	326.65	326.45
CB-866	332.72	CB-867	327.70	327.50
CB-867	332.72			328.00
CB-868	324.91		1.0	320.25
CB-869	326.94		7 <b>.</b>	322.20
CB-870	330.48			325.80
DI-813	326.78	DI-875 CB-814	322.20 320.65	320.15
DI-841 314.61		DI-850 CB-842	310.00 309.75	309.00
DI-850	315.34	DI-851	310.85	310.65
DI-851	316.85	DI-852	312.40	312.20
DI-852	318.31	DI-853	313.80	313.60
DI-853	319.80	DI-854	315.35	315.15
DI-854	321.30	DI-855	316.85	316.65
DI-855	322.76			318.10
DI-865	332.10	CB-866	327.15	326.95
DI-875	328.11	DI-876	323.55	323.35
DI-876	329.13	DI-877	324.65	324.45
DI-877	330.53	DI-878	326.05	325.85
DI-878	331.90			327.25

# PIPE SCHEDULE

F	ES	40	0
			-

		ST	ORM SY	STEM	DATA		
DOWNSTREAM STRUCTURE	UPSTREAM STRUCTURE	SIZE	LENGTH	SLOPE	MATERIAL	UPSTREAM INVERT	DOWNSTREAM INVERT
FES-400	JB-400A	24	42.87	5.74%	RCP	287.96	285.50

	STORM SYSTEM DATA										
DOWNSTREAM STRUCTURE	UPSTREAM STRUCTURE	SIZE	LENGTH	SLOPE	MATERIAL	UPSTREAM INVERT	DOWNSTREAM INVERT				
CB-906	CB-907	18	27.00	1.11%	RCP	295.40	295.10				
CB-907	CB-908	18	80.43	1.49%	RCP	296.80	295.60				
CB-908	CB-909	15	93.93	1.55%	RCP	298.65	297.20				
CB-909	CB-910	15	179.23	1.65%	RCP	301.80	298.85				
CB-910	YI-912	15	25.64	5.85%	RCP	303.50	302.00				
CB-910	CB-911	15	26.96	1.30%	RCP	302.35	302.00				
FES-905	CB-906	18	75.69	9.91%	RGRCP	293.00	285.50				

DOWNSTREAM STRUCTURE	UPSTREAM STRUCTURE	SIZE	LENGTH	SLOPE	MATERIAL	UPSTREAM INVERT	DOWNSTREAM INVERT	
CB-815	CB-816	24	42.03	0.72%	RCP	322.30	322.00	
CB-816	CB-817	24	28.83	1.05%	RCP	322.80 323.80	322.50	
CB-817	CB-818	24	98.32	0.81%	RCP		323.00	
CB-817	CB-830	15	46.13	1.08%	RCP	324.50	324.00	
CB-818	CB-819	24	86.34	0.69%	RCP	324.60	324.00	
CB-819	CB-820	24	84.89	0.65%	RCP	325.35	324.80	
CB-820	EXFES-490	24	93.46	1.12%	RCP	326.60	325.55	
CB-826	CB-807	36	233.83	1.43%	RCP	311.00	307.65	
CB-830	CB-831	15	27.01	1.11%	RCP	325.00	324.70	
CB-840	DI-841 CB-847		24	34.09	1.17%	RCP	309.00	308.60
CB-842			15	28.40	0.88%	RCP	310.55	310.30
CB-842	CB-843	15	160.91	1.80%	RCP	313.20	310.30	
CB-843	CB-844	15	75.36	1.26%	RCP	314.35	313.40	
CB-844	CB-848	15	39.57	1.01%	RCP	314.95	314.55	
CB-844	CB-845	15	254.57	1.41%	RCP	318.15	314.55	
CB-845	CB-846	15	33.00	1.06%	RCP	318.70	318.35	
CB-860	CB-868	15	27.00	1.11%	RCP	320.25	319.95	
CB-860	CB-861	18	186.47	1.13%	RCP	321.65	319.55	
CB-861	CB-869	15	27.00	1.11%	RCP	322.20	321.90	
CB-861	CB-862	15	137.35	1.16%	RCP	323.80	322.20	

# FES 800

DOWNSTREAM STRUCTURE	UPSTREAM STRUCTURE	SIZE	LENGTH	SLOPE	MATERIAL	UPSTREAM INVERT	DOWNSTREAM INVERT
CB-801	CB-802	36	111.29	1.84%	RCP	301.05	299.00
CB-801	CB-801A	15	8.00	1.25%	RCP	301.50	301.40
CB-802	CB-803	36	76.03	1.51%	RCP	302.40	301.25
CB-803	CB-804	36	44.54	1.23%	RCP	303.55	303.00
CB-804	CB-805	36	27.00	1.11%	RCP	304.05	303.75
CB-805	CB-806	36	44.54	1.01%	RCP	305.55	305.10
CB-805	CB-840	24	158.05	1.49%	RCP	308.40	306.05
CB-806	CB-826	36	124.98	1.36%	RCP	307.45	305.75
CB-806	CB-825	15	27.00	1.11%	RCP	307.40	307.10
CB-807	CB-808	36	230.49	1.74%	RCP	315.20	311.20
CB-807	CB-827	15	33.00	1.06%	RCP	313.00	312.65
CB-808	CB-828	15	28.67	1.05%	RCP	317.40	317.10
CB-808	CB-809	30	42.81	1.17%	RCP	316.20	315.70
CB-809	CB-810	30	27.96	1.07%	RCP	316.70	316.40
CB-810	CB-811	30	46.18	2.38%	RCP	318.30	317.20
CB-810	CB-860	24	175.42	0.63%	RCP	318.80	317.70
CB-811	CB-812	30	92.01	1.30%	RCP	319.70	318.50
CB-812	CB-829	15	27.97	1.07%	RCP	321.80	321.50
CB-812	DI-813	30	35.52	0.70%	RCP	320.15	319.90
CB-814	CB-815	24	95.65	0.63%	RCP	321.80	321.20

## FES 800

		ST	ORM SY	STEM	DATA			
DOWNSTREAM STRUCTURE	UPSTREAM STRUCTURE	SIZE	LENGTH	SLOPE	MATERIAL	UPSTREAM INVERT	DOWNSTREAM INVERT	
CB-862	CB-863	15	152.27	0.85%	RCP	325.30	324.00	
CB-863	CB-870	15	27.00	1.11%	RCP	325.80	325.50	
CB-863	CB-864	15	107.81	0.70%	RCP	326.45	325.70	
CB-864	DI-865	15	35.47	0.85%	RCP	326.95	326.65	
CB-866	CB-867	15	27.00	1.11%	RCP	328.00	327.70	
DI-813	CB-814	24	34.73	1.01%	RCP	321.00	320.65	
DI-813	DI-875	15	114.97	1.00%	RCP	323.35	322.20	
DI-841	DI-850	15	45.41	1.43%	RCP	310.65	310.00	
DI-841	CB-842 DI-851	15	35.78	0.98%	RCP	310.10	309.75	
DI-850		850 DI-851	15	91.73	1.47%	RCP	312.20	310.85
DI-851	DI-852	15	89.20	1.35%	RCP	313.60	312.40	
DI-852	DI-853	15	90.31	1.50%	RCP	315.15	313.80	
DI-853	DI-854	15	90.90	1.43%	RCP	316.65	315.35	
DI-854	DI-855	15	89.08	1.40%	RCP	318.10	316.85	
DI-865	CB-866	15	35.38	0.99%	RCP	327.50	327.15	
DI-875	DI-876	15	88.12	1.02%	RCP	324.45	323.55	
DI-876	DI-877	15	120.12	1.00%	RCP	325.85	324.65	
DI-877	DI-878	15	118.10	1.02%	RCP	327.25	326.05	
FES-800	CB-801	36	99.18	6.55%	RGRCP	298.00	291.50	

		ST	ORM SY	STEM	DATA		
UPSTREAM STRUCTURE	DOWNSTREAM STRUCTURE	SIZE	LENGTH	SLOPE	MATERIAL	UPSTREAM INVERT	DOWNSTREAM INVERT
FES-930	FES-931	15	30.47	4.92%	RCP	296.50	298.00

### NOTES:

RGRCP: DENOTES O-RING GASKET RCP

- 1. ALL CONSTRUCTION SHALL BE IN ACCORDANCE WITH CURRENT TOWN OF KNIGHTDALE STANDARD SPECIFICATIONS AND DETAILS.
- 2. RIM ELEVATION GIVEN FOR CB IS TOP OF CURB, YI & DI IS TOP OF GRATE FOR GRATED INLET, JB IS TOP OF RIM. 3. ALL PIPING SHALL BE CLASS III REINFORCED CONCRETE PIPE (RCP) UNLESS NOTED
- OTHERWISE. 4. ALL PUBLIC STORM DRAINAGE FRAMES, GRATES, & HOODS SHALL BE STAMPED W/
- "DRAINS TO RIVER" IN ACCORDANCE WITH TOWN OF KNIGHTDALE STANDARDS.


### STORM DRAINAGE NOTES: FES: FLARED END SECTIONS, CB: CATCH BASIN, JB: JUNCTION BOX, DI: DROP INLET (TOK #5.04), YI: YARD INLET (TOK #5.04)

ALL MATERIALS & CONSTRUCTION METHODS SHALL BE IN ACCORDANCE WITH ALL CITY OF RALEIGH & TOWN OF KNIGHTDALE DESIGN STANDARDS, DETAILS, AND SPECIFICATIONS.

### FES 905

# FES 800

# **FES 930**

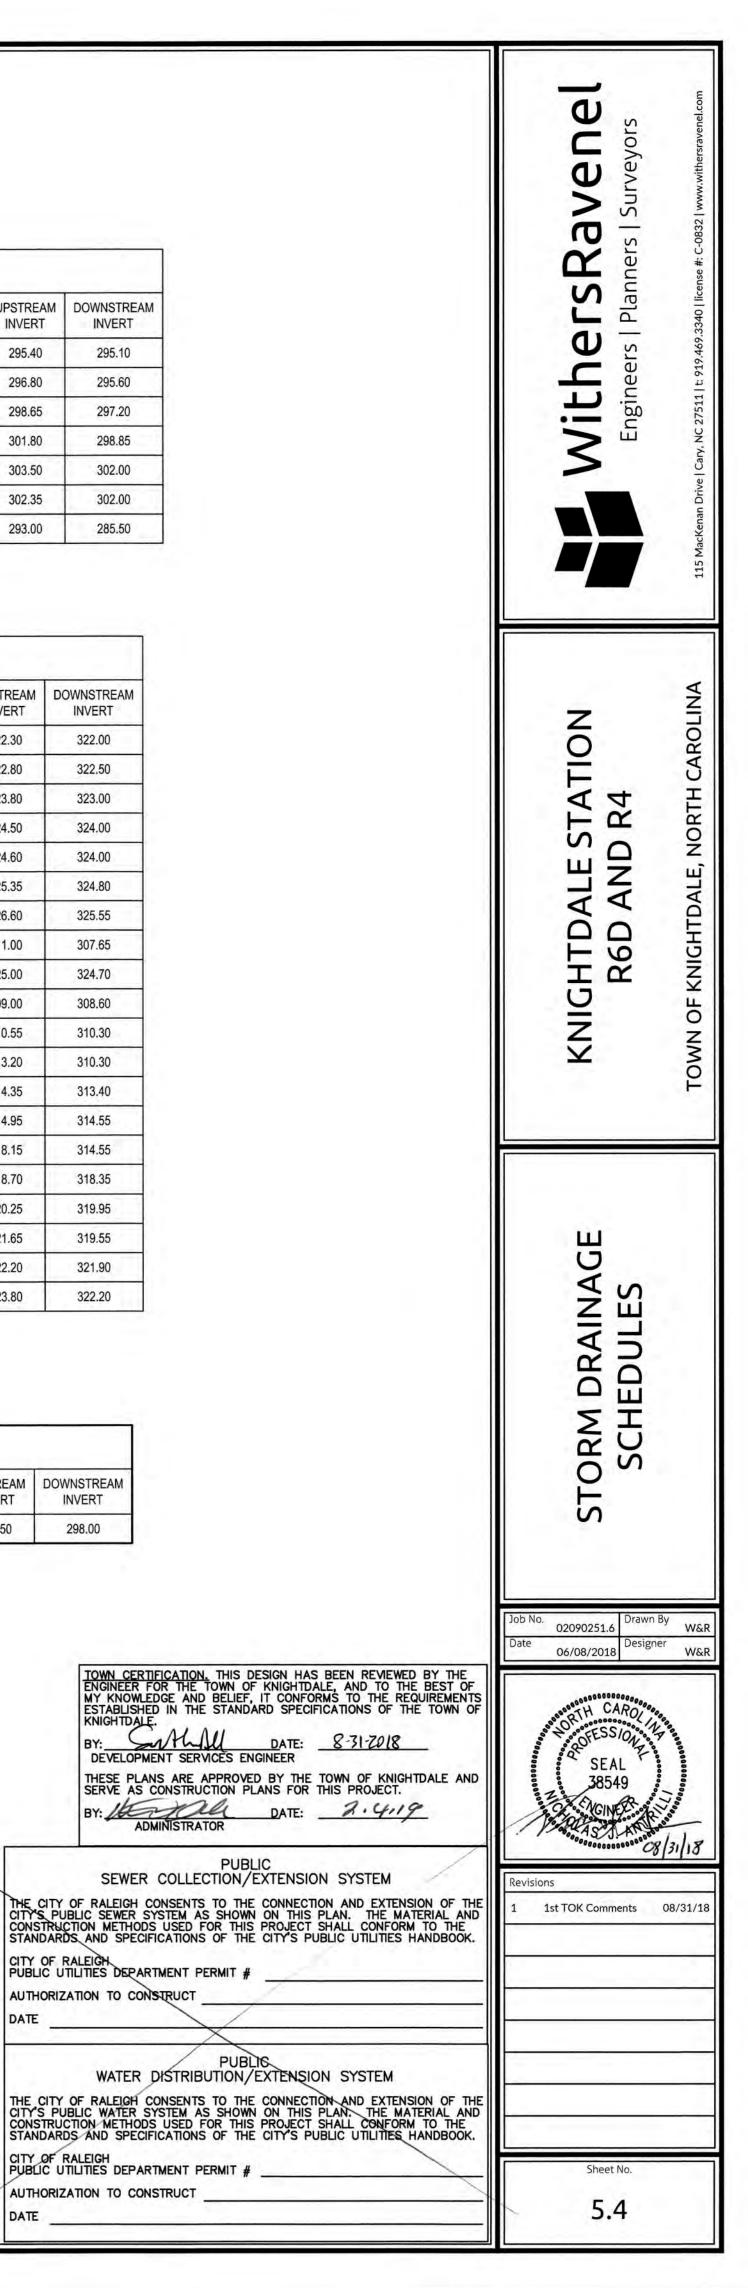

CITY OF RALEIGH PUBLIC UTILITIES DEPARTMENT PERMIT # AUTHORIZATION TO CONSTRUCT DATE

PUBLIC SEWER COLLECTION/EXTENSION SYSTEM

WATER DISTRIBUTION/EXTENSION SYSTEM


CITY OF RALEIGH PUBLIC UTILITIES DEPARTMENT PERMIT #

AUTHORIZATION TO CONSTRUCT

DATE




09-0250/090251.6-Knightdale Station Phase R4/CAD/MASTER-CONSTRUCTION DRAWINGS\5.5-5.7 GRADING PLANS.dwg- Friday, August 31, 2018 12:28:03 PM - DURYEA, COLLI

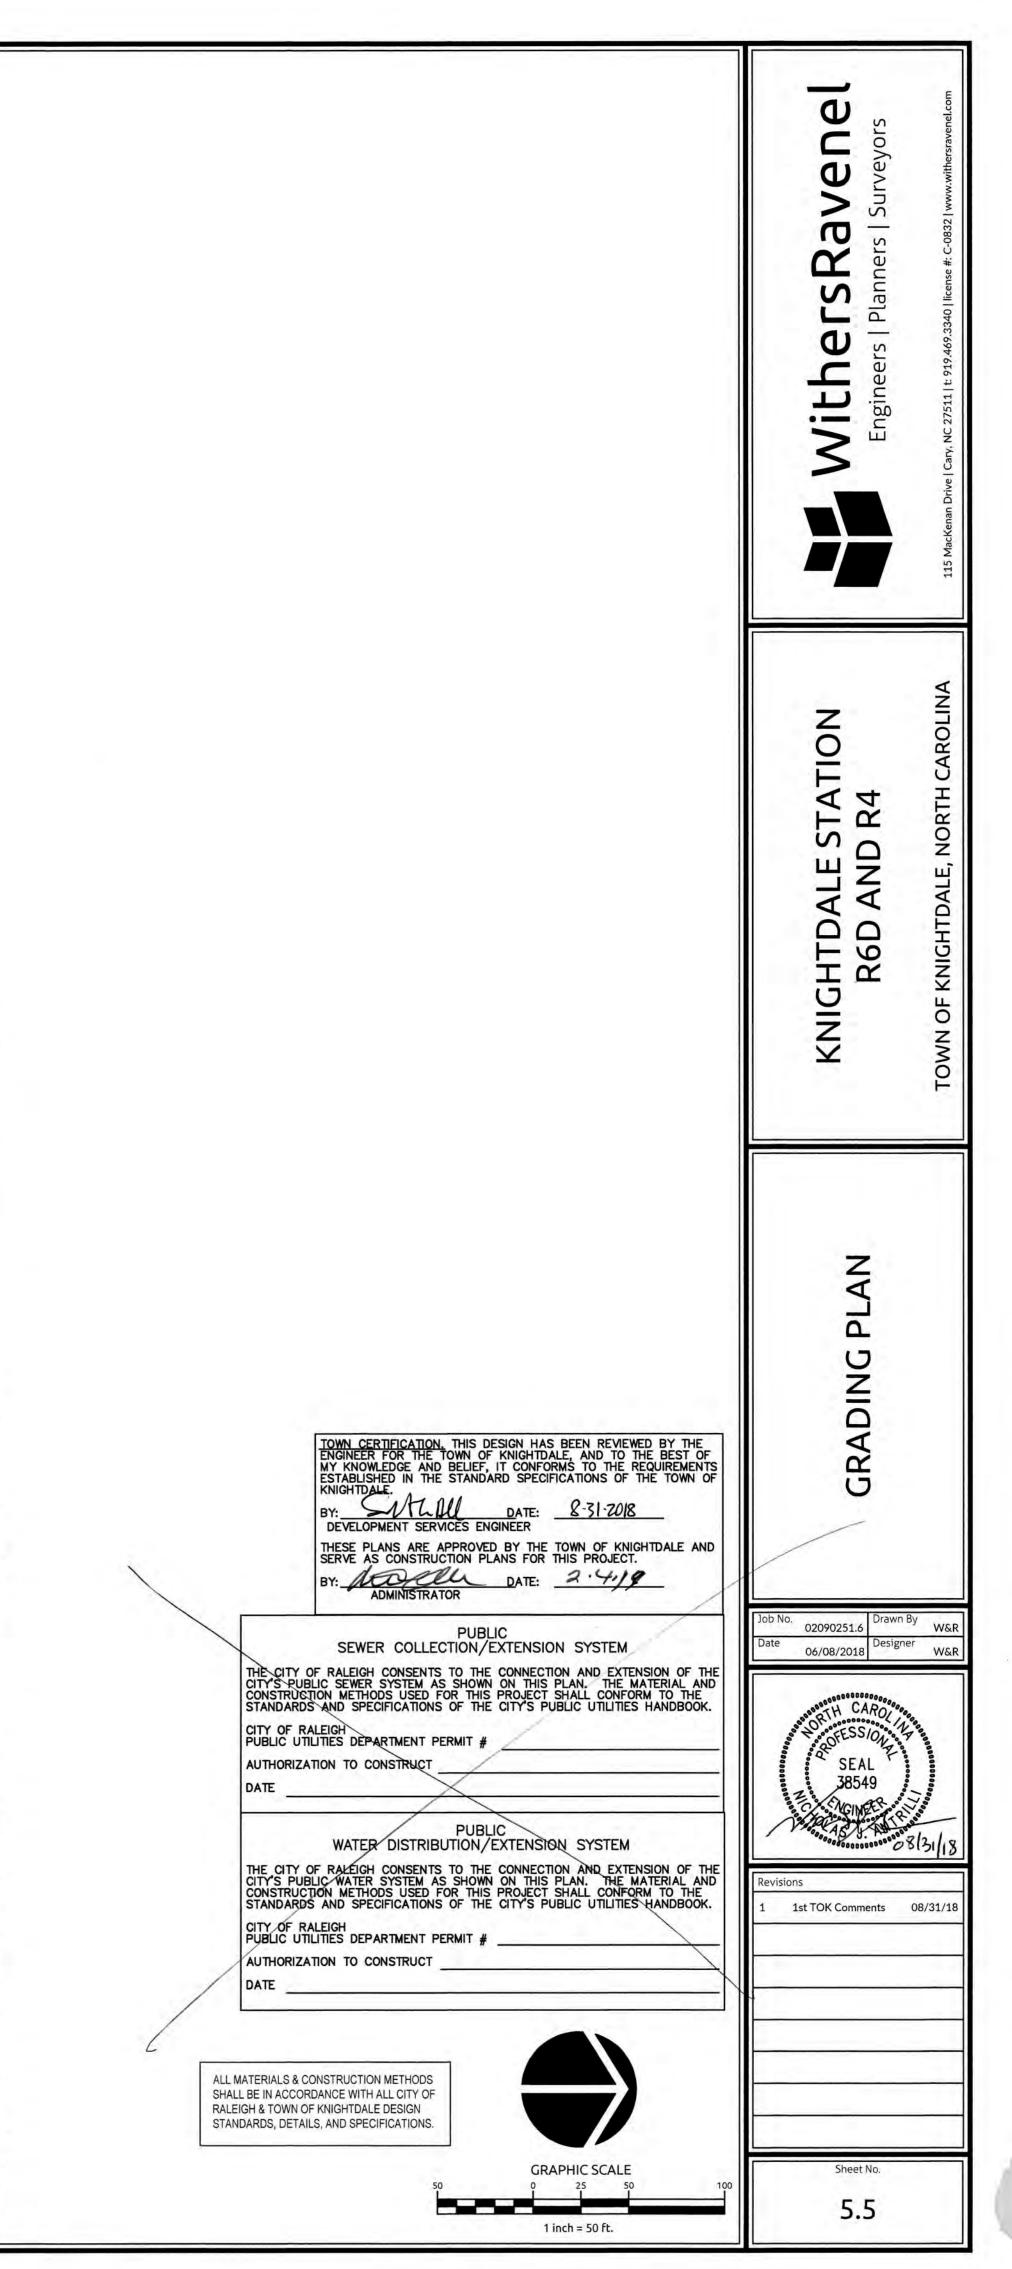




(09) 09-0250 090251.6-Knightdale Station Phase R4) CAD\MASTER-CONSTRUCTION DRAWINGS\5.5-5.7 GRADING PLANS.dwg- Friday, August 31, 2018 12:28:14 PM - DURYEA, COLLEEN

	<b>115</b> Markenan Drive   Cary, NC 27511 It, 919.469.3340   Icense #: C-0822   www.ithersanenclone
	KNIGHTDALE STATION R6D AND R4 TOWN OF KNIGHTDALE, NORTH CAROLINA
DEVELOPMENT SERVICES ENGINEER THESE PLANS ARE APPROVED BY THE SERVE AS CONSTRUCTION PLANS FOR	S-31-ZOIR TOWN OF KNIGHTDALE AND THIS PROJECT. 2.4.19
PUBLIC SEWER COLLECTION/EXTENSION THE CITY OF RALEIGH CONSENTS TO THE CONNECT CITY'S PUBLIC SEWER SYSTEM AS SHOWN ON THIS CONSTRUCTION. METHODS USED FOR THIS PROJECT STANDARDS AND SPECIFICATIONS OF THE CITY'S P CITY OF RALEIGH PUBLIC UTILITIES DEPARTMENT PERMIT # AUTHORIZATION TO CONSTRUCT DATE	ION AND EXTENSION OF THE PLAN. THE MATERIAL AND SHALL CONFORM TO THE JBLIC UTILITIES HANDBOOK. DN SYSTEM NON AND EXTENSION OF THE PLAN. THE MATERIAL AND SHALL CONFORM TO THE JBLIC UTILITIES HANDBOOK.
50 0	PHIC SCALE 25 50 100 hch = 50 ft. Sheet No. 5,6

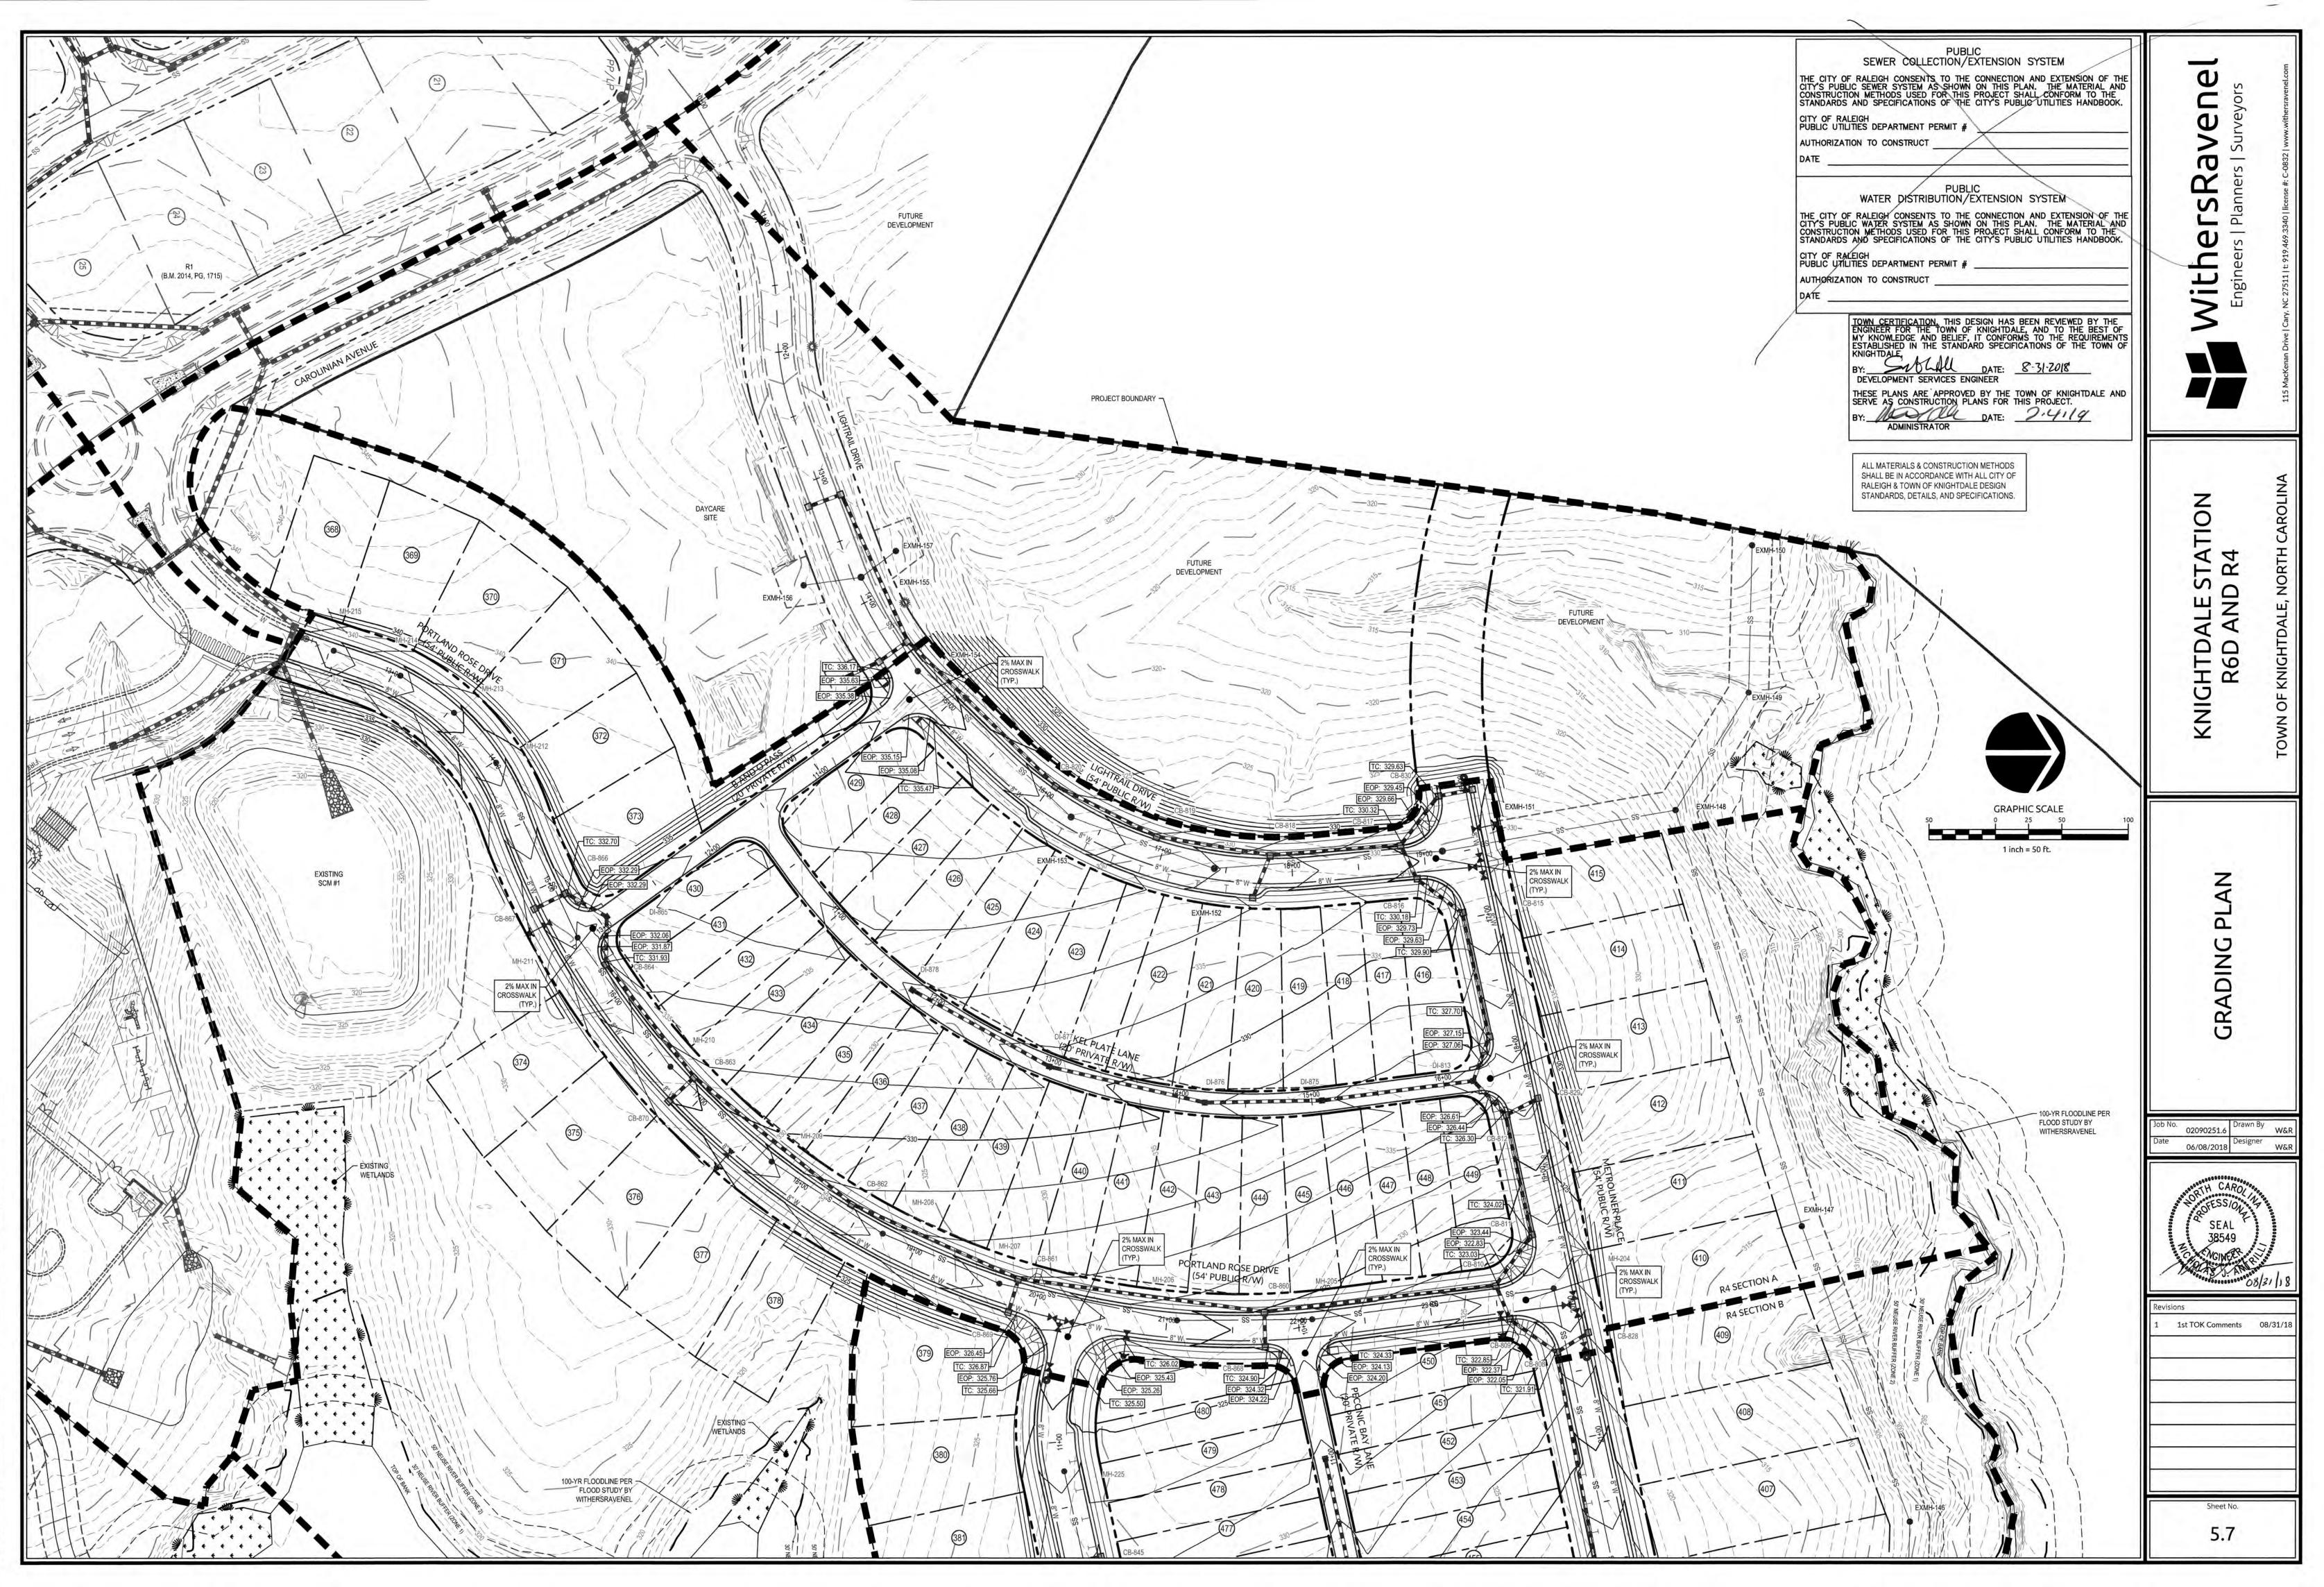


:\09\09-0250\090251.6-Knightdale Station Phase R4\CAD\MASTER-CONSTRUCTION DRAWINGS\5.5-5.7 GRADING PLANS.dwg- Friday, August 31, 2018 9:18:32 AM - DURYEA, COLL

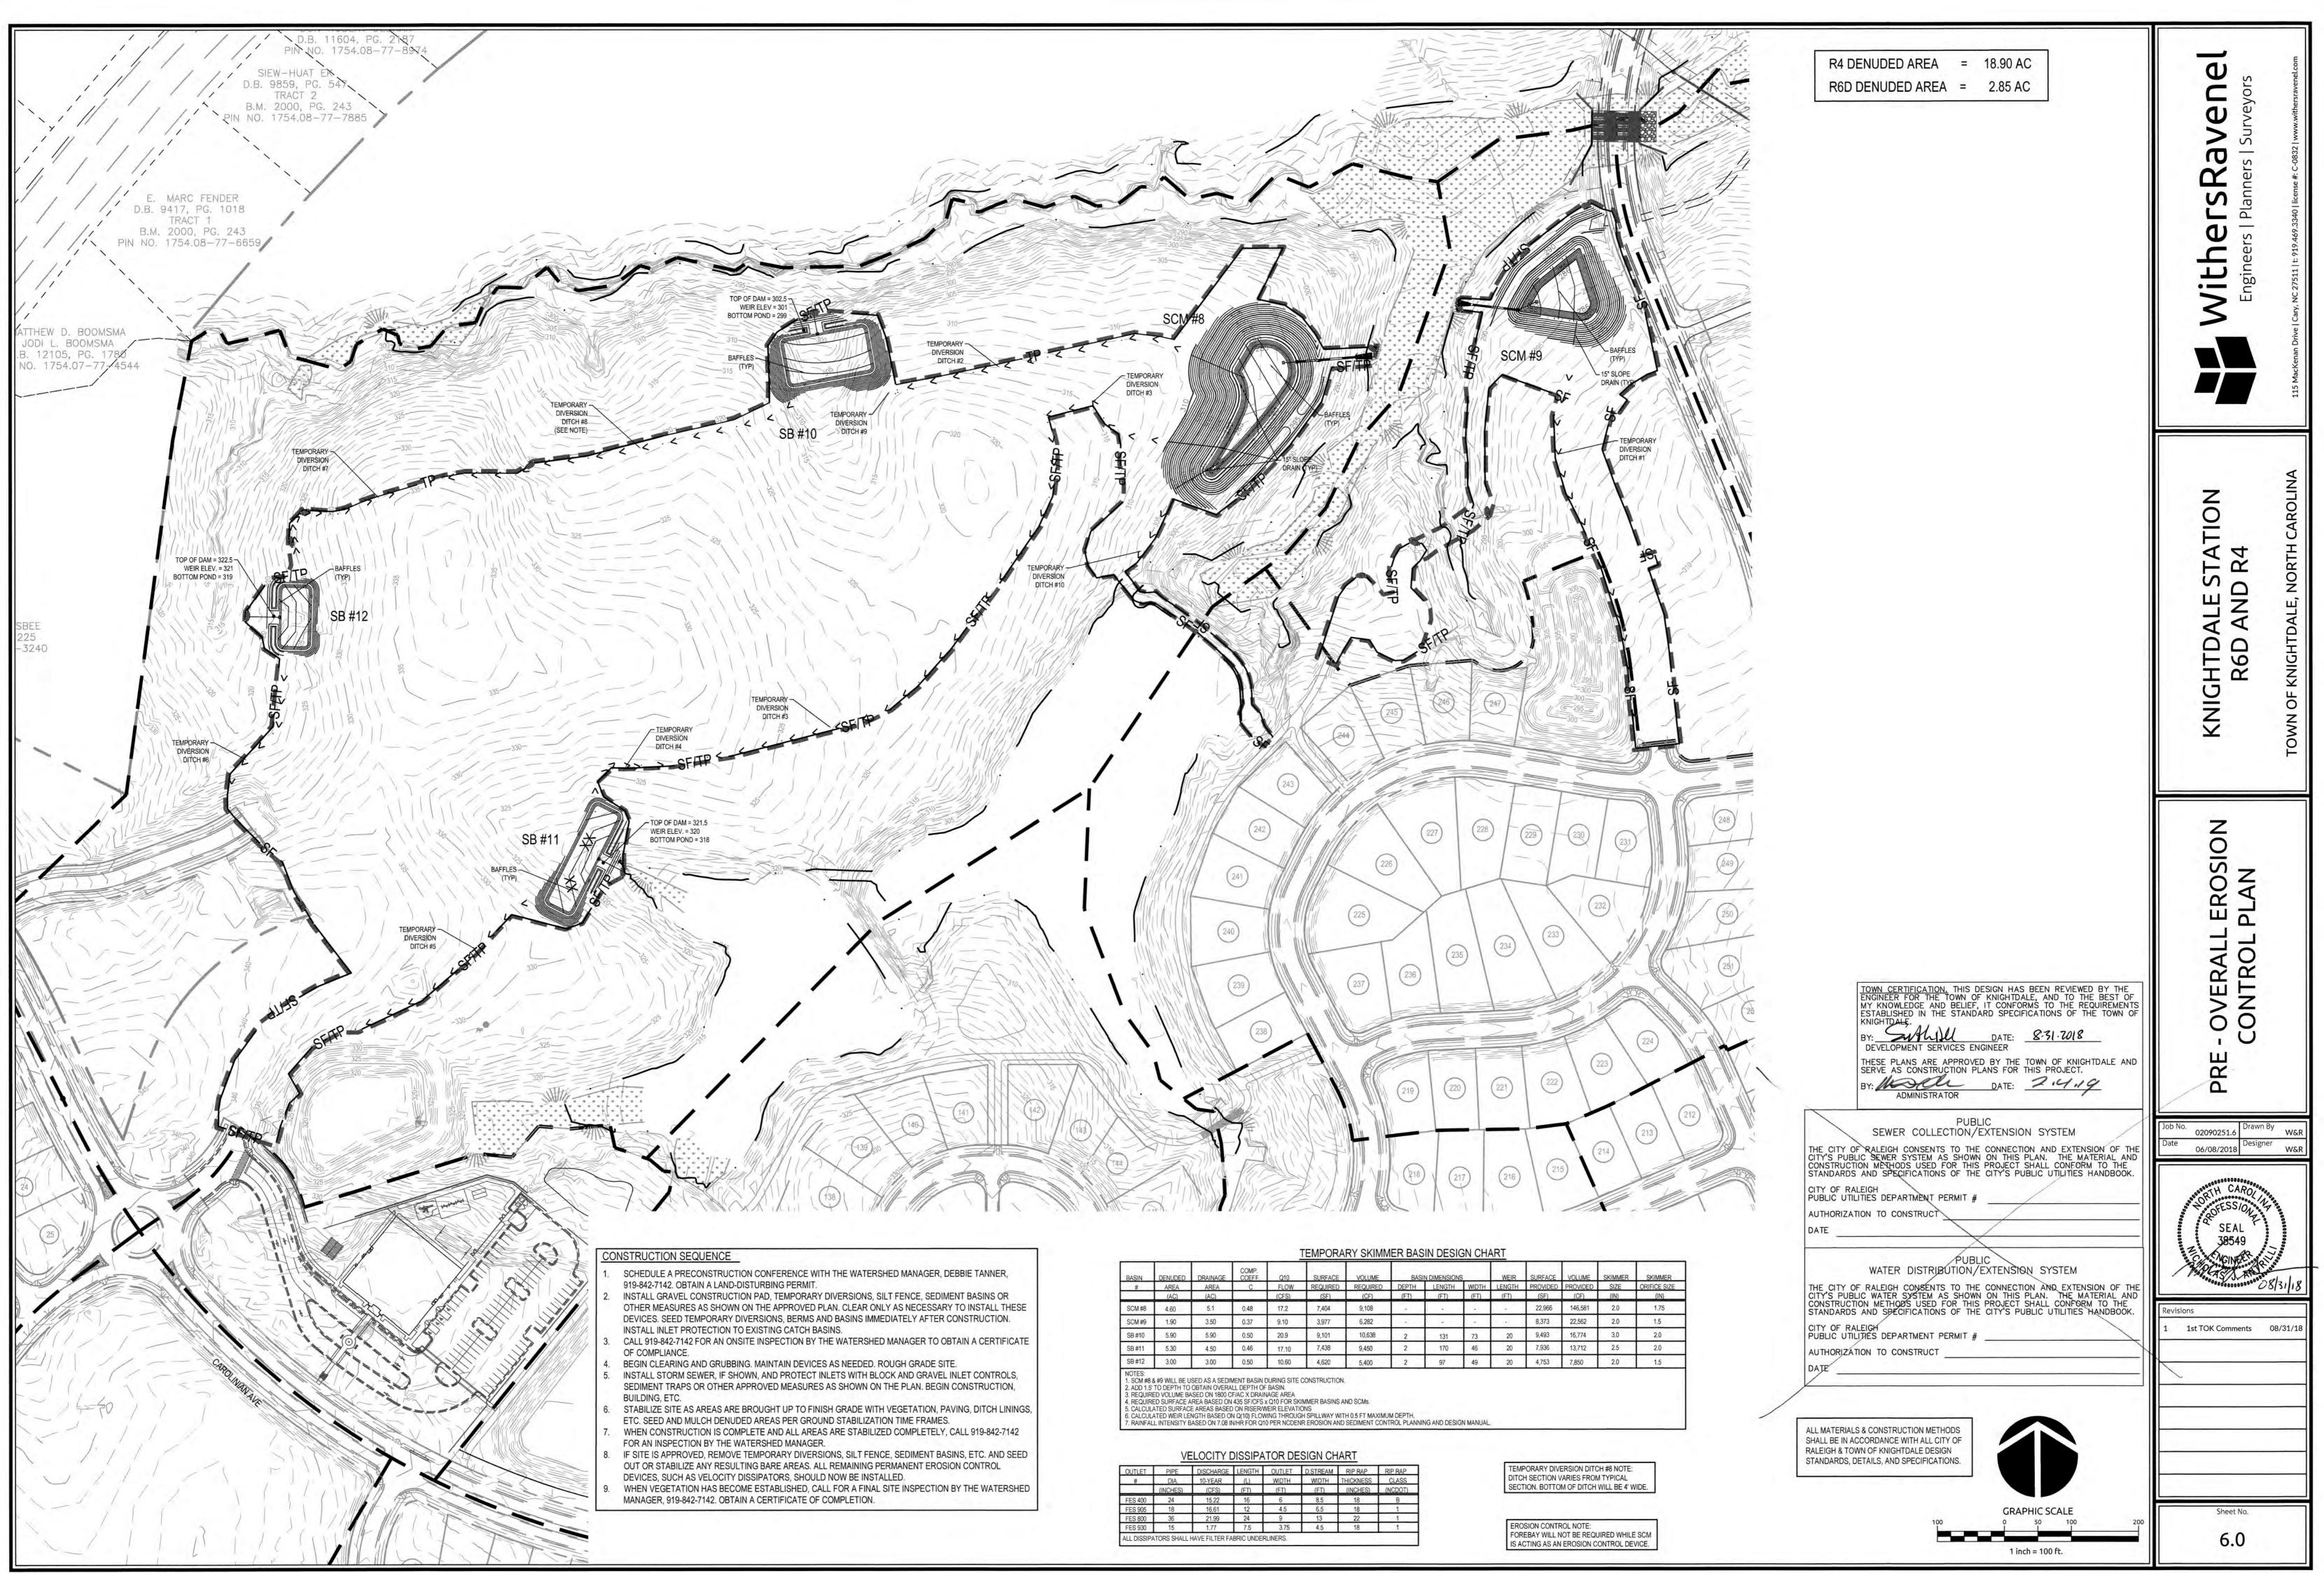


BASIN	DENUDED	DRAINAGE	COMP. COEFF.	Q10	SURFACE	VOLUME	BASIN DIMENSIONS			WEIR	SURFACE	VOLUME	SKIMME
#	AREA	AREA	С	FLOW	REQUIRED	REQUIRED	DEPTH	LENGTH	WIDTH	LENGTH	PROVIDED	PROVIDED	SIZE
	(AC)	(AC)		(CFS)	(SF)	(CF)	(FT)	(FT)	(FT)	(FT)	(SF)	(CF)	(IN)
SCM #8	4.60	5.1	0.48	17.2	7,404	9,108	-	4			22,966	146,581	2.0
SCM #9	1.90	3.50	0.37	9.10	3,977	6,282	Hard and		-	1.46	8,373	22,562	2.0
SB #10	5.90	5.90	0.50	20.9	9,101	10,638	2	131	73	20	9,493	16,774	3.0
SB #11	5.30	4.50	0.46	17.10	7,438	9,450	2	170	46	20	7,936	13,712	2.5
SB #12	3.00	3.00	0.50	10.60	4,620	5,400	2	97	49	20	4,753	7,850	2.0

OUTLET	PIPE	DISCHARGE	LENGTH	OUTLET	D.STREAM	RIP RAP	RIP RAP
#	DIA.	10-YEAR	(L)	WIDTH	WIDTH	THICKNESS	CLASS
	(INCHES)	(CFS)	(FT)	(FT)	(FT)	(INCHES)	(NCDOT)
FES 400	24	15.22	16	6	8.5	18	В
FES 905	18	16.61	12	4.5	6.5	18	1
FES 800	36	21.99	24	9	13	22	1
FES 930	15	1.77	7.5	3.75	4.5	18	1

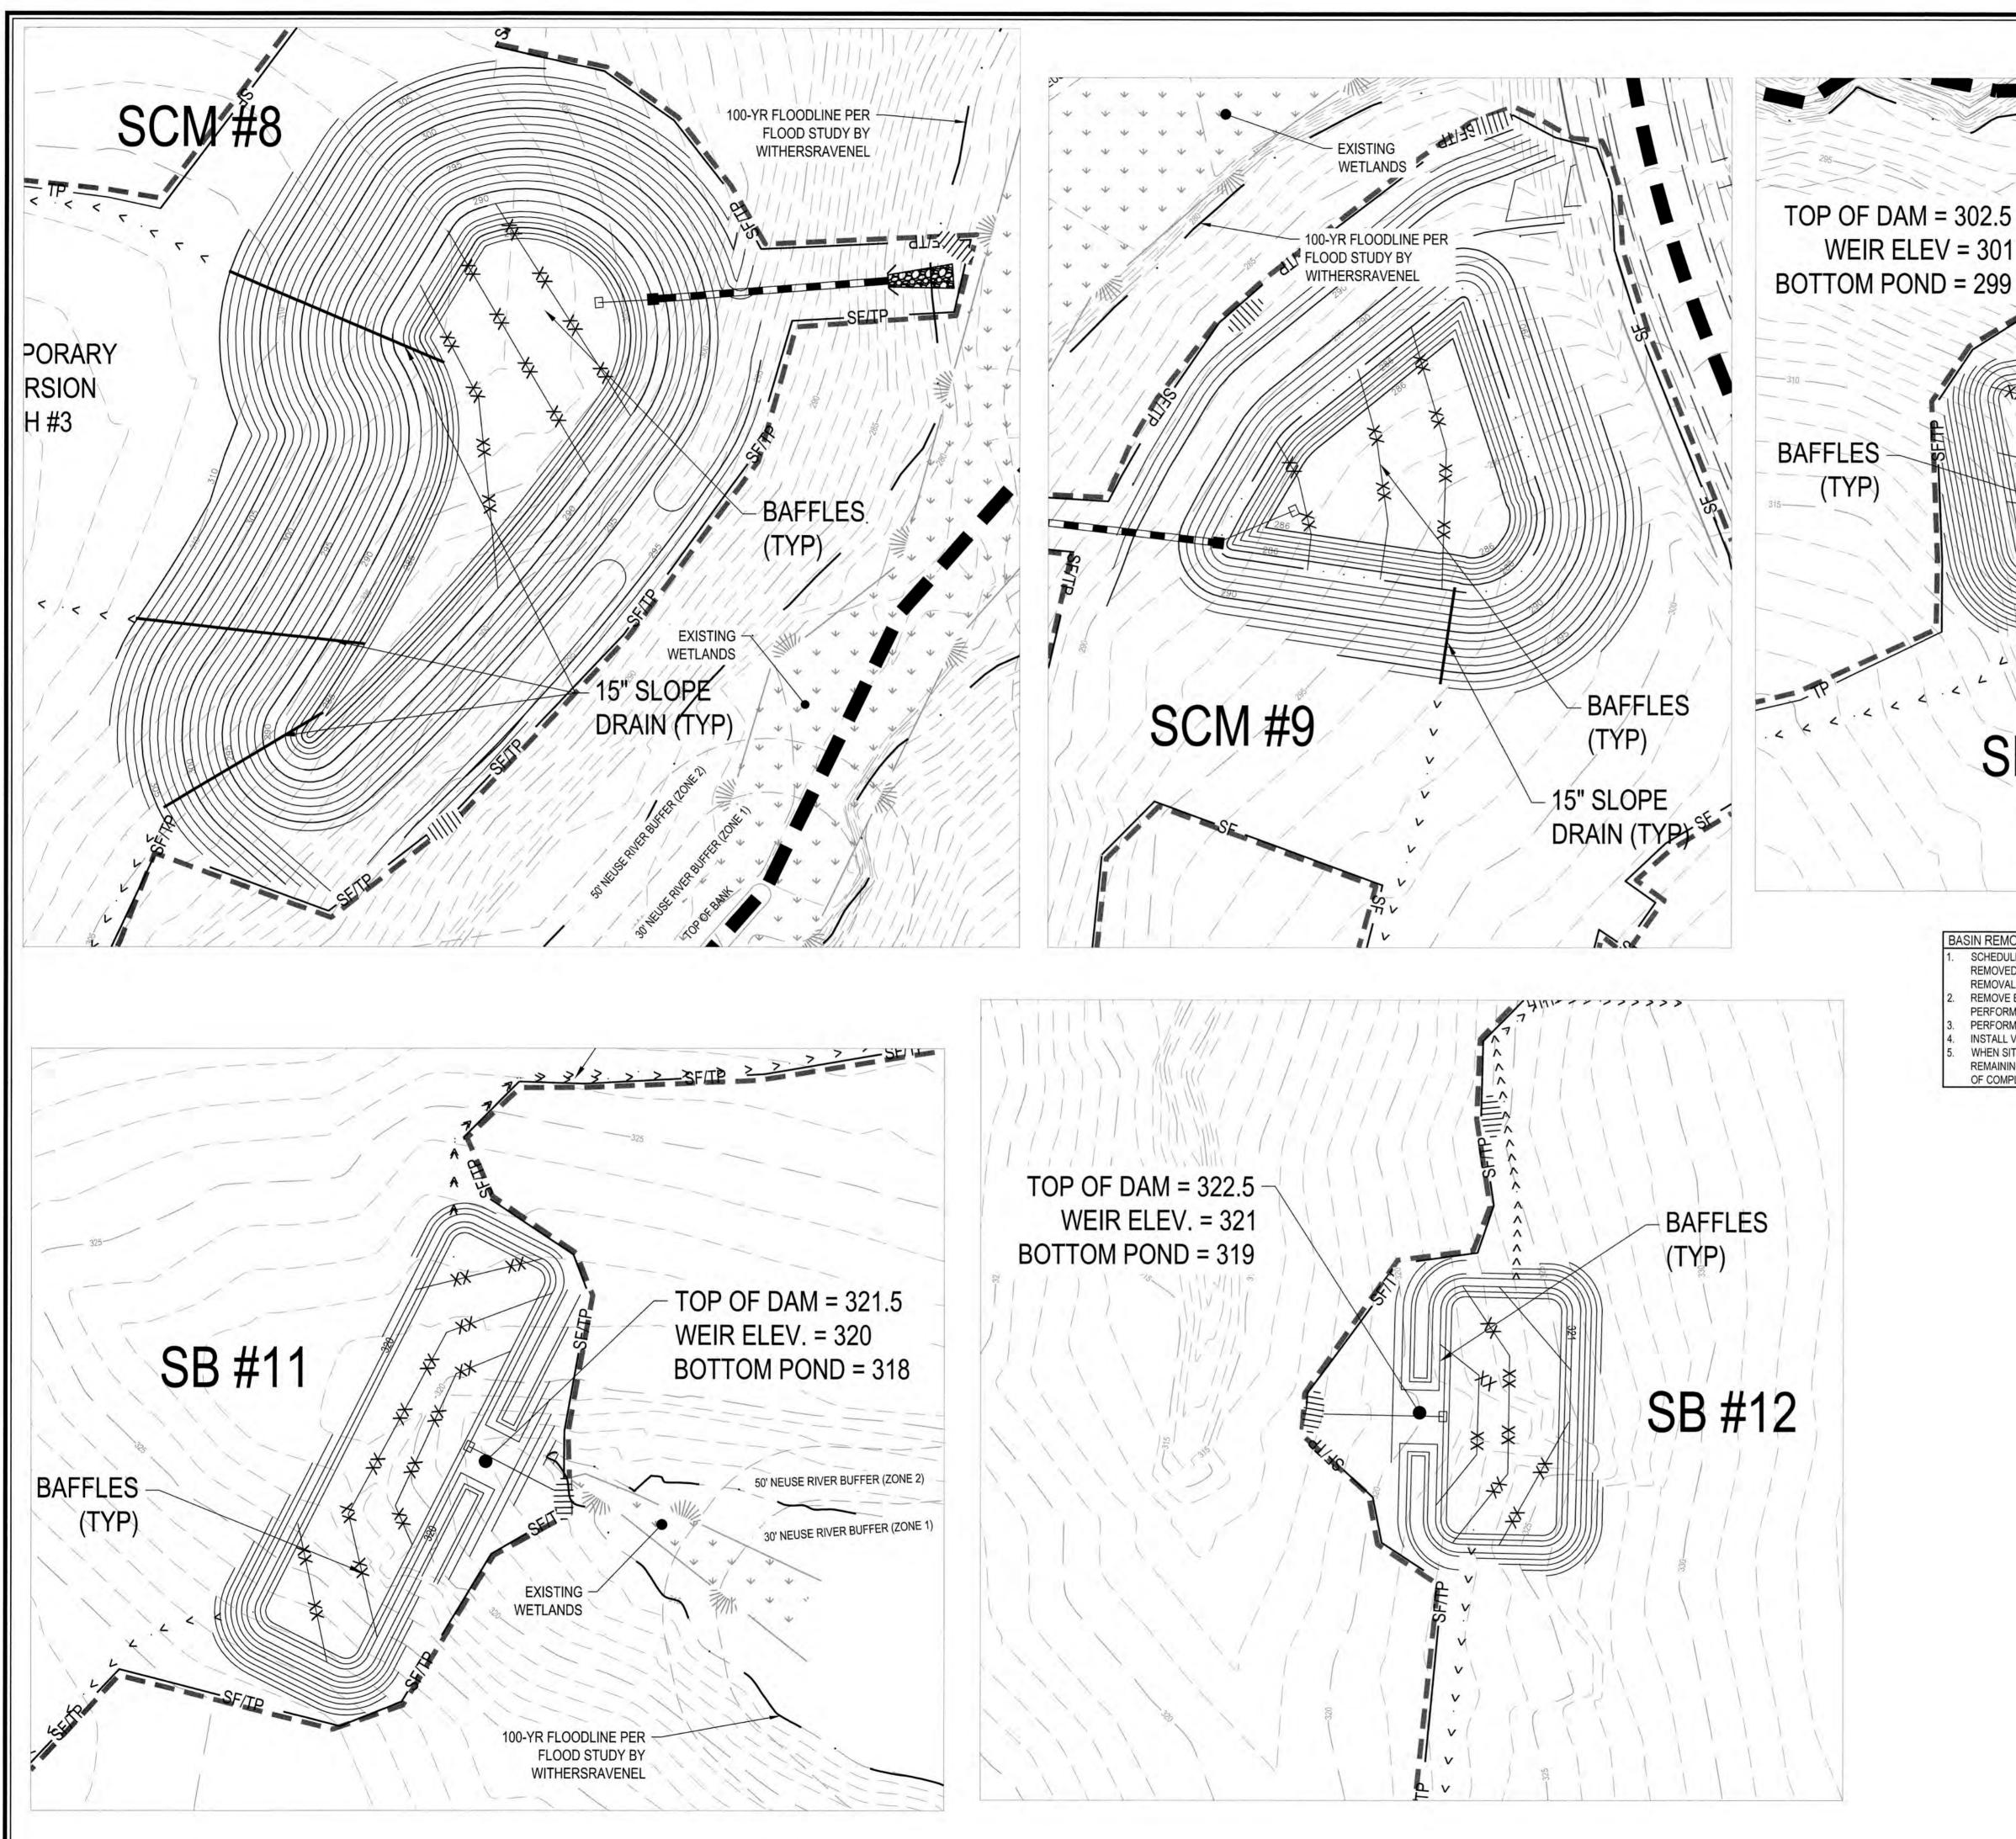

2-0250/090251.6-Knightdale Station Phase R4/CAD/MASTER-CONSTRUCTION DRAWINGS/6.0-6.1 PRE - OVERALL EROSION CONTROL PLAN.dwg- Friday, August 31, 2018 12:29:17 PM - DURYEA, COLLE

WithersRavene Engineers | Planners | Surveyors 30' NEUSE RIVER BUFFER (ZONE 50' NEUSE RIVER BUFFER (ZONE 2 XX XX XX ALE STATION AND R4 TEMPORARY DIVERSION A SB #10 DITCH #9 KNIGHTD/ R6D BASIN REMOVAL SEQUENC SCHEDULE A SITE MEETING WITH THE ENVIRONMENTAL ENGINEER/CONSULTANT TO DETERMINE IF A BASIN CAN REMOVED. INSTALL SILT FENCING OR OTHER TEMPORARY EROSION CONTROL MEASURES AS NEEDED PRIOR TO S REMOVAL OF THE BASIN. ETAIL REMOVE BASIN(S) AND ASSOCIATED TEMPORARY DIVERSION DITCHES. IF CULVERT PIPES NEED TO BE EXTENDED, PERFORM THIS OPERATION AT THIS TIME. FINE GRADE AREA IN PREPARATION FOR SEEDING. PERFORM S ) PREPARATION, SEED, MULCH, AND ASPHALT TACK ANY RESULTING BARE AREAS IMMEDIATEL INSTALL VELOCITY DISSIPATORS AND/OR LEVEL SPREADERS AS REQUIRED ON THE EROSION CONTROL PLAN. WHEN SITE IS FULLY STABILIZED, CALL ENVIRONMENTAL ENGINEER/CONSULTANT FOR APPROVAL OF REMOVING REMAINING TEMPORARY EROSION CONTROL MEASURES AND ADVICE ON WHEN SITE CAN BE ISSUED A CERTIFICAT OF COMPLETION. SIN BA SKIMMER THESE PLANS ARE APPROVED BY THE TOWN OF KNIGHTDALE AND SERVE AS CONSTRUCTION PLANS FOR THIS PROJECT. BY: <u>Mathematical Date</u>: <u>2.4.19</u> ADMINISTRATOR PUBLIC SEWER COLLECTION/EXTENSION SYSTEM Drawn By 02090251.6 WSI 06/08/2018 Designer THE CITY OF RALEIGH CONSENTS TO THE CONNECTION AND EXTENSION OF THE CITY'S PUBLIC SEWER SYSTEM AS SHOWN ON THIS PLAN. THE MATERIAL AND CONSTRUCTION METHODS USED FOR THIS PROJECT SHALL CONFORM TO THE STANDARDS AND SPECIFICATIONS OF THE CITY'S PUBLIC UTILITIES HANDBOOK. W&R CITY OF RALEIGH PUBLIC UTILITIES DEPARTMENT PERMIT # AUTHORIZATION TO CONSTRUCT SEAL 38549 WATER DISTRIBUTION/EXTENSION SYSTEM THE CITY OF RALEIGH CONSENTS TO THE CONNECTION AND EXTENSION OF THE CITY'S PUBLIC WATER SYSTEM AS SHOWN ON THIS PLAN. THE MATERIAL AND CONSTRUCTION METHODS USED FOR THIS PROJECT SHALL CONFORM TO THE STANDARDS AND SPECIFICATIONS OF THE CITY'S PUBLIC UTILITIES HANDBOOK. CITY OF RALEIGH PUBLIC UTILITIES DEPARTMENT PERMIT # 1st TOK Comments 08/31/18 AUTHORIZATION TO CONSTRUCT ALL MATERIALS & CONSTRUCTION METHODS SHALL BE IN ACCORDANCE WITH ALL CITY OF RALEIGH & TOWN OF KNIGHTDALE DESIGN STANDARDS, DETAILS, AND SPECIFICATIONS. GRAPHIC SCALE Sheet No 6.1 1 inch = 30 ft.

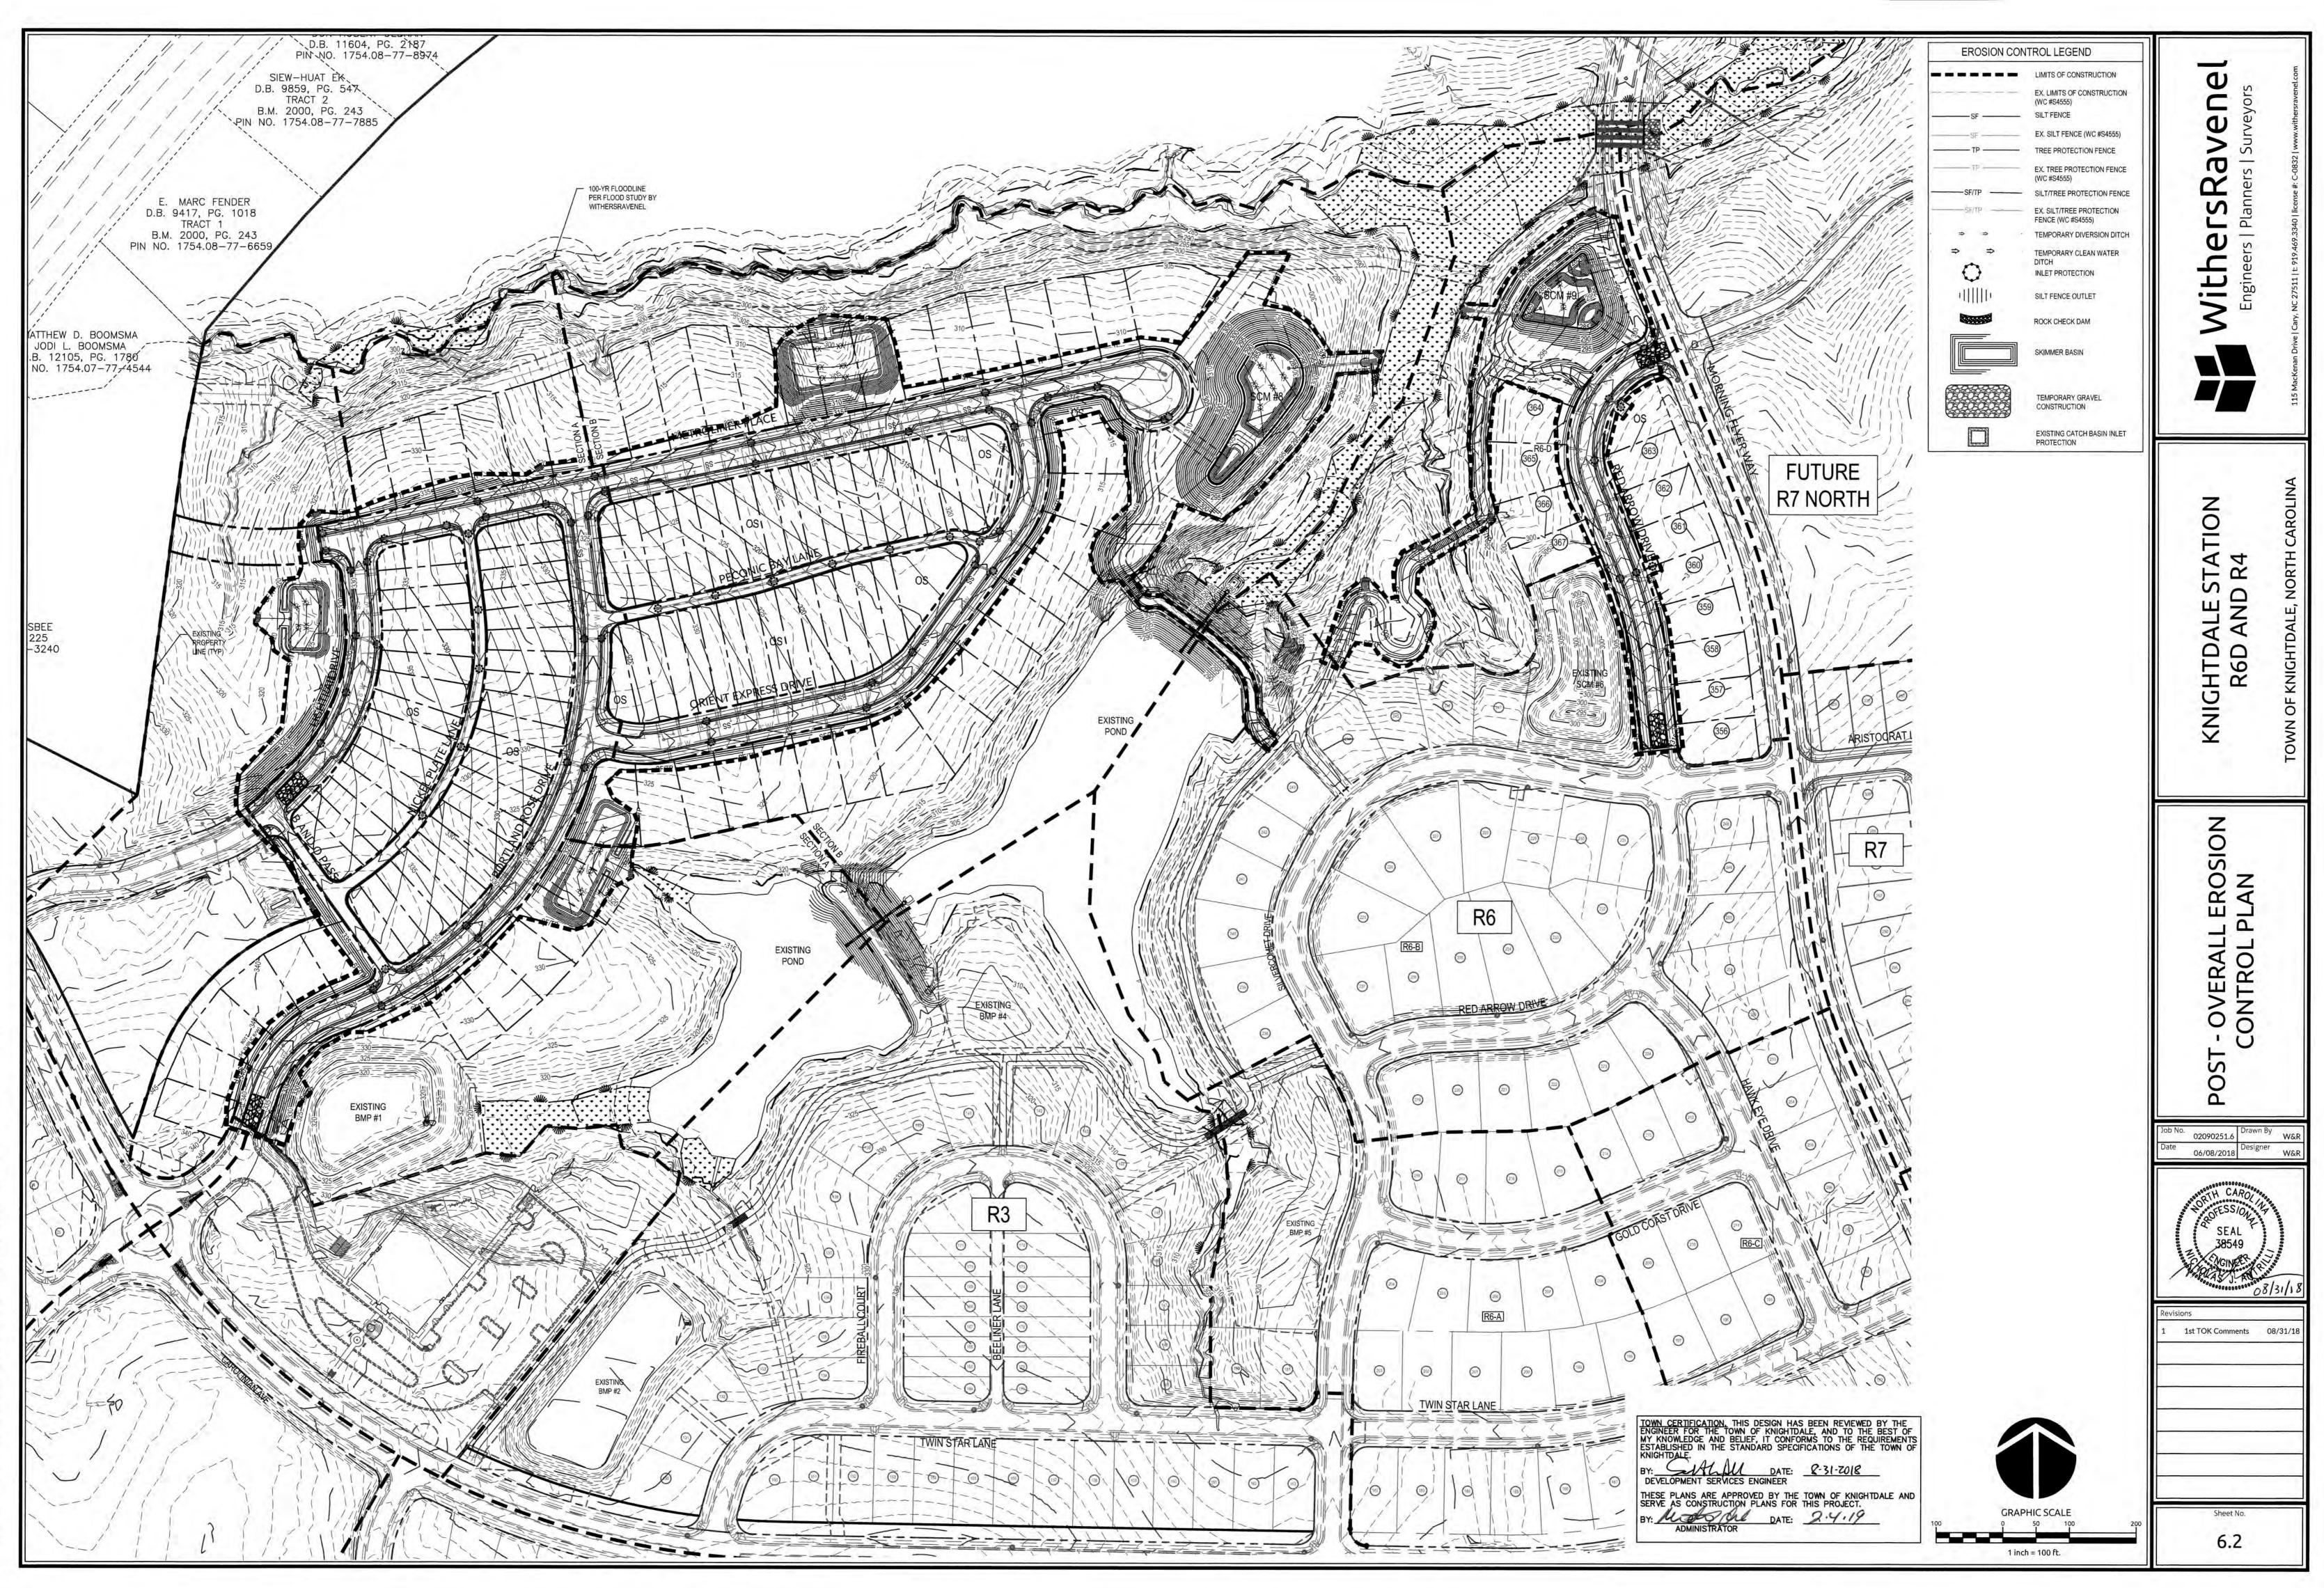

V09-0250/090251.6-Knightdale Station Phase R4\CAD\MASTER-CONSTRUCTION DRAWINGS\6.2 POST OVERALL EROSION CONTROL PLAN.dwg- Friday, August 31, 2018 12:29:46 PM - DURYEA, COLLEE




# EROSION CONTROL NOTE: FOREBAY WILL NOT BE REQUIRED WHILE SCM IS ACTING AS AN EROSION CONTROL DEVICE.

CONSTRUCTION SEQUENCE NOTE: SEE SHEET 6.2 FOR BASIN REMOVAL SEQUENCE.

	ITROL LEGEND		
	LIMITS OF CONSTRUCTION		
	EX. LIMITS OF CONSTRUCTION (WC #S4555)		
SF	SILT FENCE		
SF	EX. SILT FENCE (WC #S4555)		
TP	TREE PROTECTION FENCE		
	EX. TREE PROTECTION FENCE (WC #\$4555)		
	SILT/TREE PROTECTION FENCE		
SF/TR	EX. SILT/TREE PROTECTION FENCE (WC #S4555)		
<b>&gt; &gt;</b> +	TEMPORARY DIVERSION DITCH		
⇒ ⇒ ·	TEMPORARY CLEAN WATER DITCH		
$\mathbf{O}$	INLET PROTECTION		
())))))	SILT FENCE OUTLET		
	ROCK CHECK DAM		
	SKIMMER BASIN		
	TEMPORARY GRAVEL CONSTRUCTION		
	EXISTING CATCH BASIN INLET PROTECTION		

<b>Mithers Ravene</b> Engineers   Planners   Surveyors	
KNIGHTDALE STATION R6D AND R4 Town of Knightdale, North Carolina	
EROSION CONTROL PLAN	
Job No. 02090251.6 Drawn By W&R Date 06/08/2018 Designer W&R	
Revisions	

TOWN CERTIFICATION. THIS DESIGN HAS BEEN REVIEWED BY THE ENGINEER FOR THE TOWN OF KNIGHTDALE, AND TO THE BEST OF MY KNOWLEDGE AND BELIEF, IT CONFORMS TO THE REQUIREMENTS ESTABLISHED IN THE STANDARD SPECIFICATIONS OF THE TOWN OF KNIGHTDALE. BY: SHALAU DATE: 8-31-2018 DEVELOPMENT SERVICES ENGINEER THESE PLANS ARE APPROVED BY THE TOWN OF KNIGHTDALE AND SERVE AS CONSTRUCTION PLANS FOR THIS PROJECT. BY: <u>DATE:</u> <u>2.4.19</u> ADMINISTRATOR

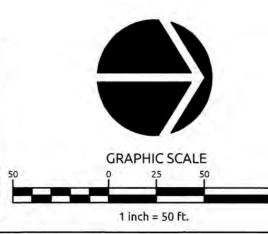



# EROSION CONTROL NOTE: FOREBAY WILL NOT BE REQUIRED WHILE SCM IS ACTING AS AN EROSION CONTROL DEVICE.

CONSTRUCTION SEQUENCE NOTE: SEE SHEET 6.2 FOR BASIN REMOVAL SEQUENCE.

EROSION CO	ONTROL LEGEND
	LIMITS OF CONSTRUCTION
	EX. LIMITS OF CONSTRUCTION (WC #S4555)
SF	SILT FENCE
SF	EX. SILT FENCE (WC #S4555)
TP	- TREE PROTECTION FENCE
TP	EX. TREE PROTECTION FENCE (WC #S4555)
SF/TP	- SILT/TREE PROTECTION FENCE
SEITP	EX. SILT/TREE PROTECTION FENCE (WC #S4555)
⇒⇒	TEMPORARY DIVERSION DITCH
⇒ ⇒	TEMPORARY CLEAN WATER DITCH
$\circ$	INLET PROTECTION
-([]]]))	SILT FENCE OUTLET
	ROCK CHECK DAM
	SKIMMER BASIN
	TEMPORARY GRAVEL CONSTRUCTION
	EXISTING CATCH BASIN INLET PROTECTION

Image: Second system       Second system         Image: Second system       Second system <td< th=""></td<>
Job No. 02090251.6 Date 06/08/2018 Designer W&R Designer W&R Designer W&R Designer W&R Designer W&R Designer W&R Designer W&R Designer W&R Designer W&R Designer W&R Designer W&R Designer W&R Designer W&R Designer W&R Designer W&R Designer W&R Designer W&R Designer Designer W&R Designer Designe
02090251.6 W&R Date 06/08/2018 Designer W&R 06/08/2018 Designer W&R 06/08/2018 Designer W&R 06/08/2018 Designer W&R 06/08/2018 Designer W&R 06/08/2018 Designer W&R 06/08/2018 Designer W&R 07 07 05 00 00 00 00 00 00 00 00 00 00 00 00
Revisions

Sheet No.

6.4

\_

C

C

Ð

>

σ

R

S

-

Φ

ĿР

• -----

3

S


Ð


S

Φ

Engi


	- 9		
			V
	GRA	PHIC SO	CALE
50	Ŷ	25	50
	11	nch = 50	ft.

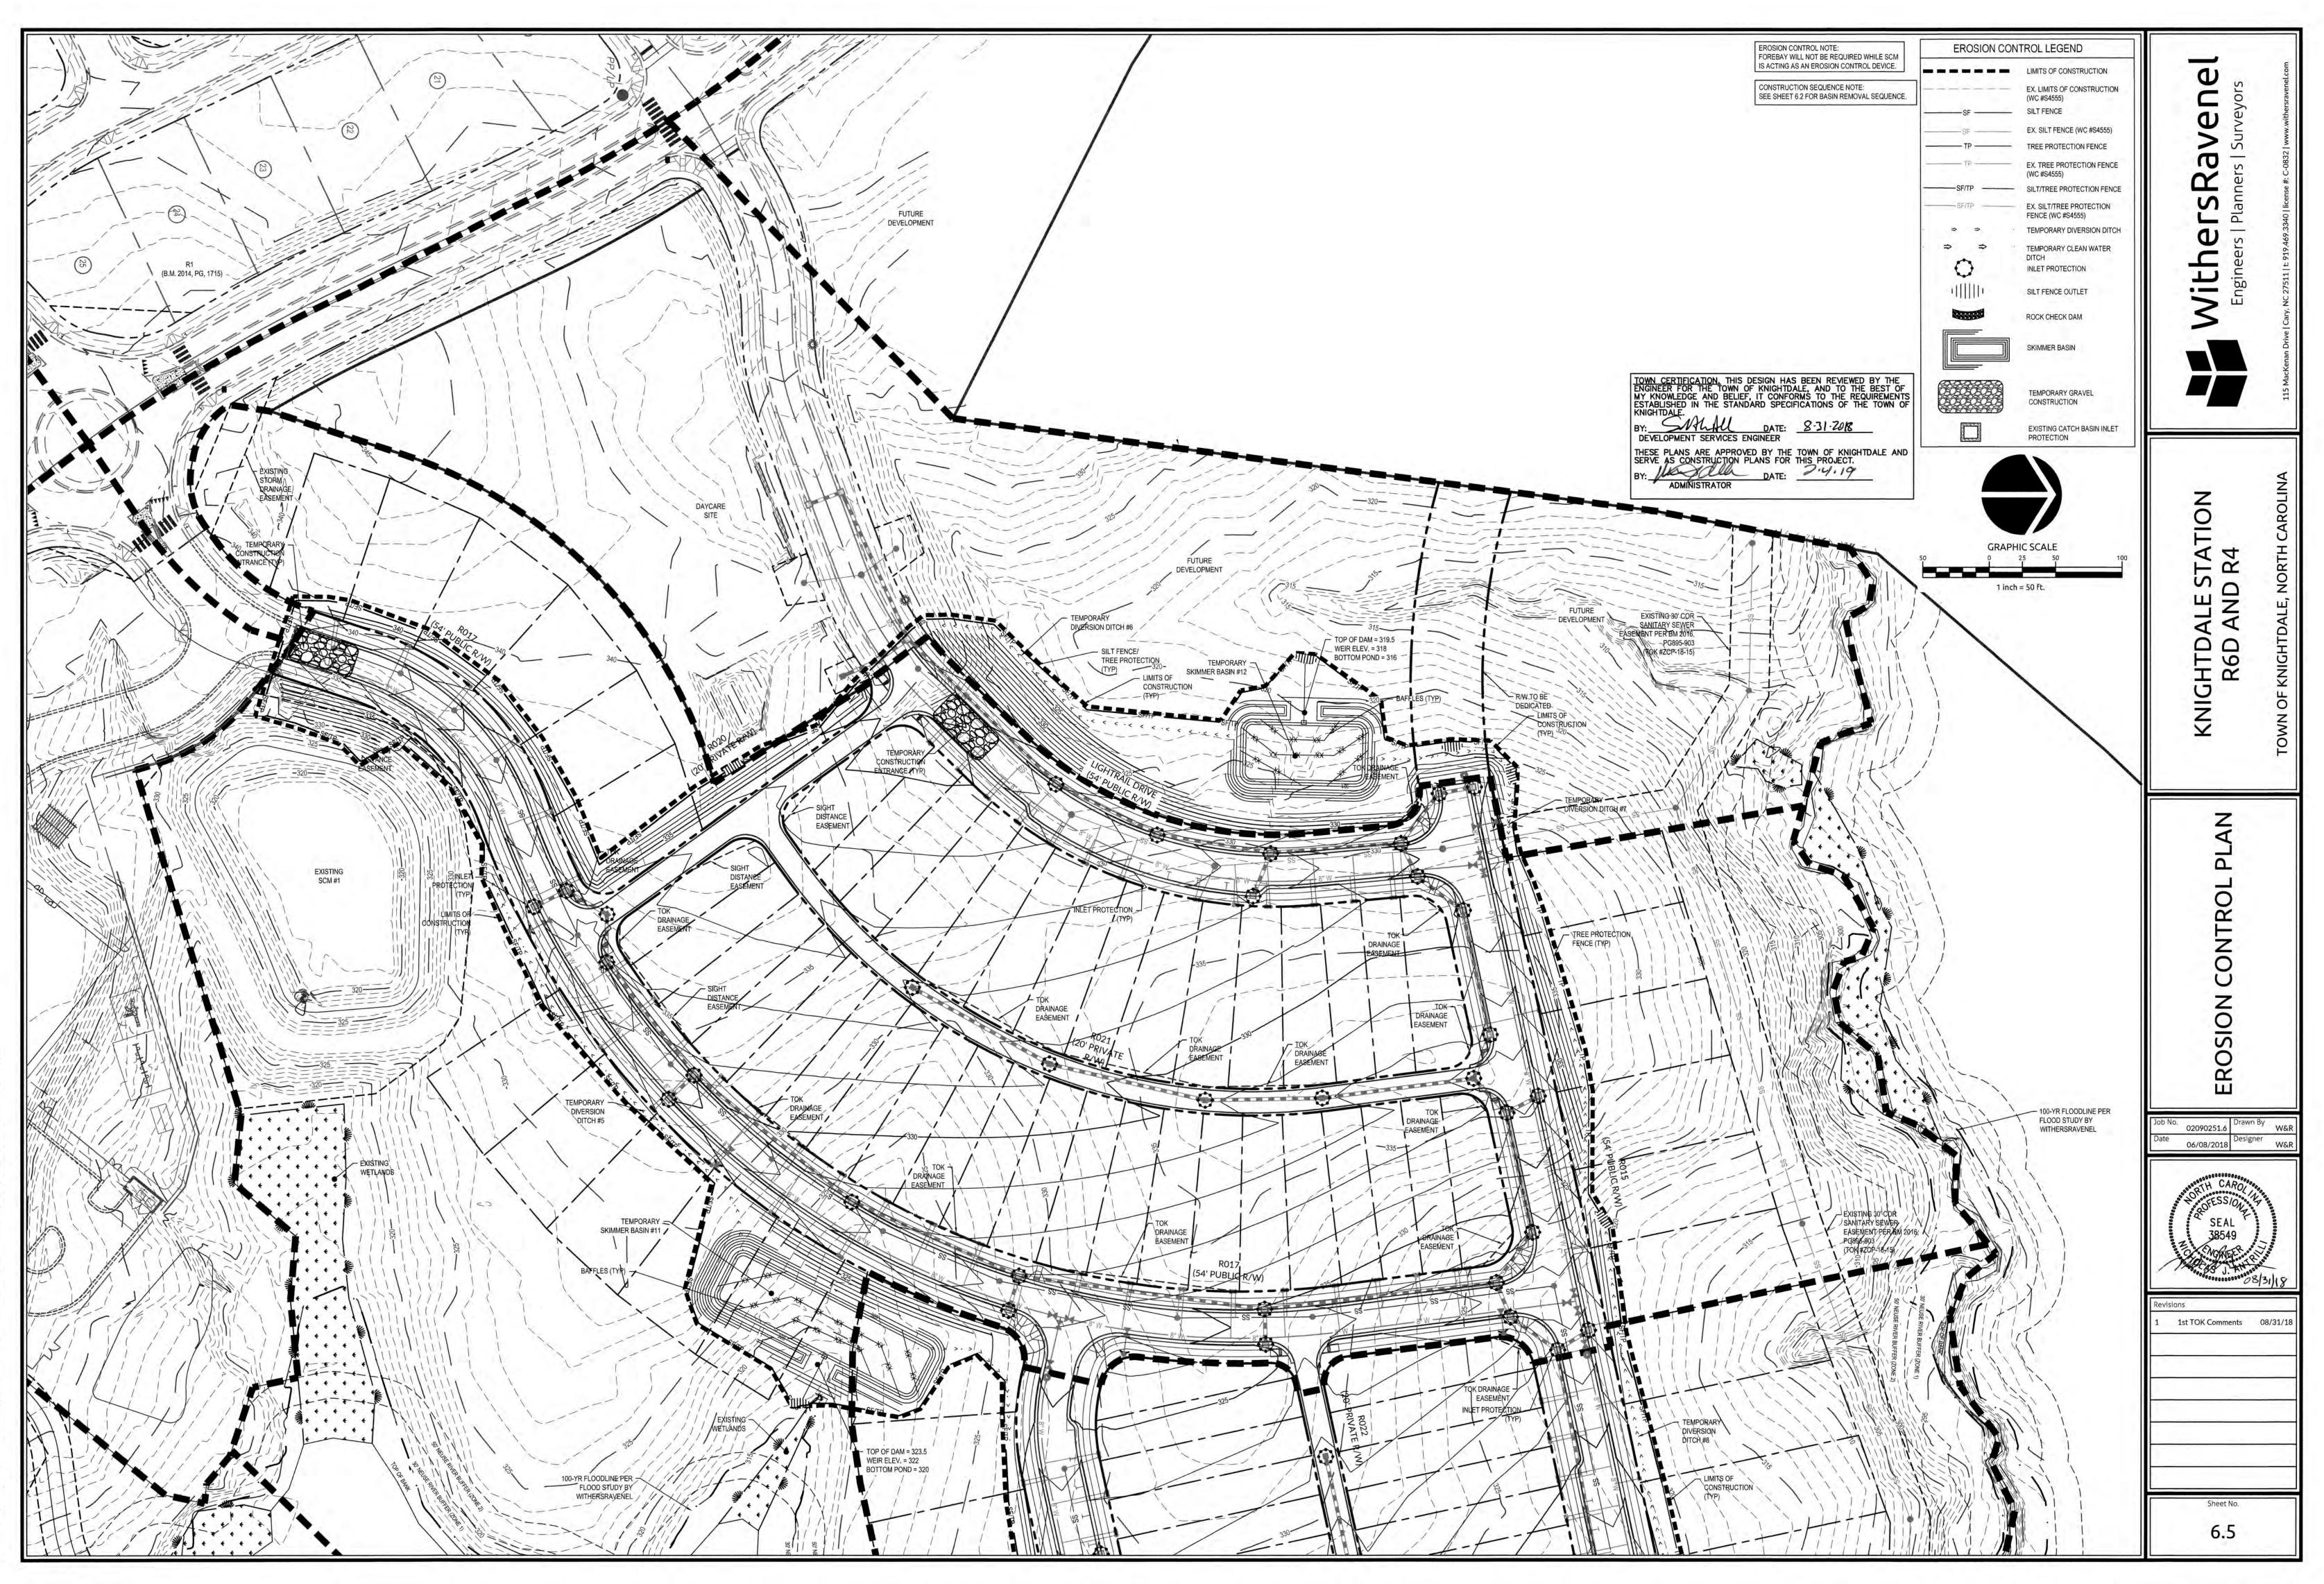

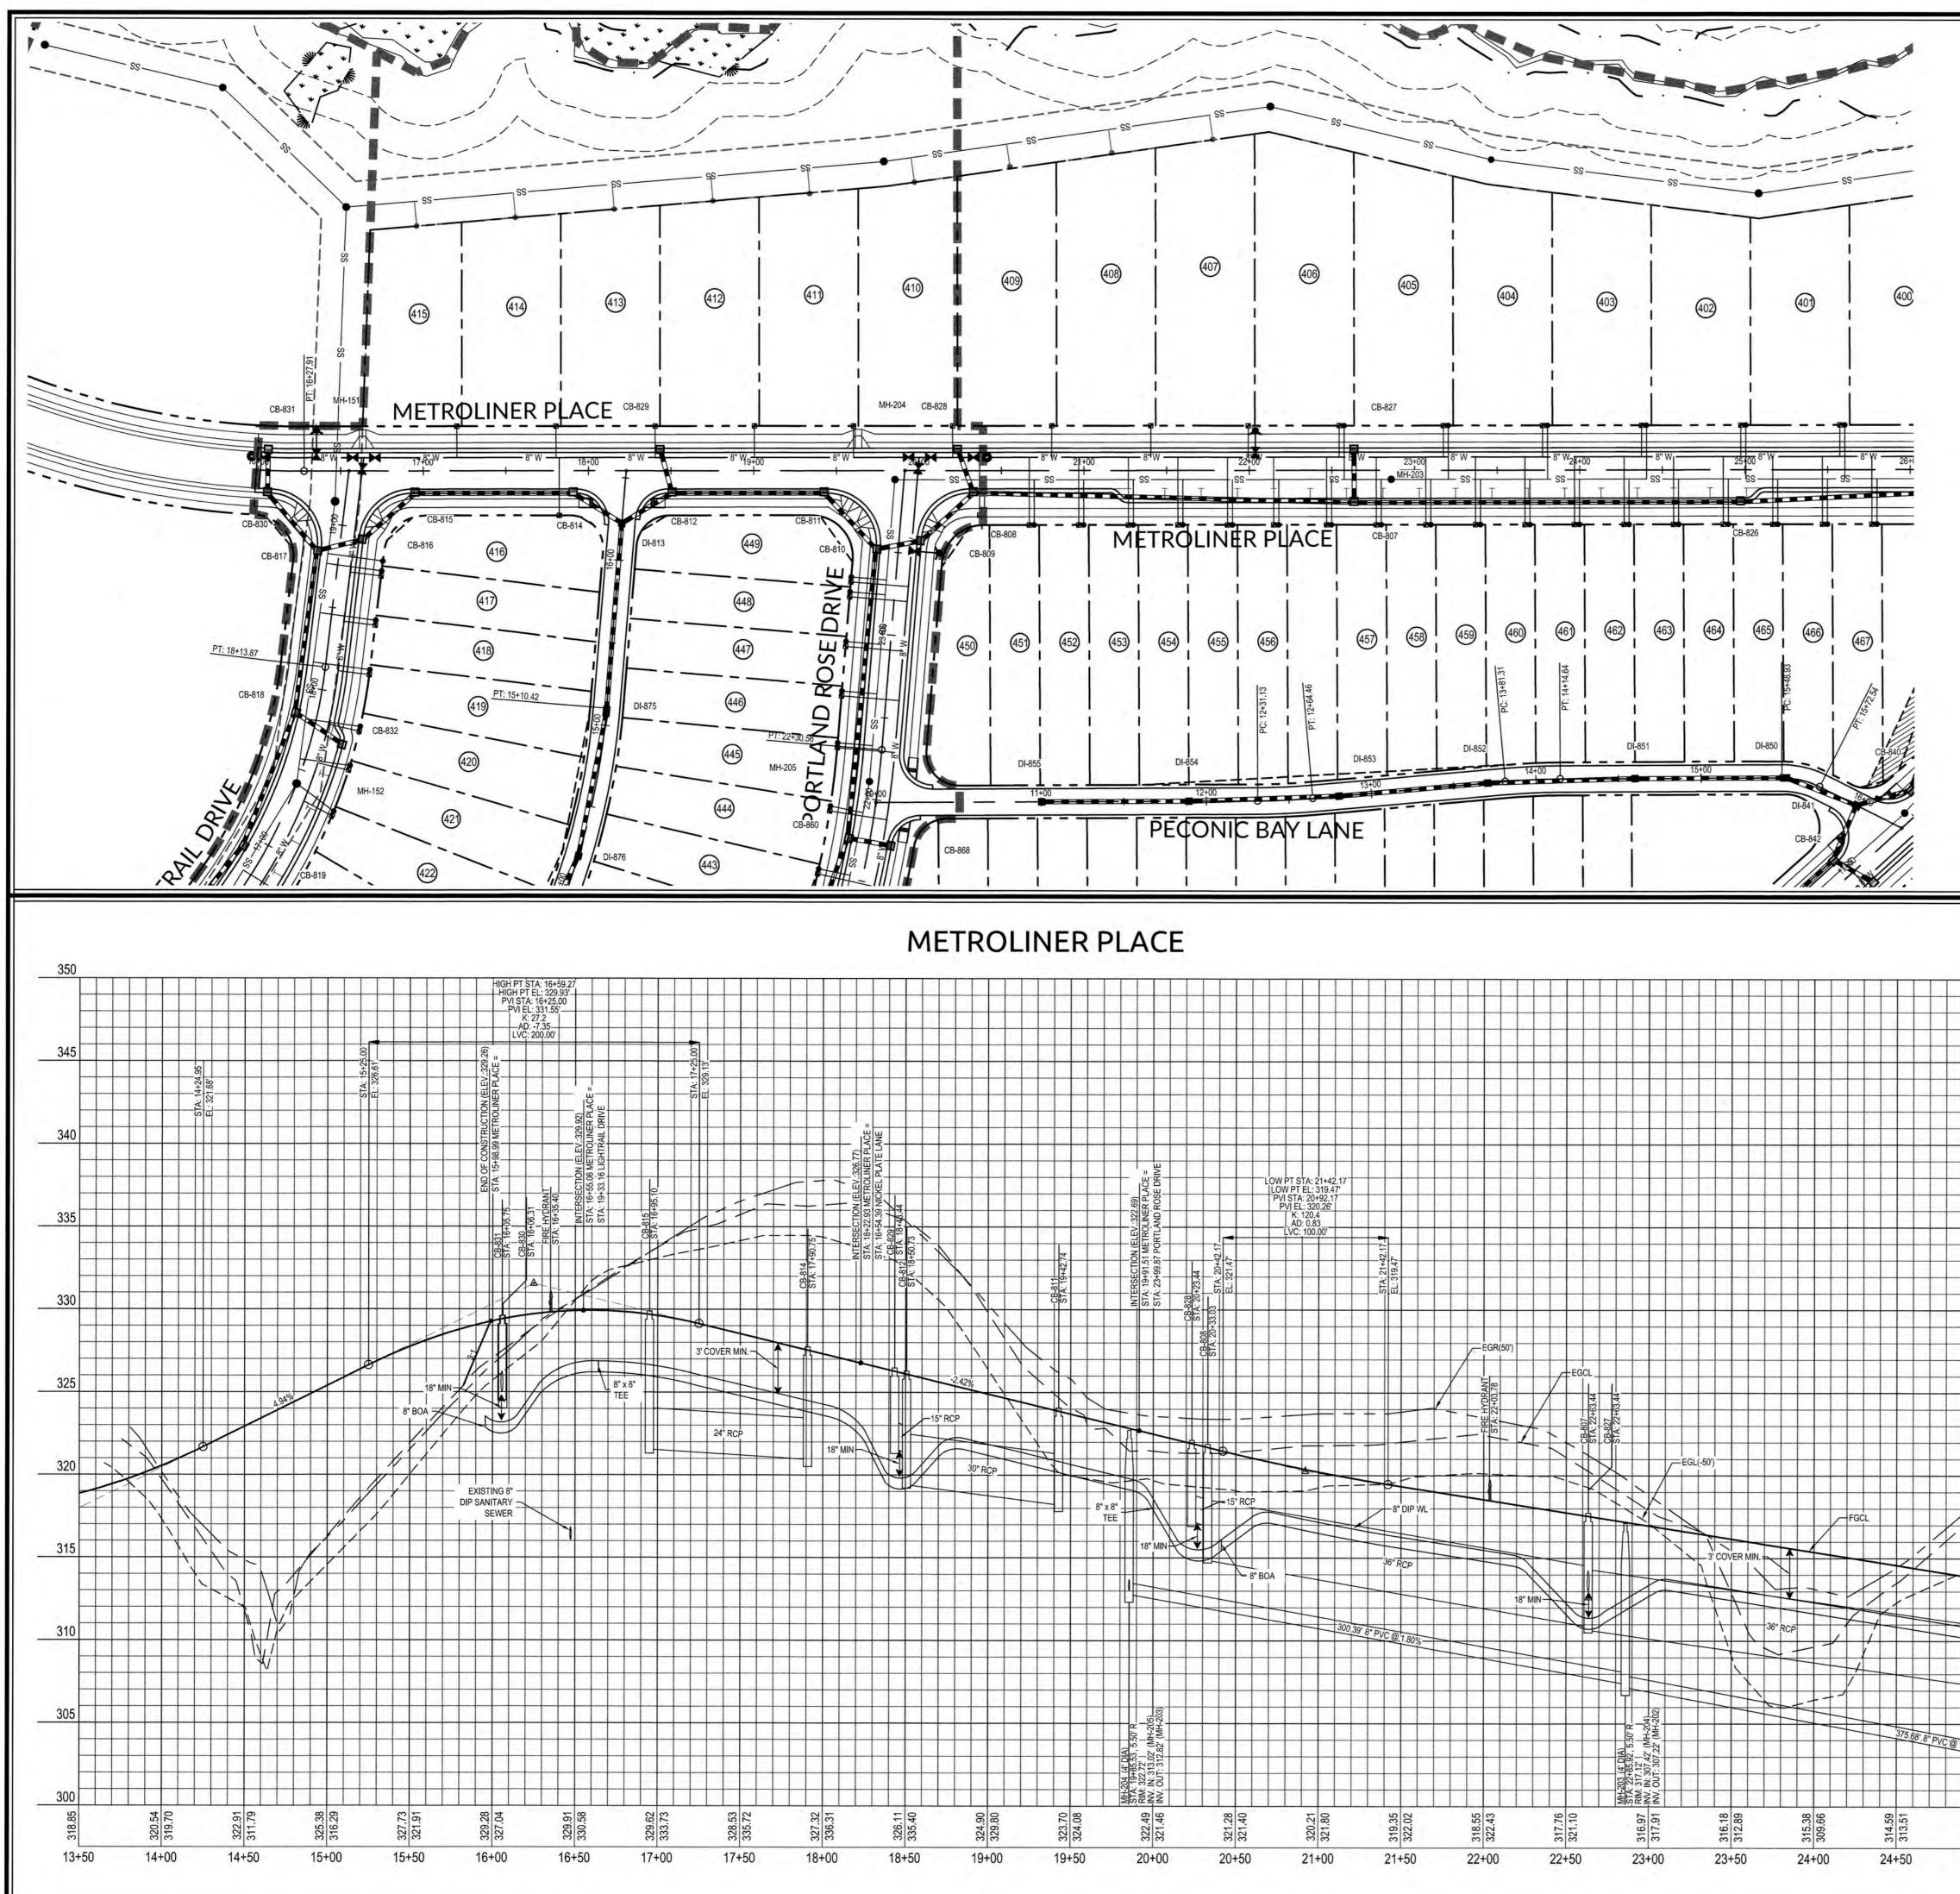


CB-811 CB-811 CB-811 CB-811 CB-811 CB-811 STA: 19+42.74 STA: 19+42.74 STA: 19+42.74 STA: 19+42.74 INTERSECTION (ELEV.:322.69) INTERSECTION (ELEV.:322.69) STA: 19+91.51 METROLINER PLACE = STA: 23+99.87 PORTLAND ROSE DRIVE STA: 23+93.87 PORTLAND ROSE DRIVE STA: 20+33.03 STA: 20+42.17 EL: 321.47	LOW PT STA: 21+42.17 LOW PT STA: 21+42.17 ILOW PT EL: 319.47' PVI STA: 20+92.17 PVI EL: 320.26' K: 120.4 AD: 0.83 LVC: 100.00' LVC: 10			
242% RCP 30" RCP 8" x 8" TEE	LINE HYDRANT-	EGCL	=EGL(-50')	
	36" RCP 8" BOA 300.39" 8" PVC @.1.80%	18" MIN	3' COVER MIN.	
324.90 329.80 329.80 323.70 324.08 323.70 324.08 MH-204.4* DA) MH-204.4* DA) 321.46 NM-204.4* DA) 321.46 NM-204.4* DA) 321.28 NM-204.4* DA) 321.28 NM-204.4* DA) 321.28 321.28	321.40 320.21 321.80 321.80 319.35 322.02 318.55 322.43	317.76 321.10 321.10 321.10 MH-203.4* DA) 317.91 RM: 317.182 RM: 317.122 RM: 307.22 (MH-202) 317.91 INV. 0UT: 307.22 (MH-202)	316.18 312.89 315.38 315.38	309.666 314.59 313.51 313.51 313.80 313.80 313.80 313.80

PUBLIC SEWER COLLECTION/EXTENSION SYSTEM Φ THE CITY OF RALEIGH CONSENTS TO THE CONNECTION AND EXTENSION OF THE CITY'S PUBLIC SEWER SYSTEM AS SHOWN ON THIS PLAN. THE MATERIAL AND CONSTRUCTION METHODS USED FOR THIS PROJECT SHALL CONFORM TO THE STANDARDS AND SPECIFICATIONS OF THE CITY'S PUBLIC UTILITIES HANDBOOK. C 0 CITY OF RALEIGH PUBLIC UTILITIES DEPARTMENT PERMIT # 5-4466 AUTHORIZATION TO CONSTRUCT ARE UM. Sample Φ > Su 1/24/19 σ DATE -S 2 PUBLIC WATER DISTRIBUTION/EXTENSION SYSTEM S P THE CITY OF RALEIGH CONSENTS TO THE CONNECTION AND EXTENSION OF THE CITY'S PUBLIC WATER SYSTEM AS SHOWN ON THIS PLAN. THE MATERIAL AND CONSTRUCTION METHODS USED FOR THIS PROJECT SHALL CONFORM TO THE STANDARDS AND SPECIFICATIONS OF THE CITY'S PUBLIC UTILITIES HANDBOOK. Ы Φ -S With CITY OF RALEIGH PUBLIC UTILITIES DEPARTMENT PERMIT # \_\_\_\_\_\_ W-3574 AUTHORIZATION TO CONSTRUCT Anew UM. Sample 10 ш THESE PLANS ARE APPROVED BY THE TOWN OF KNIGHTDALE AND SERVE AS CONSTRUCTION PLANS FOR THIS PROJECT. BY: <u>DATE:</u> <u>2.4.19</u> ADMINISTRATOR ALE STATION AND R4 OLIN 2 NORTH KNIGHTDALE,  $\triangleleft$ R6D GRAPHIC SCAL KNIG QF 1 inch = 50 ft. MO SCALE: 1" = 50' HORIZ. 1" = 5' VERT. Z WATERLINE NOTE: IF MINIMUM CLEARANCE CANNOT BE ACHIEVED WITHOUT EXCEEDING MAXIMUM PIPE DEFLECTION FOR THE Р WATERLINE, THEN CONTRACTOR TO INSTALL 45' VERTICAL 345 BENDS PER COR DETAIL W-12. ш U CLASS 1 STRUCTURAL MATERIAL NOTE: 1 CLASS 1 STRUCTURAL MATERIAL REQUIRED FROM & PROFILE EXISTING GROUND TO SPRING LINE OF PROPOSED STORM PIPE IN FILL CONDITIONS.SEE LATEST TOK STANDARD 340 SPECIFICATIONS. CITY OF RALEIGH ALL CONSTRUCTION MUST BE IN ACCORDANCE WITH ALL LOCAL, STATE, AND FEDERAL RULES AND REGULATIONS. 335 0 TRANSPORTATION SERVICES N/A METR PUBLIC UTILITIES 330 STORMWATER N/A PLANNING N/A FIRE N/A Drawn By 02090251.6 WSI 325 06/08/2018 Designer URBAN FORESTRY N/A W&R H CAR ATTENTION CONTRACTORS 1320 THE CONSTRUCTION CONTRACTOR RESPONSIBLE FOR THE EXTENSION OF WATER AND SEWER, AS APPROVED IN THESE PLANS, IS RESPONSIBLE FOR <u>CONTACTING</u> THE PUBLIC UTILITIES DEPARTMENT AT <u>(919) 996–4540</u> AT <u>LEAST 24 HOURS</u> PRIOR TO BEGINNING ANY CONSTRUCTION. SEAL 38549 FAILURE TO NOTIFY BOTH CITY DEPARTMENTS IN ADVANCE OF BEGINNING CONSTRUCTION WILL RESULT IN THE ISSUANCE OF MONETARY FINES AND REQUIRE REINSTALLATION OF ANY WATER OR SEWER FACILITIES NOT INSPECTED AS A RESULT OF THIS NOTIFICATION FAILURE. FAILURE TO CALL FOR INSPECTION, INSTALL A DOWNSTREAM PLUG, HAVE PERMITTED PLANS ON THE JOB SITE, OR ANY OTHER VIOLATION OF CITY OF RALEIGH STANDARDS WILL RESULT IN A FINE AND POSSIBLE EXCLUSION FROM FUTURE WORK 1st TOK Comments 08/31/18 IN THE CITY OF RALEIGH. 300 88 313. Sheet No. 25+50 7.1

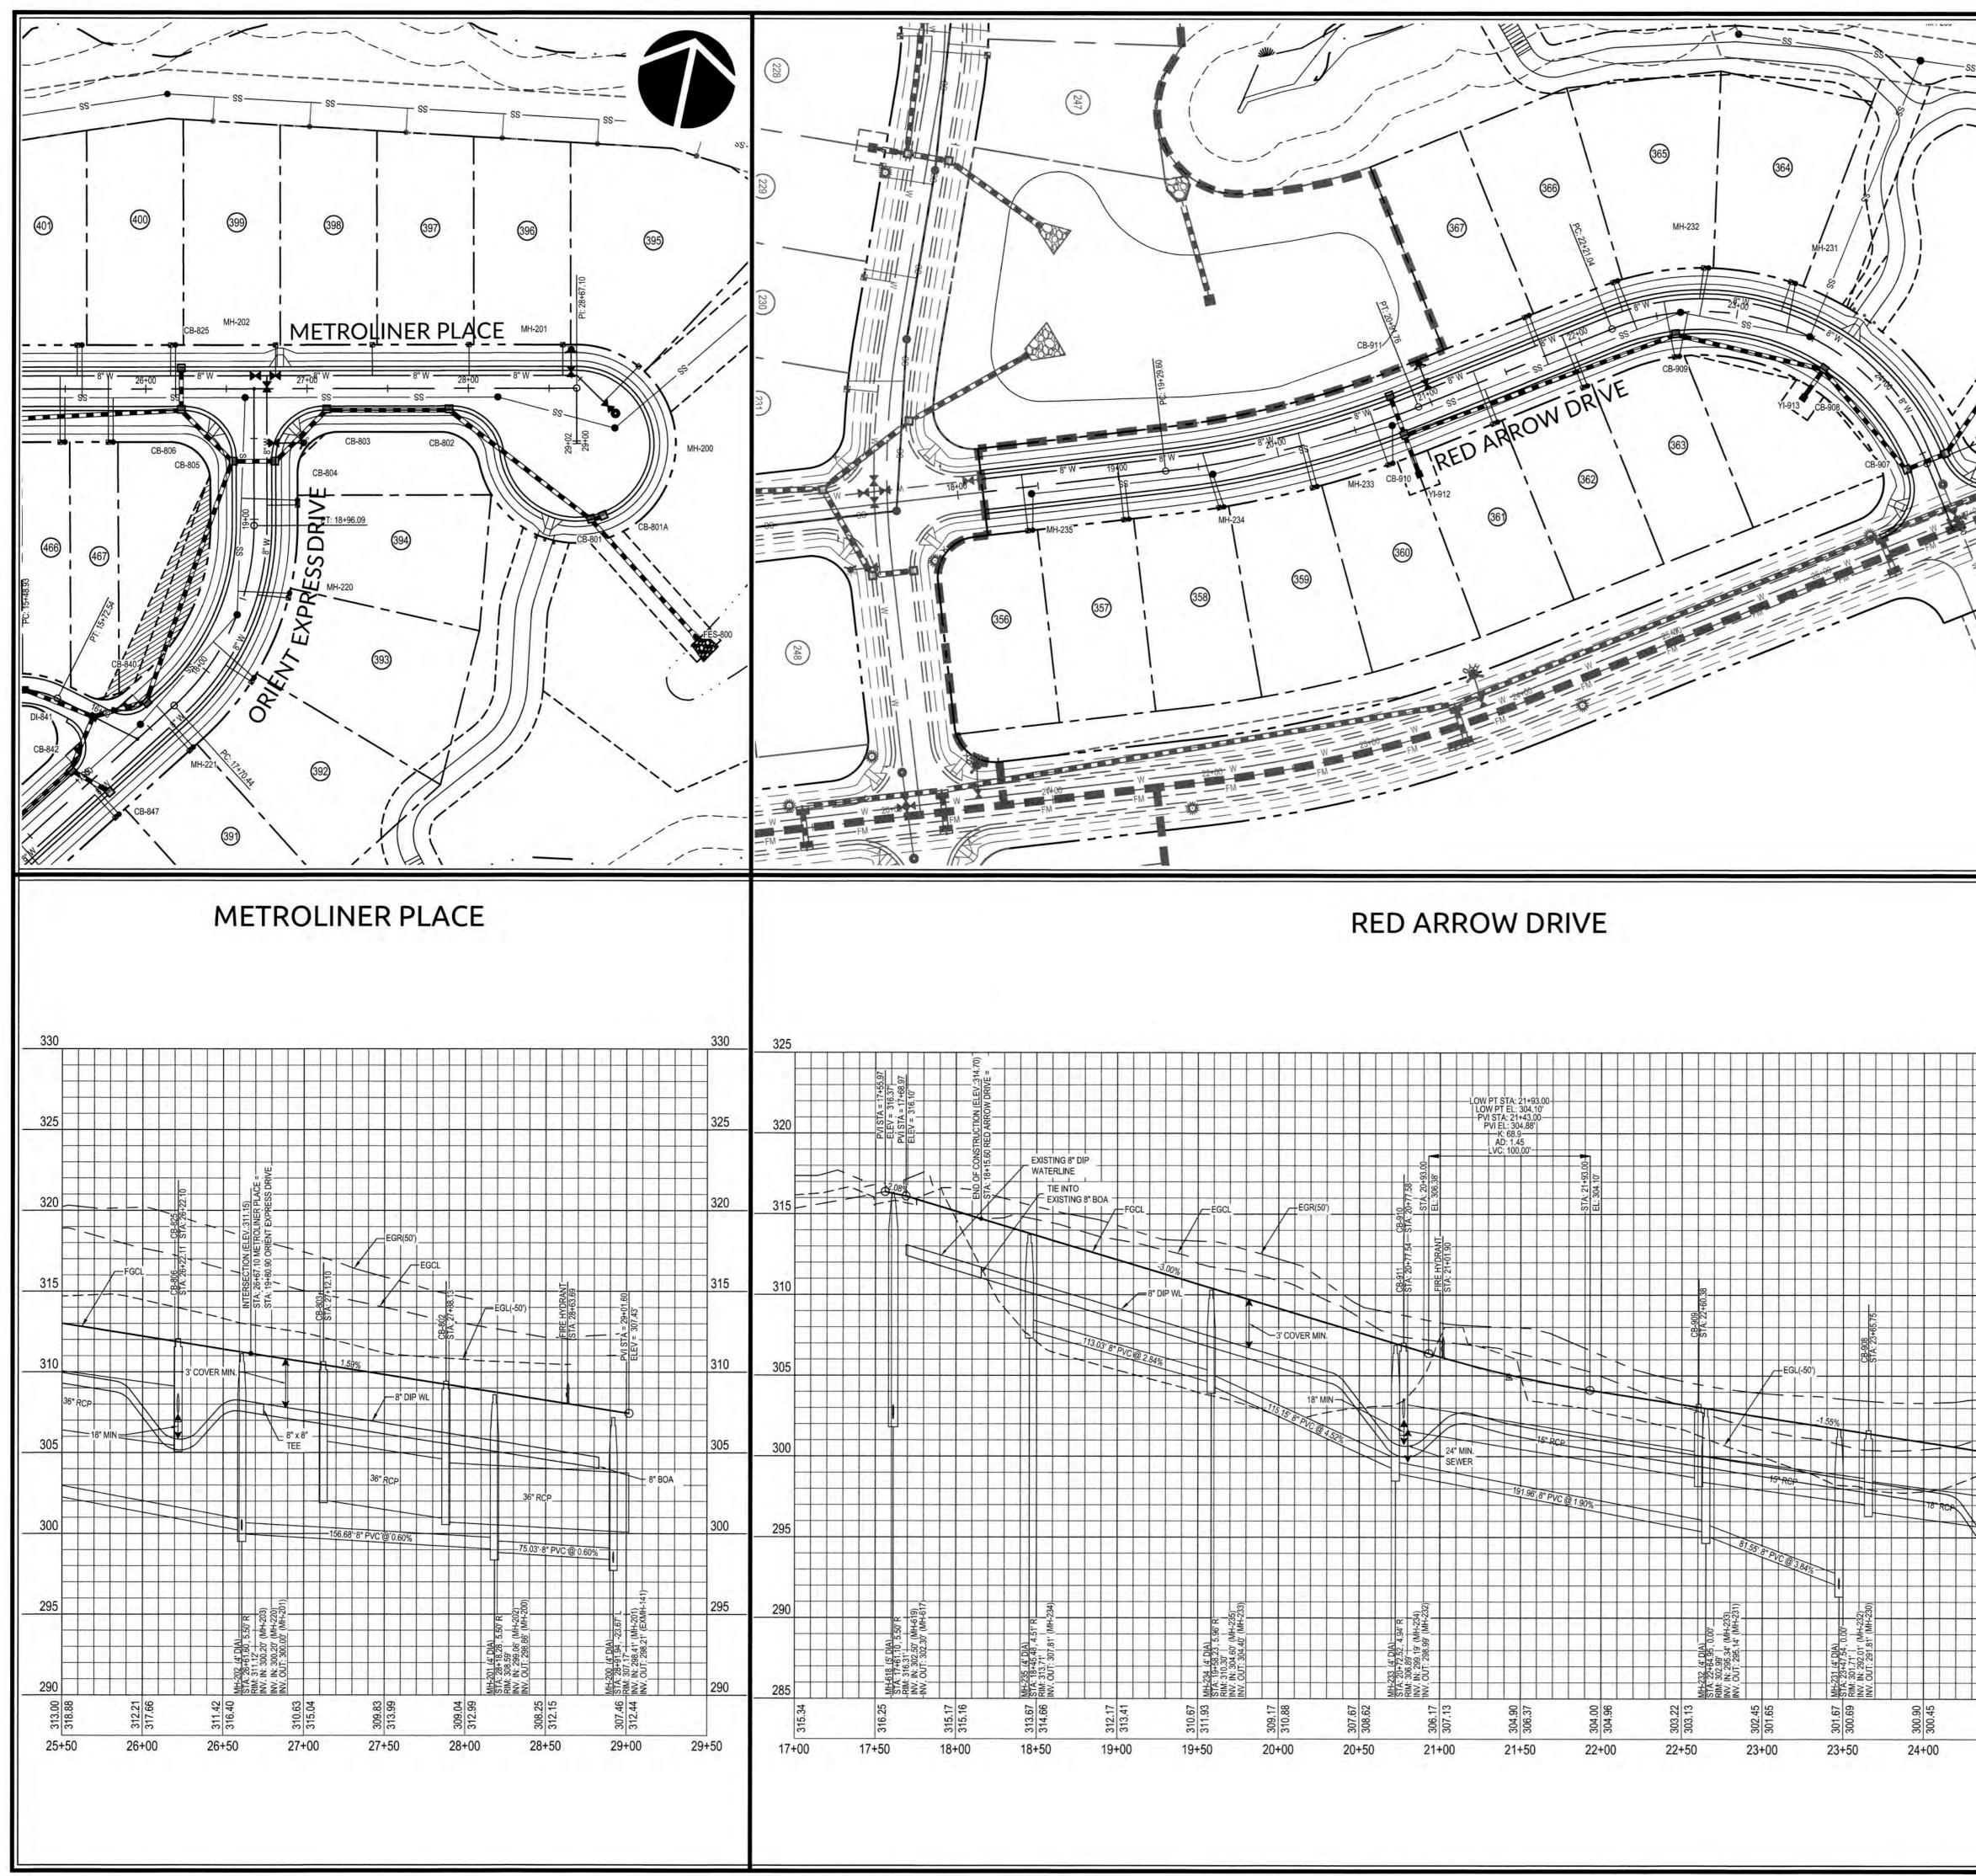



K: 109109-02501090251.6-Knightdale Station Phase R41CAD1MASTER-CONSTRUCTION DRAWINGS17.1-7.8 PLAN AND PROFILES.dwg-Thursday, August 30, 2018 9:10:51 PM - DURYEA, COLLEEN

PUBLIC SEWER COLLECTION/EXTENSION SYSTEM Φ THE CITY OF RALEIGH CONSENTS TO THE CONNECTION AND EXTENSION OF THE CITY'S PUBLIC SEWER SYSTEM AS SHOWN ON THIS PLAN. THE MATERIAL AND CONSTRUCTION METHODS USED FOR THIS PROJECT SHALL CONFORM TO THE STANDARDS AND SPECIFICATIONS OF THE CITY'S PUBLIC UTILITIES HANDBOOK. CITY OF RALEIGH PUBLIC UTILITIES DEPARTMENT PERMIT # 5-4486 Φ AUTHORIZATION TO CONSTRUCT for the going les > S θ \_ S 2 PUBLIC WATER DISTRIBUTION/EXTENSION SYSTEM S THE CITY OF RALEIGH CONSENTS TO THE CONNECTION AND EXTENSION OF TH CITY'S PUBLIC WATER SYSTEM AS SHOWN ON THIS PLAN. THE MATERIAL AND CONSTRUCTION METHODS USED FOR THIS PROJECT SHALL CONFORM TO THE STANDARDS AND SPECIFICATIONS OF THE CITY'S PUBLIC UTILITIES HANDBOOK. Φ \_ S With AUTHORIZATION TO CONSTRUCT AR Mar Server 20 1/28/19 DATE Ъ FES-905 TOWN CERTIFICATION. THIS DESIGN HAS BEEN REVIEWED BY THE ENGINEER FOR THE TOWN OF KNIGHTDALE, AND TO THE BEST OF MY KNOWLEDGE AND BELIEF, IT CONFORMS TO THE REQUIREMENTS ESTABLISHED IN THE STANDARD SPECIFICATIONS OF THE TOWN OF KNIGHTDALE. BY: \_\_\_\_\_\_\_DATE: 8-31-2018 DEVELOPMENT SERVICES ENGINEER BY: **A**7 THESE PLANS ARE APPROVED BY THE TOWN OF KNIGHTDALE AND SERVE AS CONSTRUCTION PLANS FOR THIS PROJECT. BY: <u>DATE:</u> <u>2.44.19</u> ADMINISTRATOR **TATION** 4 À -AND F ∢ 00 HTI R61 GRAPHIC SCALE KNIG 1 inch = 50 ft. SCALE: 1" = 50' HORIZ. 1" = 5' VERT. Q ⊗ WATERLINE NOTE: CE ANI IF MINIMUM CLEARANCE CANNOT BE ACHIEVED WITHOUT EXCEEDING MAXIMUM PIPE DEFLECTION FOR THE WATERLINE, THEN CONTRACTOR TO INSTALL 45' VERTICAL BENDS PER COR DETAIL W-12. P CLASS 1 STRUCTURAL MATERIAL NOTE: CLASS 1 STRUCTURAL MATERIAL REQUIRED FROM R PLA EXISTING GROUND TO SPRING LINE OF PROPOSED STORM PIPE IN FILL CONDITIONS. SEE LATEST TOK STANDARD SPECIFICATIONS. 320 ₩ > ROLINER ARROW PROF CITY OF RALEIGH ALL CONSTRUCTION MUST BE IN ACCORDANCE WITH ALL LOCAL, STATE, AND FEDERAL RULES AND REGULATIONS. 315 TRANSPORTATION SERVICES N/A DA (46) 1/24/19 PUBLIC UTILITIES 8 20 шш STORMWATER N/A ΣR 310 PLANNING N/A FIRE N/A Drawn By 02090251.6 WS. 06/08/2018 Designer 254 W&R \_\_\_\_\_305 URBAN FORESTRY N/A PVI STA ELEV = PVI ST ELEV = TH CAR ATTENTION CONTRACTORS FESSION. THE CONSTRUCTION CONTRACTOR RESPONSIBLE FOR THE EXTENSION OF WATER AND SEWER, AS APPROVED IN THESE PLANS, IS RESPONSIBLE FOR <u>CONTACTING</u> THE PUBLIC UTILITIES DEPARTMENT AT <u>(919) 996–4540</u> AT <u>LEAST 24 HOURS</u> PRIOR TO BEGINNING ANY CONSTRUCTION. 8.08% SEAL TYN-38549 CONCINEER. FAILURE TO NOTIFY BOTH CITY DEPARTMENTS IN ADVANCE OF BEGINNING CONSTRUCTION WILL RESULT IN THE ISSUANCE OF MONETARY FINES AND AS AS TIE INTO 18" MIN EXISTING 8" BOA 295 REQUIRE REINSTALLATION OF ANY WATER OR SEWER FACILITIES NOT INSPECTED 08/31/18 AS A RESULT OF THIS NOTIFICATION FAILURE. FAILURE TO CALL FOR INSPECTION, INSTALL A DOWNSTREAM PLUG, HAVE PERMITTED PLANS ON THE JOB SITE, OR ANY OTHER VIOLATION OF CITY OF RALEIGH STANDARDS WILL RESULT IN A <u>FINE AND POSSIBLE EXCLUSION</u> FROM FUTURE WORK IN THE CITY OF RALEIGH. 1st TOK Comments 08/31/18 290 1285 300.12 301.67 8 8 299 24+50 25+00 25+50 Sheet No. 7.2

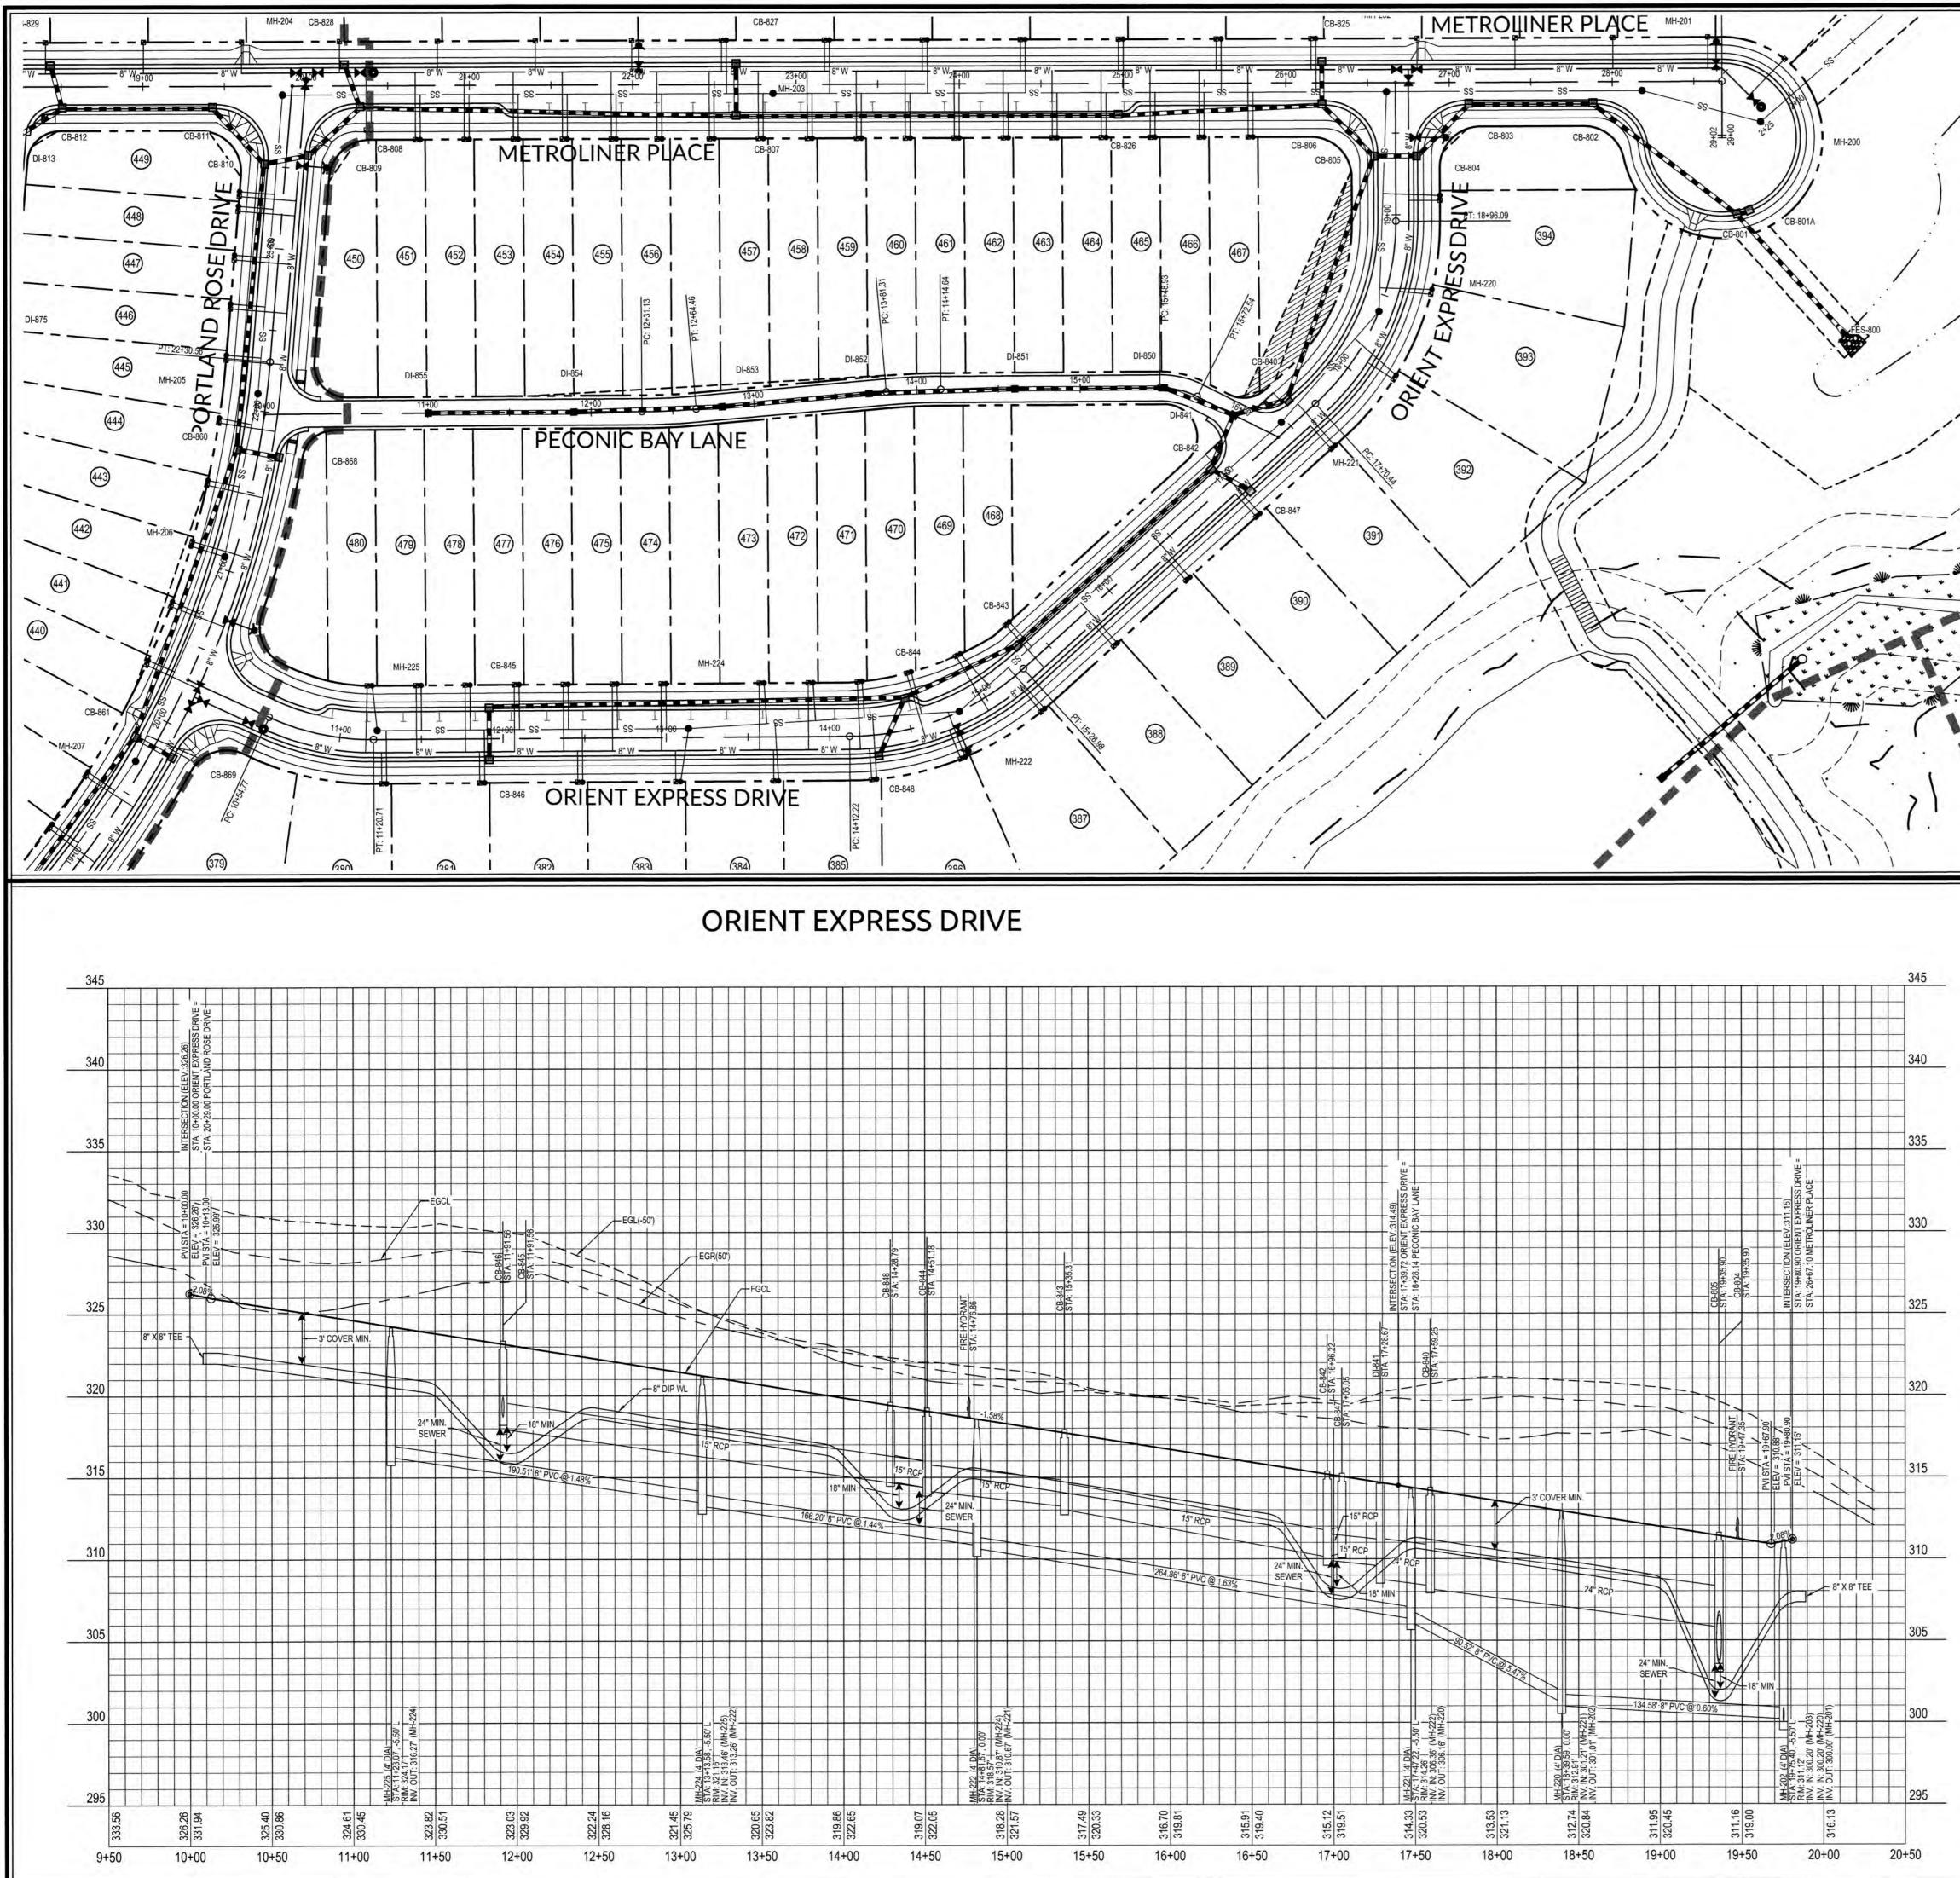


PUBLIC SEWER COLLECTION/EXTENSION SYSTEM Φ THE CITY OF RALEIGH CONSENTS TO THE CONNECTION AND EXTENSION OF TH CITY'S PUBLIC SEWER SYSTEM AS SHOWN ON THIS PLAN. THE MATERIAL AND CONSTRUCTION METHODS USED FOR THIS PROJECT SHALL CONFORM TO THE STANDARDS AND SPECIFICATIONS OF THE CITY'S PUBLIC UTILITIES HANDBOOK. С Φ CITY OF RALEIGH PUBLIC UTILITIES DEPARTMENT PERMIT # 5-4450 AUTHORIZATION TO CONSTRUCT <u>JOURS UN</u>. Scarple DATE 1/26/19 > V σ \_ S R PUBLIC WATER DISTRIBUTION/EXTENSION SYSTEM S THE CITY OF RALEIGH CONSENTS TO THE CONNECTION AND EXTENSION OF THE CITY'S PUBLIC WATER SYSTEM AS SHOWN ON THIS PLAN. THE MATERIAL AND CONSTRUCTION METHODS USED FOR THIS PROJECT SHALL CONFORM TO THE STANDARDS AND SPECIFICATIONS OF THE CITY'S PUBLIC UTILITIES HANDBOOK. Δ\_ Φ S With CITY OF RALEIGH PUBLIC UTILITIES DEPARTMENT PERMIT # W - 3574AUTHORIZATION TO CONSTRUCT ANOS 4M. Bamper Engi TOWN CERTIFICATION. THIS DESIGN HAS BEEN REVIEWED BY THE ENGINEER FOR THE TOWN OF KNIGHTDALE, AND TO THE BEST OF MY KNOWLEDGE AND BELIEF, IT CONFORMS TO THE REQUIREMENTS ESTABLISHED IN THE STANDARD SPECIFICATIONS OF THE TOWN OF KNIGHTDALE. BY: \_\_\_\_\_\_DATE: \_\_\_\_\_A-31-2018 DEVELOPMENT SERVICES ENGINEER 47 STATION D R4 KNIGHTDALE S R6D AND I ш KNIGH 1 inch = 50 ft. SCALE: 1" = 50' HORIZ. 1" = 5' VERT. WATERLINE NOTE: ш IF MINIMUM CLEARANCE CANNOT BE ACHIEVED WITHOUT E RIV EXCEEDING MAXIMUM PIPE DEFLECTION FOR THE WATERLINE, THEN CONTRACTOR TO INSTALL 45' VERTICAL BENDS PER COR DETAIL W-12. \_ CLASS 1 STRUCTURAL MATERIAL NOTE: SI CLASS 1 STRUCTURAL MATERIAL REQUIRED FROM PRESS PROI EXISTING GROUND TO SPRING LINE OF PROPOSED STORM PIPE IN FILL CONDITIONS.SEE LATEST TOK STANDARD SPECIFICATIONS. ð × CITY OF RALEIGH шz ALL CONSTRUCTION MUST BE IN ACCORDANCE WITH ALL LOCAL, STATE, AND FEDERAL RULES AND REGULATIONS. RIENT TRANSPORTATION SERVICES N/A PUBLIC UTILITIES 0 STORMWATER N/A PLANNING N/A FIRE N/A rawn By 02090251.6 W&R Designer 06/08/2018 W&R URBAN FORESTRY N/A CAR ATTENTION CONTRACTORS FESSIO THE CONSTRUCTION CONTRACTOR RESPONSIBLE FOR THE EXTENSION OF WATER AND SEWER, AS APPROVED IN THESE PLANS, IS RESPONSIBLE FOR <u>CONTACTING</u> THE PUBLIC UTILITIES DEPARTMENT AT <u>(919)</u> 996–4540 AT LEAST 24 HOURS SEAL 38549 PRIOR TO BEGINNING ANY CONSTRUCTION. \*NGINEE2. FAILURE TO NOTIFY BOTH CITY DEPARTMENTS IN ADVANCE OF BEGINNING CONSTRUCTION WILL RESULT IN THE ISSUANCE OF MONETARY FINES AND REQUIRE REINSTALLATION OF ANY WATER OR SEWER FACILITIES NOT INSPECTED AS A RESULT OF THIS NOTIFICATION FAILURE. 08 3111 FAILURE TO CALL FOR INSPECTION, INSTALL A DOWNSTREAM PLUG, HAVE PERMITTED PLANS ON THE JOB SITE, OR ANY OTHER VIOLATION OF CITY OF RALEIGH STANDARDS WILL RESULT IN A <u>FINE AND POSSIBLE EXCLUSION</u> FROM FUTURE WORK IN THE CITY OF RALEIGH. 1st TOK Comments 08/31/18 Sheet No. 7.3

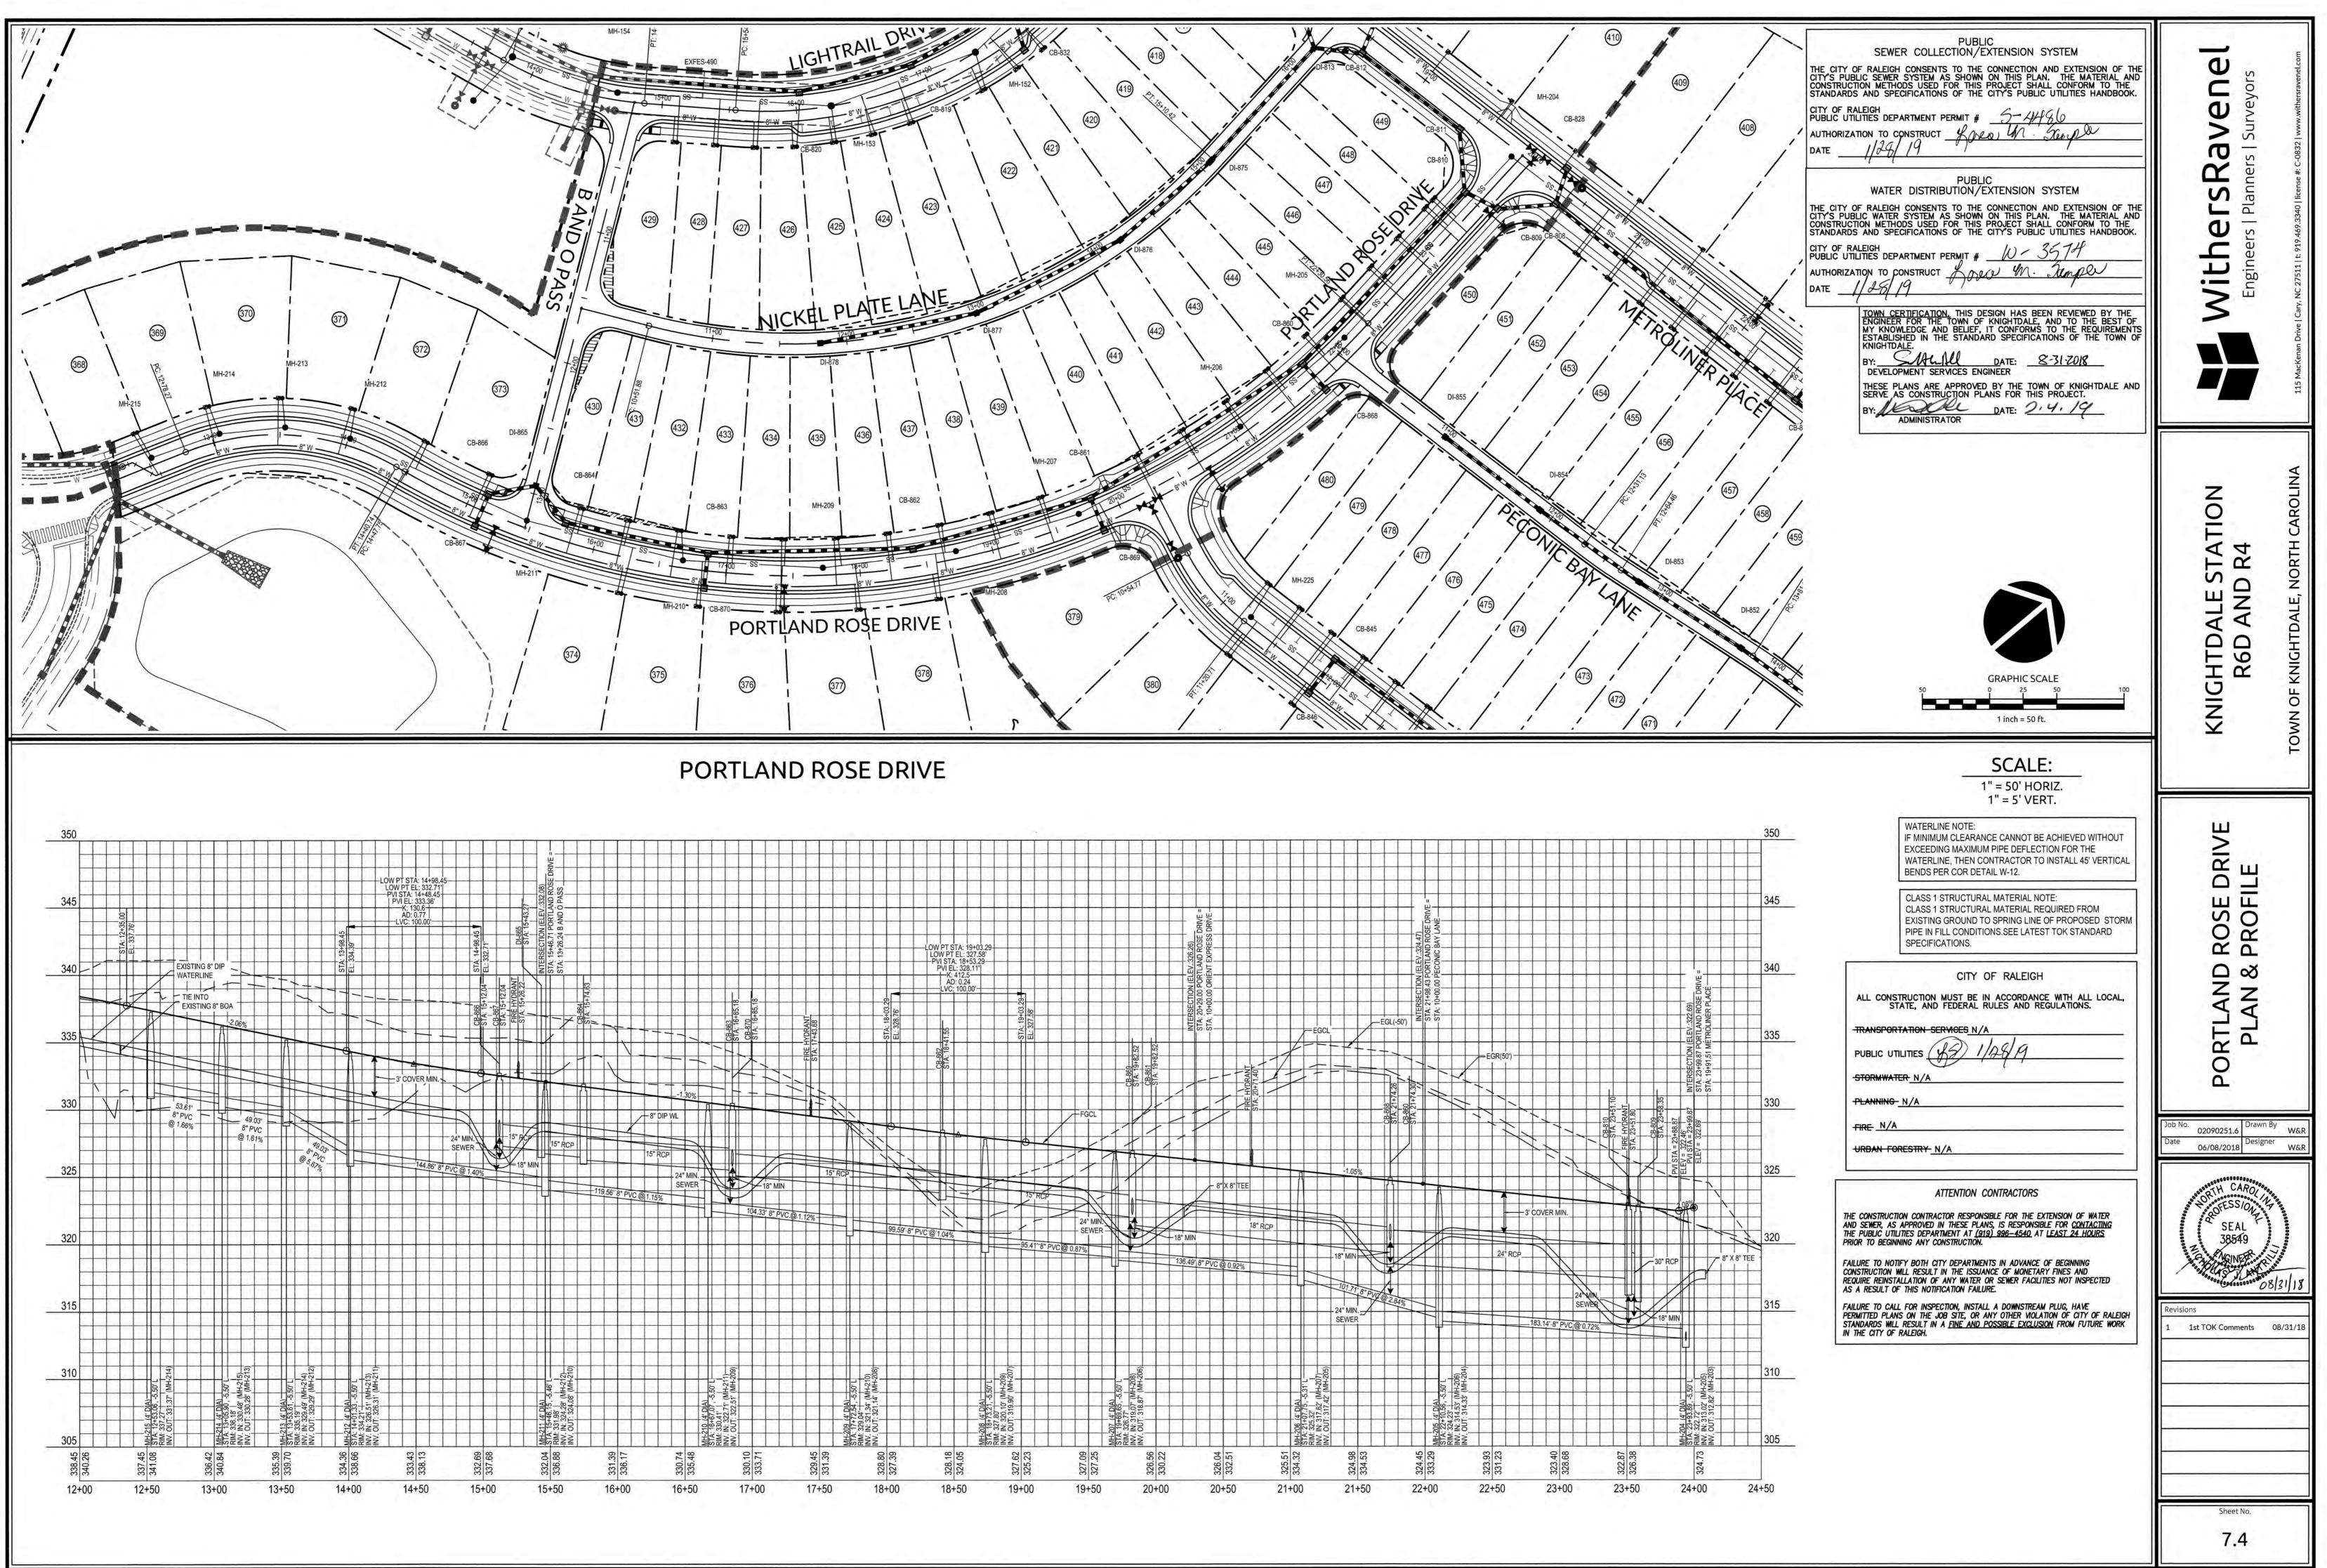


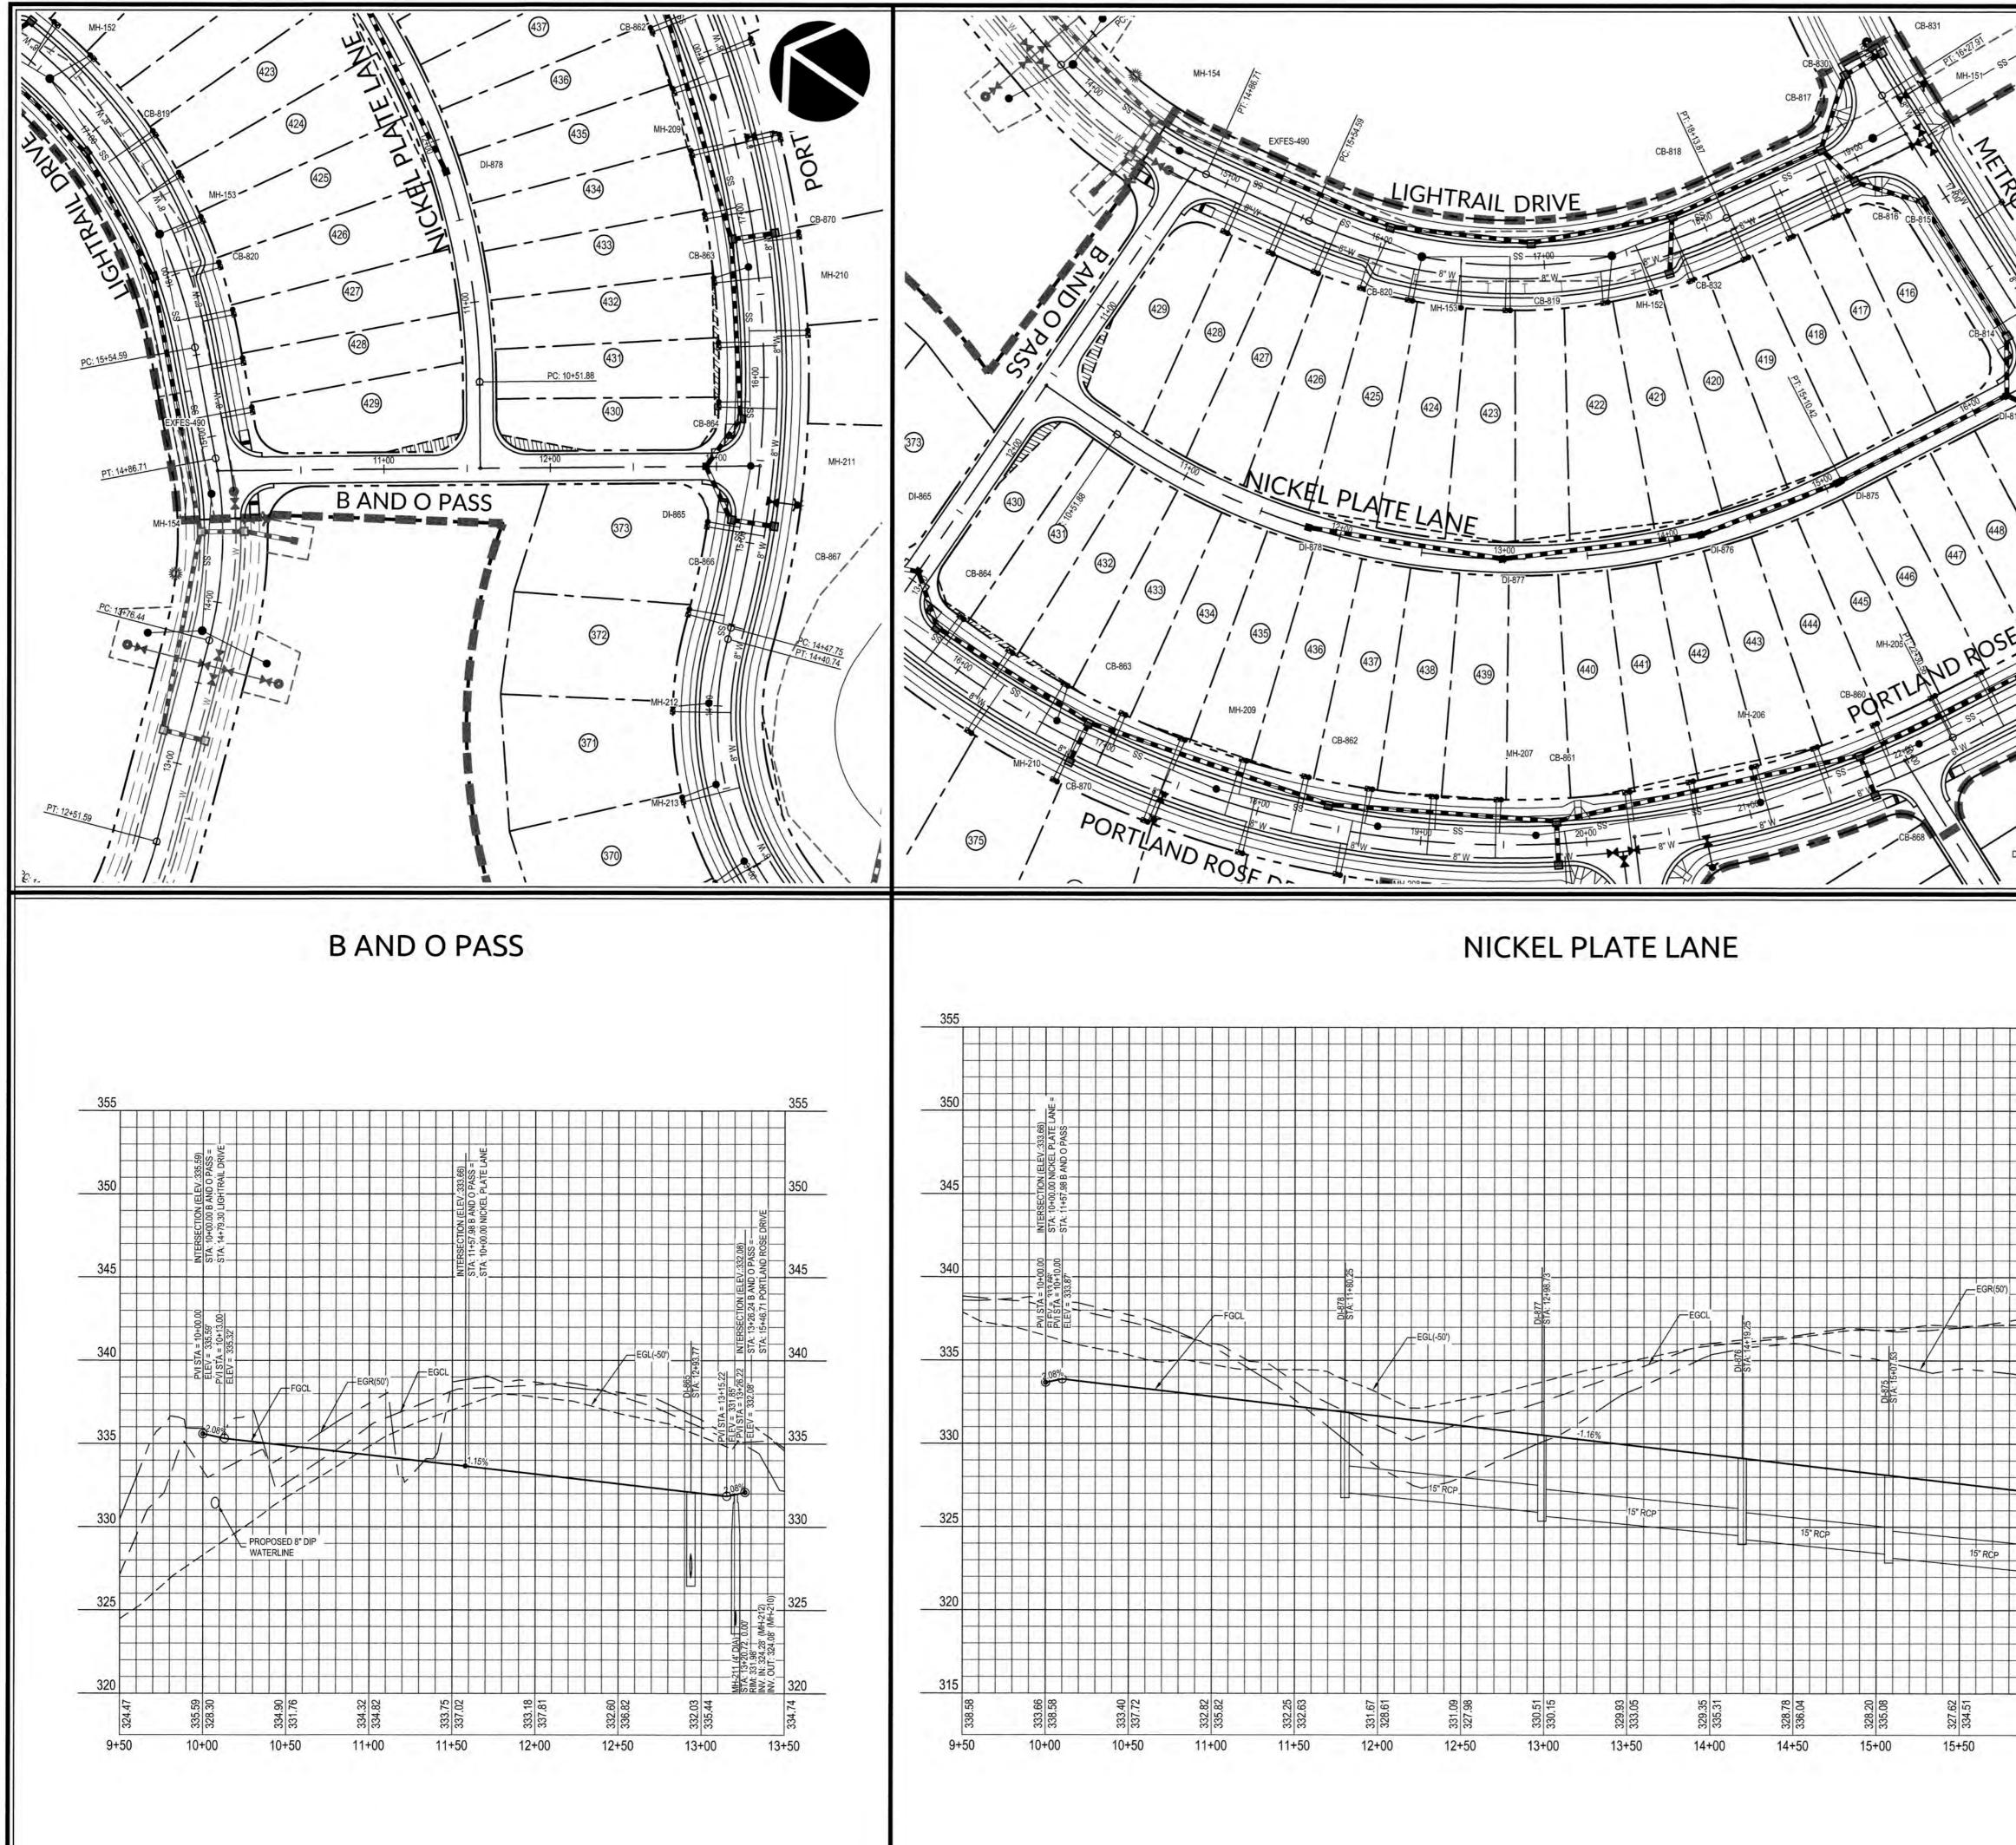



PUBLIC SEWER COLLECTION/EXTENSION SYSTEM \_ venel THE CITY OF RALEIGH CONSENTS TO THE CONNECTION AND EXTENSION OF THE CITY'S PUBLIC SEWER SYSTEM AS SHOWN ON THIS PLAN. THE MATERIAL AND CONSTRUCTION METHODS USED FOR THIS PROJECT SHALL CONFORM TO THE STANDARDS AND SPECIFICATIONS OF THE CITY'S PUBLIC UTILITIES HANDBOOK. 0 CITY OF RALEIGH PUBLIC UTILITIES DEPARTMENT PERMIT # 5-44-150 Ve AUTHORIZATION TO CONSTRUCT Acres M. Sample Su σ \_ (414) ROLINER S R PUBLIC WATER DISTRIBUTION/EXTENSION SYSTEM S P THE CITY OF RALEIGH CONSENTS TO THE CONNECTION AND EXTENSION OF THE CITY'S PUBLIC WATER SYSTEM AS SHOWN ON THIS PLAN. THE MATERIAL AND CONSTRUCTION METHODS USED FOR THIS PROJECT SHALL CONFORM TO THE STANDARDS AND SPECIFICATIONS OF THE CITY'S PUBLIC UTILITIES HANDBOOK. Ы (413) Φ -----S With CITY OF RALEIGH PUBLIC UTILITIES DEPARTMENT PERMIT # W - 3574AUTHORIZATION TO CONSTRUCT & Mar UN. Semples Engin DATE TOWN CERTIFICATION, THIS DESIGN HAS BEEN REVIEWED BY THE ENGINEER FOR THE TOWN OF KNIGHTDALE, AND TO THE BEST OF MY KNOWLEDGE AND BELIEF, IT CONFORMS TO THE REQUIREMENTS ESTABLISHED IN THE STANDARD SPECIFICATIONS OF THE TOWN OF KNIGHTDALE. BY: Supple Date: 8-31-2018 DEVELOPMENT SERVICES ENGINEER (449) R4 LE S A 00 HT R6 **GRAPHIC SCALE** KNIG DI-855 453 1 inch = 50 ft. SCALE: 1" = 50' HORIZ. 1" = 5' VERT. 111 WATERLINE NOTE: Y 355 IF MINIMUM CLEARANCE CANNOT BE ACHIEVED WITHOUT Ū ⊗ EXCEEDING MAXIMUM PIPE DEFLECTION FOR THE WATERLINE, THEN CONTRACTOR TO INSTALL 45' VERTICAL z z BENDS PER COR DETAIL W-12. P 0 CLASS 1 STRUCTURAL MATERIAL NOTE: S ANI VE PL FILE CLASS 1 STRUCTURAL MATERIAL REQUIRED FROM EXISTING GROUND TO SPRING LINE OF PROPOSED STORM PIPE IN FILL CONDITIONS.SEE LATEST TOK STANDARD SPECIFICATIONS. LANI 345 CITY OF RALEIGH ЧШч Δ ALL CONSTRUCTION MUST BE IN ACCORDANCE WITH ALL LOCAL, STATE, AND FEDERAL RULES AND REGULATIONS. OF TRANSPORTATION SERVICES N/A 340 PUBLIC UTILITIES Zd 1 STORMWATER N/A 4 Β PLANNING N/A 335 FIRE N/A Drawn By 02090251.6 06/08/2018 Designer W&R URBAN FORESTRY N/A TH CARO ATTENTION CONTRACTORS FESS/01 . THE CONSTRUCTION CONTRACTOR RESPONSIBLE FOR THE EXTENSION OF WATER AND SEWER, AS APPROVED IN THESE PLANS, IS RESPONSIBLE FOR <u>CONTACTING</u> THE PUBLIC UTILITIES DEPARTMENT AT (919) 996-4540 AT LEAST 24 HOURS SEAL 38549 PRIOR TO BEGINNING ANY CONSTRUCTION. 325 FAILURE TO NOTIFY BOTH CITY DEPARTMENTS IN ADVANCE OF BEGINNING CONSTRUCTION WILL RESULT IN THE ISSUANCE OF MONETARY FINES AND REQUIRE REINSTALLATION OF ANY WATER OR SEWER FACILITIES NOT INSPECTED 08/31/18 AS A RESULT OF THIS NOTIFICATION FAILURE. FAILURE TO CALL FOR INSPECTION, INSTALL A DOWNSTREAM PLUG, HAVE PERMITTED PLANS ON THE JOB SITE, OR ANY OTHER VIOLATION OF CITY OF RALEIGH sions STANDARDS WILL RESULT IN A FINE AND POSSIBLE EXCLUSION FROM FUTURE WORK 1st TOK Comments 08/31/18 IN THE CITY OF RALEIGH. 327.04 326.68 16+50 17+00 16+00 Sheet No 7.5

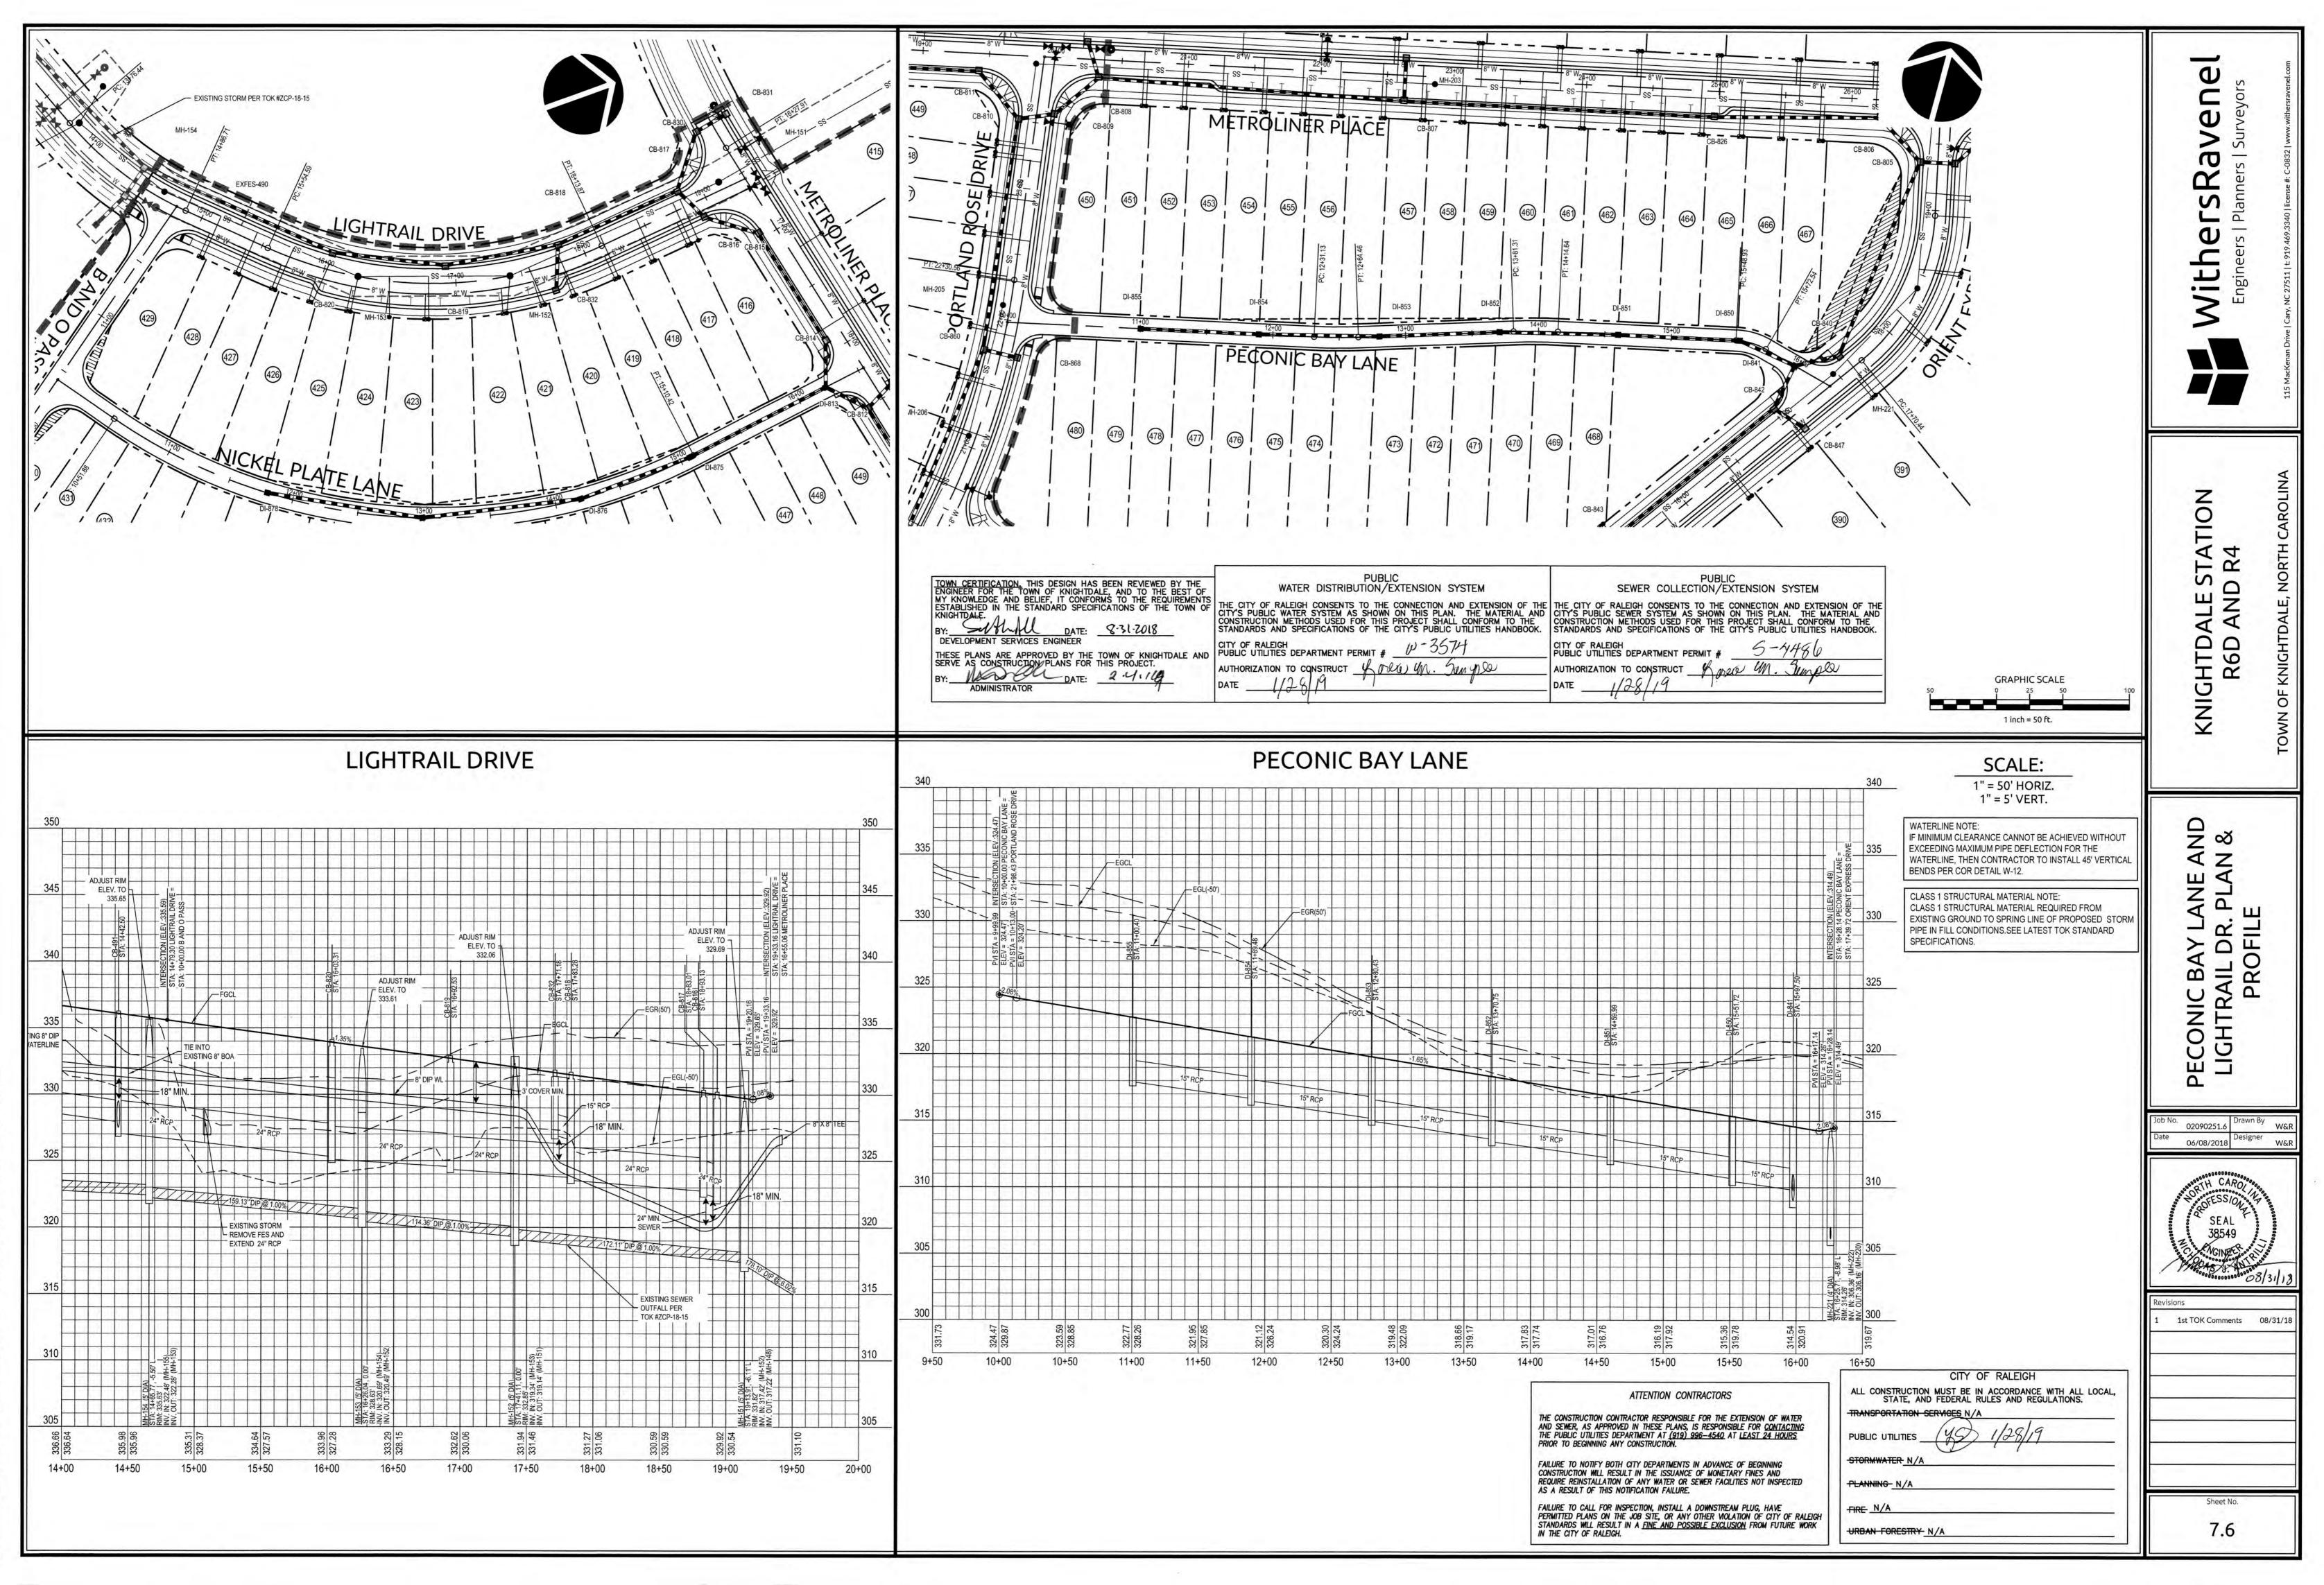


(09/09-0250/090251.6-Knightdale Station Phase R4\CAD\MASTER-CONSTRUCTION DRAWINGS\7.1-7.8 PLAN AND PROFILES.dwg-Thursday, August 30, 2018 9:11:51 PM - DURYEA, COLLEEN

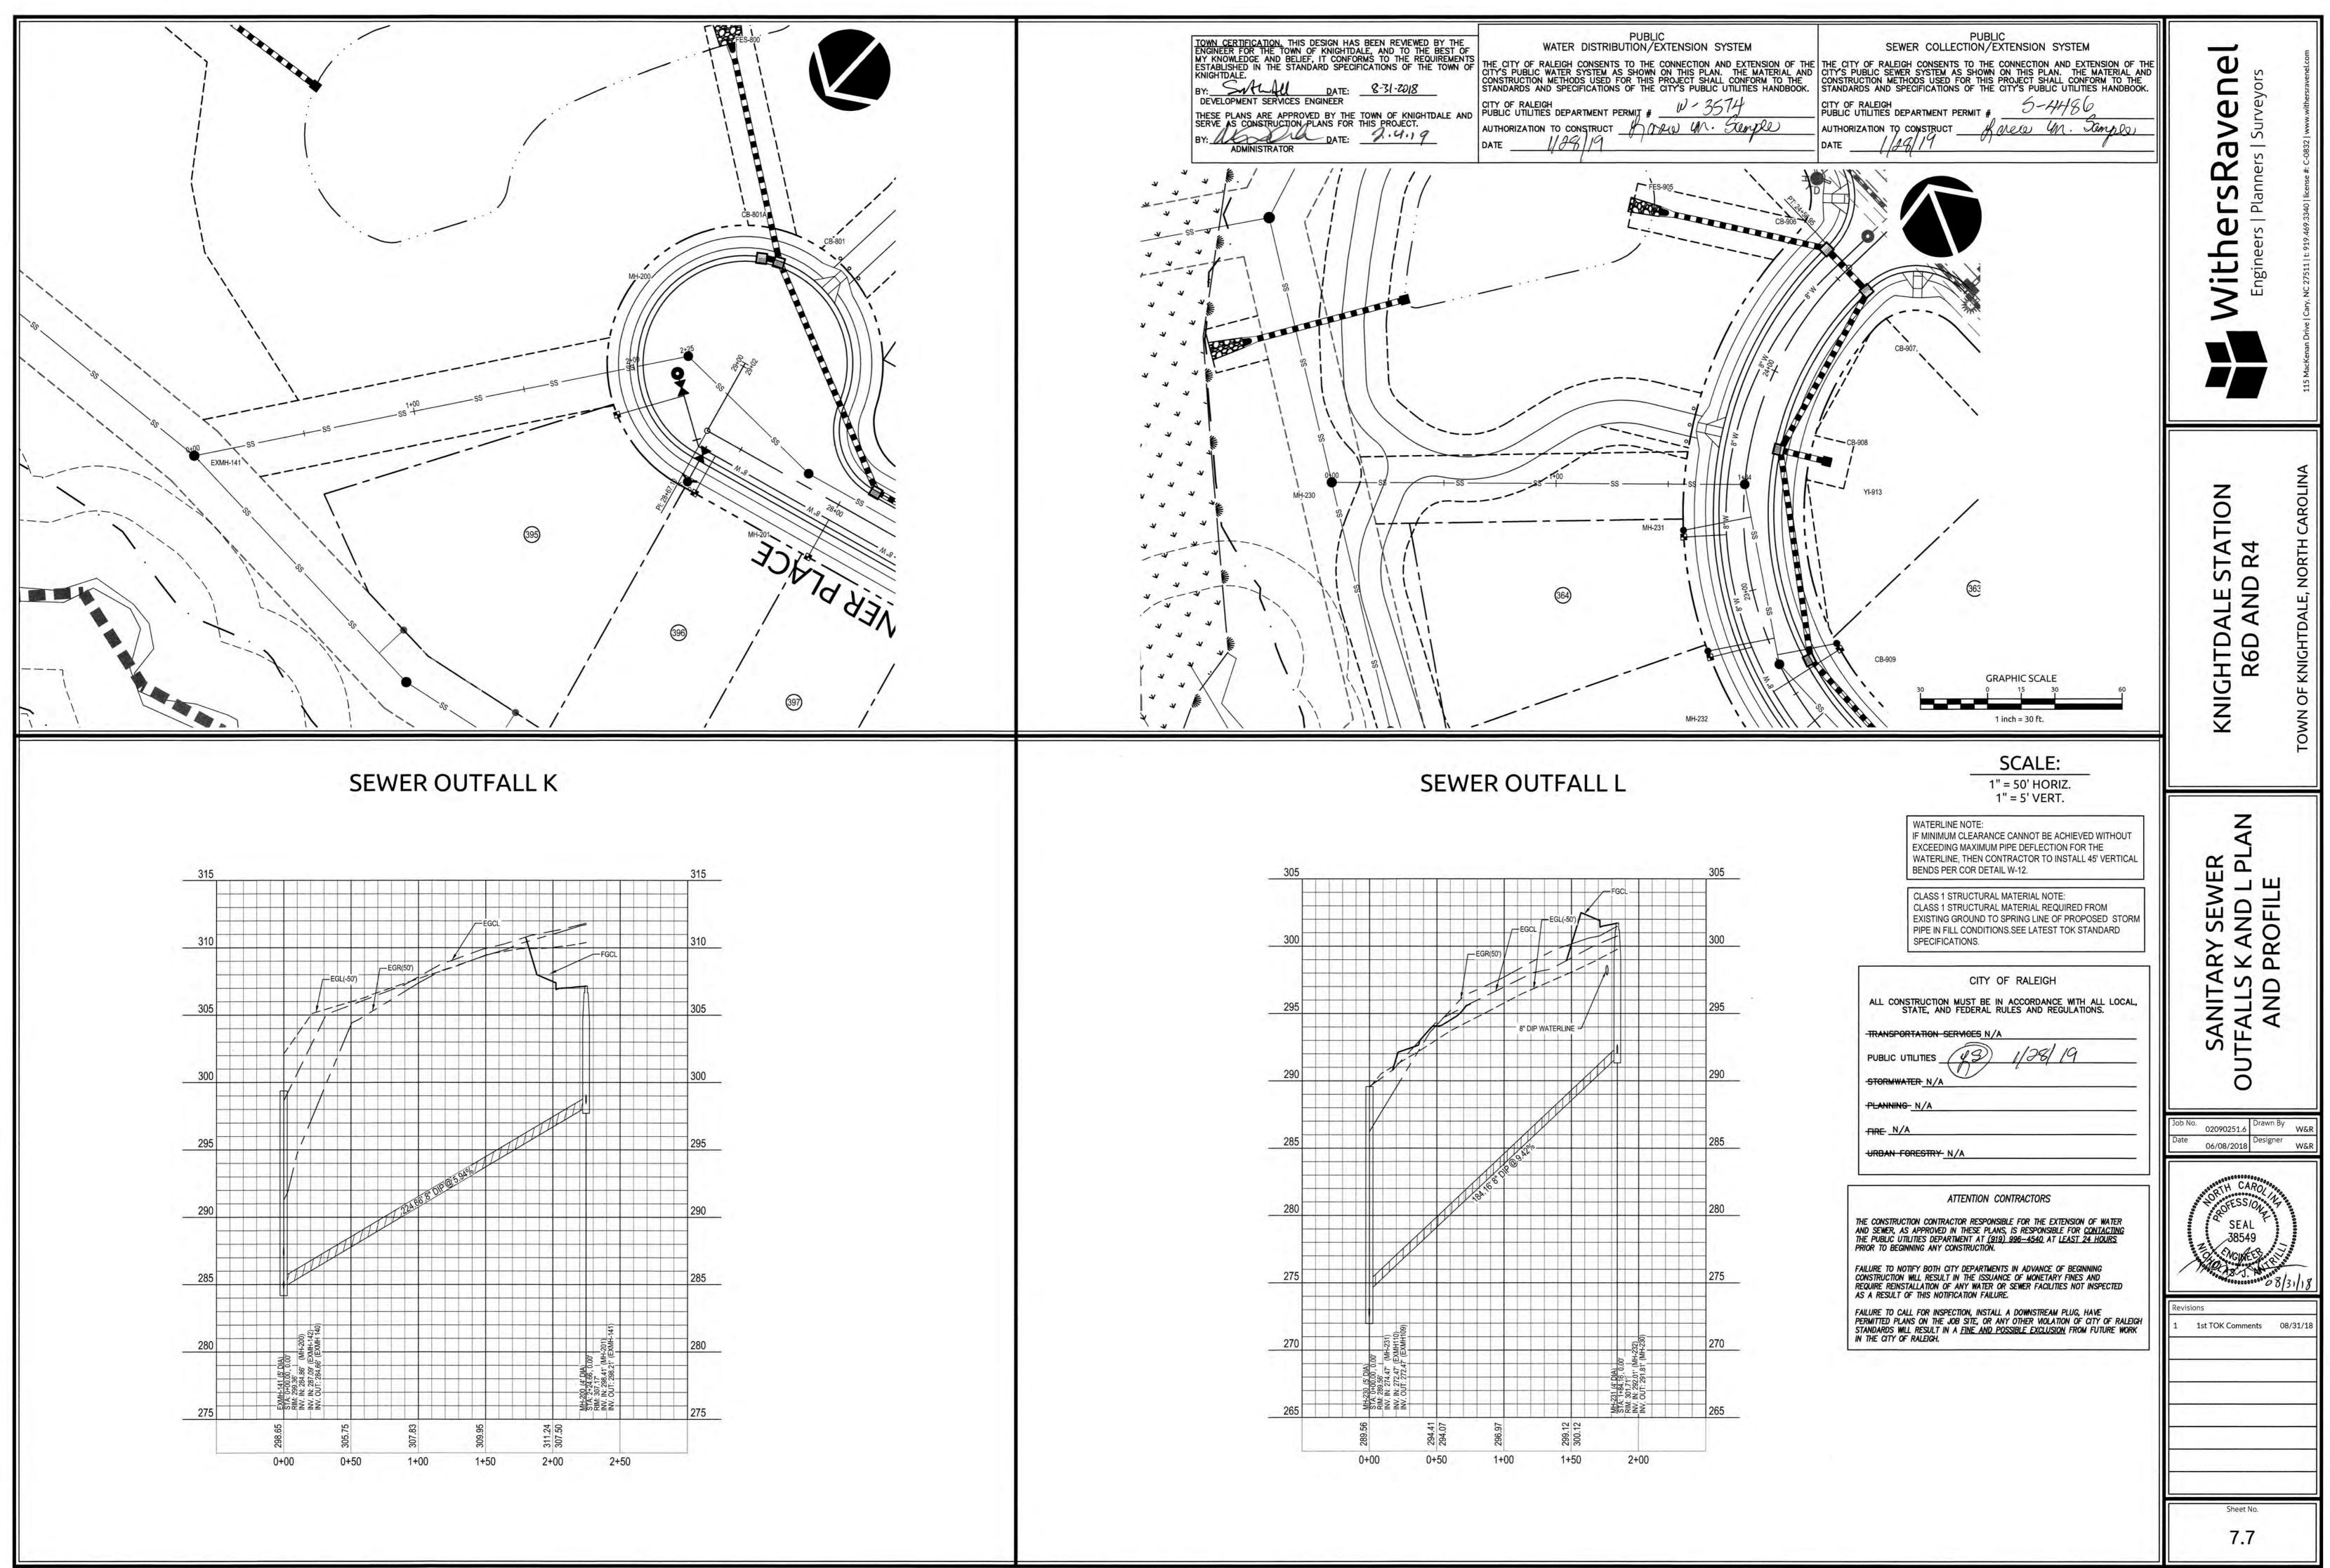


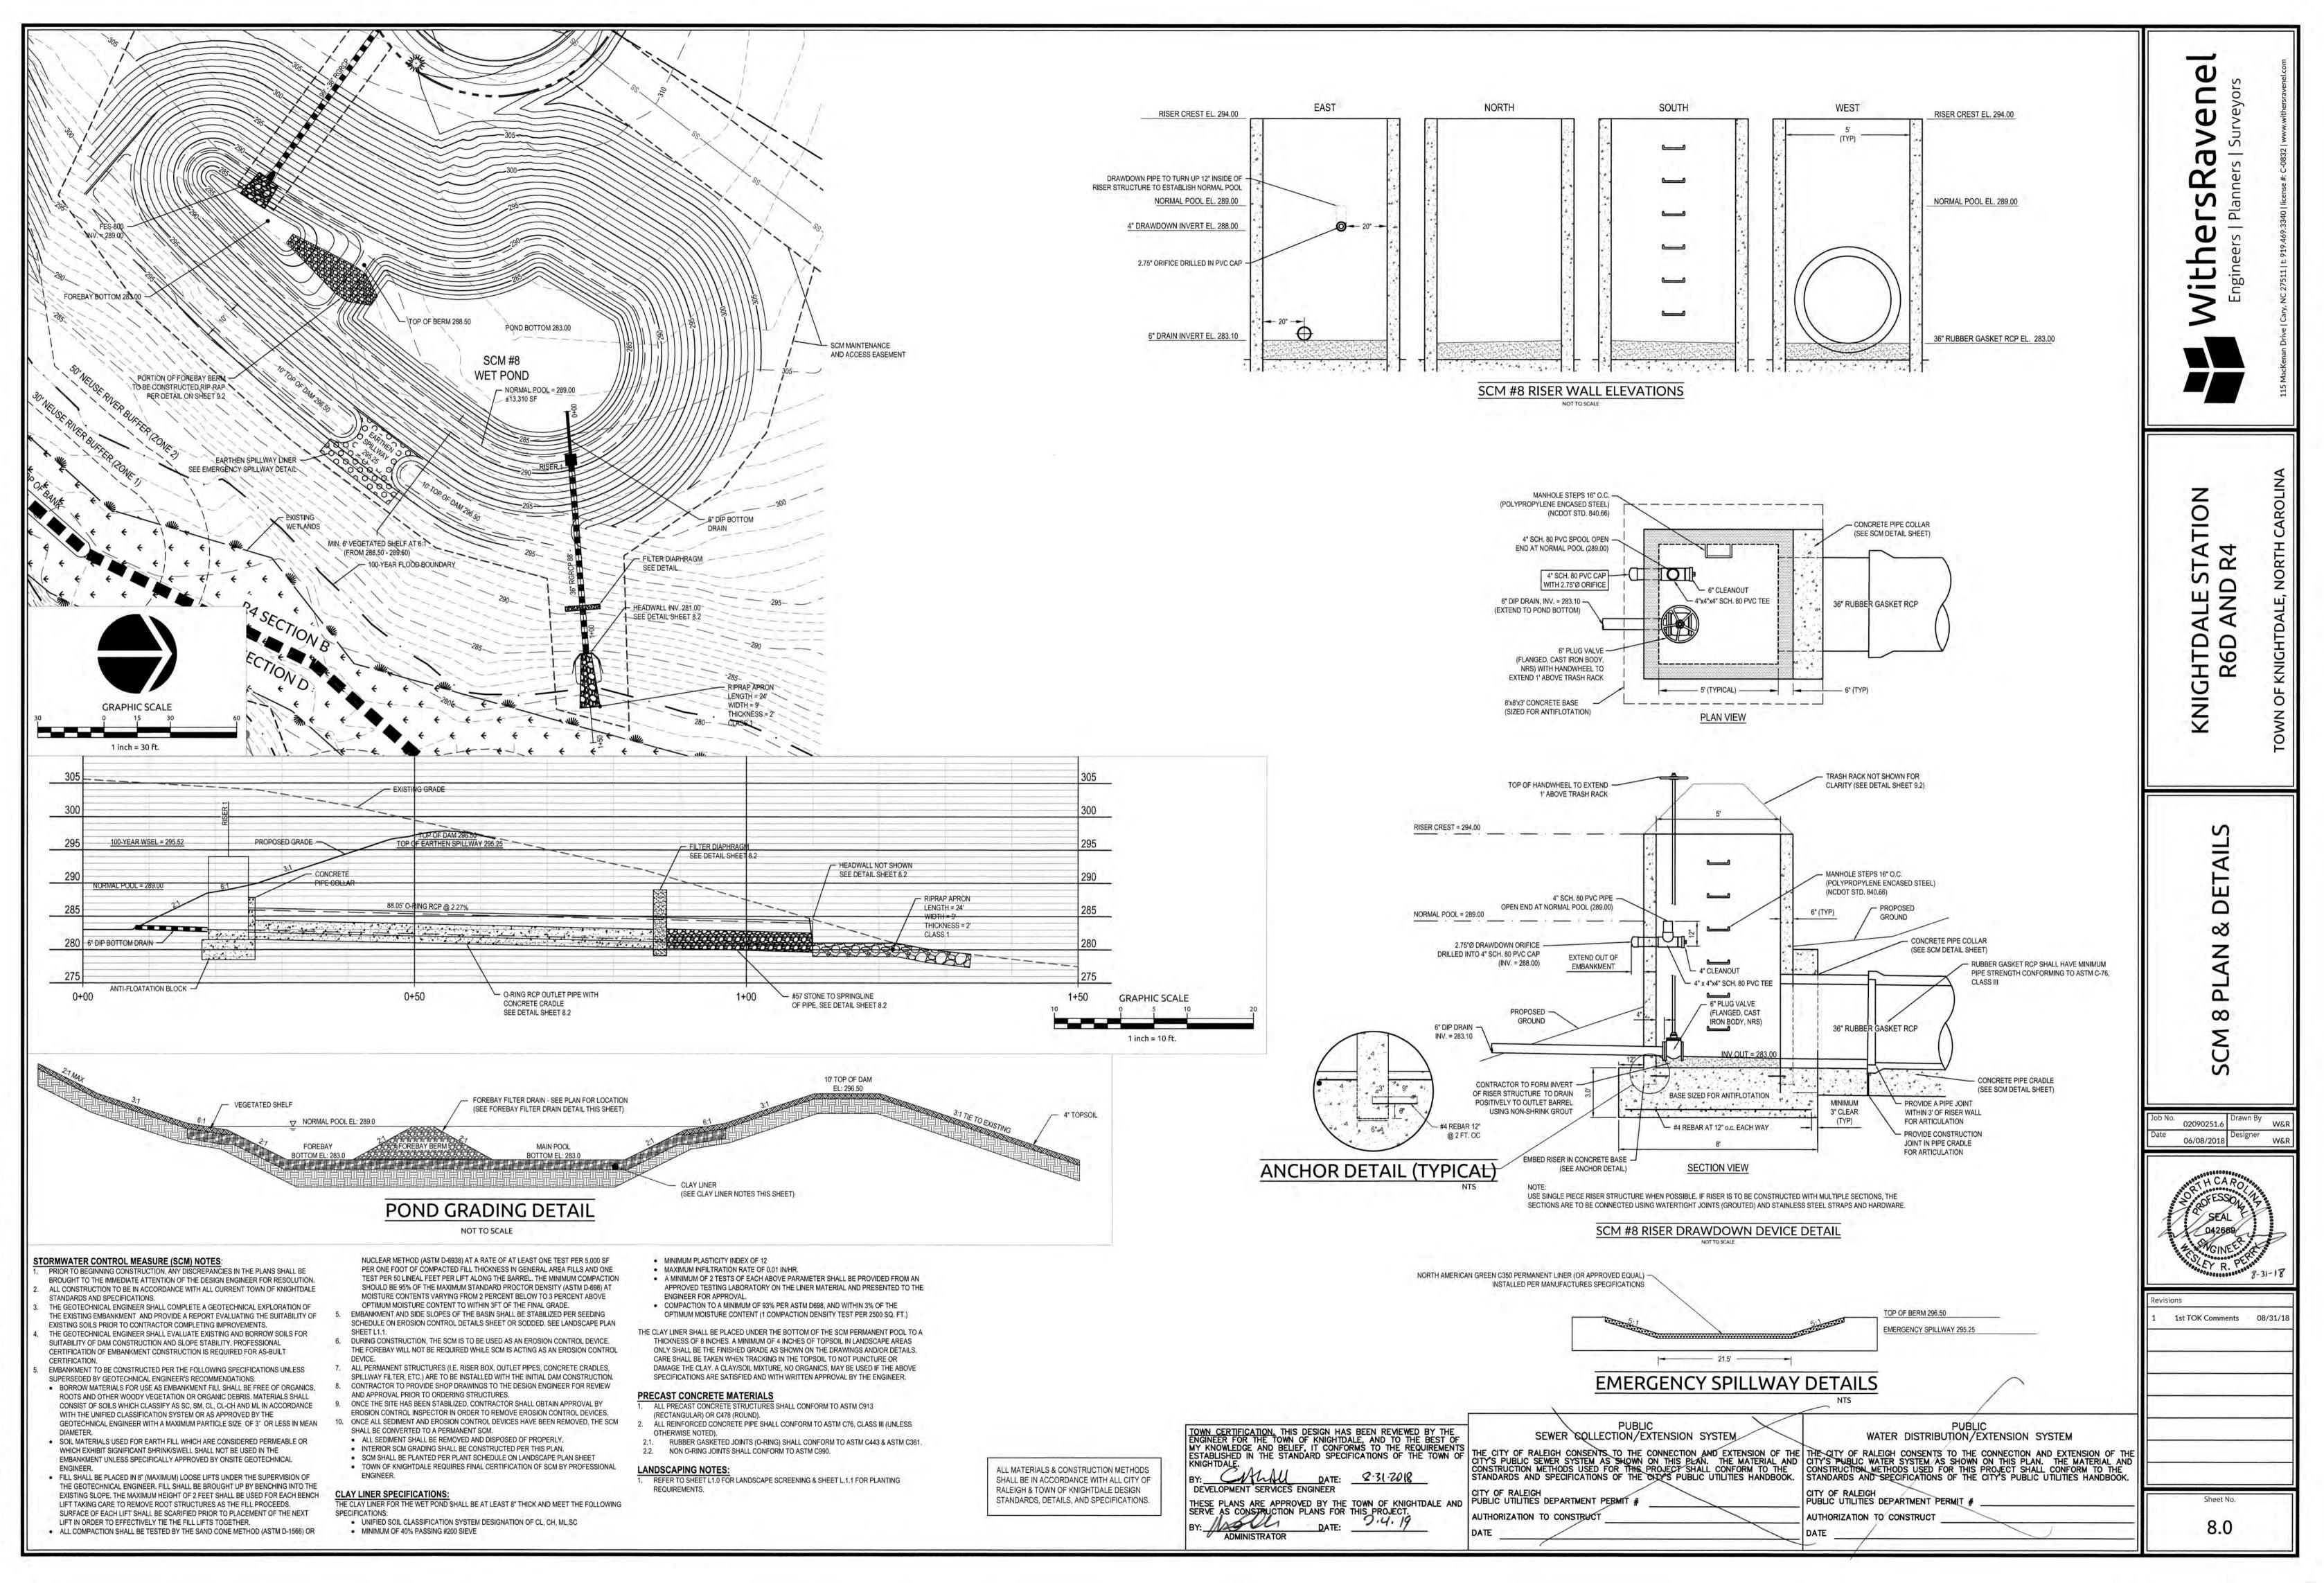


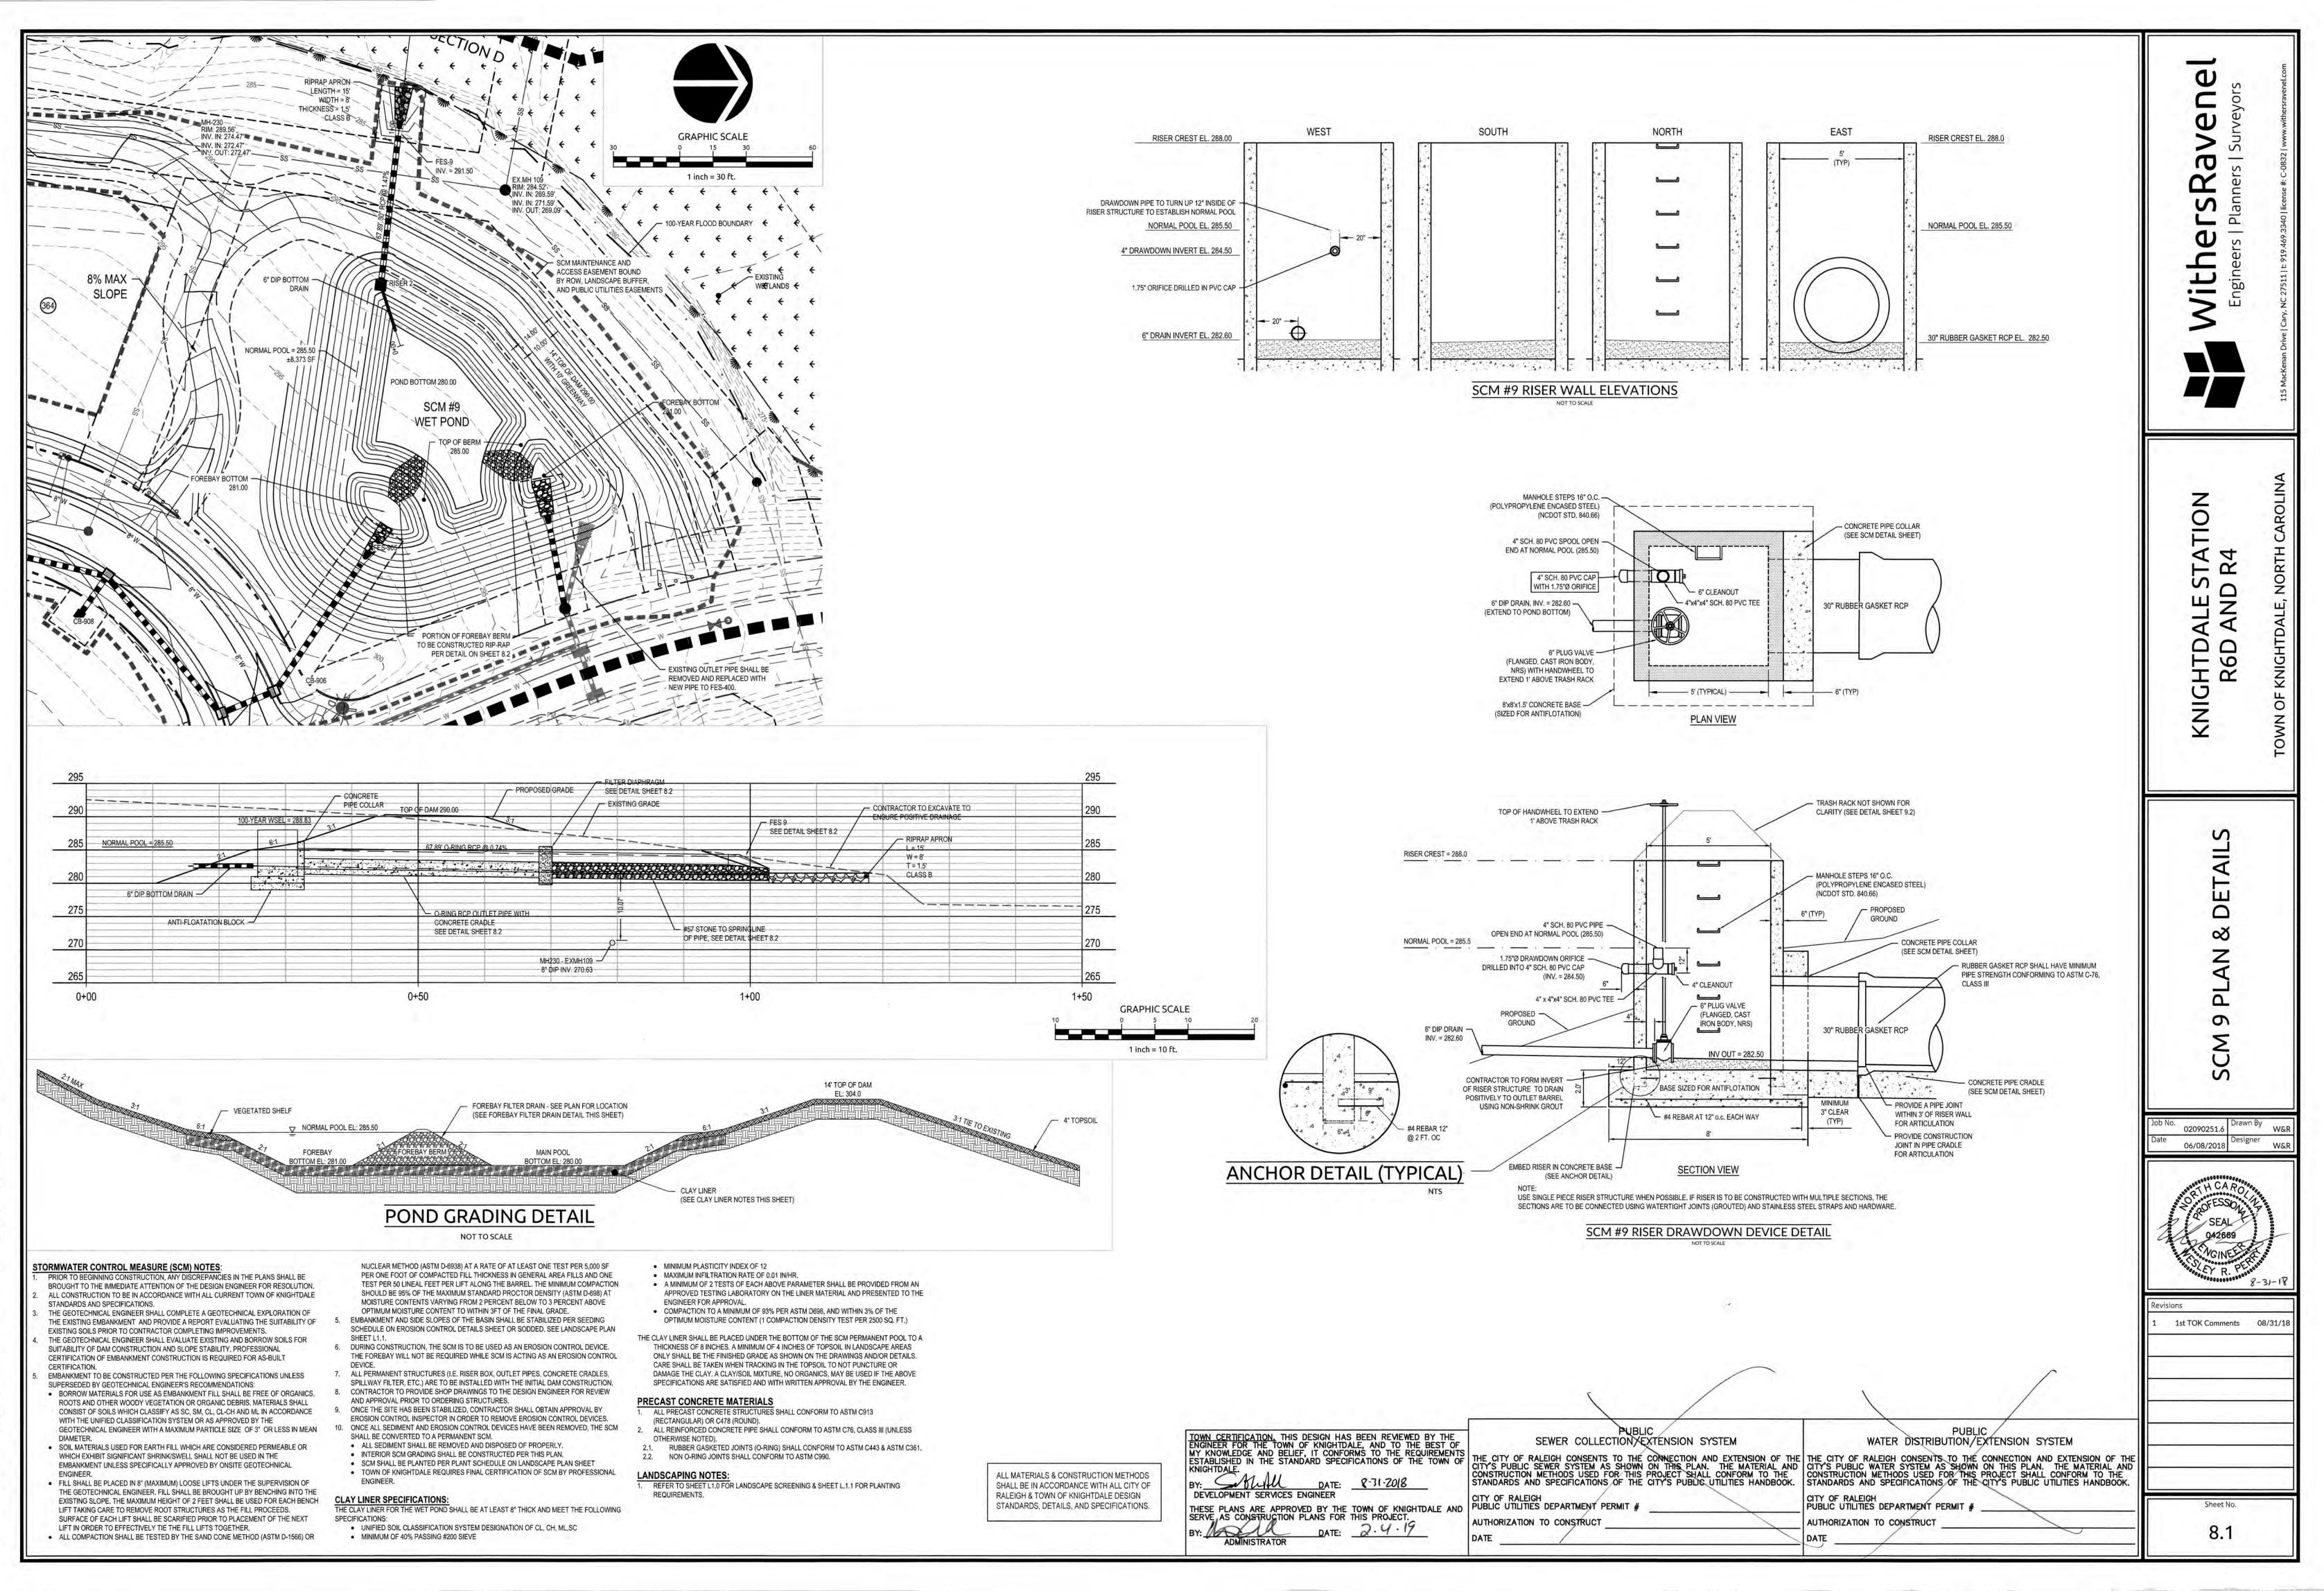


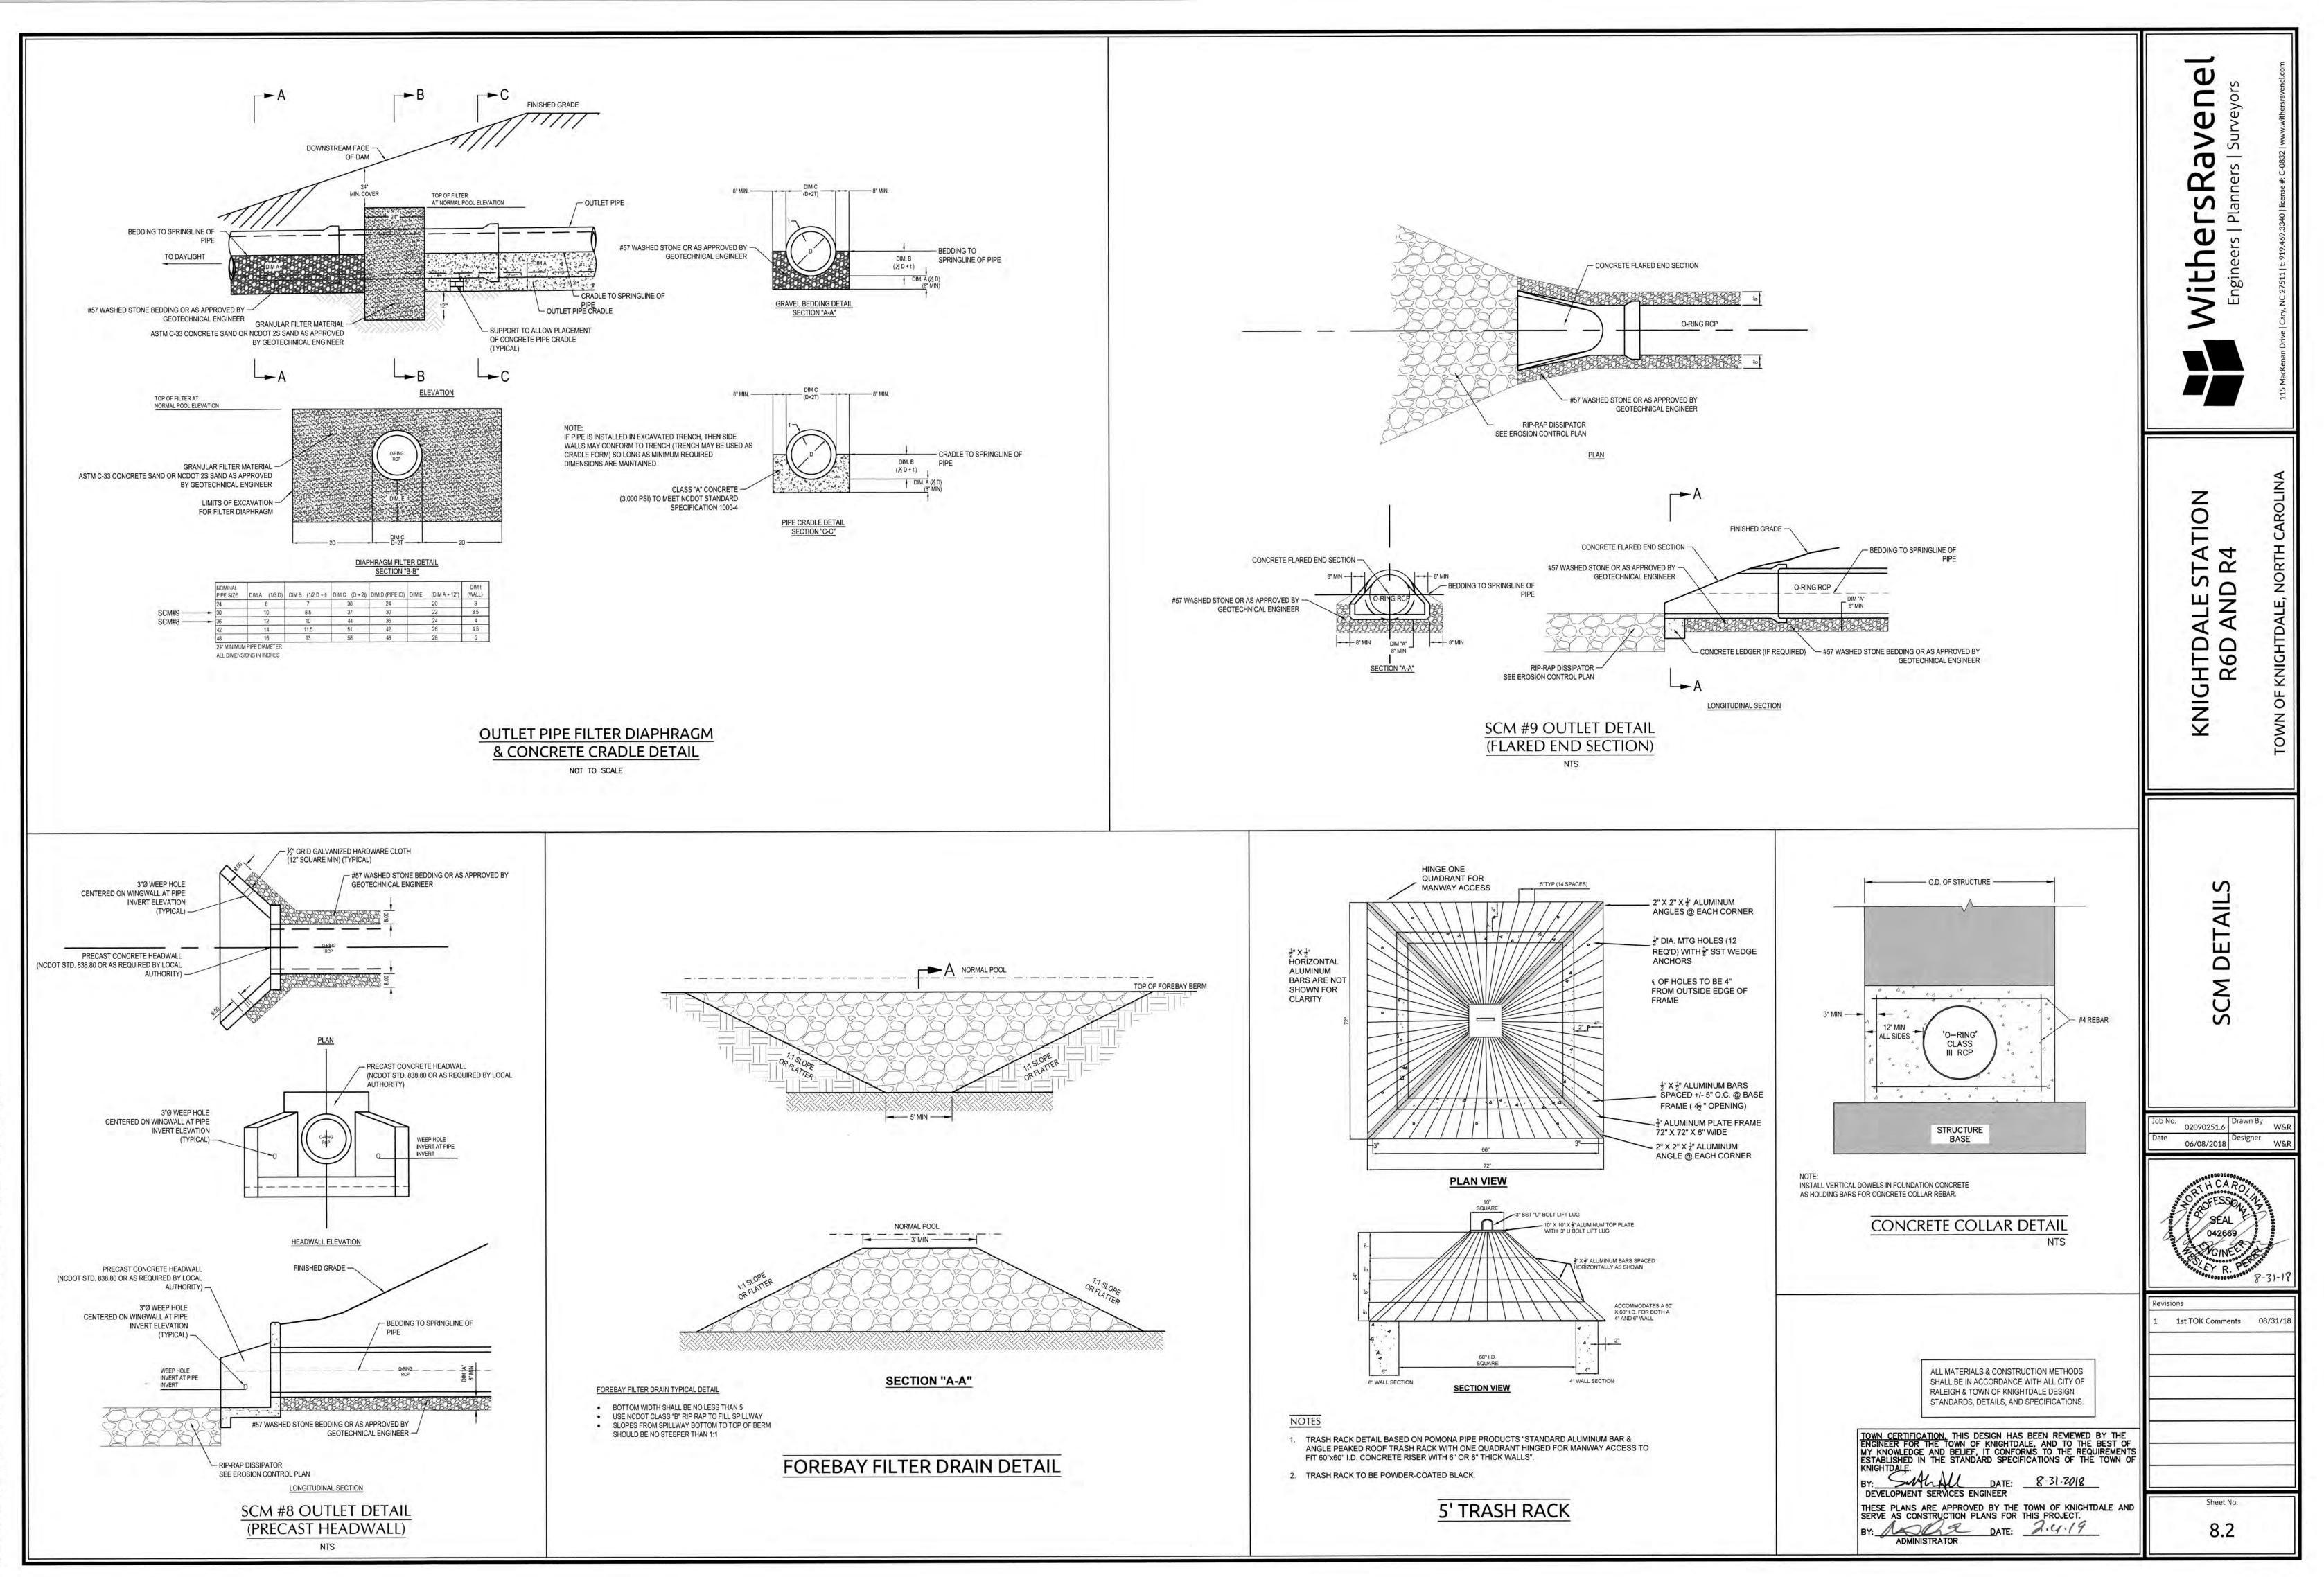



9/09-0250/090251.6-Knightdale Station Phase R4/CAD\MASTER-CONSTRUCTION DRAWINGS\8.0-8.2 SCM PLAN & DETAILS.dwg-Thursday, August 30, 2018 9:13:45 PM - DURYEA, COLLI

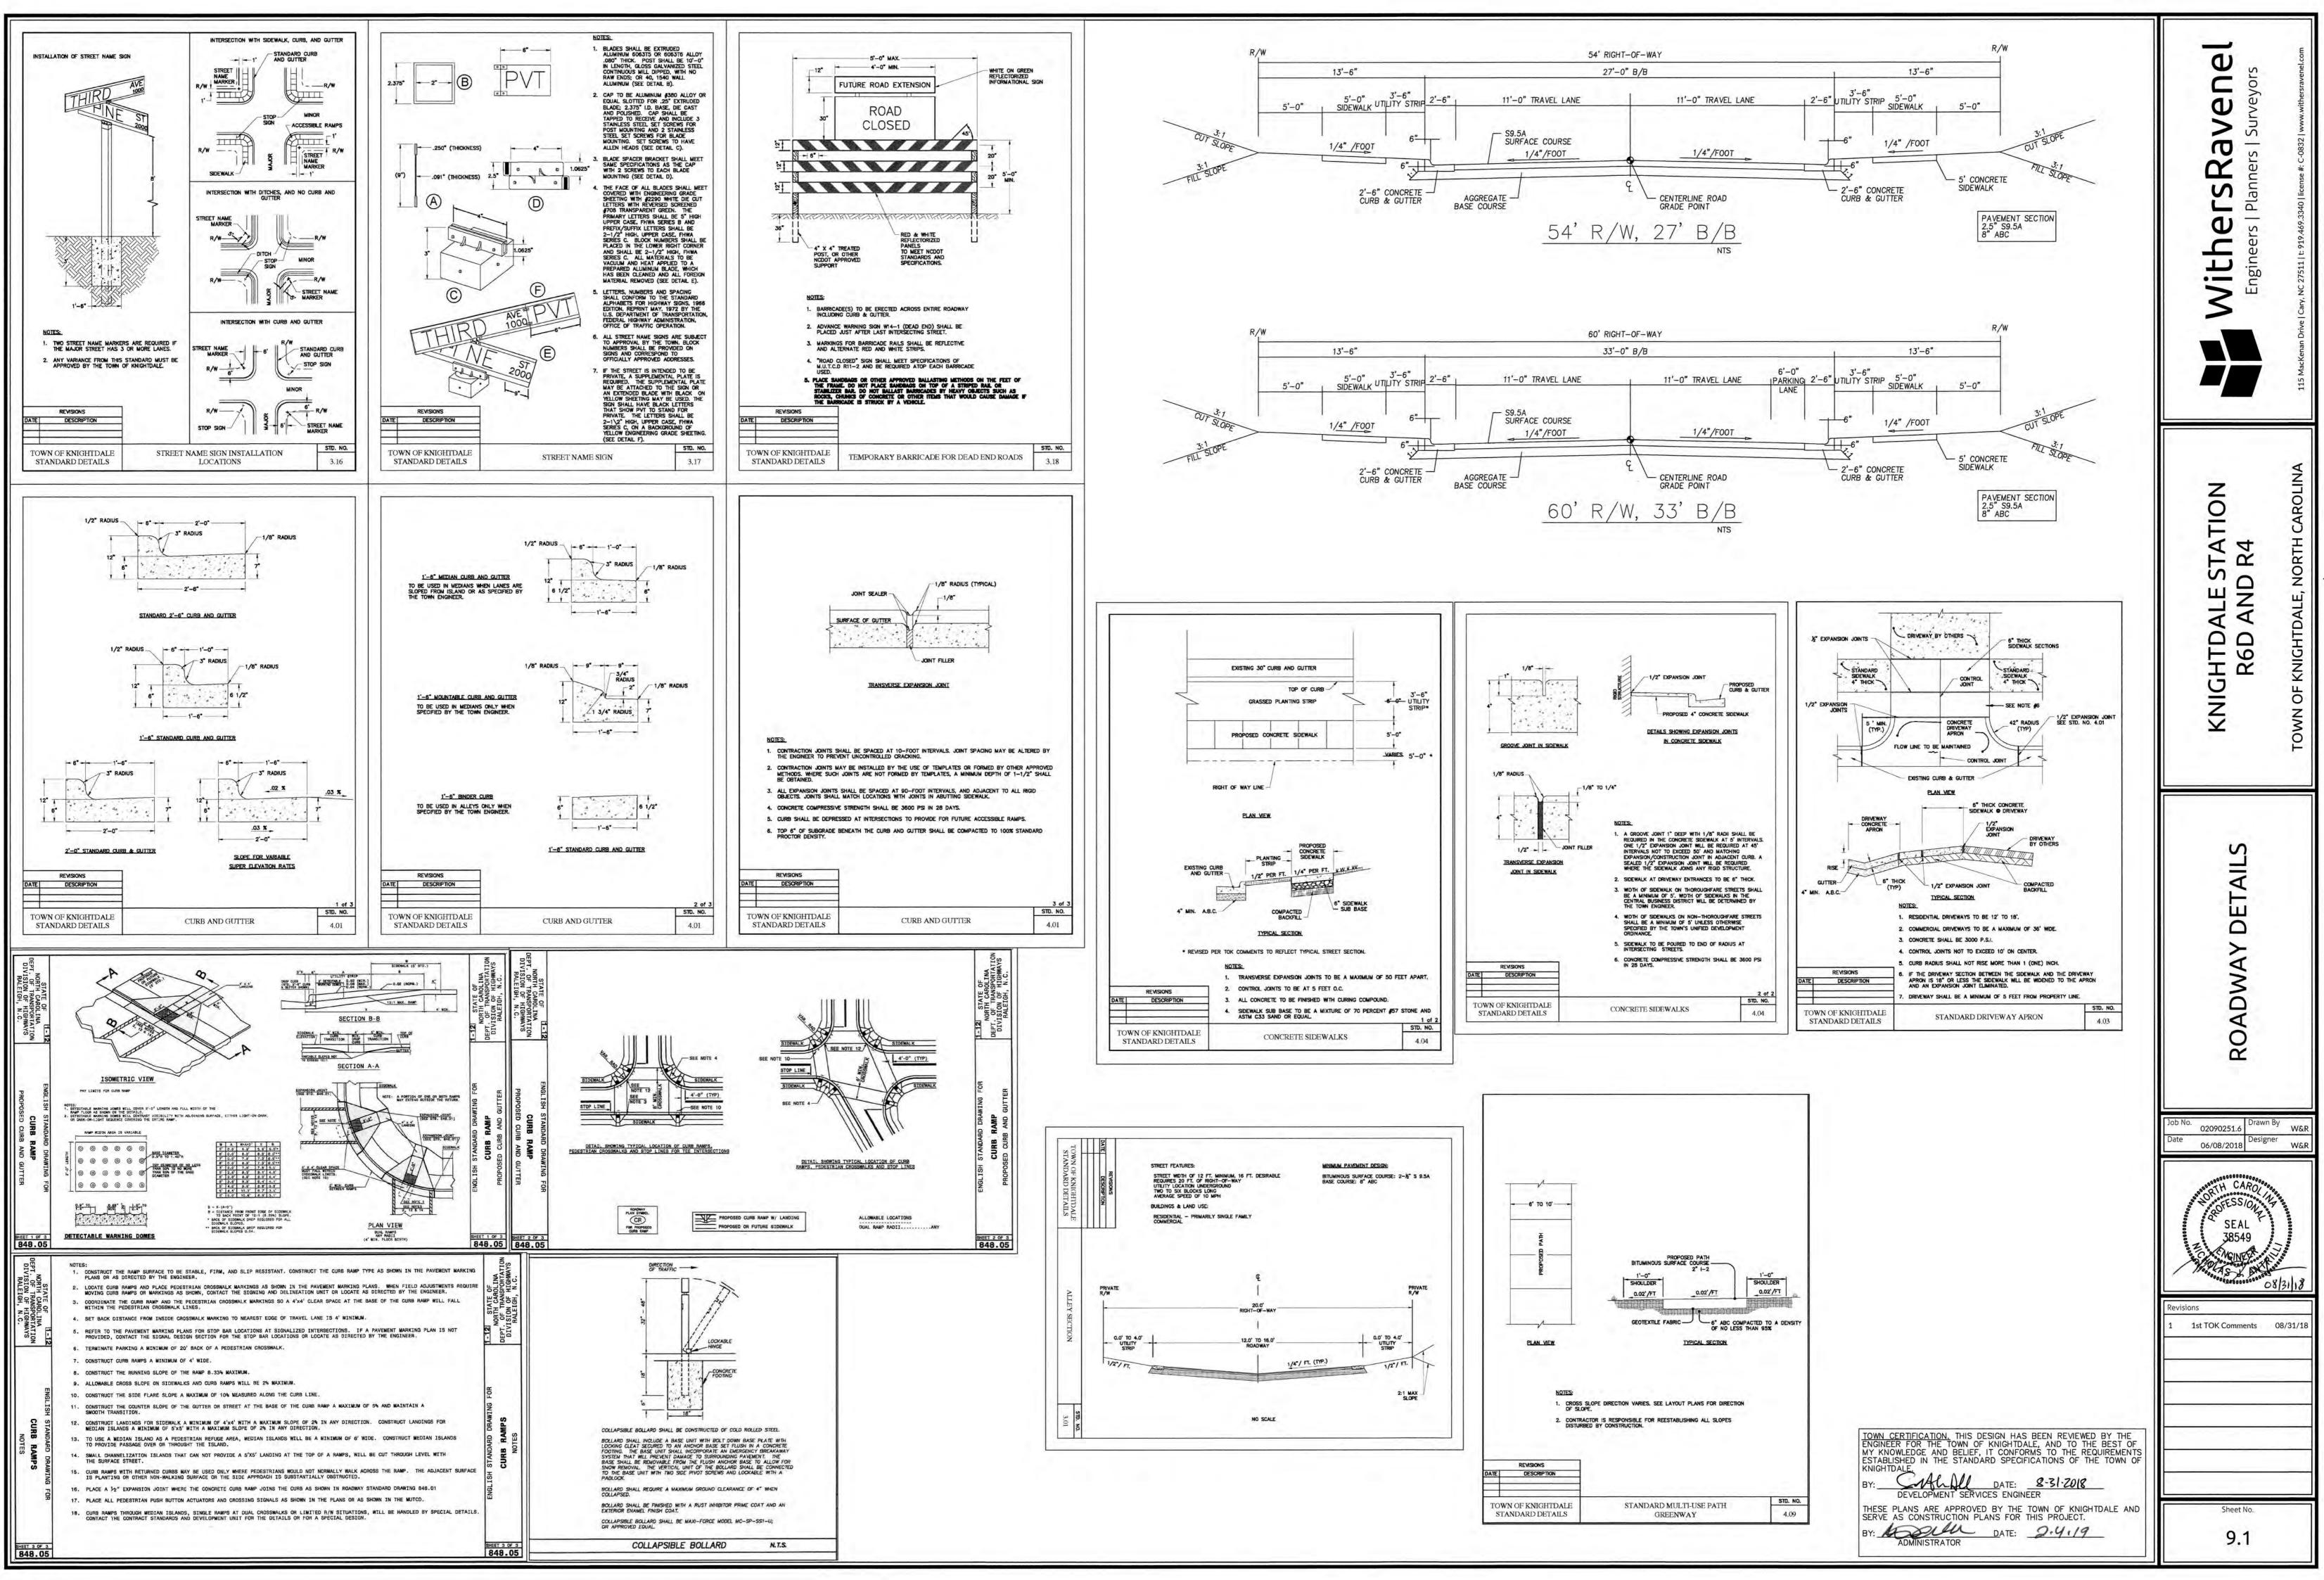

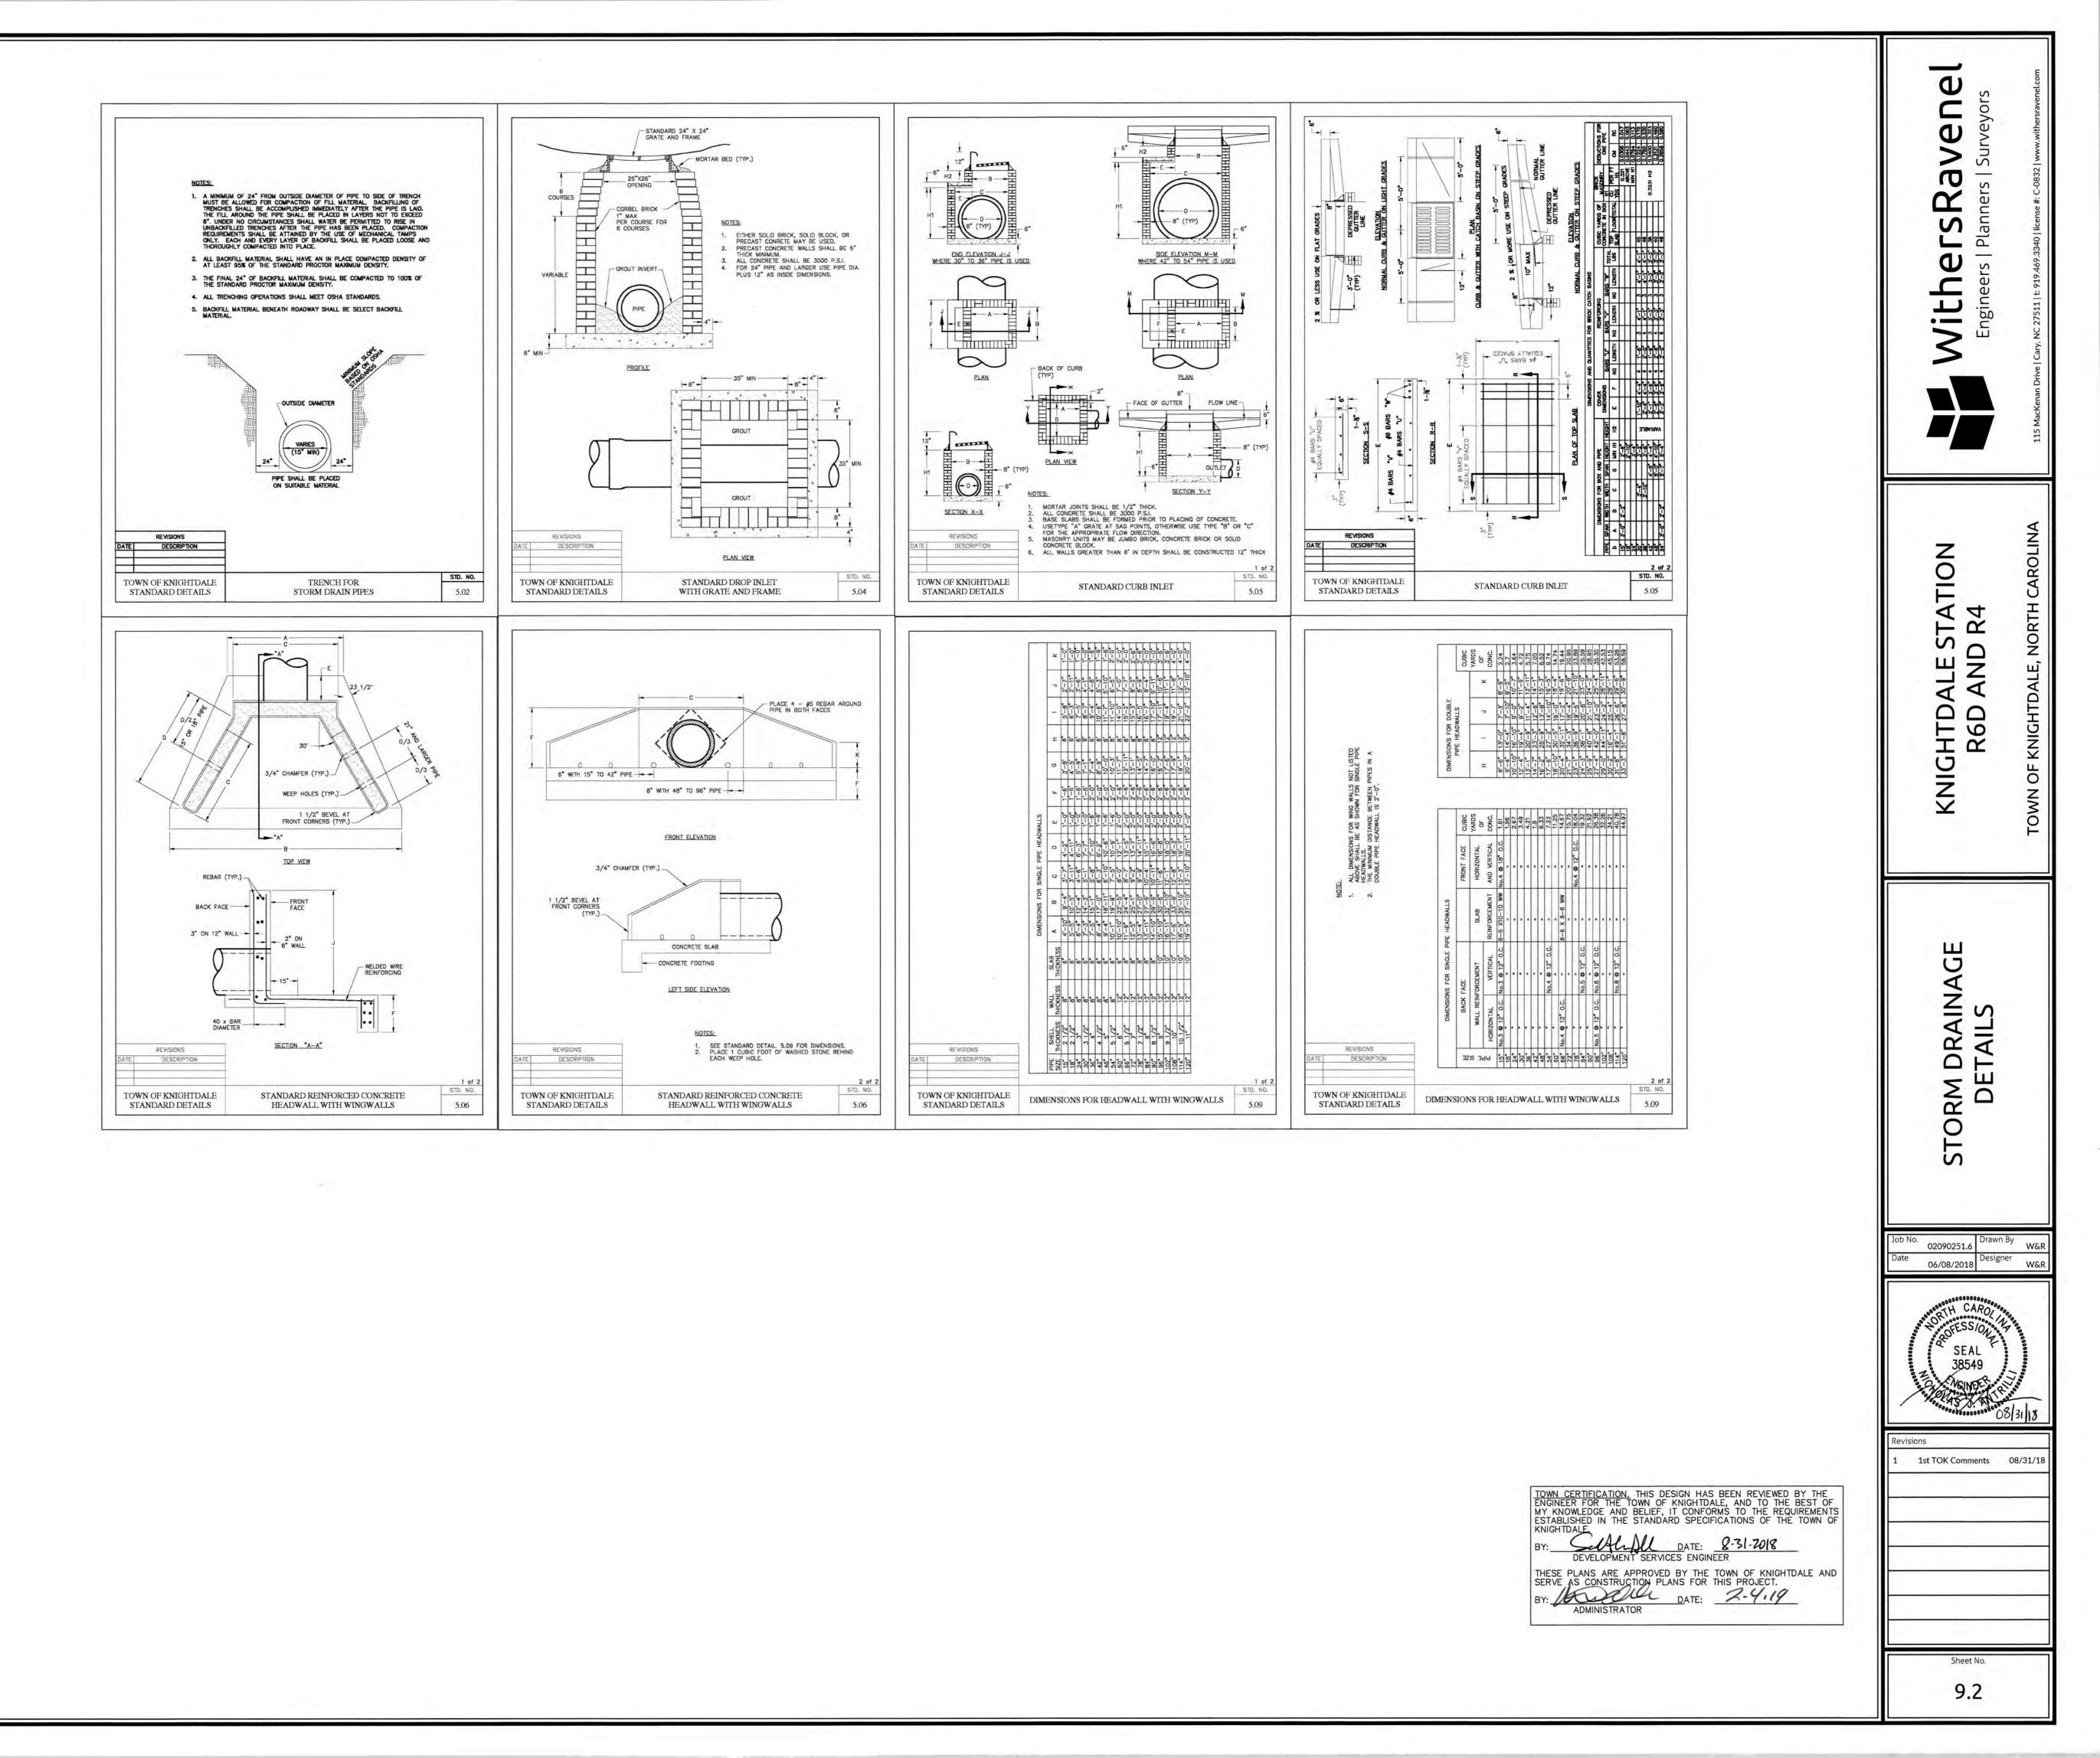

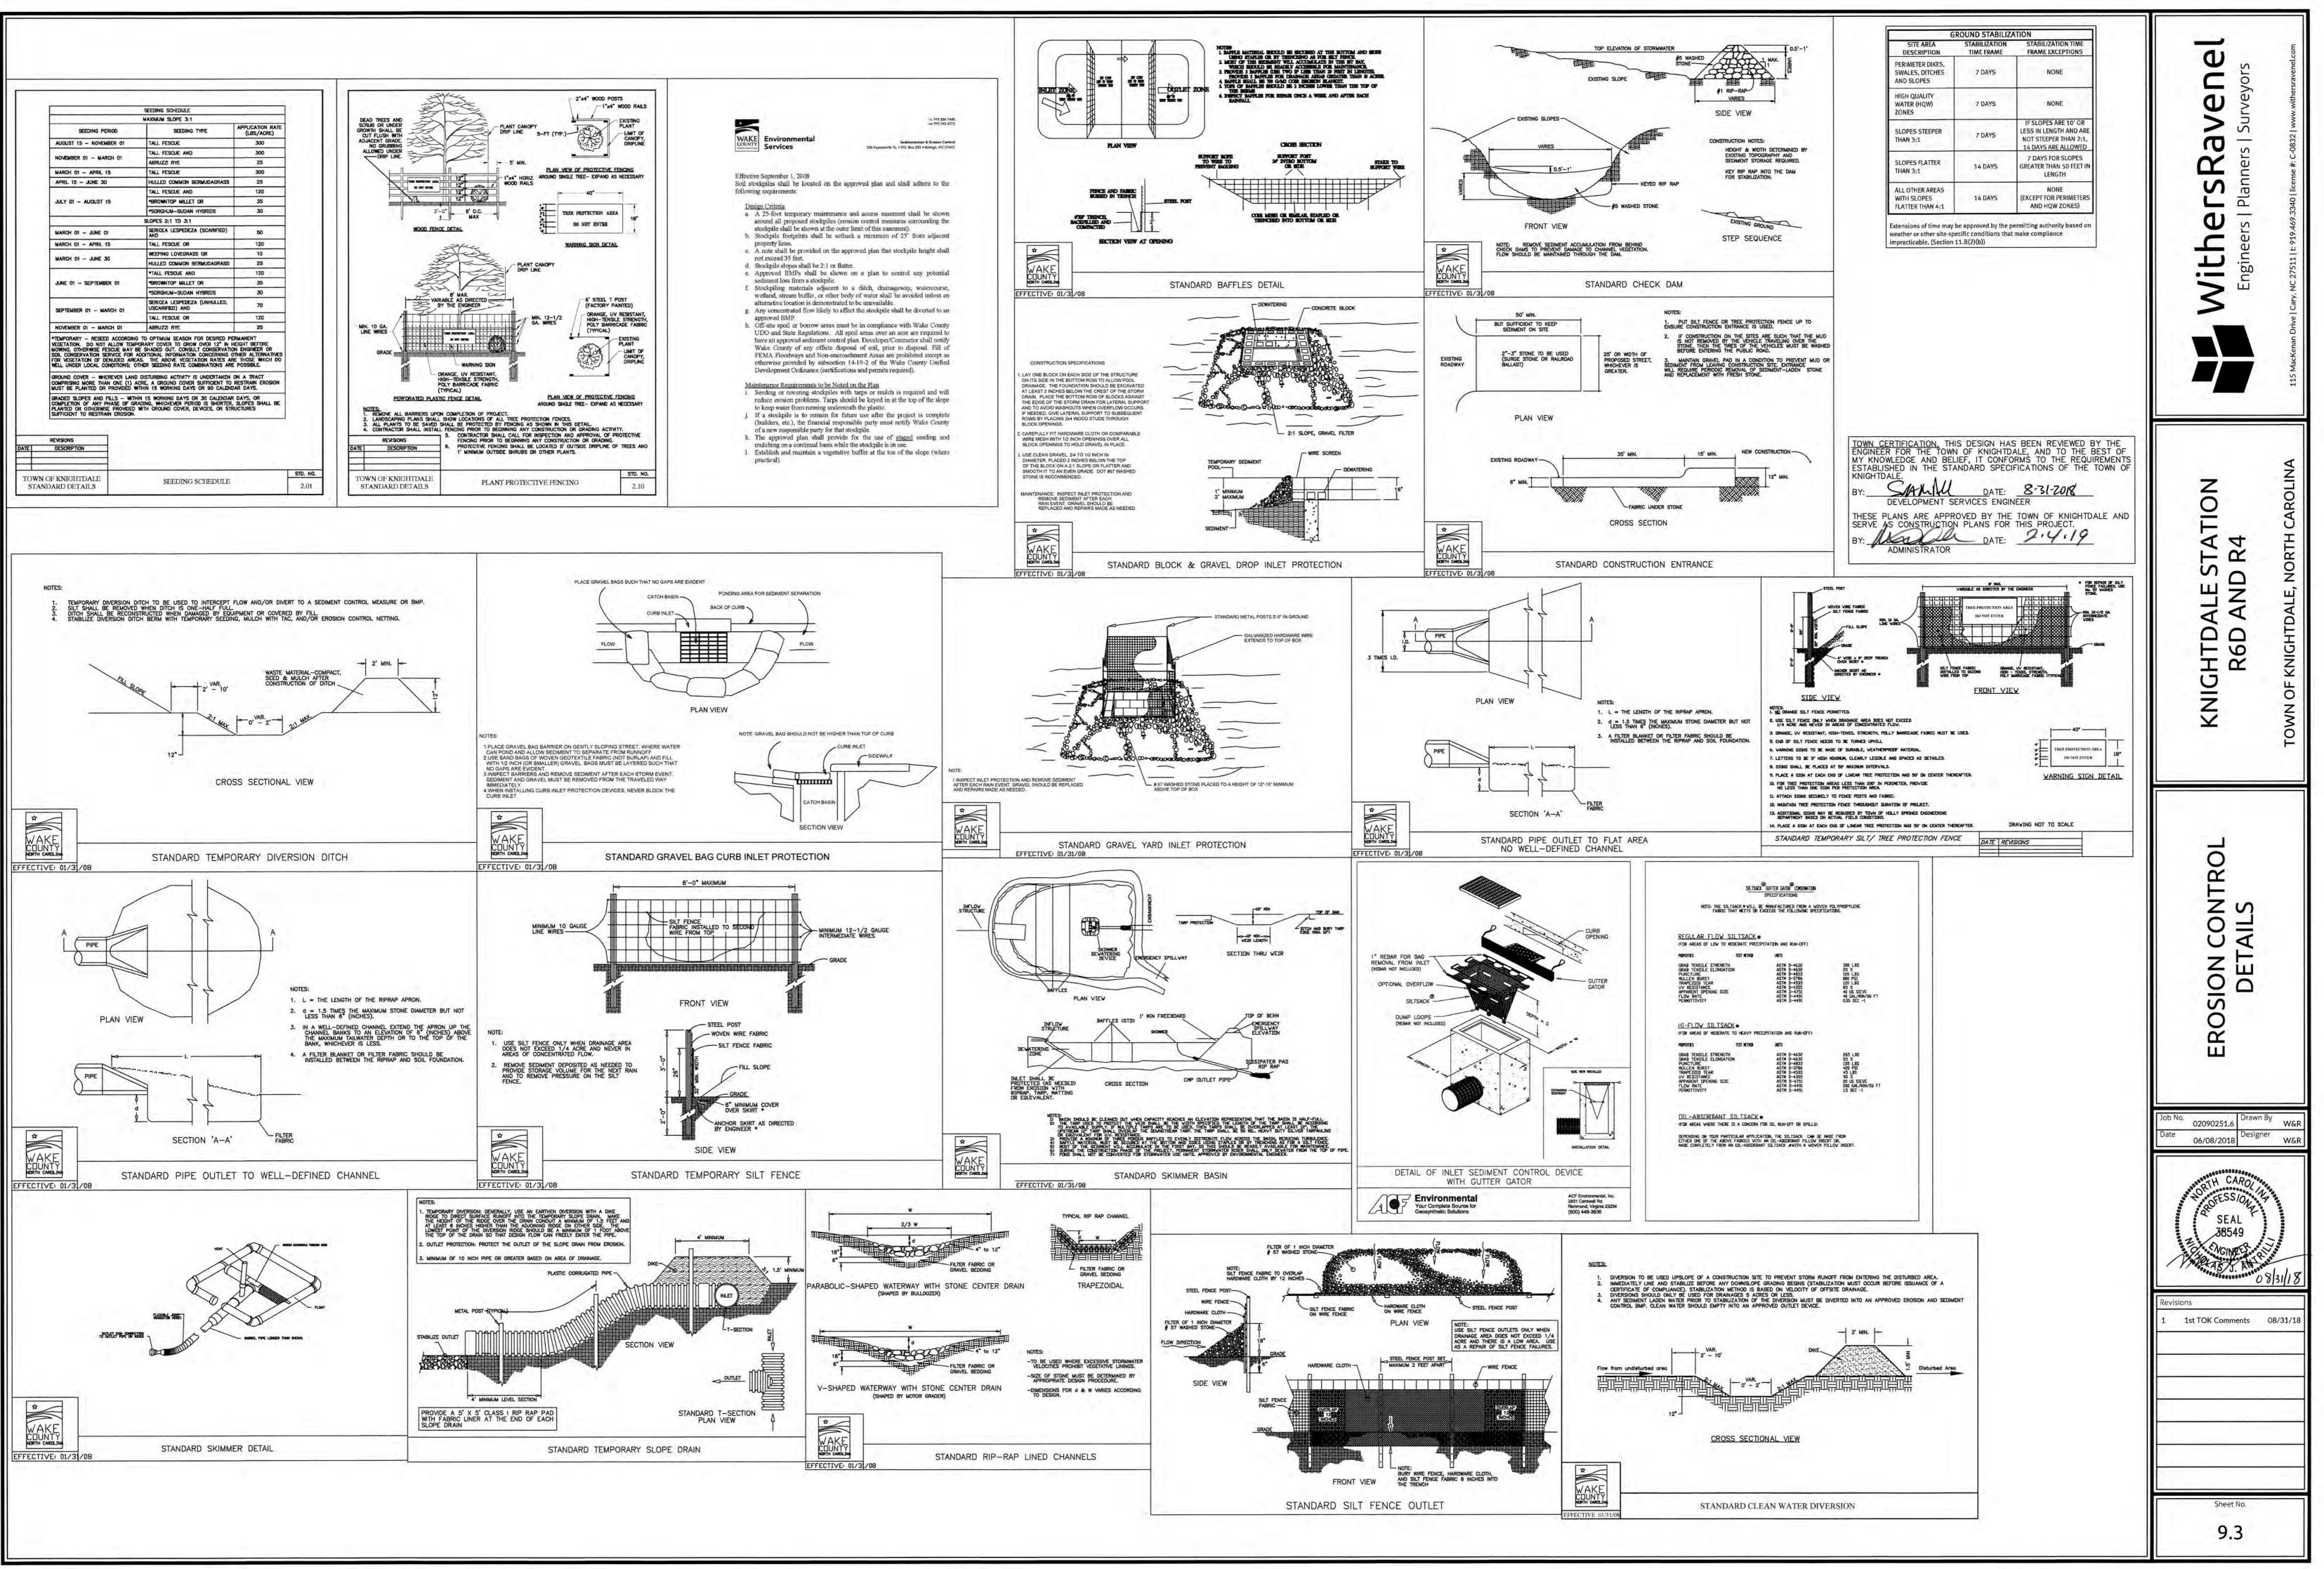


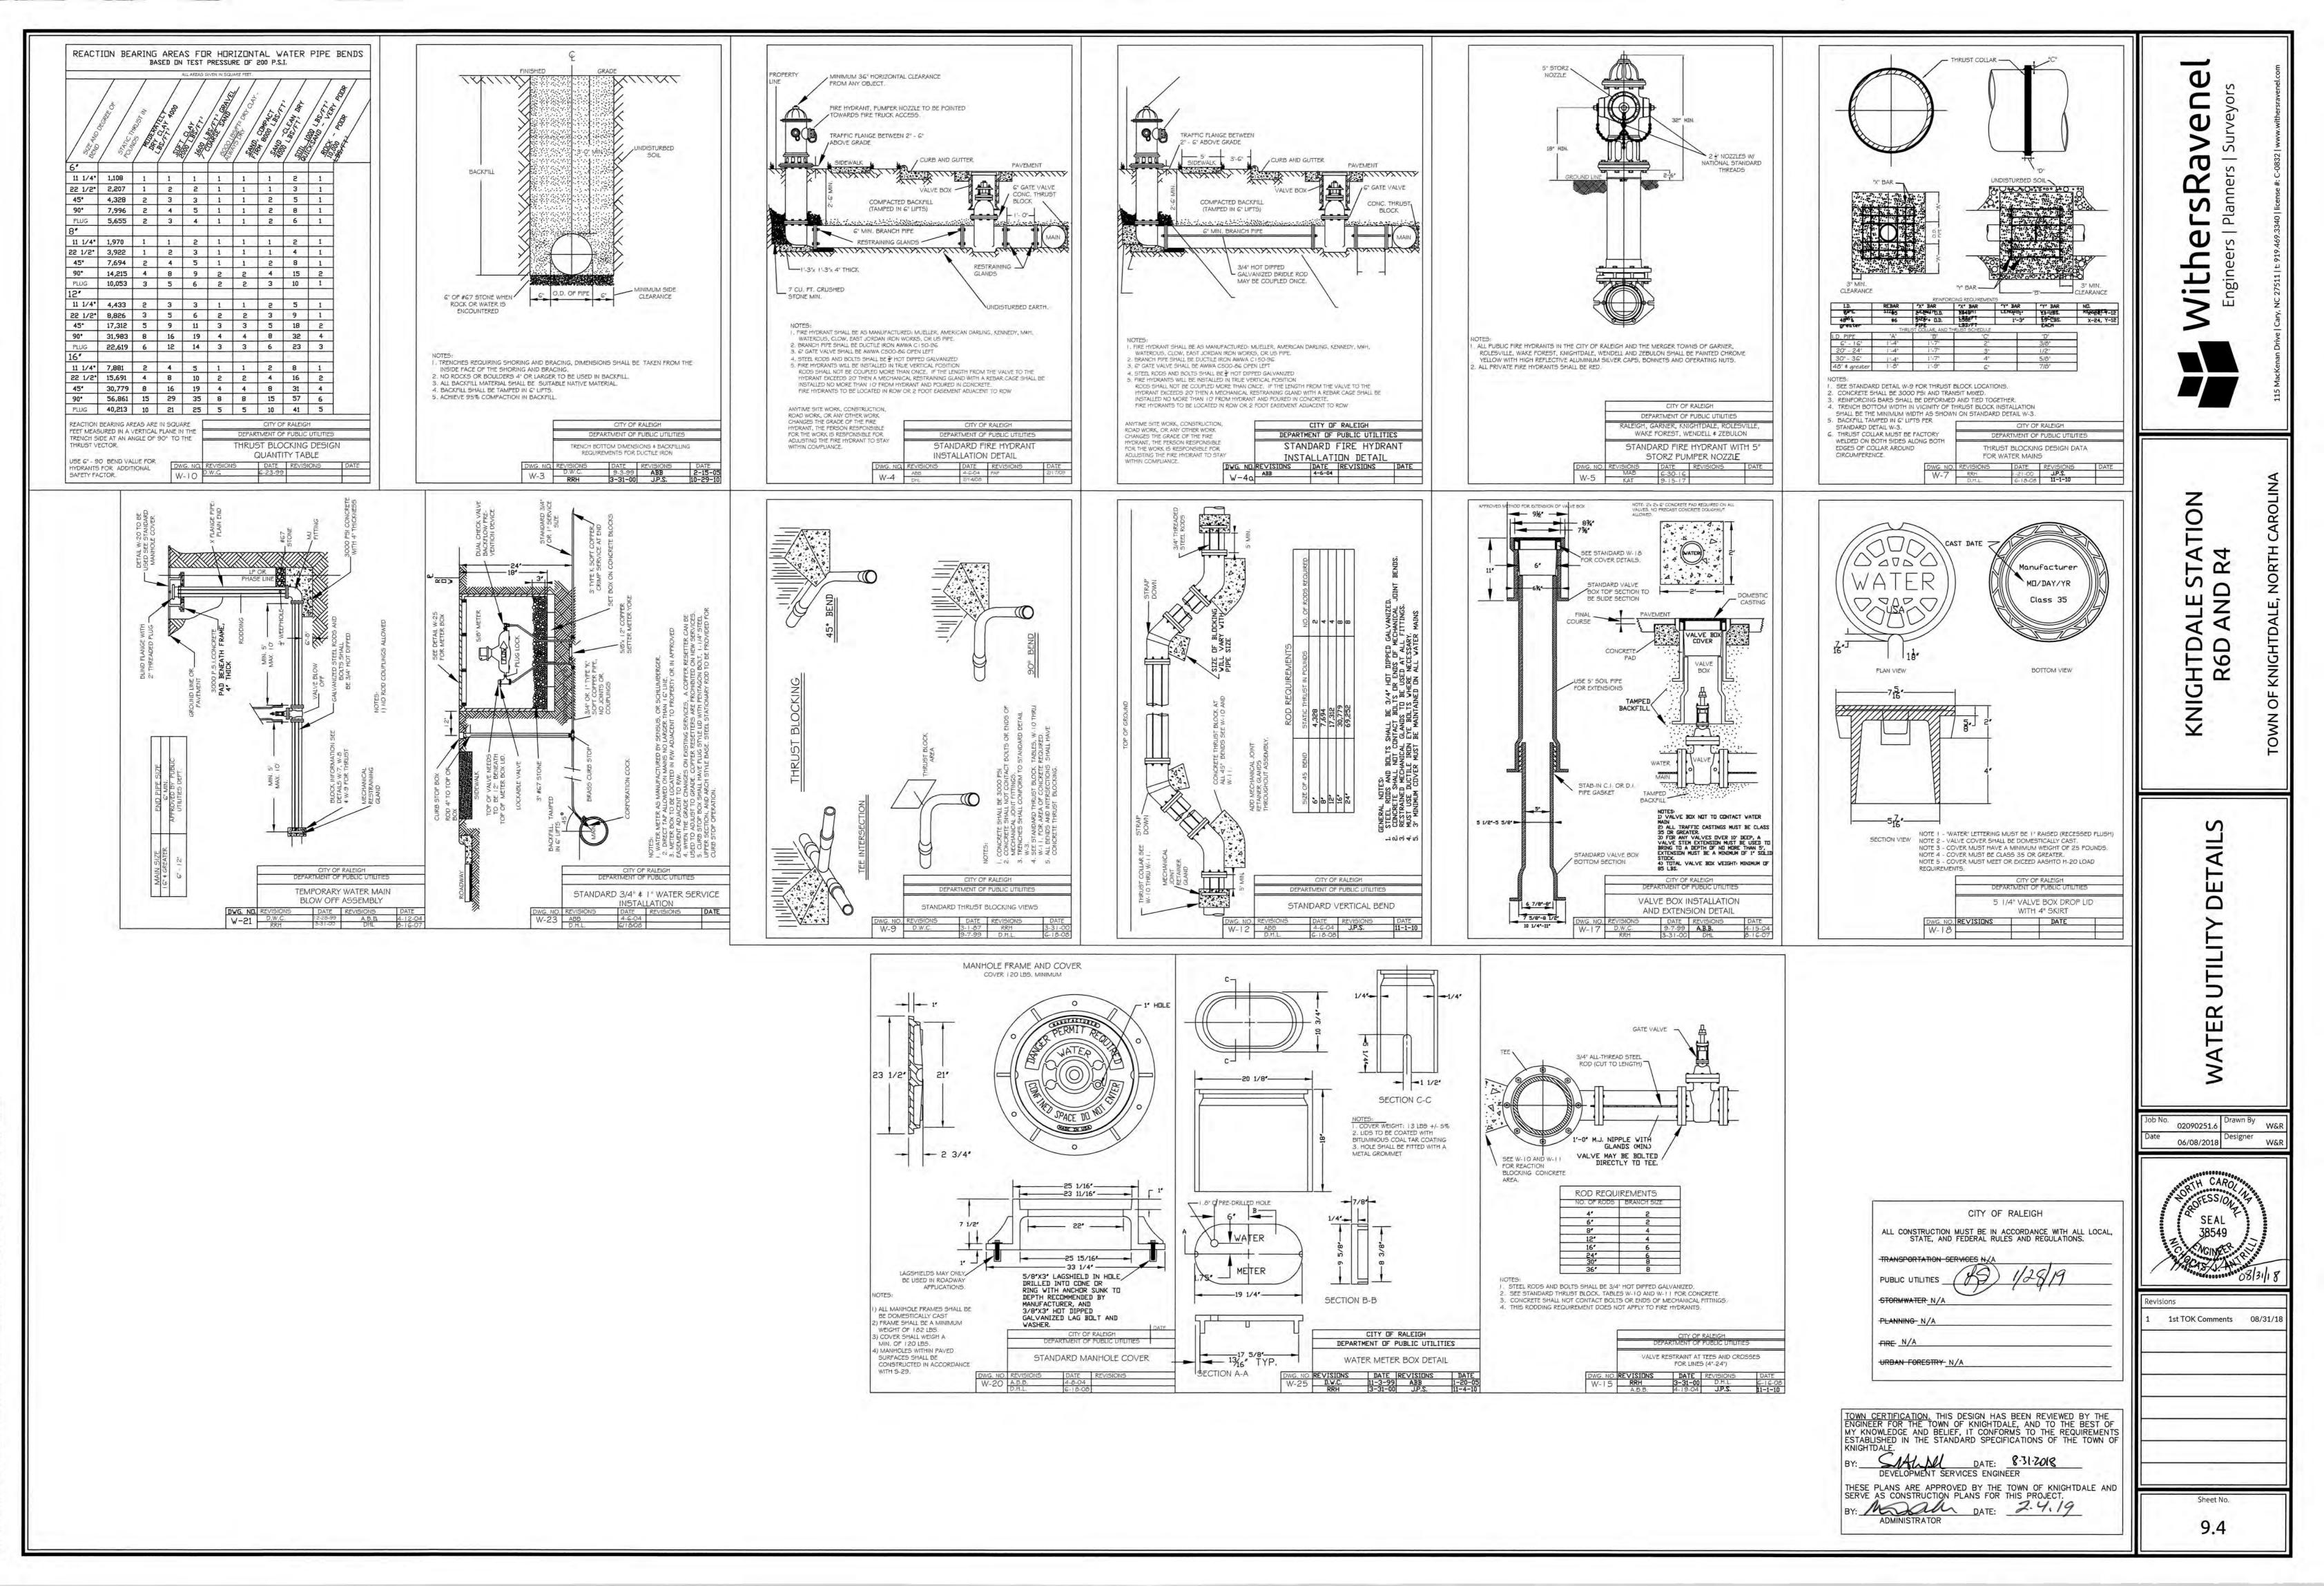


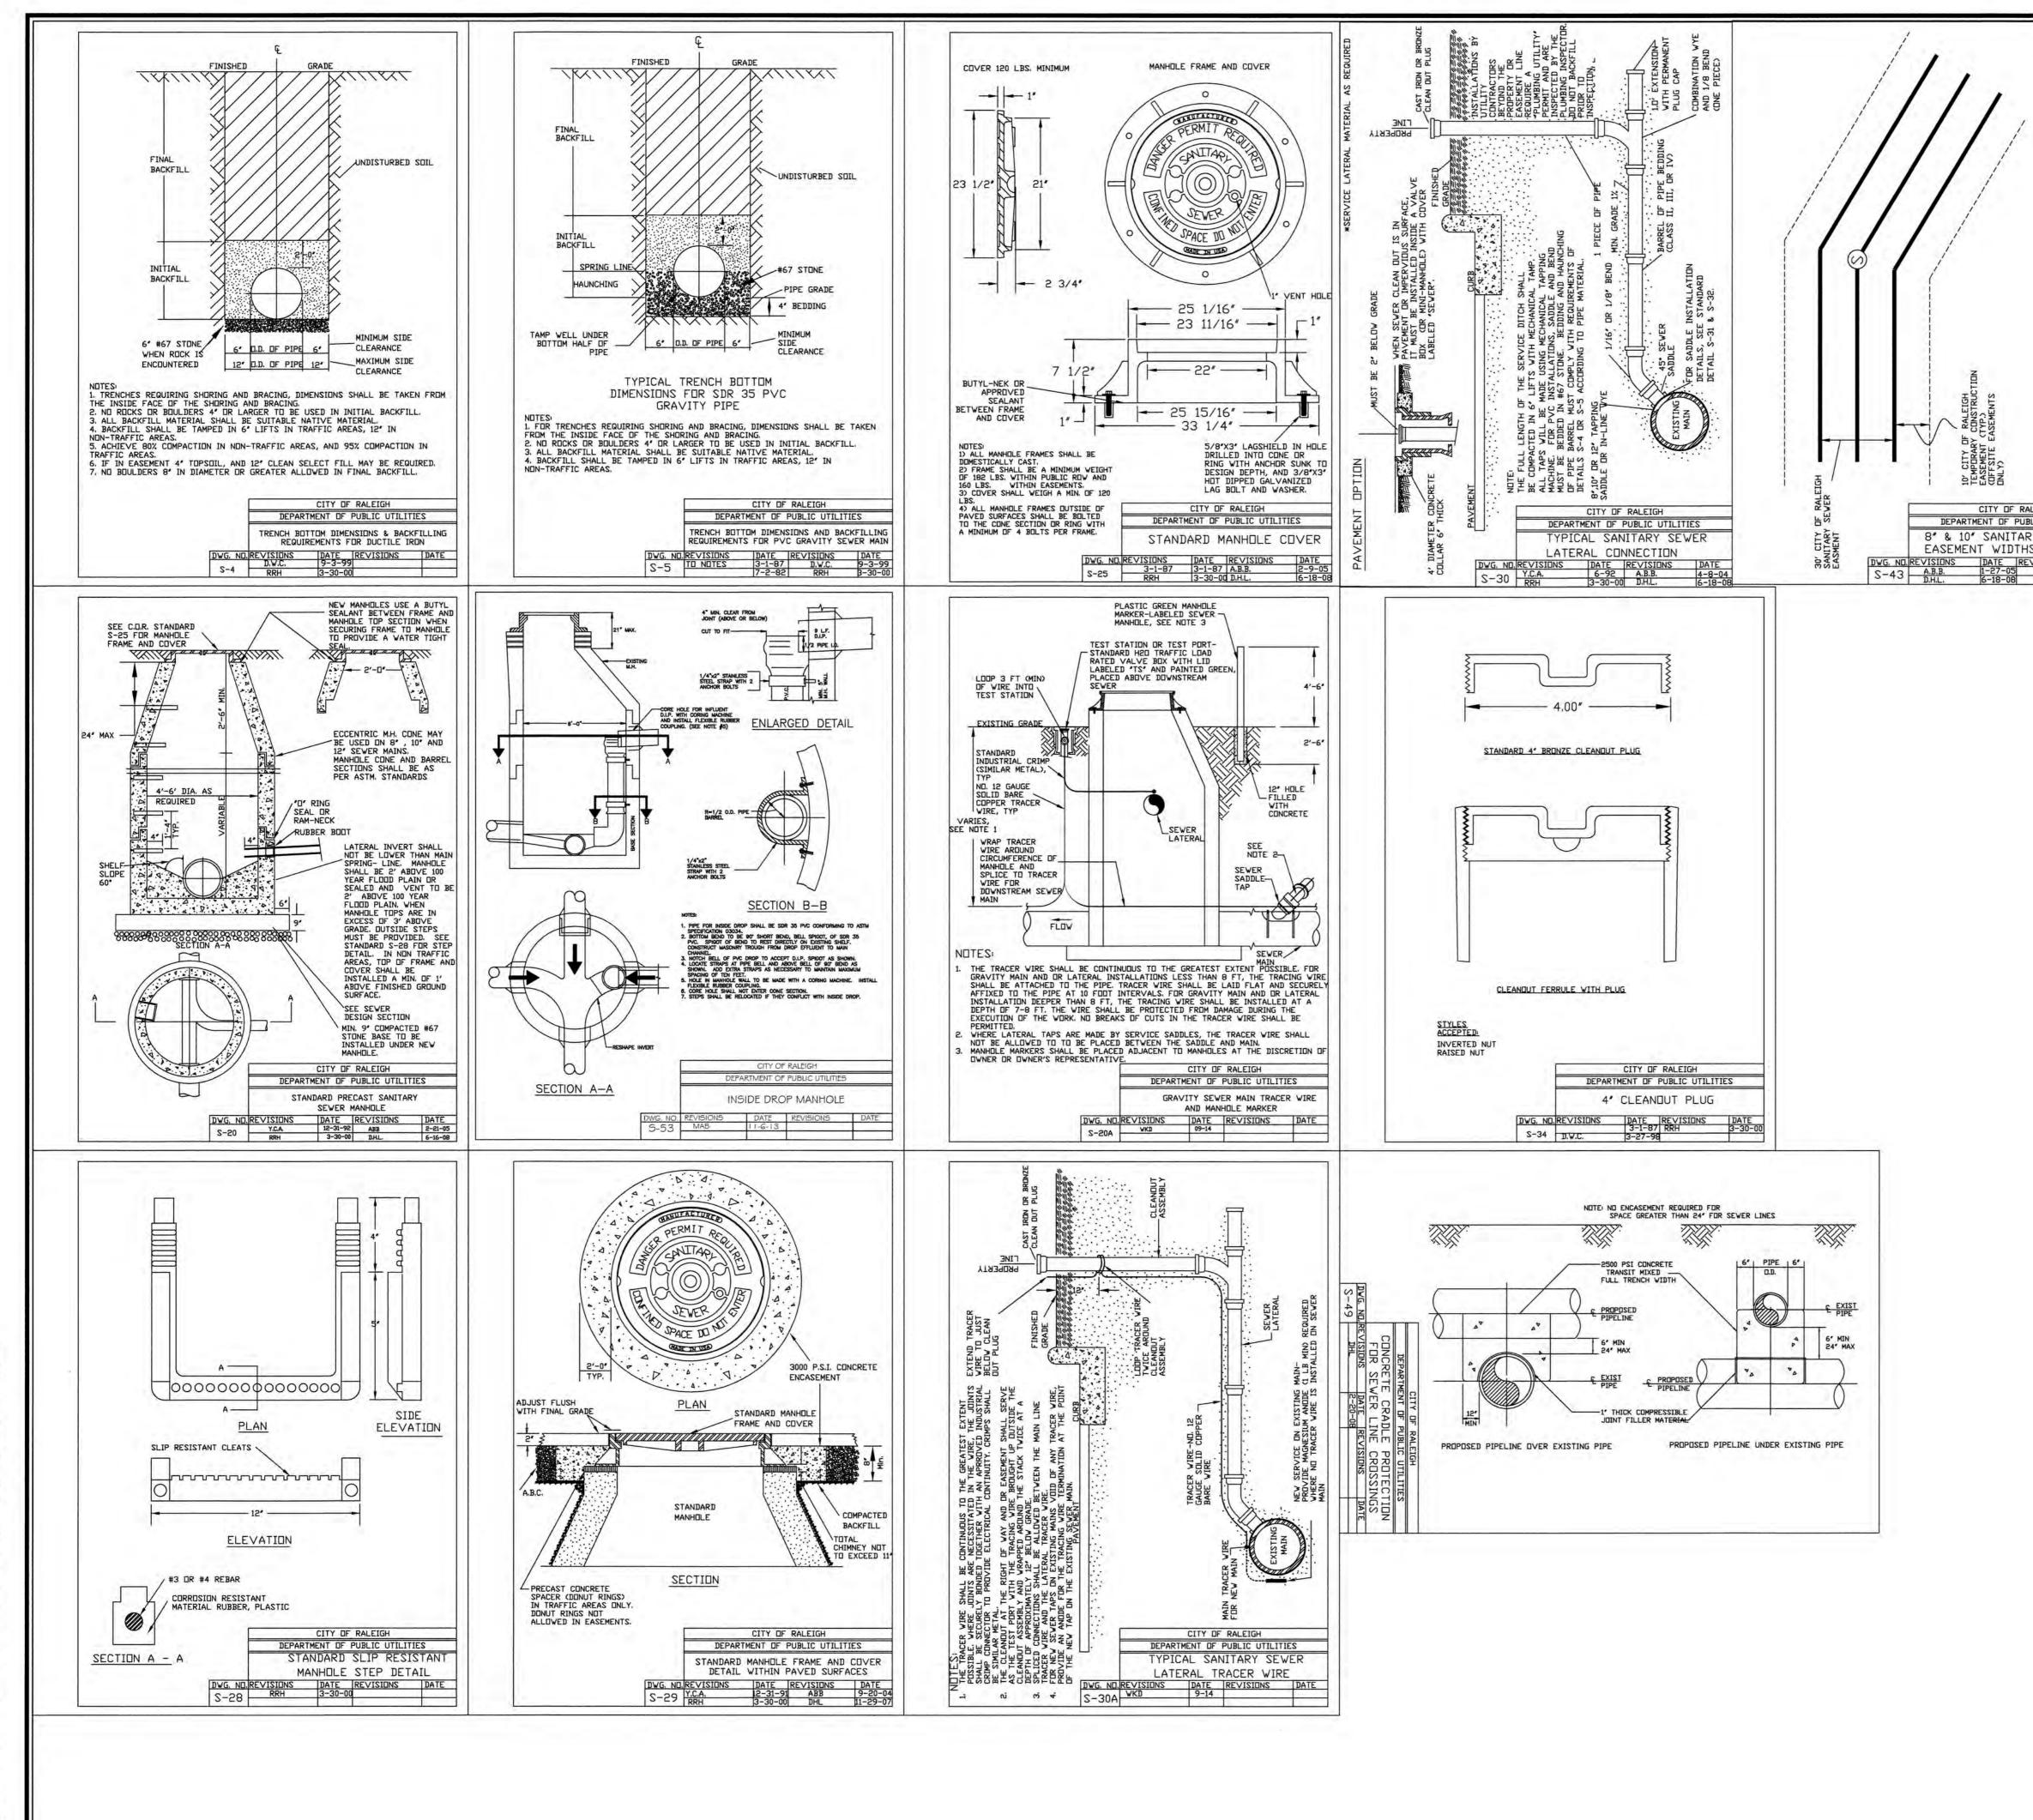


\090251.6-Knightdale Station Phase R4\CAD\MASTER-CONSTRUCTION DRAWINGS\9.1-9.5 DETAILS.dwg-Thursday, August 30, 2018 9:18:51 PM - DURYEA, COLI

	Additional and a series of the
Y SEWER <u>ISIONS DATE</u>	KNIGHTDALE STATION R6D AND R4 Town of Knightdale, North Carolina
	SEWER UTILITY DETAILS
CITY OF RALEIGH ALL CONSTRUCTION MUST BE IN ACCORDANCE WITH ALL LOCAL, STATE, AND FEDERAL RULES AND REGULATIONS. TRANSPORTATION SERVICES N/A PUBLIC UTILITIES	Job No. 02090251.6 Date 06/08/2018 Designer W&R 06/08/2018 Designer W&R W&R W&R W&R W&R W&R W&R W&R
TOWN CERTIFICATION. THIS DESIGN HAS BEEN REVIEWED BY THE         ENGINEER FOR THE TOWN OF KNIGHTDALE, AND TO THE BEST OF         MY KNOWLEDGE AND BELIEF, IT CONFORMS TO THE REQUIREMENTS         ESTABLISHED IN THE STANDARD SPECIFICATIONS OF THE TOWN OF         KNIGHTDALE.         BY:       DATE:         ADMINISTRATOR       DATE:	Sheet No. 9.5

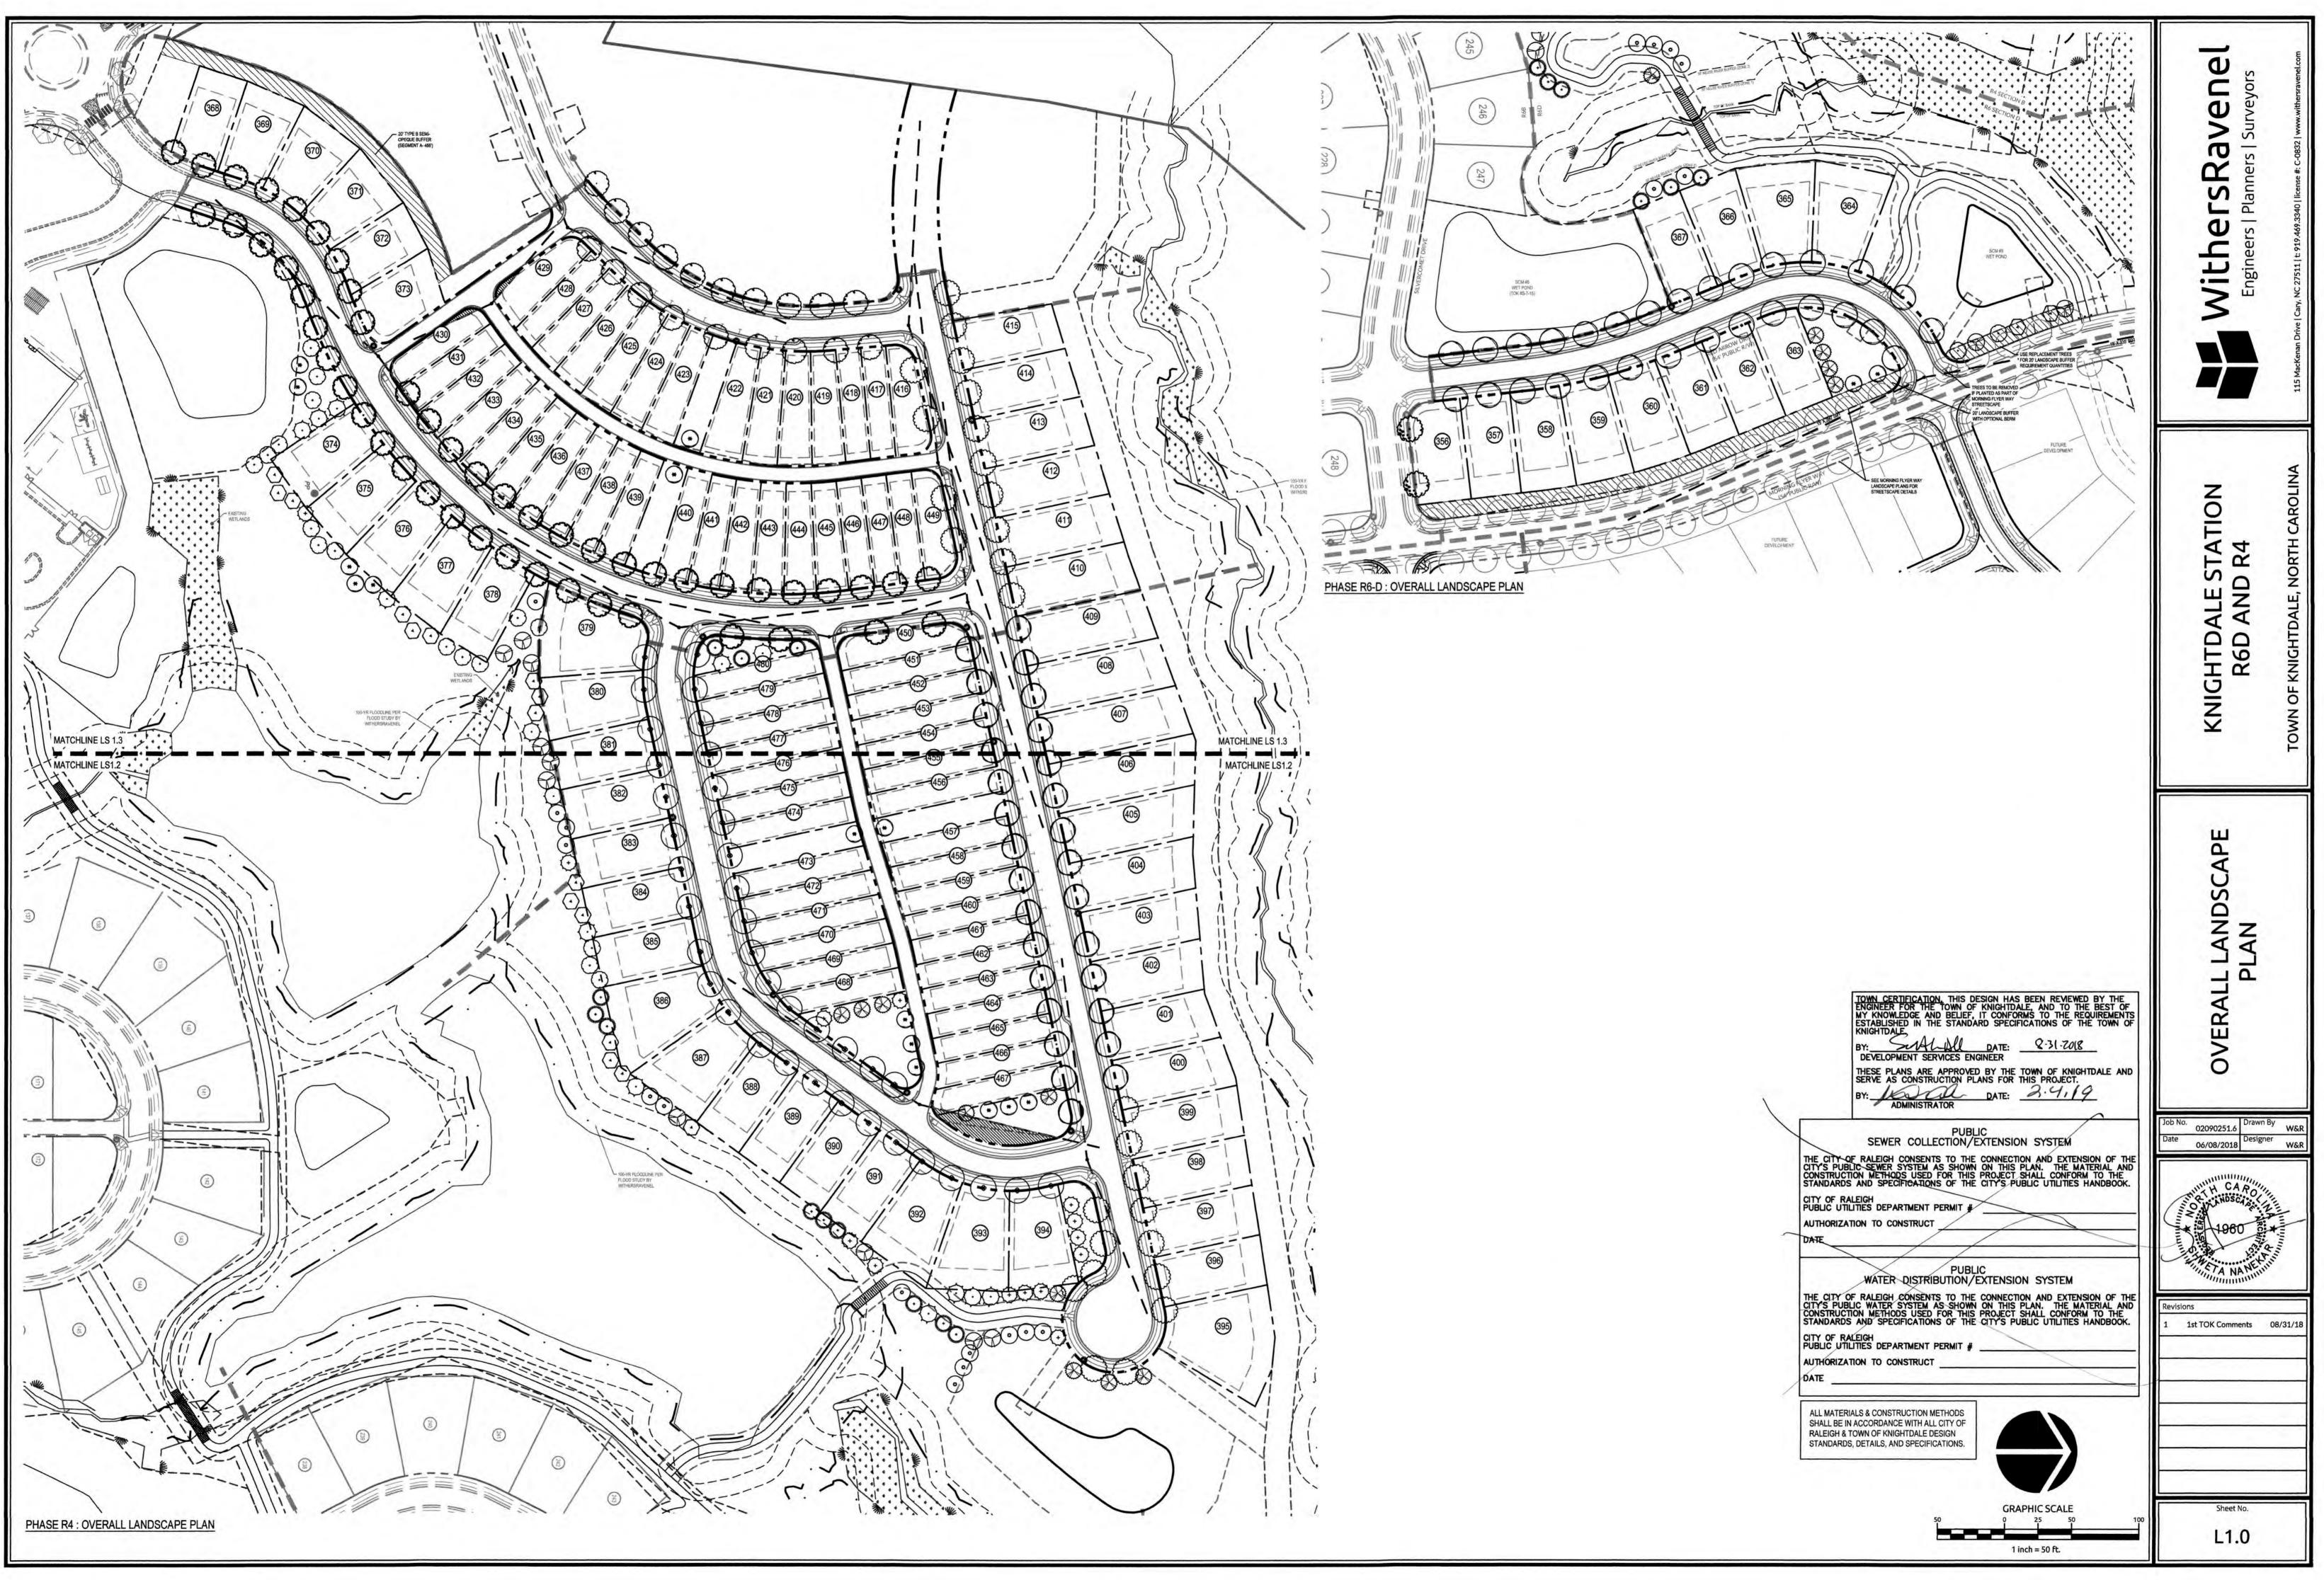

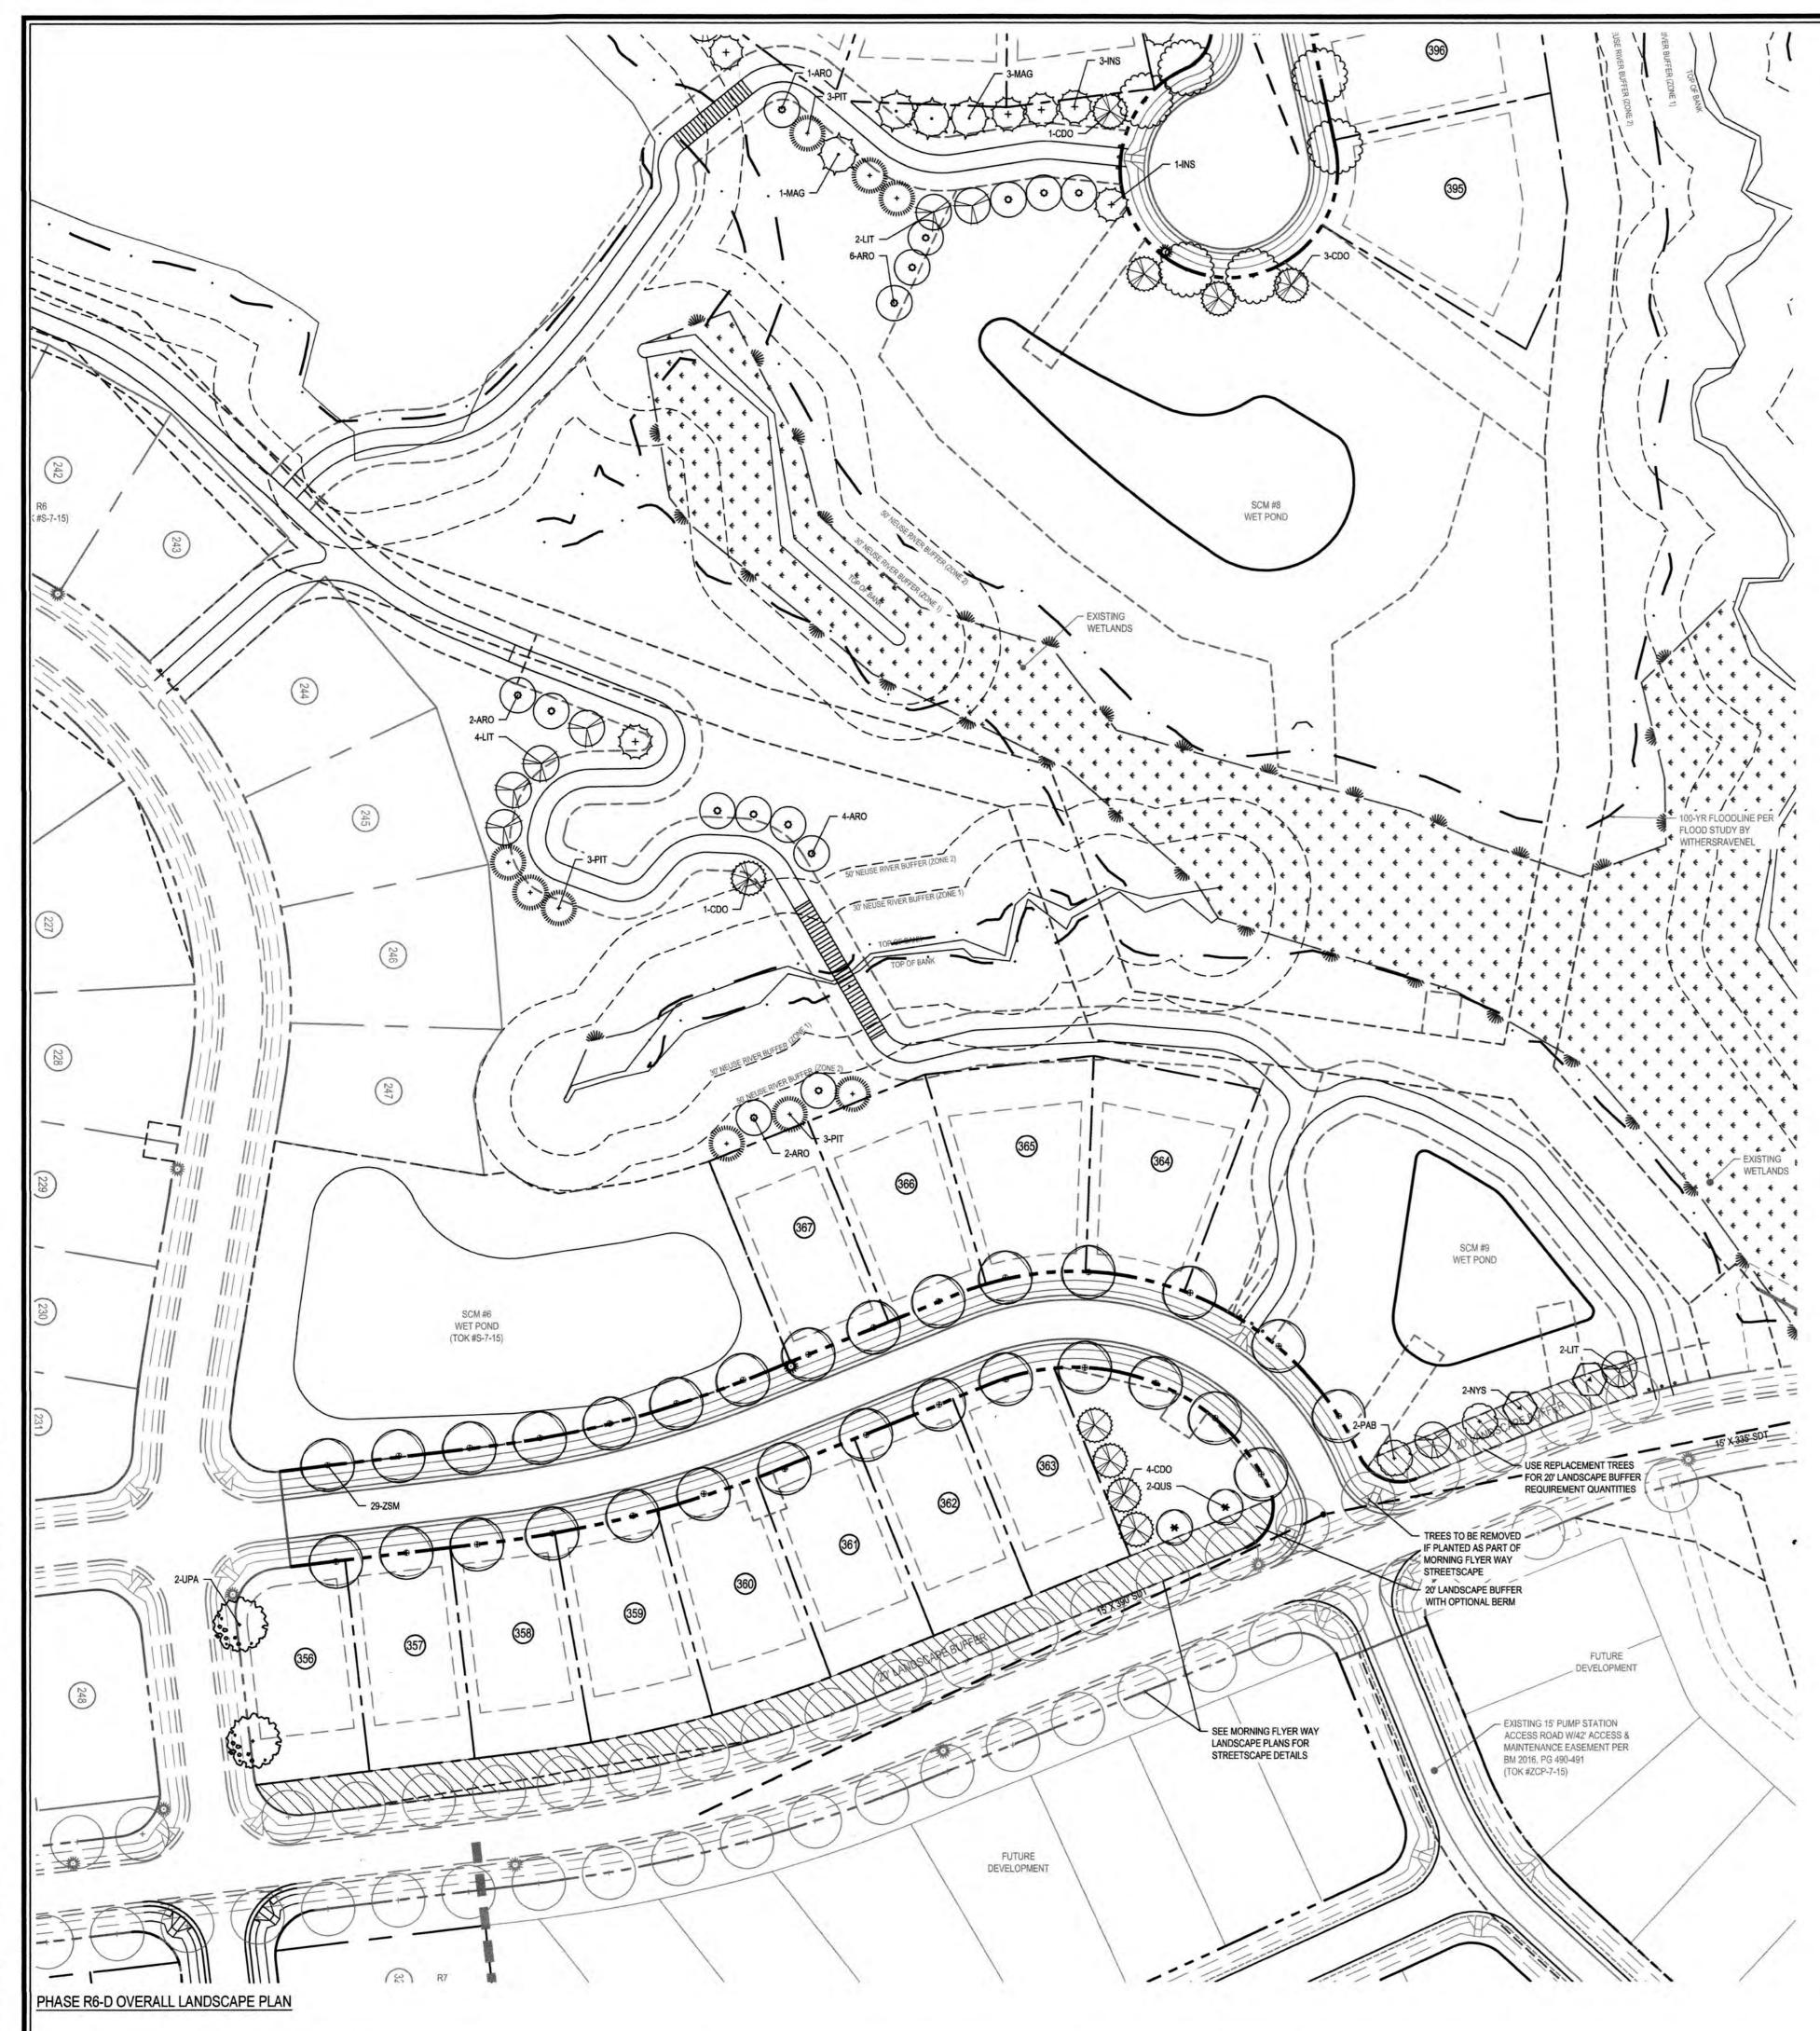


nel Ve S P -S 2 S La **D** <u></u> With 50 ш KNIGHTDALE STATION R6D AND R4 NORT HTDALE, KN 0 Z 4 9 Б NDSC TOWN CERTIFICATION. THIS DESIGN HAS BEEN REVIEWED BY THE ENGINEER FOR THE TOWN OF KNIGHTDALE, AND TO THE BEST OF MY KNOWLEDGE AND BELIEF, IT CONFORMS TO THE REQUIREMENTS ESTABLISHED IN THE STANDARD SPECIFICATIONS OF THE TOWN OF KNIGHTDALE. 4 BY: <u>DATE:</u> 8.31.2018 DEVELOPMENT SERVICES ENGINEER THESE PLANS ARE APPROVED BY THE TOWN OF KNIGHTDALE AND SERVE AS CONSTRUCTION PLANS FOR THIS PROJECT. BY: Model DATE: 2-9-19 Drawn 02090251.6 WSR PUBLIC SEWER COLLECTION/EXTENSION SYSTEM 06/08/2018 Designer )ate W&R THE CITY OF RALEIGH CONSENTS TO THE CONNECTION AND EXTENSION OF THE CITY'S PUBLIC SEWER SYSTEM AS SHOWN ON THIS PLAN. THE MATERIAL AND CONSTRUCTION METHODS USED FOR THIS PROJECT SHALL CONFORM TO THE STANDARDS AND SPECIFICATIONS OF THE CITY'S PUBLIC UTILITIES HANDBOOK. H CARO CITY OF RALEIGH PUBLIC UTILITIES DEPARTMENT PERMIT # AUTHORIZATION TO CONSTRUCT 1960 DATE PUBLIC WATER DISTRIBUTION/EXTENSION SYSTEM THE CITY OF RALEIGH CONSENTS TO THE CONNECTION AND EXTENSION OF THE CITY'S PUBLIC WATER SYSTEM AS SHOWN ON THIS PLAN. THE MATERIAL AND CONSTRUCTION METHODS USED FOR THIS PROJECT SHALL CONFORM TO THE STANDARDS AND SPECIFICATIONS OF THE CITY'S PUBLIC UTILITIES HANDBOOK. Revisions 1st TOK Comments 08/31/18 CITY OF RALEIGH PUBLIC UTILITIES DEPARTMENT PERMIT # AUTHORIZATION TO CONSTRUCT DATE ALL MATERIALS & CONSTRUCTION METHODS SHALL BE IN ACCORDANCE WITH ALL CITY OF RALEIGH & TOWN OF KNIGHTDALE DESIGN STANDARDS, DETAILS, AND SPECIFICATIONS. **GRAPHIC SCALE** Sheet No L1.1 1 inch = 50 ft.

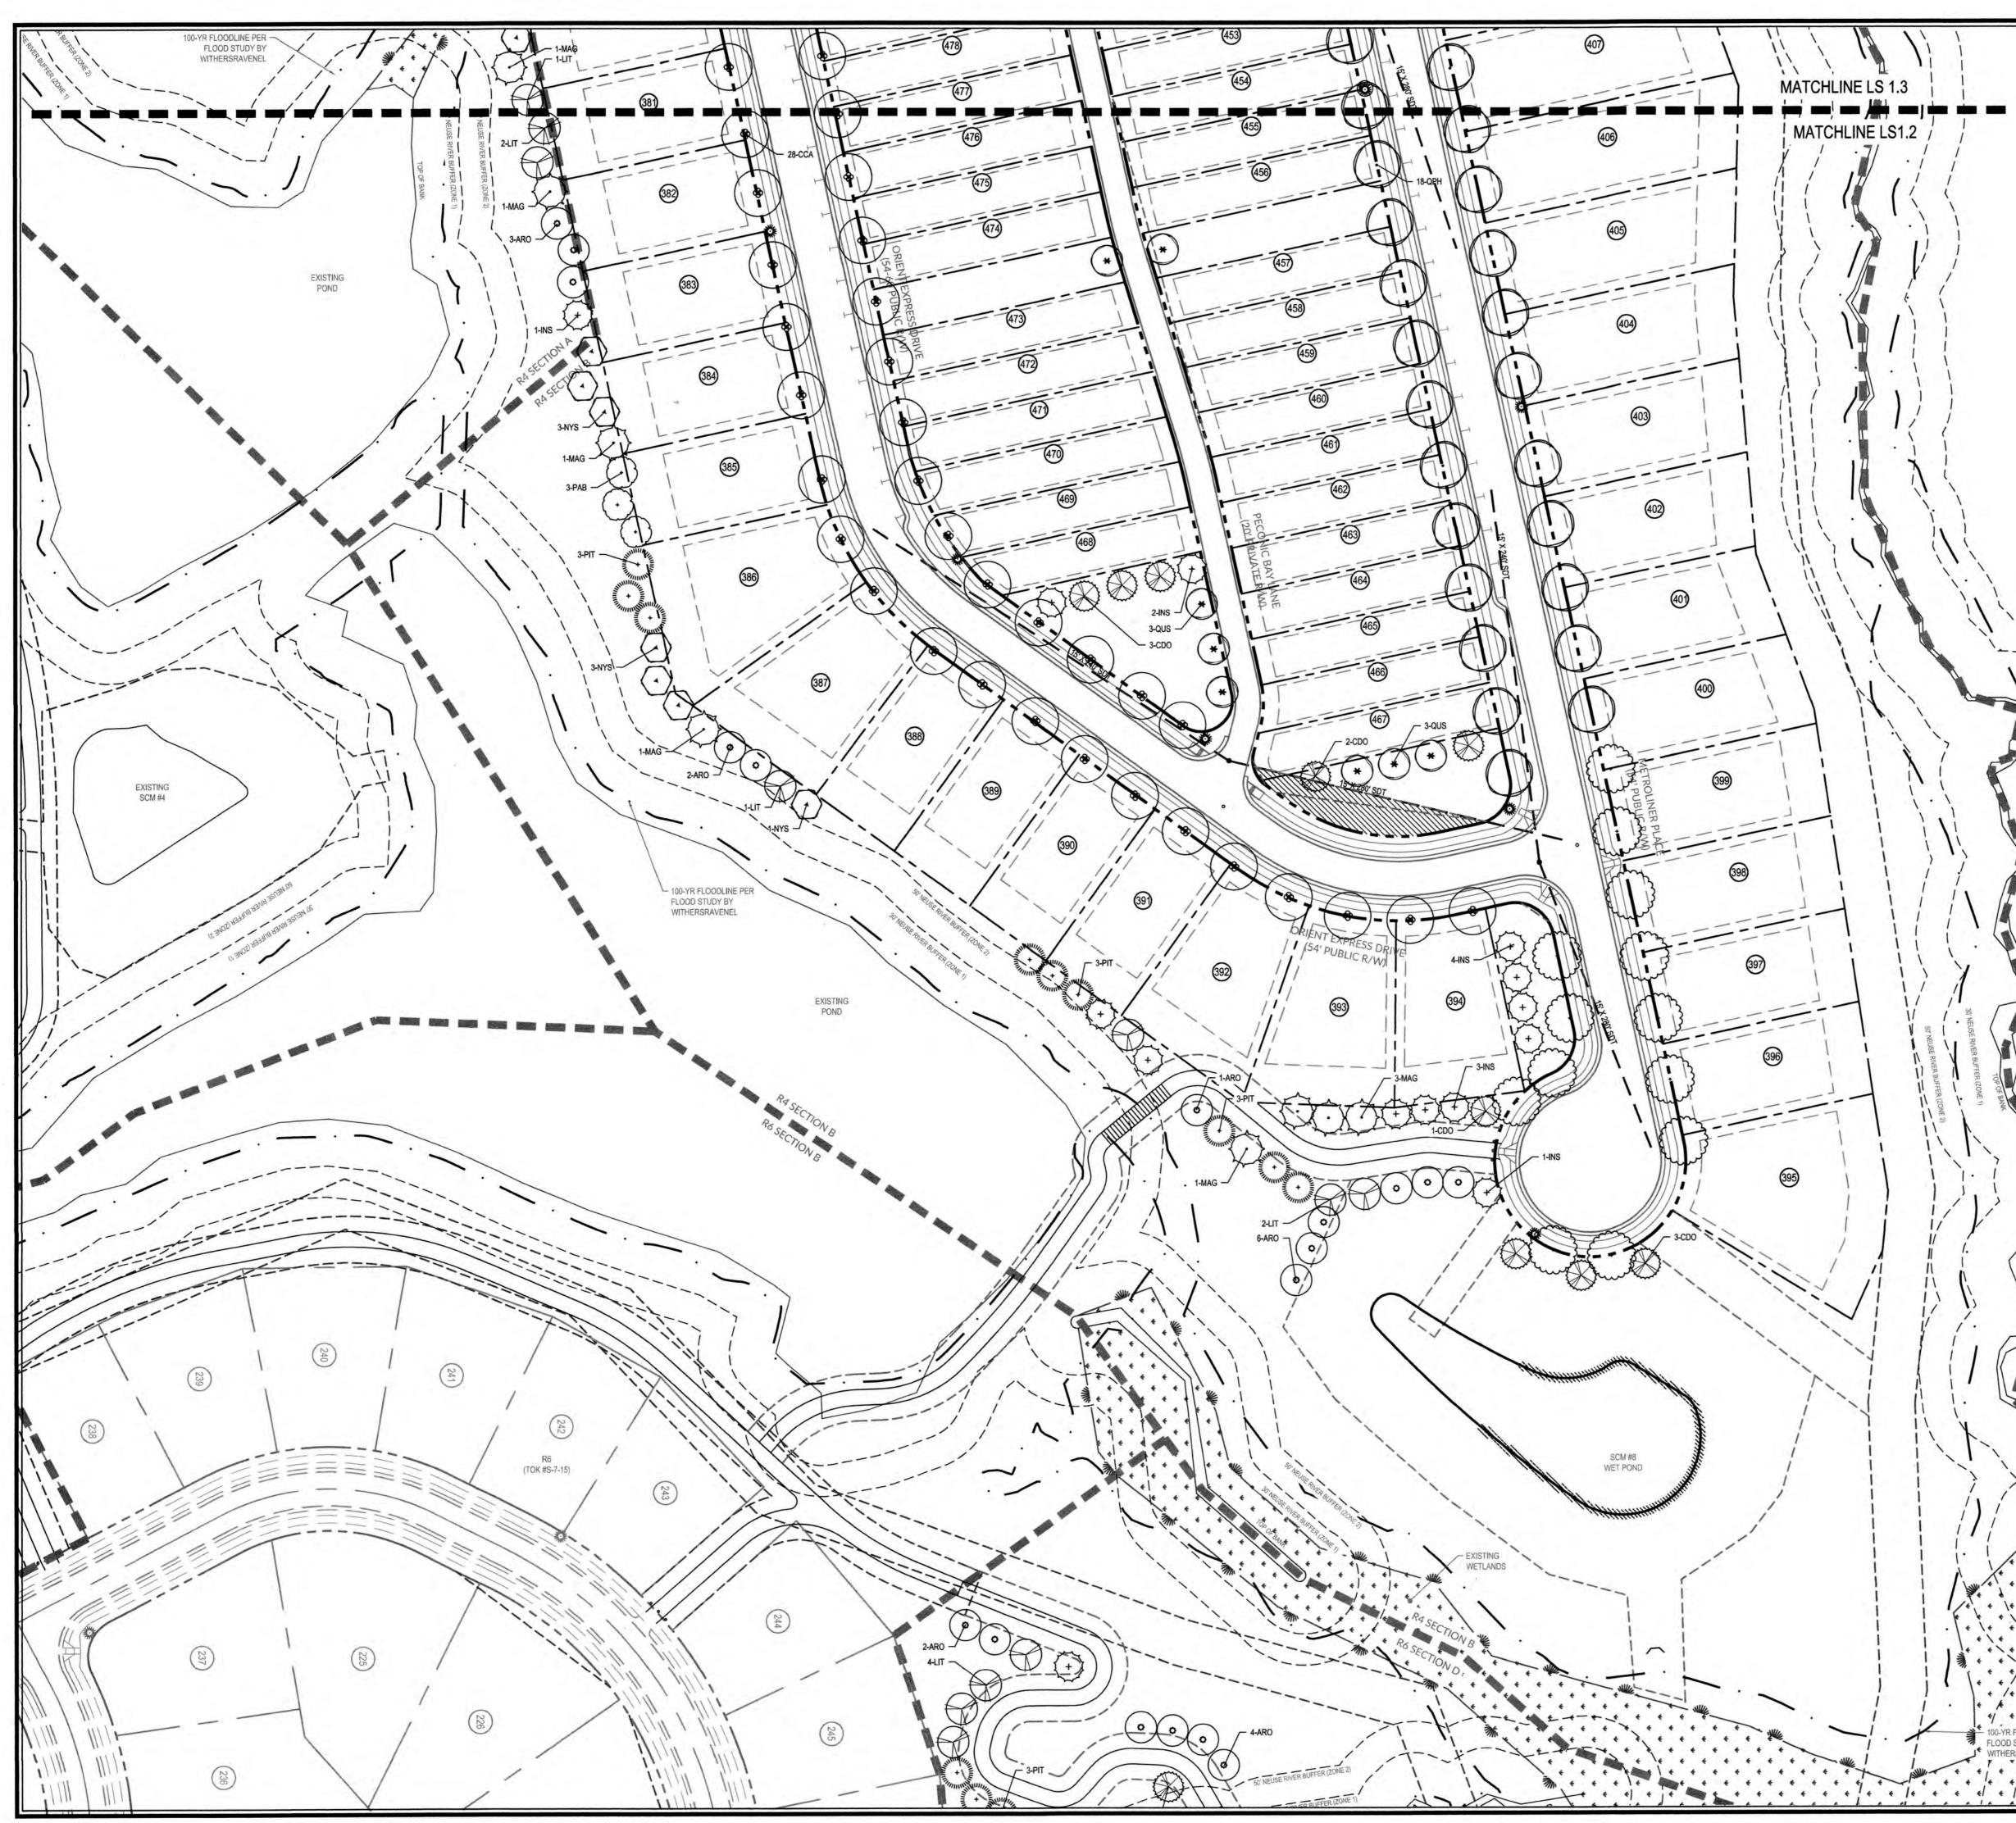

-0250/090251.6-Knightdale Station Phase R4\CAD\MASTER-CONSTRUCTION DRAWINGS\L1.0-1.3 LANDSCAPE PLAN.dwg-Thursday, August 30, 2018 4:26:27 PM - NANEKA

ene 0 S σ S X S T J S /ith ngi ш TION R4 ALE S 0 Ż 0 KNIGHTD/ R6D Y 0 AN ൨ ш Δ ⊲ ANDSC. TOWN CERTIFICATION. THIS DESIGN HAS BEEN REVIEWED BY THE ENGINEER FOR THE TOWN OF KNIGHTDALE, AND TO THE BEST OF MY KNOWLEDGE AND BELIEF, IT CONFORMS TO THE REQUIREMENTS ESTABLISHED IN THE STANDARD SPECIFICATIONS OF THE TOWN OF KNIGHTDALE BY: \_\_\_\_\_\_DATE: \_\_\_\_\_\_\_ DEVELOPMENT SERVICES ENGINEER THESE PLANS ARE APPROVED BY THE TOWN OF KNIGHTDALE AND SERVE AS CONSTRUCTION PLANS FOR THIS PROJECT. BY: <u>Manual Date:</u> <u>2.4119</u> ADMINISTRATOR Drawn By 02090251.6 PUBLIC SEWER COLLECTION/EXTENSION SYSTEM 06/08/2018 Designer W&R THE CITY OF RALEIGH CONSENTS TO THE CONNECTION AND EXTENSION OF THE CITY'S PUBLIC SEWER SYSTEM AS SHOWN ON THIS PLAN. THE MATERIAL AND CONSTRUCTION METHODS USED FOR THIS PROJECT SHALL CONFORM TO THE STANDARDS AND SPECIFICATIONS OF THE CITY'S PUBLIC UTILITIES HANDBOOK. H CARO CITY OF RALEIGH PUBLIC UTILITIES DEPARTMENT PERMIT # AUTHORIZATION TO CONSTRUCT 1960 DATE A NA PUBLIC WATER DISTRIBUTION/EXTENSION SYSTEM THE CITY OF RALEIGH CONSENTS TO THE CONNECTION AND EXTENSION OF THE CITY'S PUBLIC WATER SYSTEM AS SHOWN ON THIS PLAN. THE MATERIAL AND CONSTRUCTION METHODS USED FOR THIS PROJECT SHALL CONFORM TO THE STANDARDS AND SPECIFICATIONS OF THE CITY'S PUBLIC UTILITIES HANDBOOK. isions 1st TOK Comments 08/31/18 CITY OF RALEIGH PUBLIC UTILITIES DEPARTMENT PERMIT # AUTHORIZATION TO CONSTRUCT DATE + \ + e \ + + \ + + + + + + 3 + + + ALL MATERIALS & CONSTRUCTION METHODS SHALL BE IN ACCORDANCE WITH ALL CITY OF + +! \* \* / \* RALEIGH & TOWN OF KNIGHTDALE DESIGN + /+ STANDARDS, DETAILS, AND SPECIFICATIONS. \* \* \*/ \* 100-YR FLO FLOOD STUD **GRAPHIC SCALE** Sheet No. WITHERSRA × 1 L1.2 4 i 4 4 4 4 1 inch = 50 ft. \* \* |\* \* \* \*| \* |\*

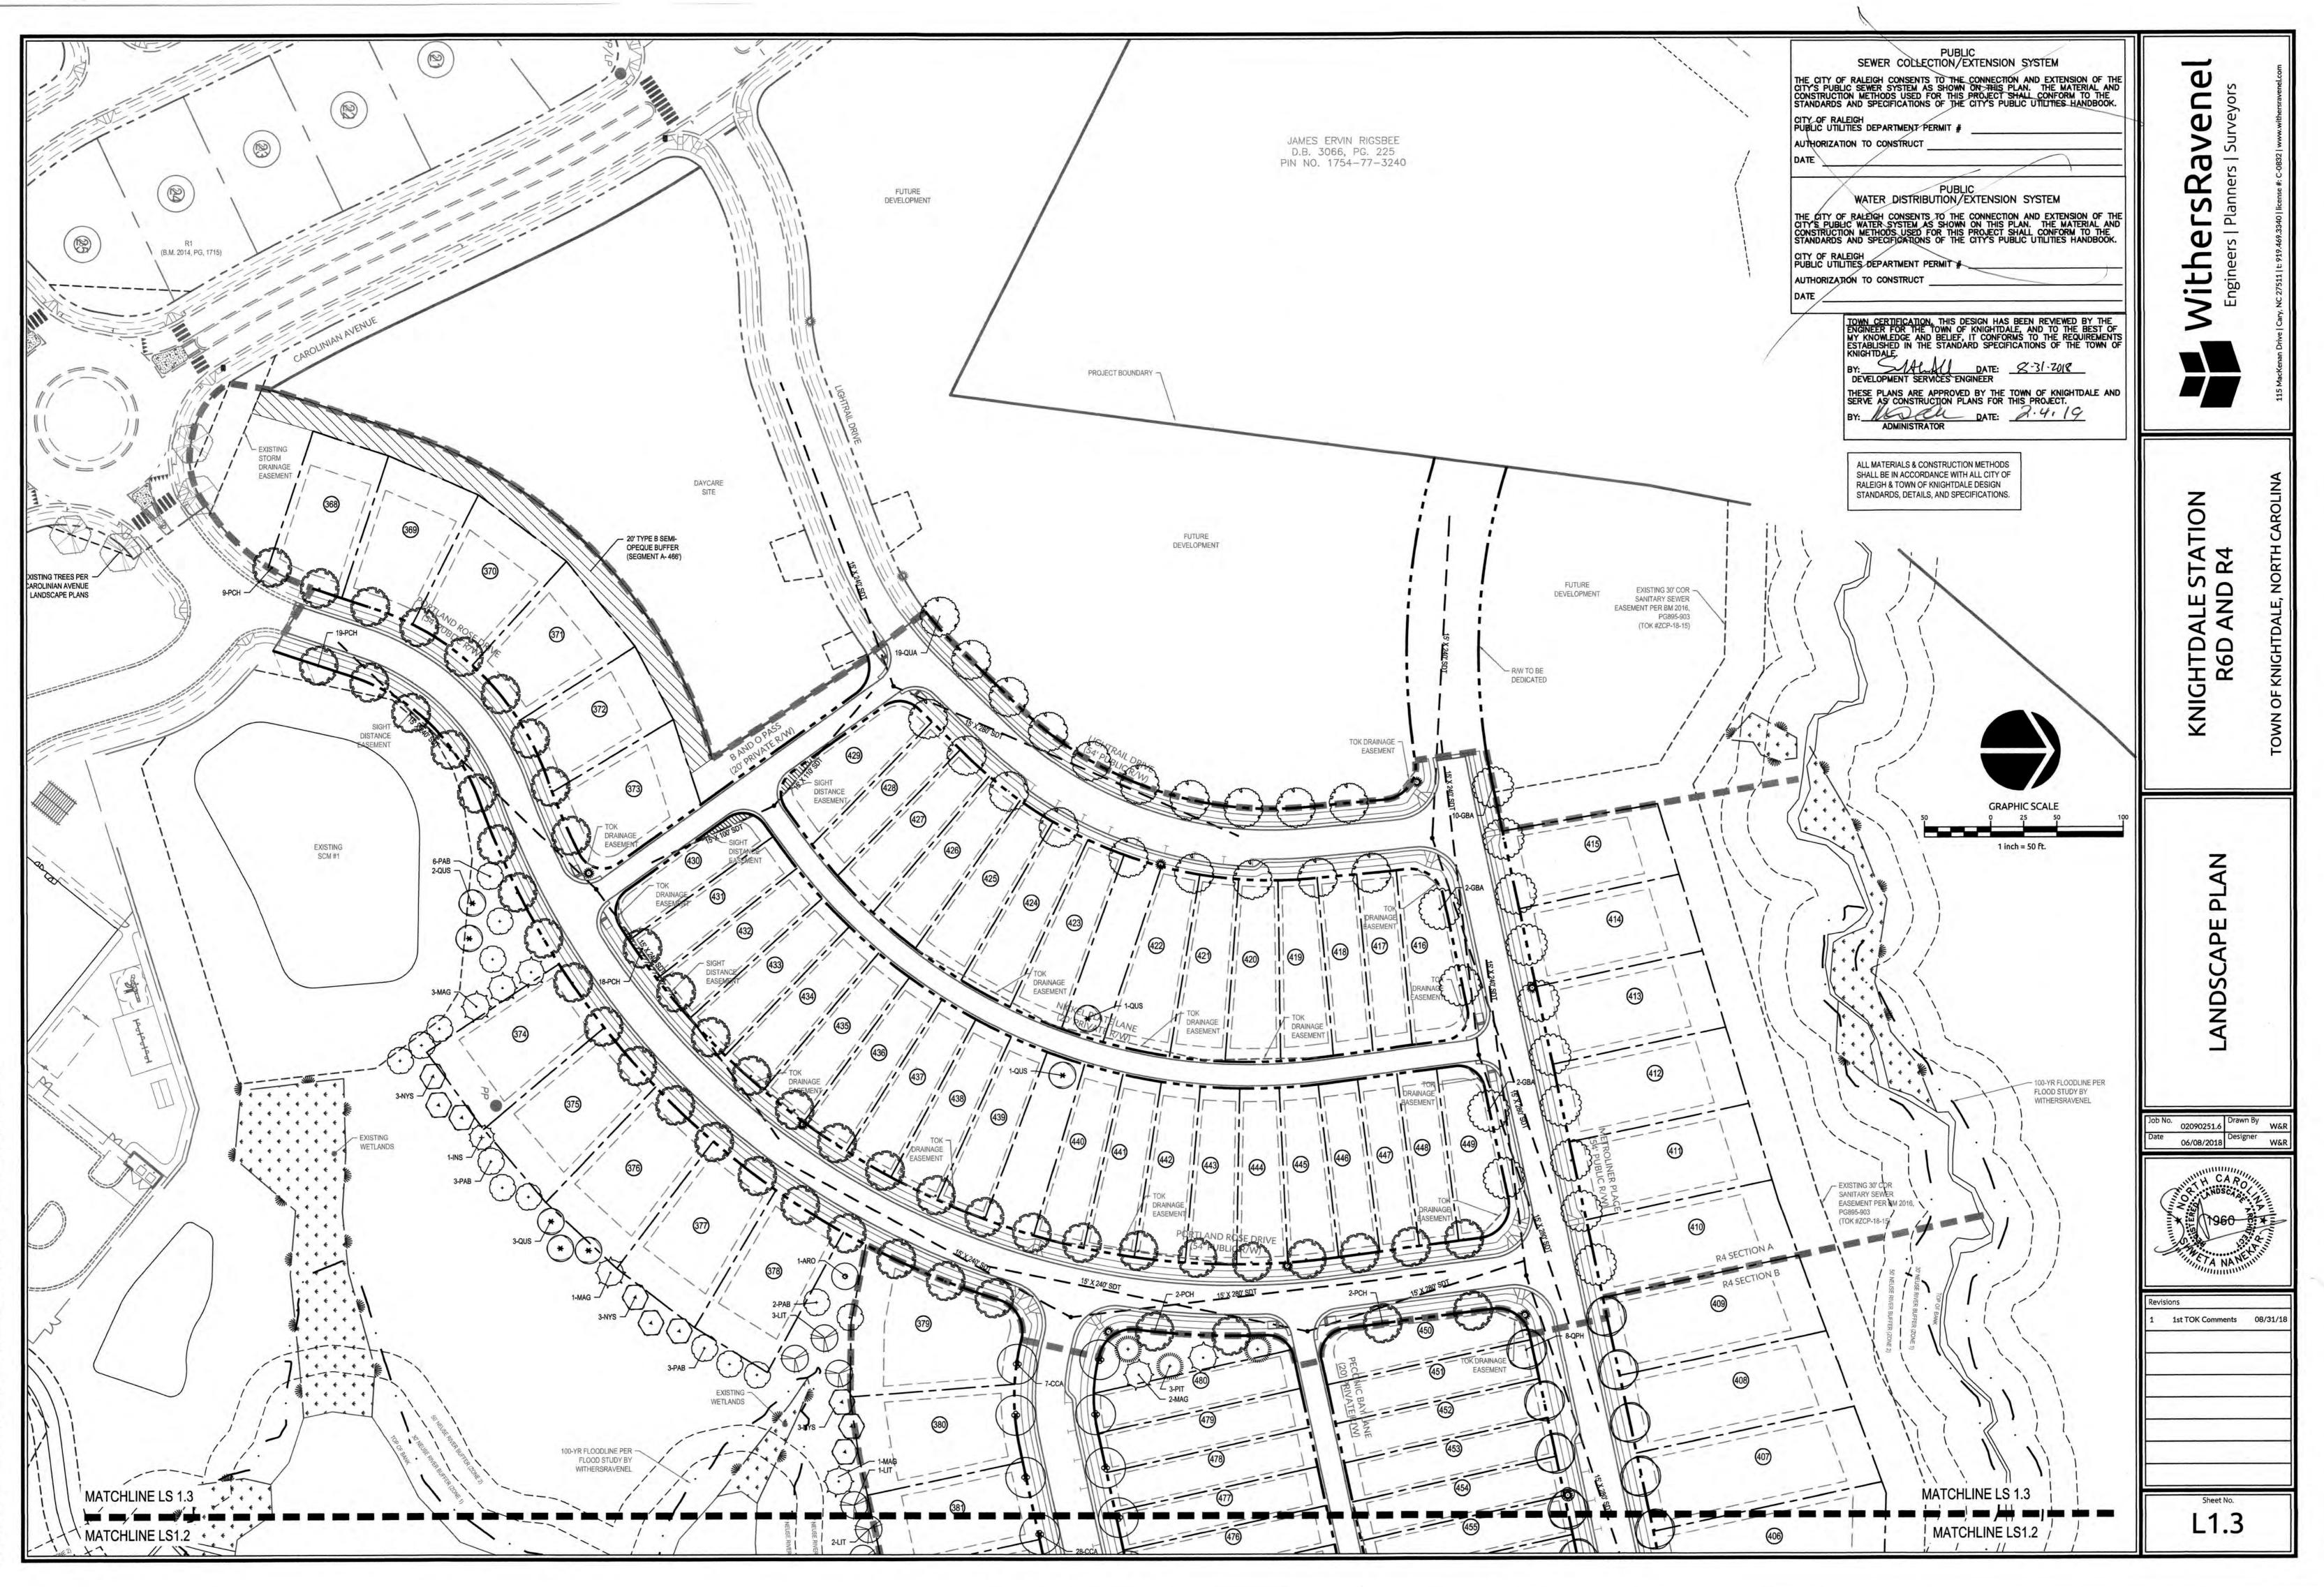

K:(09/09-0250/090251.6-Knightdale station Phase R4)CAD\MASTER-CONSTRUCTION DRAWINGS\L1.0-1.3 LANDSCAPE PLAN\_recover.dwg- Friday, August 31, 2018 11:24:07 AM - NANEKAR, SF

## **GENERAL LANDSCAPE NOTES**

- TREE PROTECTION FENCE SHALL SURROUND ALL EXISTING PLANTINGS AND EXISTING BUFFER AREAS WHERE APPLICABLE AND SHALL BE MAINTAINED UNTIL ALL SITE WORK IS COMPLETE. THE FENCE SHALL BE REMOVED PRIOR TO THE FINAL SITE INSPECTION FOR THE ISSUANCE OF A CERTIFICATE OF OCCUPANCY.
- WHERE EXISTING OR PROPOSED VEGETATION FAILS TO FUNCTION ADEQUATELY AS REQUIRED, THE TOWN OF KNIGHTDALE SITE INSPECTOR RESERVES THE RIGHT TO REQUIRE SUPPLEMENTAL PLANTINGS IN ADDITION TO THOSE SHOWN ON THE LANDSCAPE PLAN BASED ON ACTUAL FIELD CONDITIONS.
- NO CHANGES TO ANY ASPECT OF THIS SITE PLAN, INCLUDING BUT NOT LIMITED TO LANDSCAPING, GRADING, BUILDING ELEVATIONS (ESPECIALLY COLOR), LIGHTING, OR UTILITIES WILL BE MADE WITHOUT THE APPROVAL OF THE TECHNICAL REVIEW COMMITTEE OF THE TOWN OF KNIGHTDALE.
- ALL EXTERIOR SITE LIGHTING WILL BE DESIGNED TO PREVENT OFF-SITE GLARE. THE SITE SHALL BE STABILIZED AND SEEDED PRIOR TO THE ISSUANCE OF A CERTIFICATE OF OCCUPANCY (CO). ALL ABOVE GROUND UTILITY EQUIPMENT (AND FACILITIES ASSOCIATED WITH ON-SITE ELECTRIC, TELEPHONE, GAS, CABLE, OR OTHER SIMILAR UTILITY) AND ENCLOSED TRASH CONTAINMENT SHALL BE SCREEENED BY THE
- ELEMENTS OF A TYPE B (SEMI-OPAQUE) BUFFER YARD TO A SIX (6) FEET IN HEIGHT OR THE HEIGHT OF THE UTILITY OR ENCLOSURE, WHICHEVER IS LESS. ALL RIP RAP PADS, DETENTION PONDS, AND OTHER STORMWATER RELATED DEVICES SHALL BE SCREENED WITH
- EVERGREEN PLANTINGS TO REDUCE VISUAL IMPACT FROM OFF-SITE. NO TREE SHALL BE LOCATED WITHIN TEN FEET OF A LIGHT POLE OR 12 FEET FROM ELECTRICAL TRANSFORMERS. THIS PLAN IS FOR PLANTING PURPOSES ONLY. FOR INFORMATION REGARDING ROAD WORK GEOMETRY, GRADING,
- WALLS, UTILITIES, ETC., REFER TO THE CIVIL DRAWINGS. 0. ALL PLANTS AND PLANTING PROCEDURES SHALL MEET OR EXCEED A.N.L.A. STANDARDS AS SET FORTH IN
- "AMERICAN STANDARD FOR NURSERY STOCK", 2004 OR LATER EDITION.
- ALL TREES AND SHRUBS SHALL BE FULL, WELL-BRANCHED PLANTS WHICH ARE CHARACTERISTIC TO THE SPECIES. 2. ALL CANOPY TREES TO BE A MINIMUM OF 2" CALIPER AND 8' HEIGHT, ALL UNDERSTORY TREES 1 1/4" CALIPER, 6' HEIGHT AND SHRUBS 18", 3 GAL. CONTAINER AT TIME OF INSTALLATION.
- 3. NO FENCING SHALL BE PLACED WITHIN BUFFER AREAS UNLESS INSTALLED AT ONE TIME FOR THE ENTIRE LENGTH OF THE BUFFER OR STREETSCAPE. NEITHER INDIVIDUAL LOT OWNERS NOR THE H.O.A. SHALL INSTALL FENCES IN A PIECEMEAL FASHION. PRIOR TO PLACING A FENCE IN A BUFFER OR STREETSCAPE, THE FENCE SHALL BE SUBMITTED TO AND APPROVED BY THE TOWN OF KNIGHTDALE.
- 14. PLANT MATERIAL LOCATED WITHIN A REQUIRED SIGHT DISTANCE MAINTENANCE EASEMENT SHALL BE MAINTAINED
- AT A HEIGHT LESS THAN 24 INCHES OR LIMBED UP TO A MINIMUM HEIGHT OF SIX FEET. 15. ALL PLANT BEDS TO BE MULCHED WITH A MINIMUM OF 3" OF CLEAN PINE STRAW OR SHREDDED HARDWOOD BARK
- AT THE DISCRETION OF THE DEVELOPER. ALL PLANT GROUPINGS SHALL BE MULCHED AS ONE BED. 6. RESIDENTIAL LANDSCAPING:
- 16.1. EACH SINGLE-FAMILY OR DUPLEX LOT SHALL CONTAIN A MINIMUM OF ONE (1) CANOPY TREE FOR EACH TWO THOUSAND (2,000) SQUARE FEET OF LOT AREA OR FRACTION THEREOF UP TO 20,000 SQUARE FEET IN LOT AREA. ANY PORTION OF THE RESIDENTIAL LOT OCCUPIED BY A RECORDED UTILITY EASEMENT SHALL NOT BE INCLUDED AS PART OF THE TOTAL LOT AREA. THE LOCATION OF PLANTING TO ACCOUNT FOR PHYSICAL CONDITIONS MAY BE ADJUSTED BY THE ADMINISTRATOR.
- 16.2. THE USE OF EXISTING TREES MEETING THE FOLLOWING STANDARDS TO SATISFY THIS REQUIREMENT IS ENCOURAGED. EXISTING LARGE SHADE TREES OVER SIX (6) INCHES IN CALIPER AS MEASURED AT DBH (DIAMETER BREAST HEIGHT) MAY BE COUNTED TOWARDS FULFILLING THIS REQUIREMENT.
- 16.3. REQUIRED STREET TREES MAY NOT BE COUNTED TOWARDS THE FULFILLMENT OF THIS RESIDENTIAL LANDSCAPING REQUIREMENT. APART FROM REQUIRED STREET TREES, ALL OTHER TREES REQUIRED UNDER THIS CHAPTER SHALL BE PLANTED WITHIN THE PRIVATE LOT.
- 17.A LIGHTING PLAN SHALL BE SUBMITTED BY THE UTILITY PROVIDER TO KNIGHTDALE DEVELOPMENT SERVICES FOR APPROVAL PRIOR TO THE INSTALLATION OF ALL REQUIRED LIGHTING. THE LIGHTING PLAN SHALL DESIGNATE THE PROPOSED LOCATION OF ALL LIGHT POLES AND SHALL BE IN COMPLIANCE WITH SECTIONS 8.10 AND 16.8B AS WELL AS CHAPTER 11 OF THE TOWN OF KNIGHTDALE UDO. IF A PROPOSED LIGHT POLE LOCATION SHOULD PRESENT A CONFILICT WITH EXISTING OR PROPOSED VEGETATION ACCORDING TO THE APPROVED CONSTRUCTION DRAWINGS, THE LANDSCAPING PLAN SHALL BE REVISED TO COMPLY WITH THE TOWN OF KNIGHTDALE UDO REQUIREMENTS. ALL REVISIONS ARE SUBJECT TO TOWN OF KNIGHTDALE APPROVAL.

## KNIGHTDALE UDO REQUIREMENTS

## STREET TREE PLANTINGS

1. CANOPY TREES SHALL BE INSTALLED AT A MINIMUM AVERAGE DISTANCE OF 40 FEET ON CENTER IN A PLANTING STRIP MINIMUM OF FIVE FEET IN WIDTH. WHERE OVERHEAD UTILITIES EXIST PRIOR TO DEVELOPMENT, AND ARE IN CONFLICT WITH PROPOSED CANOPY TREES, UNDERSTORY TREES MAY BE SUBSTITUTED WITH APPROVAL.

- 2. IF UNDERSTORY TREES SUBSTITUTED, THEY HAVE TO BE PLANTED 20 FEET ON CENTER AND SPECIES SHALL BE APPROVED BY THE TOWN OF KNIGHTDALE PRIOR TO INSTALLATION.
- 3. STREET TREES SHALL BE PLACED AT LEAST 10 FEET FROM LIGHT POLES AND 12 FEET FROM ELECTRICAL TRANSFORMERS.
- 4. STREET TREES SHALL BE DECIDUOUS HARDWOODS.
- 5. ANY ABOVE GROUND UTILITIES HAVE TO BE SCREENED IN ACCORDANCE WITH UDO SECTION 8.7.

PLANT TYPE	QTY	KEY	ERNAL STREETSCAPE PL	COMMON NAME	ROOT	SIZE	HEIGHT	NOTES
CANOPY 34 STREET TREES 36 50 19		CCA	Carpinus caroliniana	American Hornbeam / Ironwood	B&B	2" CAL. MIN.	8' MIN.	MATCHED (40' O.C.)
		GBA	Ginkgo biloba 'Autumn Gold'	Autumn Gold Ginkgo	B&B	2" CAL. MIN.	8' MIN.	MATCHED (40' O.C.)
		PCH	Pistacia chinensis	Chinese Pistache	B&B	2" CAL. MIN.	8' MIN.	MATCHED (40' O.C.)
		QUA	Quercus acutissima	Sawtooth Oak	B&B	2" CAL. MIN.	8' MIN.	MATCHED (40' O.C.)
	26	QPH	Quercus phellos	Willow Oak	B&B	2" CAL. MIN.	8' MIN.	MATCHED (40' O.C.)
	20	UPA	Ulmus parvifolia 'Allee'	Allee Lacebark Elm	B&B	2" CAL. MIN.	8' MIN.	MATCHED (40' O.C.)
	29	ZSM	Zelkova serrata 'ZSFKF'	Myrimar Japanese Zelkova	B&B	2" CAL. MIN.	8' MIN.	MATCHED (40' O.C.)


PLANT TYPE	QTY	KEY	R6-D: TREE REPLACEMEN	COMMON NAME	ROOT	SIZE	HEIGHT	NOTES
CANOPY TREES (DECIDUOUS) 16 LIT (DECIDUOUS) 17 QL 18 NY 19 PA 14 CE	100 C	ARO	Acer rubrum 'October Glory'	October Glory Maple	B&B	2" CAL. MIN.	8' MIN.	MATCHED
		LIT	Liriodendron tulipifera	Tulip Poplar	B&B	2" CAL. MIN.	8' MIN.	MATCHED
	QUS	Quercus shumardii	Shumard Oak	B&B	2" CAL. MIN.	8' MIN.	MATCHED	
		NYS	Nyssa sylvatica	Black Gum	B&B	2" CAL. MIN.	8' MIN.	MATCHED
		PAB	Platanus x acerifolia 'Bloodgood'	London Plane Tree	B&B	2" CAL. MIN.	8' MIN.	MATCHED
		CDO	Cedrus deodara	Deodar Cedar	B&B	2" CAL. MIN.	8' MIN.	MATCHED
	14	MAG	Magnolia grandiflora	Southern Magnolia	B&B	2" CAL. MIN.	8' MIN.	MATCHED
TREES	18	PIT	Pinus taeda	Lobiolly Pine	B&B	2" CAL. MIN.	8' MIN.	MATCHED
EVERGREEN)	15	INS	Ilex x 'Nellie R. Stevens'	Nellie Stevens Holly	B&B	2" CAL. MIN.	8' MIN.	MATCHED


TREE REPLACEMENT QUANTITY CALCULATIONS FOR PHASE R4 REFER TO SHEET 2.0 OVERALL SITE PLAN FOR TREE REPLACEMENT CALCULATIONS. TOTAL TREE REPLACEMENT REQUIRED = 135 = 54 40% EVERGREEN PROVIDED 60% DECIDUOUS PROVIDED = 81


TREE REPLACEMENT QUANTITY CALCULATIONS FOR PHASE R6-D REFER TO SHEET 2.0 OVERALL SITE PLAN FOR TREE REPLACEMENT CALCULATIONS.

TOTAL TREE REPLACEMENT REQUIRED = 17 40% EVERGREEN PROVIDED

60% DECIDUOUS PROVIDED = 10

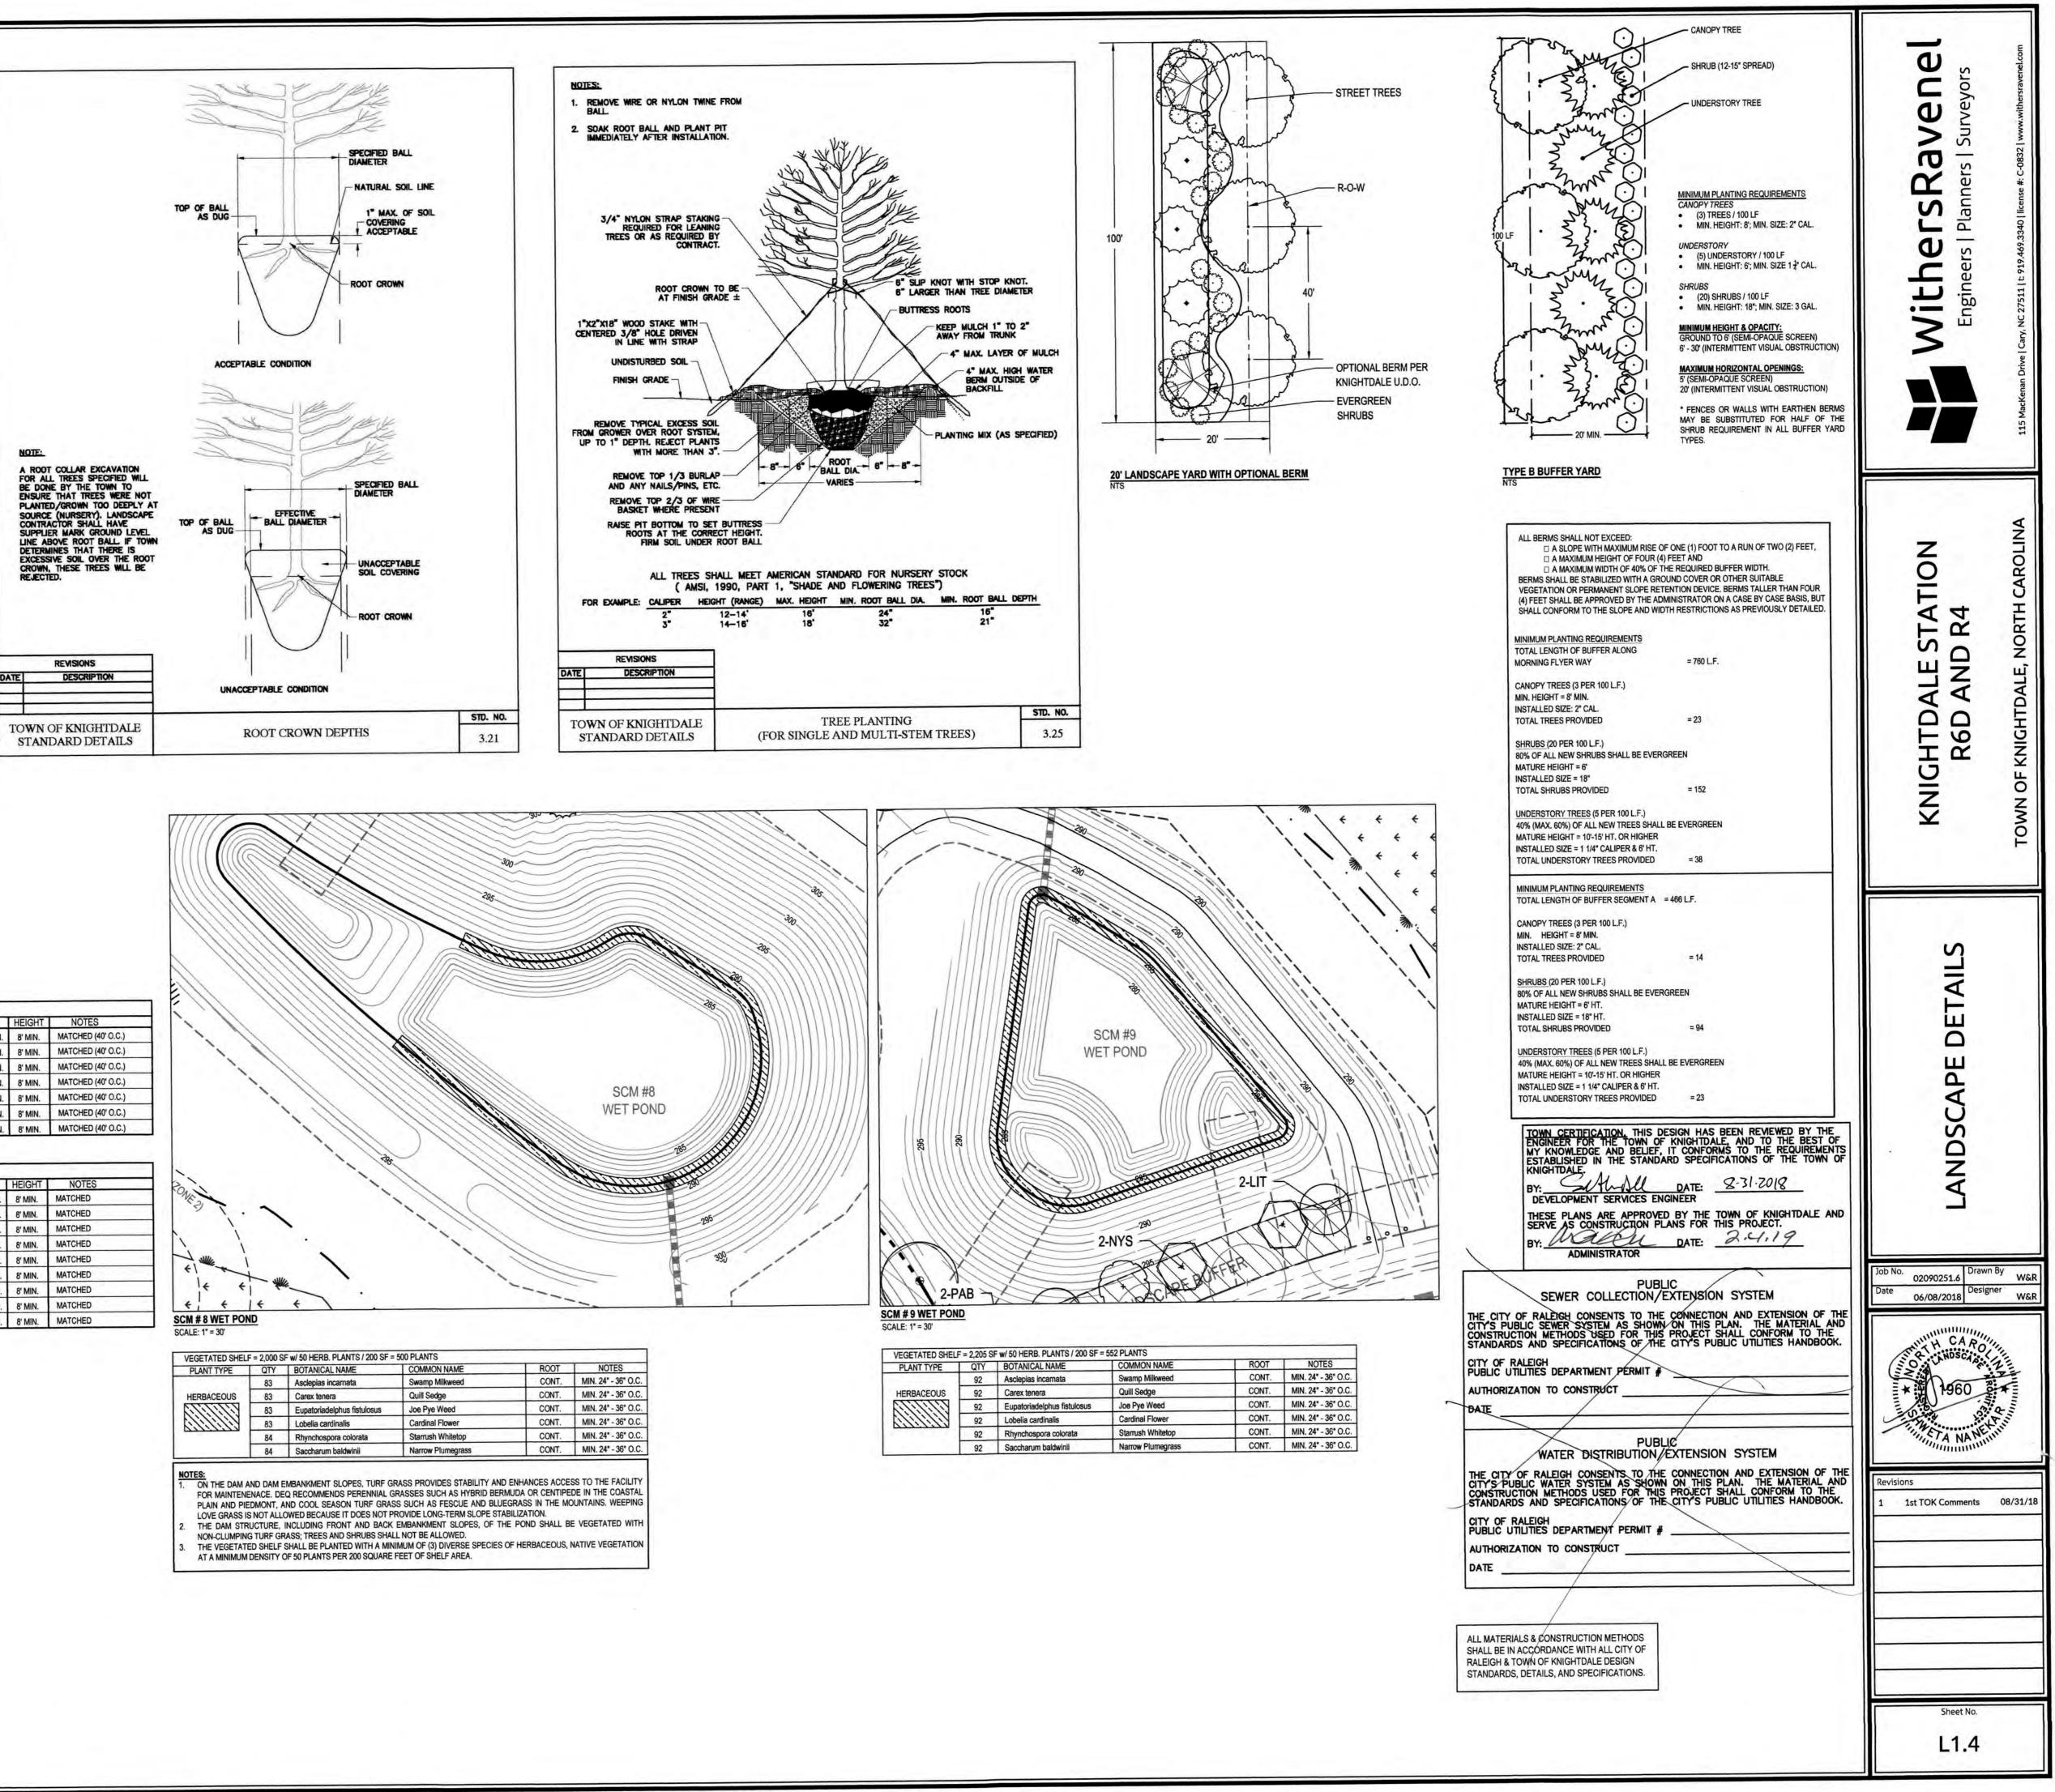

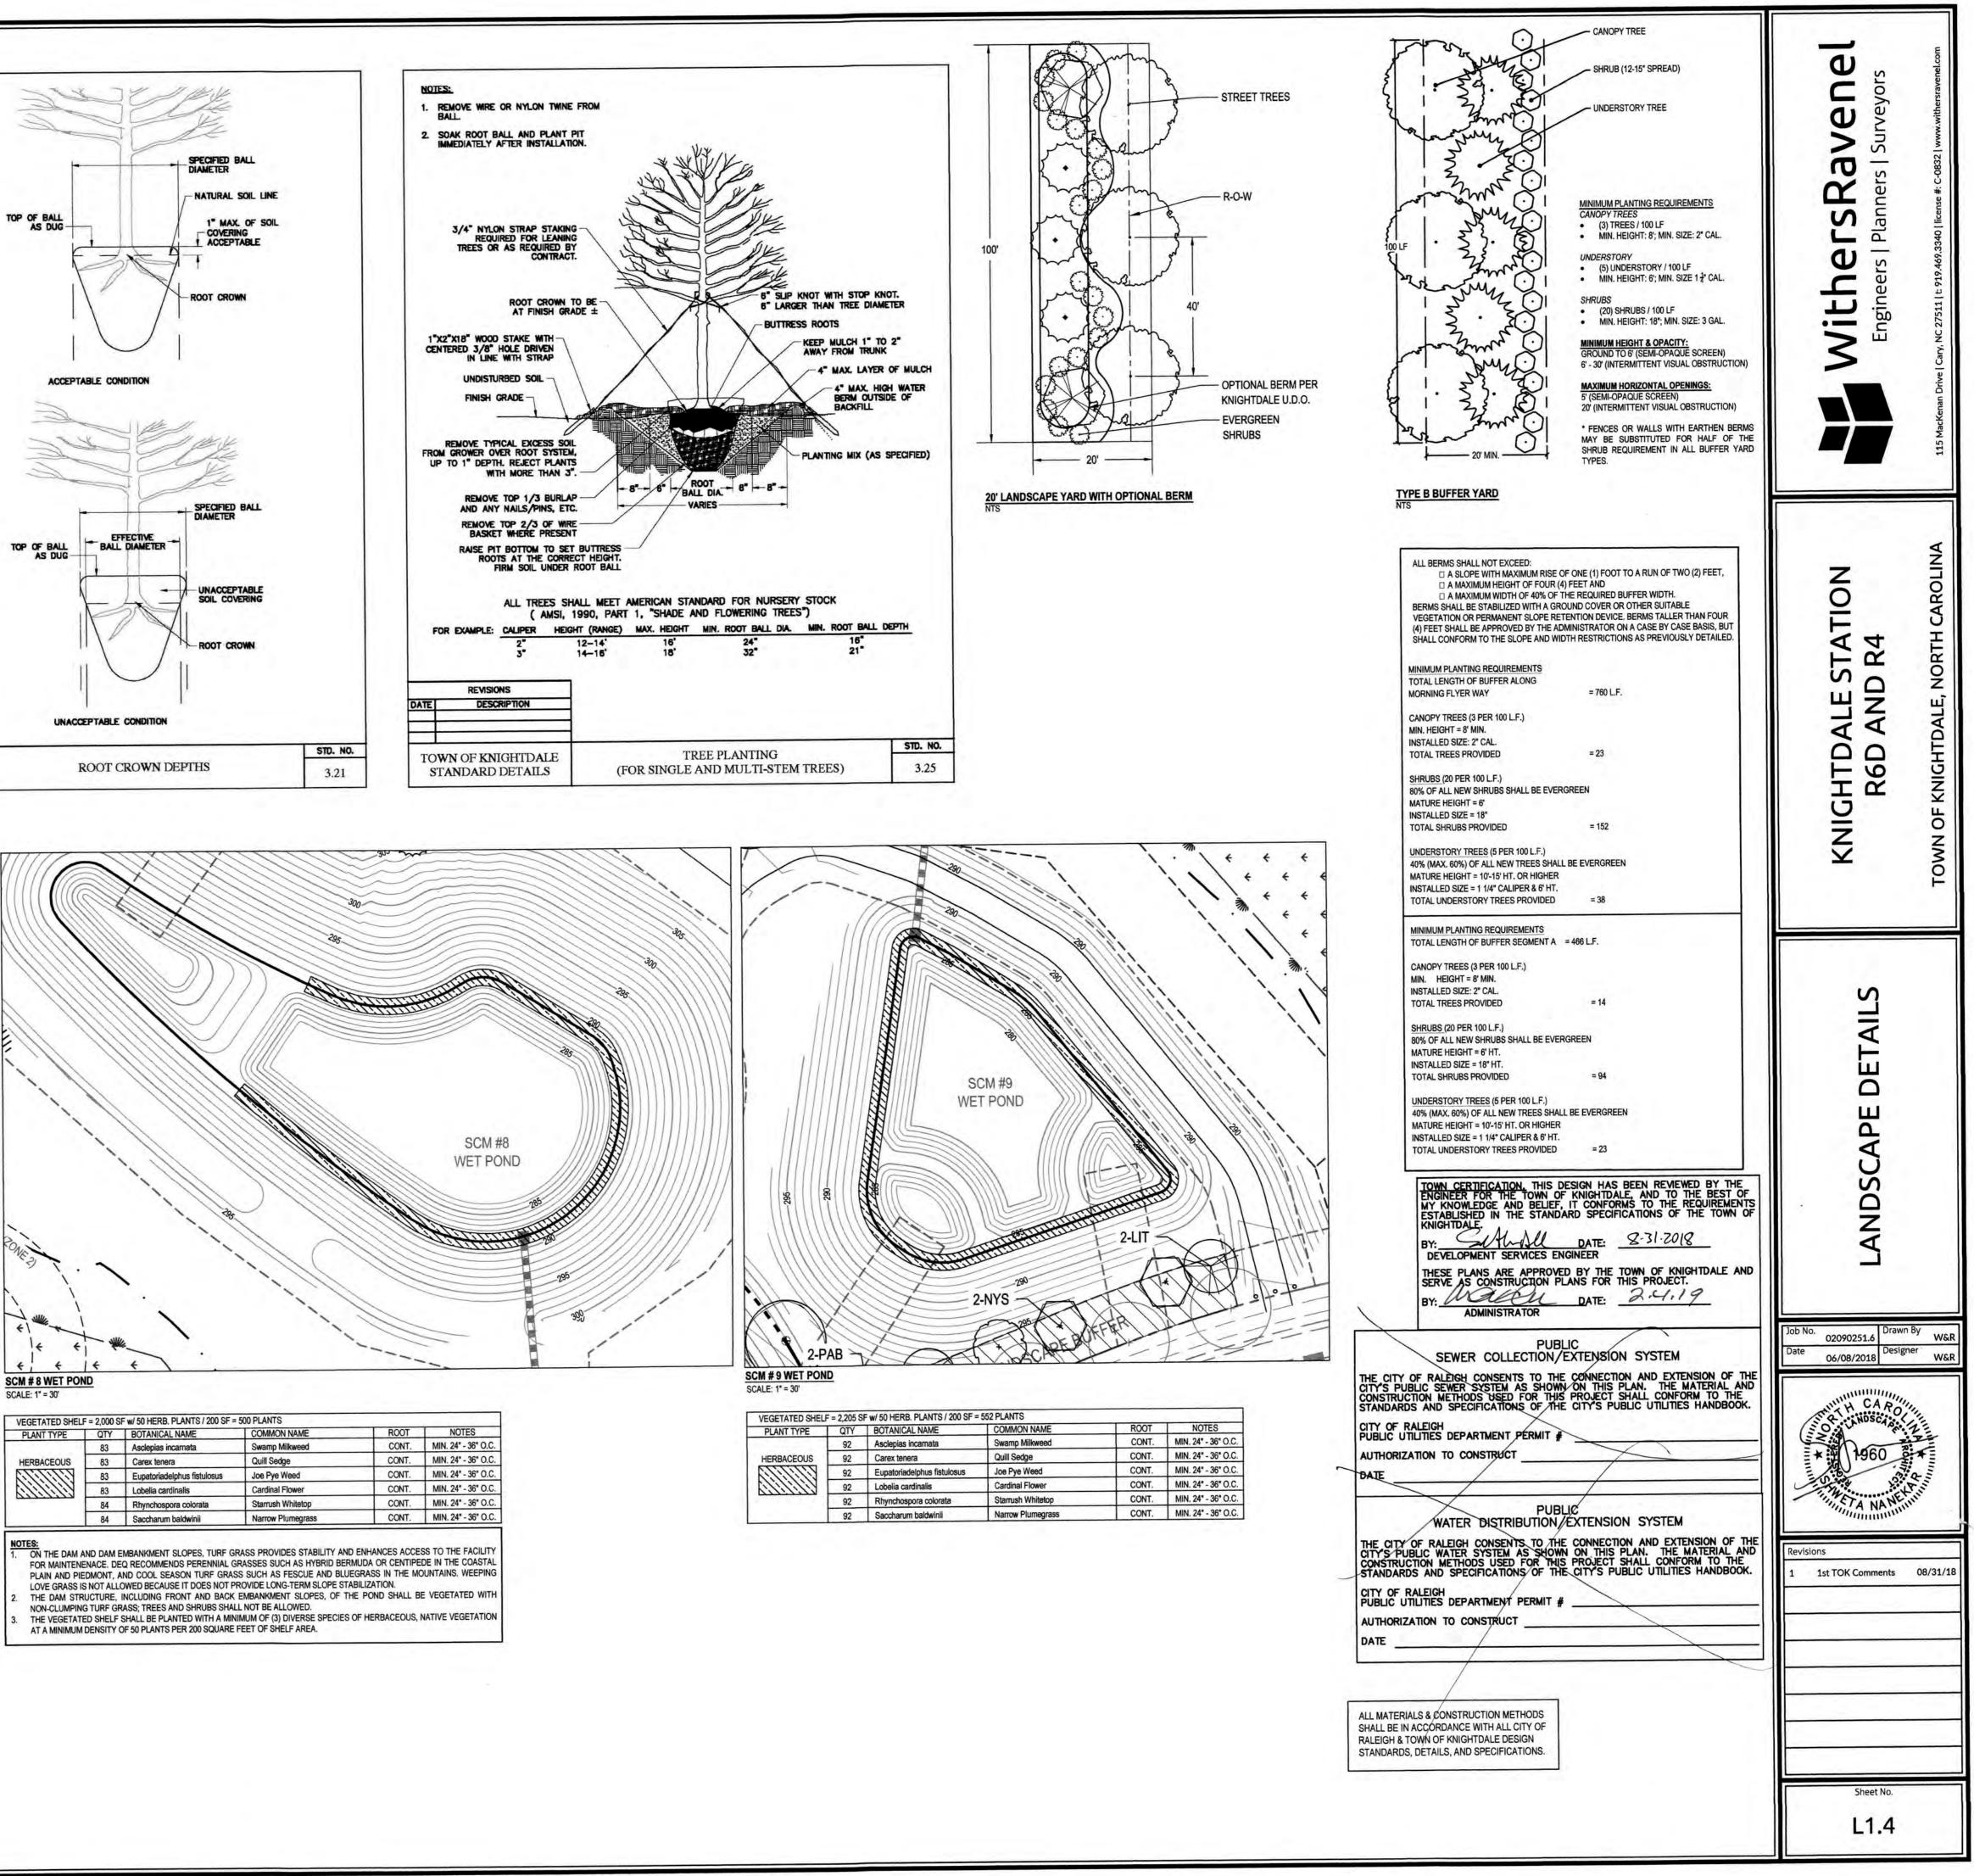

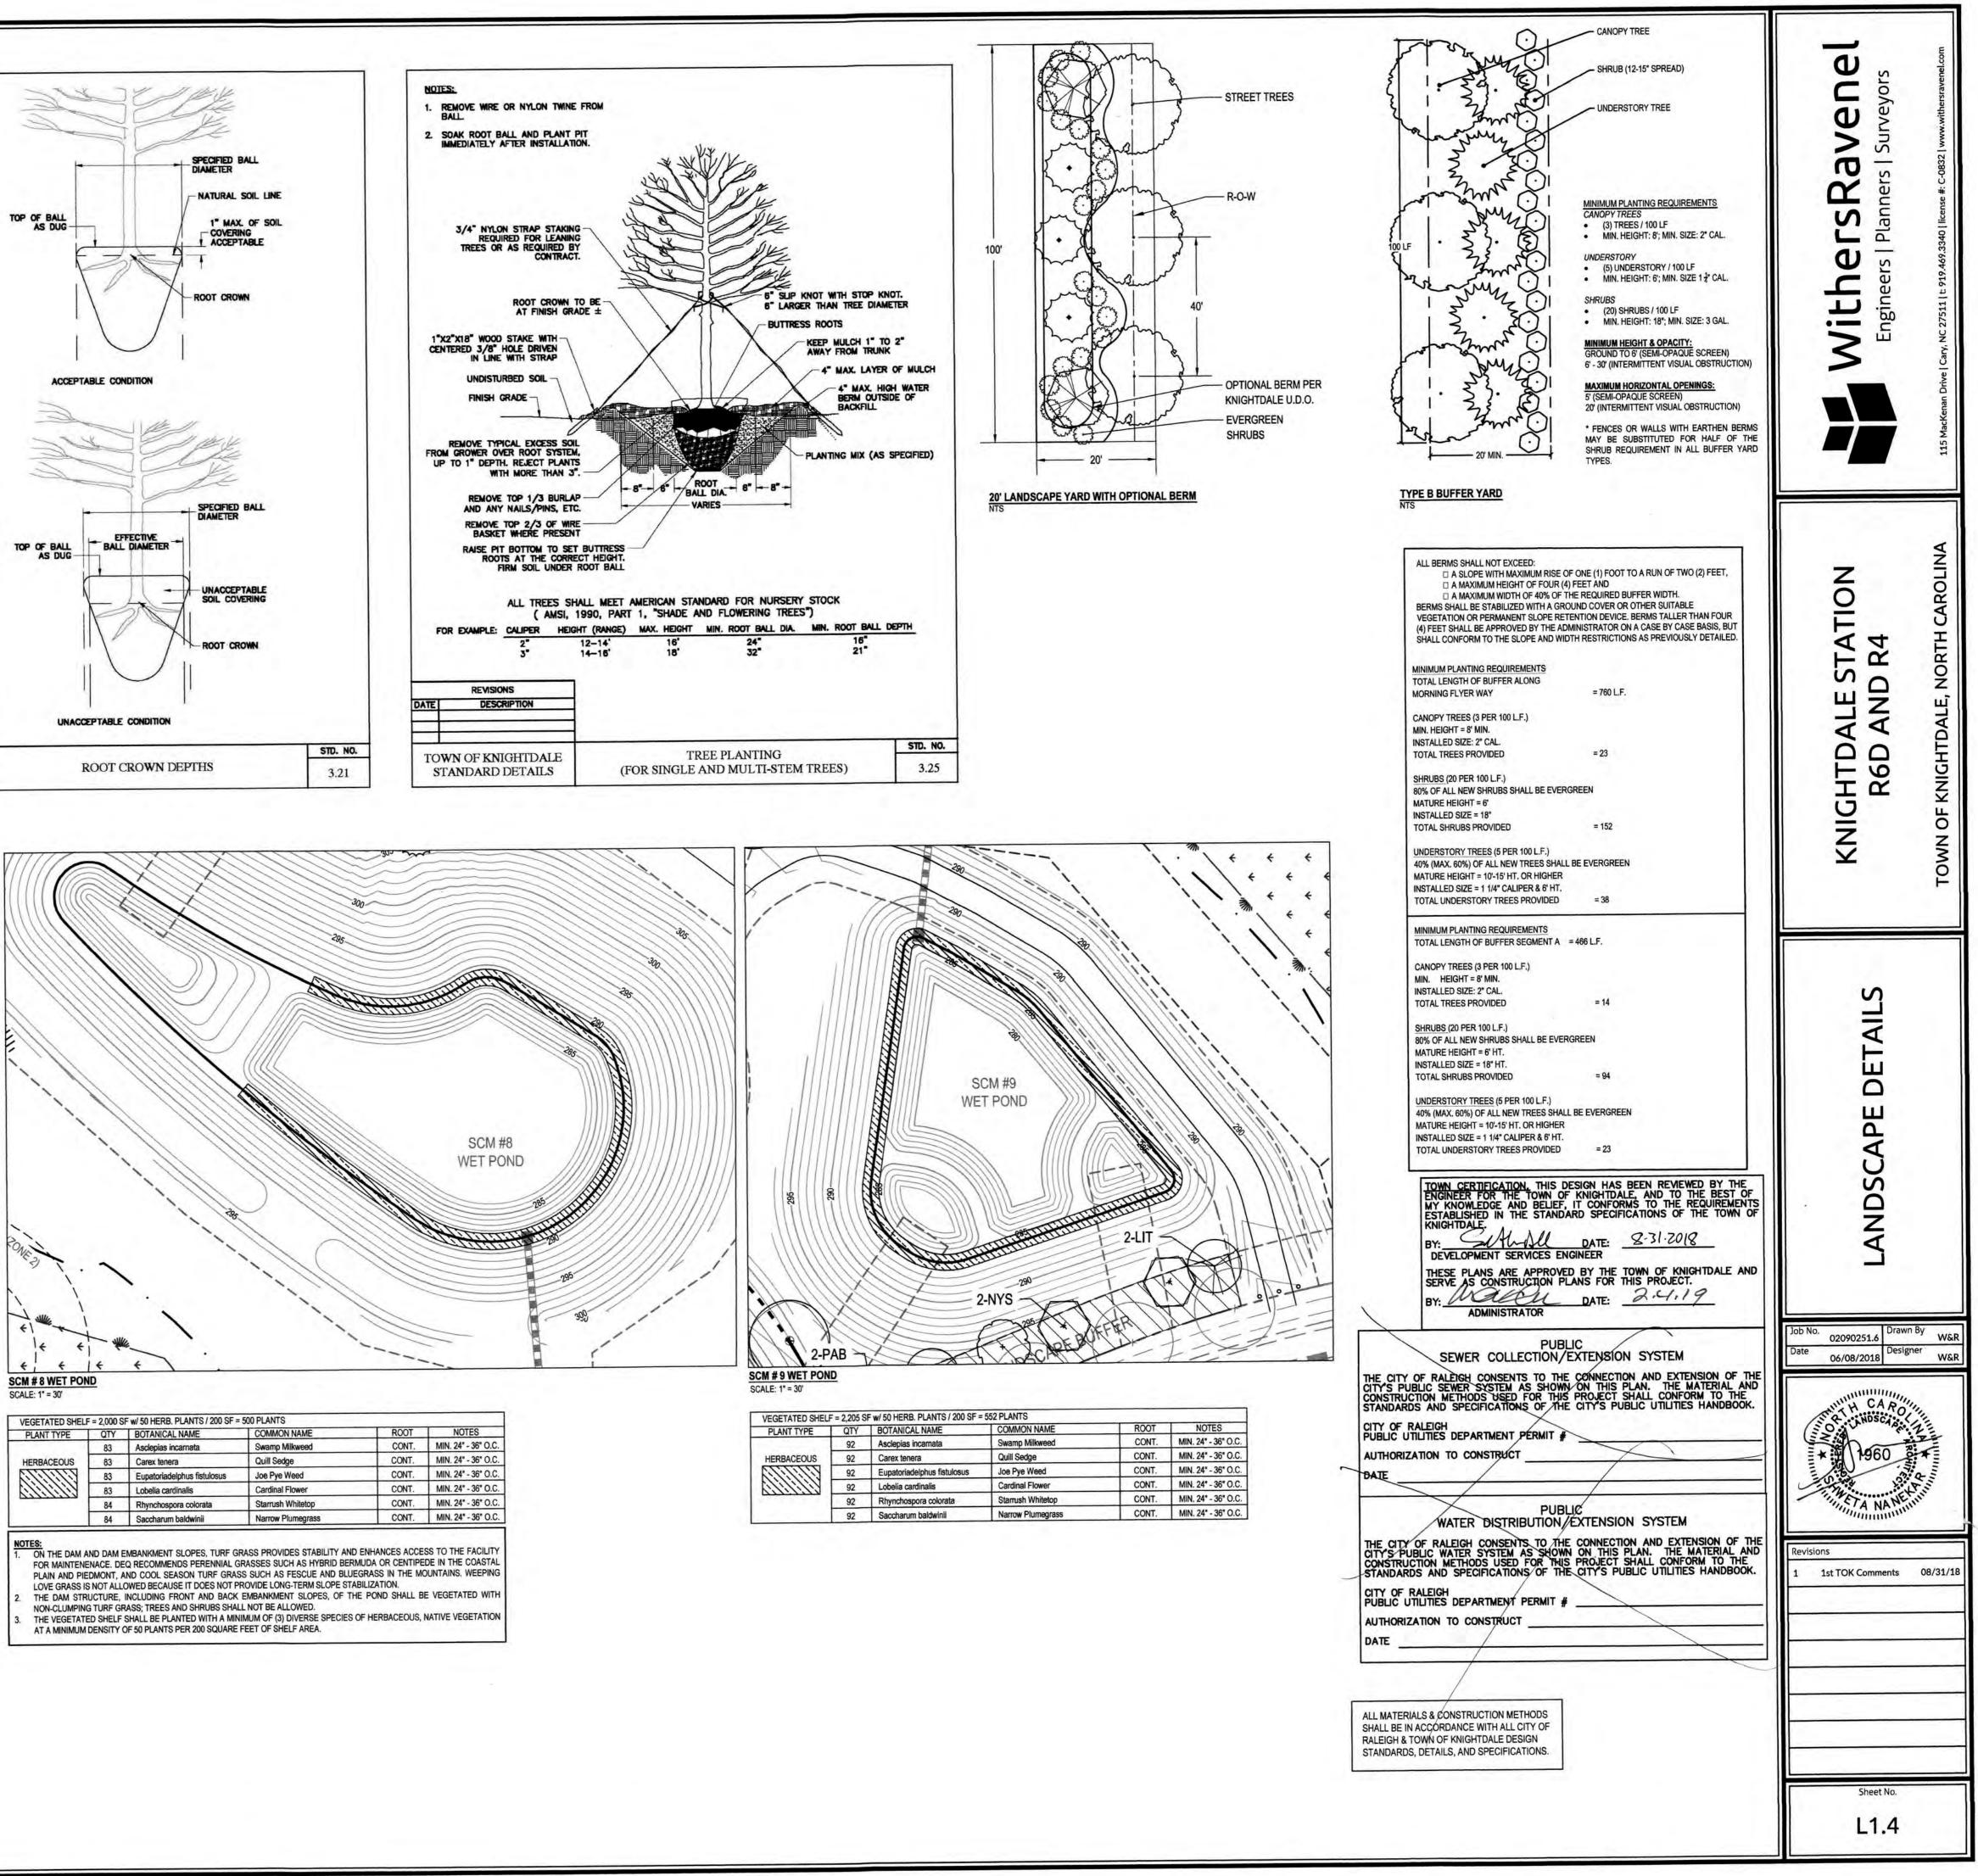

PLANT TYPE	QTY	BOTANICAL NAME	COMMON NAME	ROOT	NOTES
HERBACEOUS	83	Asclepias incarnata	Swamp Milkweed	CONT.	MIN. 24" - 36" O.C
	83	Carex tenera	Quill Sedge	CONT.	MIN. 24" - 36" O.C
	83	Eupatoriadelphus fistulosus	Joe Pye Weed	CONT.	MIN. 24" - 36" O.C
	83	Lobelia cardinalis	Cardinal Flower	CONT.	MIN. 24" - 36" O.C
	84	Rhynchospora colorata	Starrush Whitetop	CONT.	MIN. 24" - 36" O.C
	84	Saccharum baldwinii	Narrow Plumegrass	CONT.	MIN. 24" - 36" O.C

CW	Ŧ	91	NE		JND
CAL	E:	1" =	= 30'	11.1	

PLANT TYPE	QTY	BOTANICAL NAME	COMMON NAME	RC
	92	Asclepias incarnata	Swamp Milkweed	CC
HERBACEOUS	92	Carex tenera	Quill Sedge	CC
VIIIII V	92	Eupatoriadelphus fistulosus	Joe Pye Weed	CC
Ullillilla	92	Lobelia cardinalis	Cardinal Flower	CC
(11111)	92	Rhynchospora colorata	Starrush Whitetop	CC
	92	Saccharum baldwinii	Narrow Plumegrass	CC